#### F.S.NOTES:

### 1. GENERAL

- 1.1 FIRE SERVICE INSTALLATIONS SHALL BE PROVIDED IN ACCORDANCE WITH THE CODES OF PRACTICE FOR MINIMUM FIRE SERVICE INSTALLATIONS AND EQUIPMENT AND INSPECTION, TESTING AND MAINTENANCE OF INSTALLATIONS AND EQUIPMENT 2022 (COP 2022), FSD CIRCULAR LETTERS AND THE HONG KONG WATERWORKS STANDARD REQUIREMENTS.
- 1.2 ALL TUBES AND FITTINGS SHALL BE G.M.S. TO BS1387 MEDIUM GRADE WHERE PIPEWORK UP TO Ø150mm.
- 1.3 ALL TUBES AND FITTINGS SHALL BE DUCTILE IRON TO BS EN545 K12 WHERE PIPEWORK ABOVE Ø150mm.
- 1.4 ALL DRAIN PIPES SHALL BE DISCHARGED TO A CONSPICUOUS POSITION WITHOUT THE POSSIBILITY OF BEING SUBMERGED.
- 1.5 ALL PUDDLE FLANGES SHALL BE MADE OF DUCTILE IRON
- 1.6 SMOKE EXTRACTION SYSTEM(S) SHALL NOT BE PROVIDED AS THE AGGREGATE AREA OF OPERABLE WINDOW OF STRUCTURE B1 EXCEEDS 6.25% OF THE FLOOR AREA OF THE COMPARTMENT.
- 1.7 VENTILATION/AIR CONDITIONING SYSTEM NOT TO BE PROVIDED.

#### 2. HOSE REEL SYSTEM

- 2.1 NEW FIRE HOSE REEL SHALL BE PROVIDED AS INDICATED ON PLAN TO ENSURE THAT EVERY PART OF THE BUILDING CAN BE REACHED BY A LENGTH OF NOT MORE THAN 30m HOSE REEL TUBING.
- 2.2 THE WATER SUPPLY FOR HOSE REEL SYSTEM WILL BE FED FROM A NEW 2m3 F.S. FIBREGLASS WATER TANK VIA TWO HOSE REEL PUMPS (DUTY/ STANDBY) LOCATED INSIDE FS PUMP ROOM AT EXTERNAL AREA.
- 2.3 HOSE REEL PUMPS SHALL BE STARTED BY ACTUATION OF ANY BREAKGLASS UNIT FITTED ASIDE EACH HOSE REEL SETS
- 2.4 ALL FIRE HOSE REEL OUTLETS SHOULD BE HOUSED IN GLASS FRONTED CABINET SECURED UNDER LOCK & KEY.
- 2.5 ALL FIRE HOSE REEL SHOULD BE PROVIDED WITH FSD APPROVED TYPE INSTRUCTION PLATE & WSD WARNING PLATE
- 2.6 SECONDARY ELECTRICITY SUPPLY DIRECTLY TEE OFF BEFORE CLP'S INCOMING MAIN SWITCH SHALL BE PROVIDED FOR THE FH/HR PUMPS.

#### 3. AUTOMATIC SPRINKLER SYSTEM

- 3.1 NEW AUTOMATIC SPRINKLER SYSTEM SHALL BE PROVIDED AND INSTALLED IN ACCORDANCE WITH LPC RULES FOR AUTOMATIC SPRINKLER INSTALLATIONS INCORPORATING BS EN 12845: 2015 (INCLUDING TECHNICAL BULLETINS, NOTES, COMMENTAR AND RECOMMENDATIONS) AND FSD CIRCULAR LETTER NO. 5/2020. THE CLASSIFICATION OF THE OCCUPANCIES WILL BE ORDINARY HAZARD GROUP III.
- 3.2 ONE NEW 135m3 SPRINKLER WATER TANK WILL BE PROVIDED AS INDICATED ON PLAN. THE TOWN MAIN WATER SUPPLY WILL BE FED FROM SINGLE END.
- 3.3 TWO NEW SPRINKLER PUMPS (DUTY/STANDBY) AND ONE JOCKEY PUMP SHALL BE PROVIDED IN FS PUMP ROOM LOCATED AT EXTERNAL AREA.
- 3.4 NEW SPRINKLER CONTROL VALVE SET AND SPRINKLER INLET SHALL BE PROVIDED AS INDICATED ON PLAN.
- 3.5 A TEST VALVE SHALL BE PROVIDED FOR EACH ZONE OF SPRINKLER PIPE. THIS VALVE SHALL BE AT A CONSPICUOUS POSITION THAT WATER CAN BE DRAINED AWAY EASILY.
- 3.6 ALL SUBSIDIARY STOP VALVES TO BE ELECTRIC MONITORING TYPE.
- 3.7 ALL ELECTRIC TYPE VALVES SHOULD GIVE VISUAL SIGNALS TO FIRE SERVICE MAIN SUPERVISORY CONTROL PANEL TO INDICATE THE STATUS (OPEN/CLOSE) OF THE VALVES.
- 3.8 SECONDARY ELECTRICITY SUPPLY DIRECTLY TEE OFF BEFORE CLP'S INCOMING MAIN SWITCH SHALL BE PROVIDED FOR THE SPRINKLER PUMPS.
- 3.9 THE SPRINKLER SYSTEM DESIGN IS BASED ON THE FOLLOWINGS: HAZARD CLASS: ORDINARY HAZARD GROUP III TYPE OF STORAGE: POST-PALLET (ST2) STORAGE CATEGORY: CATEGORY I MAXIMUM STORAGE HIEGHT: 3.5m SPRINKLER PROTECTION: CEILING PROTECTION ONLY THE MAXIMUM STORAGE AREAS SHALL BE 50m2 FOR SINGLE BLOCK THE MINIMUM CLEARANCE AROUND EACH SINGLE STORAGE CLOCK: 2.4m

# 4. FIRE ALARM SYSTEM

- 4.1 NEW FIRE ALARM SYSTEM SHALL BE PROVIDED IN ACCORDANCE WITH BS 5839-1:2017 AND FSD CIRCULAR LETTERS NO. 6/2021.
- 4.2 NEW BREAKGLASS UNITS AND FIRE ALARM BELLS SHALL BE PROVIDED AT ALL<sup>3</sup> NEW FIRE HOSE REEL POINTS. THE FIRE ALARM INTALLATION WILL BE INTEGRATED WITH THE HOSE REEL SYSTEM.

# 5. EMERGENCY LIGHTING

5.1 EMERGENCY LIGHTING SHALL BE PROVIDED IN ACCORDANCE WITH 'BS 5266-1:2016 AND BS EN 1838:2013", AND THE FSD CIRCULAR LETTER NO. 4/2021, COVERING ALL AREA. EMERGENCY LIGHTINGS SHALL BE BACKED UP BY BUILT-IN BATTERY AND CAPABLE OF MAINTAINING FUNCTION OF NOT LESS THAN 2 HOURS IN CASE OF POWER FAILURE

# 6. EXIT SIGN

6.1 ALL EXIT SIGNS/DIRECTIONAL EXIT SIGNS SHALL BE PROVIDED IN ACCORDANCE WITH BS 5266-1:2016 AND FSD CIRCULAR LETTER NO. 5/2008, FOR THE BUILDING. EXIT SIGNS/DIRECTIONAL EXIT SIGNS SHALL BE BACKED UP BY BUILT-IN BATTERY AND CAPABLE OF MAINTAINING FUNCTION OF NOT LESS THAN 2 HOURS IN CASE OF POWER FAILURE.

# 7. PORTABLE APPLIANCES

7.1 PORTABLE HAND OPERATED APPLIANCES SHALL BE PROVIDED AS INDICATED ON PLAN.


# LEGEND



BREAK GLASS UNIT

FIRE ALARM BELL



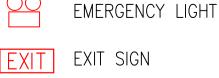

EXIT EXIT SIGN

NON-RETURN VALVE



FIRE EXTINGUISHER FIRE EXTINGUISHER

DRAWING TITLE :

- SUBSIDIARY VALVE / FLOW SWITCH

GATE TYPE (With MONITORING)

REV DESCRIPTION DATE

ARCHITECT

SPRINKLER INLET CONSULTANT :


FIRE SERVICE CONTRACTOR **Century Fire Service Engineering Co., Ltd.** 

DRAWING NO **FS-01** C.K.NG 17 Jul 2025 SCALE: 1:1000 (A1) CHECKED BY B.O.O. Ref. BD APPROVED BY F.S.D. Ref. FP

REV.

**GF of Structure B1 Openable Windows Calculation** Area of GF Structure B1 = 12917 sq.m. Area of High Bay Window (H.B.W.) = 2.6m(H) x 312m(total length) = 811.2 sq.m. Total openable window area = 811.2 sq.m. = 6.28% of floor area


1F of Structure B1 Openable Windows Calculation Area of 1F Structure B1 = 12917sq.m. Area of High Bay Window (H.B.W.) = 2.6m(H) x 312m(total length) = 811.2 sq.m. Total openable window area = 811.2 sq.m.

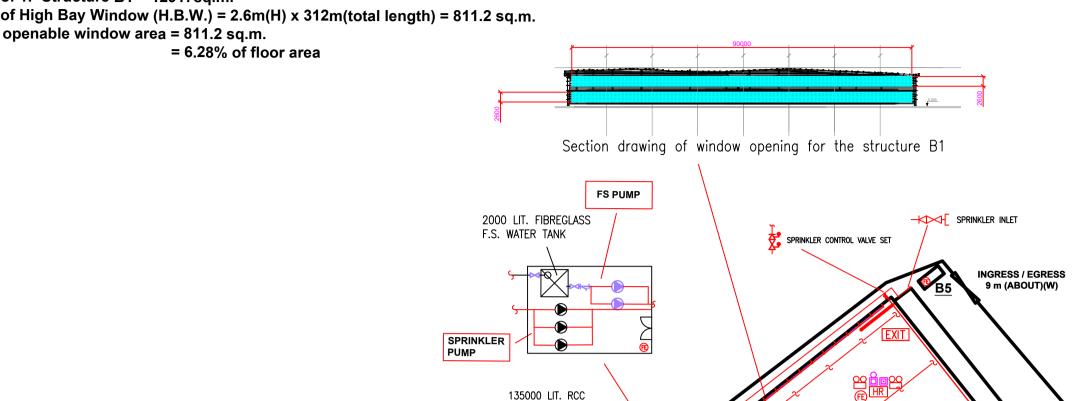

SPRINKLER WATER TANK

Water Tank Room For FSIs

**G/F PLAN VIEW** 1/F PLAN VIEW Section drawing of window opening for the structure B1

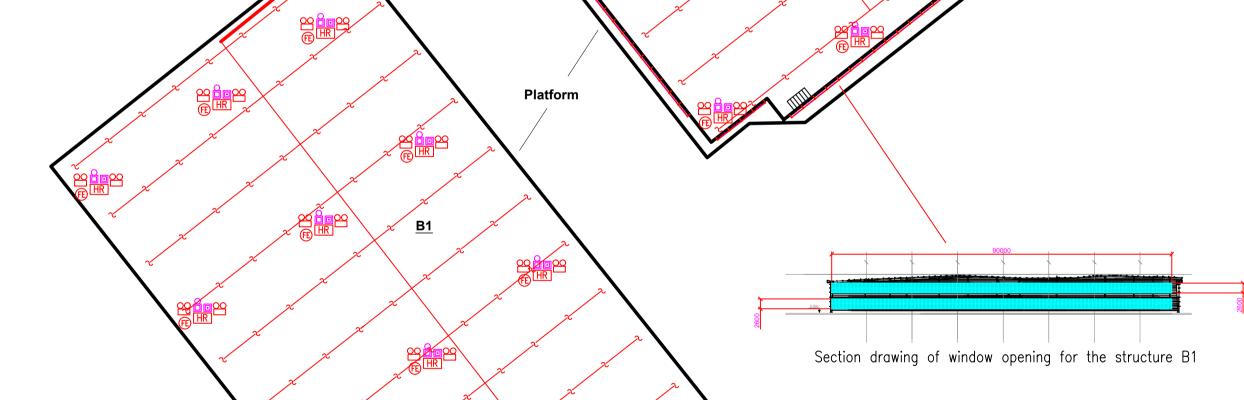

STRUCTURE USE

RAIN SHELTER FOR L/UL

GUARD ROOM

OFFICE, CANTEEN AND WASHROOM

706 m<sup>2</sup> (ABOUT)

450 m<sup>2</sup> (ABOUT)

27,061 m<sup>2</sup> (ABOUT)

15 m<sup>2</sup> (ABOUT)

225 m<sup>2</sup> (ABOUT)

13,979 m<sup>2</sup> (ABOUT)

15 m<sup>2</sup> (ABOUT)

6.2 m (ABOUT)(1-STORE)

12 m (ABOUT)(2-STOREY) 3 m (ABOUT)(1-STOREY)

SPRINKLER CONTROL VALVE SET PRESSURE GAUGE Y-TYPE STRAINER GATE VALVE 

TEMPORARY LOGISTICS CENTRE WITH ANCILLARY OFFICE AND CANTEEN FOR A PERIOD OF 3 YEARS VARIOUS LOTS IN D.D. 129 AND ADJOINING GOVERNMENT LAND, LAU FAU SHAN, YUEN LONG, NEW TERRITORIES

F.S. Notes, Legend, Fire Service Installation **Layout Plan**