

宏 基 測 量 師 行

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香港九龍尖沙咀漆咸道南9號均輝大廈9樓

Estate Agent Licence (Company) No. C-006243 地產代理 (公司) 牌照號碼: C-006243

Our Ref.: KW/TPN/2639A/L03

17 July 2025

Secretary
Town Planning Board
15/F, North Point Government Offices
333 Java Road, North Point
Hong Kong

By Post and Email

Dear Sir/Madam,

Planning Application for

Minor Relaxation of Building Height Restriction to Construct a Car Park and an Ancillary Plant Room at Basement Level for Permitted Residential Development at No. 3 Lincoln Road,

Kowloon Tong, Kowloon

(New Kowloon Inland Lot No. 713) (Planning Application No. A/K18/350)

We refer to the captioned planning application.

We submit herewith a set of replacement pages of the Application Form and "Response-to-Comments" in responding to the government departmental comment for the captioned planning application.

In order to making response to government departmental comments, the Proposed Layout Plans together with the Development Schedule has been revised, as shown at **Appendix 1**.

Should you have any queries, please feel free to call our Mr. Anson Lee at you.

Yours faithfully,

For and on behalf of

LAMBASE SURVEYORS LIMITED

Anson Lee

Encl.

RK/AL







For Official Use Only	Application No. 申請編號	
請勿填寫此欄	Date Received 收到日期	

- 1. The completed form and supporting documents (if any) should be sent to the Secretary, Town Planning Board (the Board), 15/F, North Point Government Offices, 333 Java Road, North Point, Hong Kong. 申請人須把填妥的申請表格及其他支持申請的文件(倘有),送交香港北角渣華道 333 號北角政府合署 15 樓城市規劃委員會(下稱「委員會」)秘書收。
- 2. Please read the "Guidance Notes" carefully before you fill in this form. The document can be downloaded from the Board's website at http://www.tpb.gov.hk/. It can also be obtained from the Secretariat of the Board at 15/F, North Point Government Offices, 333 Java Road, North Point, Hong Kong (Tel: 2231 4810 or 2231 4835), and the Planning Enquiry Counters of the Planning Department (Hotline: 2231 5000) (17/F, North Point Government Offices, 333 Java Road, North Point, Hong Kong and 14/F, Sha Tin Government Offices, 1 Sheung Wo Che Road, Sha Tin, New Territories). 請先細閱《申請須知》的資料單張,然後填寫此表格。該份文件可從委員會的網頁下載(網址: http://www.tpb.gov.hk/),亦可向委員會秘書處(香港北角渣華道 333 號北角政府合署 15 樓 電話:2231 4810 或 2231 4835)及規劃署的規劃資料查詢處(熱線:2231 5000) (香港北角渣華道 333 號北角政府合署 17 樓及新界沙田上禾鞍路 1 號沙田政府合署 14 樓)索取。
- 3. This form can be downloaded from the Board's website, and obtained from the Secretariat of the Board and the Planning Enquiry Counters of the Planning Department. The form should be typed or completed in block letters. The processing of the application may be refused if the required information or the required copies are incomplete. 此表格可從委員會的網頁下載,亦可向委員會秘書處及規劃署的規劃資料查詢處索取。申請人須以打印方式或以正楷填寫表格。如果申請人所提交的資料或文件副本不齊全,委員會可拒絕處理有關申請。

1.	Name of Applicant	申請人姓名/名稱
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(□Mr. 先生 /□Mrs. 夫人 /□Miss 小姐 /□Ms. 女士 /☑ Company 公司 /□ Organisation 機構)

COLUMN INVESTMENT GROUP (HONG KONG) LIMITED

2. Name of Authorised Agent (if applicable) 獲授權代理人姓名/名稱(如適用)

(□Mr. 先生 /□Mrs. 夫人 /□Miss 小姐 /□Ms. 女士 /亞Company 公司 /□Organisation 機構)

LANBASE SURVEYORS LIMITED 宏基測量師行有限公司

3.	Application Site 申請地點	
(a)		NO. 3 LINCOLN ROAD, KOWLOON TONG, KOWLOON (NKIL 713)
(b)	Site area and/or gross floor area involved 涉及的地盤面積及/或總樓面面 積	☑Site area 地盤面積 945.28 sq.m 平方米☑About 約 ☑Gross floor area 總樓面面積 540.35 sq.m 平方米☑About 約
(c)	Area of Government land included (if any) 所包括的政府土地面積(倘有)	NIL sq.m 平方米 ☑About 約

(iy) <u>E</u>	or Type (iv) applicat	ion A	\$(v)\$C.B.				
(a) I	(a) Please specify the proposed minor relaxation of stated development restriction(s) and also fill in the						
	proposed use/development and development particulars in part (v) below -						
	清列明擬議略為放寬的	的發展的	限制 <u>並填妥於第(v)部分的</u>	接護用途/發展及發展細節 -			
	Plot ratio restriction 地積比率限制		From 由	to 至			
	Gross floor area restrict 總樓面面積限制	tion	From 由sq. m	平方米 to 至sq. m 平方光	(
	Site coverage restriction 上蓋面積限制	n	From 由	% to 至%			
Ø	Building height restrict 建築物高度限制	ion	From 由n	n 米 to 至m 米			
			From 由	mPD 米 (主水平基準上) to 至			
			*********	mPD 米 (主水平基準上)			
			From 由 .3	storeys 層 to 至4 store	/s 層		
	□ Non-building area restriction 非建築用地限制		From 由m to 至m				
	Others (please specify) 其他(請註明)						
					_		
(v) <u>F</u>	or Type (v) applicati	on #	iorus				
		M	NOR RELAXATIO	ON OF BUILDING	HEIGHT		
	•		RESTRICTION TO CONSTRUCT A CAR PARK AND AN				
(a) Pro	posed (s)/development						
	成用途/發展		NCILLARY PLANT ROOM AT BASEMENT LEVEL FOR				
		PE	PERMITTED RESIDENTIAL DEVELOPMENT				
		(Please	illustrate the details of the propo	sal on a layout plan 請用平面圖說明建議語	详情)		
(b) <u>Dev</u>	/elopment Schedule 發展	細節表					
Pro	posed gross floor area (G	FA) 擬	義總樓面面積	540.35 sg.m 平方米	☑About 約		
Proposed plot ratio 擬議地積比率				540.35 sq.m 平方米 Not more than 0.6	□About 約		
Proposed site coverage 擬議上蓋面積			費	24.24 %	M About 約		
Proposed no. of blocks 擬議座數				1			
Proposed no. of storeys of each block 每座建築物的擬議			每座建築物的擬議層數	4 storeys 層			
				☑ include 包括 1 storeys of basem			
				□ exclude 不包括storeys of bas	ements 層地庫		
Pro	posed building height of	each blo	ck 每座建築物的擬議高度	21.86 mPD 米(主水平基準上) 🗹 About 約		
				m 米	□About 約		

☑ Dor	nestic part	住用部分			
	GFA 總	婁面面穳		540.35, sq. m 平方米	MAbout 約
	number (of Units 單位數目		1	
	average	unit size 單位平均面	稽	.540.35sq. m 平方米	√ □About 約
	_	i number of resident		6	V
	open nato.				
□ Nor	-domestic	part 非住用部分		GFA 總樓面面	元稿
		ace 食肆 and Shop	and Comicae	sq. m 平方米	□About 約
	hotel 酒		and services		□About 約
	noter (四)	ㅁ		sq. m 平方米	
				(please specify the number of room	
	مداند جب	مند اد		請註明房間數目)	
	office 辦			sq. m 平方米	
	shop and	services 商店及服务	务行業	sq. m 平方米	□About 約
		nent, institution or co 後構或社區設施	ommunity facilities	(please specify the use(s) and area(s)/GFA(s) 請註明用途及有關 樓面面積)	的地面面積/總
				••••••	**********
				••••••	****
	other(s)	其他		(please specify the use(s) and area(s)/GFA(s) 請註明用途及有關 樓面面積)	的地面面積/總
				•••••	

	n mana H	- 海色 田 - 山		(mloope gnosify land swee(s) 全主计即	tsb 757 757 158 1
	n space (†		EE .Lib	(please specify land area(s) 請註明	
		pen space 私人休憩		sq. m 平方米 口 Not	
<u> </u>	public of	en space 公眾休憩	书 地	sq. m 平方米 口 Not	less than 个少於
(c) Use(s)) of differe	ent floors (if applicat	ole) 各樓層的用途 (如道	適用)	
[Block n	umber]	[Floor(s)]		[Proposed use(s)]	
[座	数]	[層數]		[擬議用途]	
1		B/F	Car Parking Spage	og / Plant Pooms / Water Toules	
		***************************************	***************************************	es / Plant Rooms / Water Tanks	
•••••		G/F	Padraama	Room / Living Room / Dining Room	
**********		1/F 2/F	Bedrooms / Flat F	 Roof	
	******	R/F	T1-4 D 6		
	*******		Flat Roof		
(d) Propo	sed use(s)	of uncovered area (fany) 露天地方(倘有)的擬議用途	
		******************		••••	
		*******		•••••	
*********	******	*******			,,,,,,,,,,,,,,,,,,,,,,,,,,,,,,,,,,,,,

7. Anticipated Completion Time of the Development Proposal 擬議發展計劃的預計完成時間					
擬議發展計劃預期完成的年份及 (Separate anticipated completion Government, institution or commi	Anticipated completion time (in month and year) of the development proposal (by phase (if any)) (e.g. June 2023) 擬議發展計劃預期完成的年份及月份 (分期 (倘有)) (例: 2023 年 6 月) (Separate anticipated completion times (in month and year) should be provided for the proposed public open space and Government, institution or community facilities (if any)) (申請人須就擬議的公眾休憩用地及政府、機構或社區設施(倘有)提供個別擬議完成的年份及月份)				
5/2029					
***************************************	· · · · · · · · · · · · · · · · · · ·				
		••••••	•••••		
			• • • • • • • • • • • • • • • • • • • •		
	• • • • • • • • • • • • • • • • • • • •		•••••		
8. Vehicular Access Arra 擬議發展計劃的行	_	t of the Development Proposal 安排			
Any vehicular access to the site/subject building? 是否有車路通往地盤/有關建築物?	Yes 是	 ✓ There is an existing access. (please indicate the street paperopriate) 有一條現有車路。(請註明車路名稱(如適用)) LINCOLN ROAD □ There is a proposed access. (please illustrate on plan and special paperopriate) 有一條擬議車路。(請在圖則顯示,並註明車路的闊度) 	 ify the width)		
	No 否				
Any provision of parking space for the proposed use(s)? 是否有為擬議用途提供停車位?	Yes 是	▼ (Please specify type(s) and number(s) and illustrate on plan) 請註明種類及數目並於圖則上顯示) Private Car Parking Spaces 私家車車位 Motorcycle Parking Spaces 電單車車位 Light Goods Vehicle Parking Spaces 輕型貨車泊車位 Medium Goods Vehicle Parking Spaces 中型貨車泊車位 Heavy Goods Vehicle Parking Spaces 重型貨車泊車位 Others (Please Specify) 其他 (請列明) Accessible Visitor Car Parking Space	3 1		
	No否		· · · · · ·		
Any provision of loading/unloading space for the proposed use(s)? 是否有為擬議用途提供上落客資車位?	Yes 是	 ✓ (Please specify type(s) and number(s) and illustrate on plan) 請註明種類及數目並於圖則上顯示) Taxi Spaces 的士車位 Coach Spaces 旅遊巴車位 Light Goods Vehicle Spaces 輕型貨車車位 Medium Goods Vehicle Spaces 中型貨車車位 Heavy Goods Vehicle Spaces 重型貨車車位 Others (Please Specify) 其他 (講列明) 	<u>T</u>		
	No 否				

9. Impacts of De	velopme	ent Proposal 擬議發	展計劃的影響		
justifications/reasons for	r not provi	sheets to indicate the propiding such measures. 國家少可能出現不良影響的		_	ndverse impacts or give
	Yes 是	☐ Please provide detail:	: 請提供詳情		
Does the development					
proposal involve alteration of existing			*****		
building?			*******		
擬議發展計劃是否	!				
包括現有建築物的		***************************************	********************		*********************
改動?	No 否	lacksquare	*************	• • • • • • • • • • • • • • • • • • • •	
			-t (t 2	11 1/ 1/2	
	Yes 是		·	-	articulars of stream diversion,
		the extent of filling of land/			t on the state of the state and the state of
Does the development			土地/池塘界線・以及	河遁改道、填塘、填:	上及/或挖土的細節及/或範
proposal involve the operation on the		圍)			
right?		Diversion of stream	n河道改道		
擬議發展是否涉及		□ Filling of pond 填	磨		
右列的工程?				so.m 平方米	口About 約
(Note: where Type (ii)		=	塘深度		□About 約
application is the subject of application,					
please skip this		☐ Filling of land 填土			
section.	,	_	:面積		
註: 如申請涉及第		Depth of filling 填	土厚度	m 米	□About 約
(ii)類申請,請跳至下		Excavation of land			
一條問題。)		Area of excavation	挖土面積689.1	l.65 sq.m 平方米	MAbout 約
		Depth of excavation	n 挖土深度 6.8	m 米	☑About 約
	No 否	PLEASE REFER	TO DWG. NO. P-0	02 OF APPENDI	X 4 OF PLANNING
<u> </u>		STATEMENT onment 對環境	···		
	On enviro	onment 對環境		Yes 會 🗌	No 不會 忆
	On traffic	; 對文通 supply 對供水		Yes 會 □ Yes 會 □	No 不會 ☑ No 不會 ☑
		ige 對排水		Yes 會 🗌	No 不會 🖸
	On slope			Yes 會 🗌	No 不會 🗹
		by slopes 受斜坡影響		Yes 會 🗌	No 不會 🖸
		e Impact 構成景觀影響		Yes 會 🗌	No 不會 🗾
		ing 砍伐樹木		Yes 會 🗀	No 不會 ☑
		ipact 構成視覺影響 Hease Specify) 其他 (請列	HE/	Yes 會 □ Yes 會 □	No 不會 ② No 不會 ②
Would the	Odiets (1	iease opecity) 英恒 (調內i	73)	I e2 屬 □	140 小場 [2]
development					
proposal cause any					
adverse impacts?		ate measure(s) to minimis			ease state the number,
擬議發展計劃會否 造成不良影響?	請註明證	at breast height and species 量減少影響的措施。如涉 種(倘可)			收目、及胸高度的樹幹
	*******			•••••	
					•
		••••••	***********		•••••

Gist of Applica	tion F	申請摘要				
consultees, uploaded available at the Plant	to the ' ning Enq 文填寫 到資料查	Town Planning Boa uiry Counters of the 。此部分將會發送 詢處供一般參閱。	rd's Website fo Planning Depa 予相關諮詢人士)	s possible. This par or browsing and free rtment for general inf 上、上載至城市規劃	downloading formation.)	by the public and
Application No. 申請編號	(For Of	ficial Use Only) (請勿	刃填寫此欄)			
Location/address 位置/地址	NO. 3	O. 3 LINCOLN ROAD, KOWLOON TONG, KOWLOON (NKIL 713)				
Site area 地盤面積			945.28	s	q. m 平方米	☑ About 約
心盆山1月	(include	es Government land	of包括政府:	土地	sq. m 平方米	:□ About 約)
Plan 圖則	APP S/K1		OON TONG	GOUTLINE ZO	NING PLA	N (OZP) NO.
Zoning 地帶	"RESIDENTIAL (GROUP C)(1)"					
Applied use/ development 申請用途/發展	MINOR RELAXATION OF BUILDING HEIGHT RESTRICTION TO CONSTRUCT A CAR PARK AND AN ANCILLARY PLANT ROOM AT BASEMENT LEVEL FOR PERMITTED RESIDENTIAL DEVELOPMENT				ROOM AT	
(i) Gross floor are and/or plot rat			sq.ı	n 平方米	Plot Ra	tio 地積比率
總樓面面積及 地積比率		Domestic 住用	540.35	☑ About 約 □ Not more than 不多於	0.6	□About 約 ☑Not more than 不多於
		Non-domestic 非住用		□ About 約 □ Not more than 不多於		□About 約 □Not more than 不多於
(ii) No. of blocks 憧數		Domestic 住用		1		
		Non-domestic 非住用				
		Composite 綜合用途				

(111)	Building height/No. of storeys 建築物高度/層數	Domestic 住用		m 米□ (Not more than 不多於)
				mPD 米(主水平基準上)□ (Not more than 不多於)
				Storeys(s) 層 ✔(Not more than 不多於)
			4	(Minclude 包括/ Exclude 不包括 Carport 停車間 Masement 地庫 Refuge Floor 防火層 Podium 平台)
		Non-domestic 非住用 Composite 綜合用途		m 米□ (Not more than 不多於)
				mPD 米(主水平基準上)□ (Not more than 不多於)
				Storeys(s) 層 □ (Not more than 不多於)
				(□Include 包括/□ Exclude 不包括 □ Carport 停車間 □ Basement 地庫 □ Refuge Floor 防火層 □ Podium 平台)
				m 米□ (Not more than 不多於)
				mPD 米(主水平基準上) 口 (Not more than 不多於)
				Storeys(s) 層 □ (Not more than 不多於)
				(□Include 包括/□ Exclude 不包括 □ Carport 停車間 □ Basement 地庫 □ Refuge Floor 防火層 □ Podium 平台)
(iv)	Site coverage 上蓋面積		24.24	☑ About 約
(v)	No. of units 單位數目	1		
(vi)	Open space 休憩用地	Private 私人		sq.m 平方米 🗆 Not less than 不少於
		Public 公眾		sq.m 平方米 🗆 Not less than 不少於

(vii)	No. of parking spaces and loading /	Total no. of vehicle parking spaces 停車位總數	4
	unloading spaces	Private Car Parking Spaces 私家車車位	3
	停車位及上落客貨 車位數目	Motorcycle Parking Spaces 電單車車位	
	一世級人口	Light Goods Vehicle Parking Spaces 輕型貨車泊車位	
		Medium Goods Vehicle Parking Spaces 中型貨車泊車位 Heavy Goods Vehicle Parking Spaces 重型貨車泊車位	
		Others (Please Specify) 其他 (請列明)	1
		Accessible Visitor Car Parking Space	
		Total no. of vehicle loading/unloading bays/lay-bys	1
		上落客貨車位/停車處總數	1
		Taxi Spaces 的士車位	
		Coach Spaces 旅遊巴車位	
		Light Goods Vehicle Spaces 輕型貨車車位	1
		Medium Goods Vehicle Spaces 中型貨車位	
		Heavy Goods Vehicle Spaces 重型貨車車位 Others (Please Specify) 其他 (請列明)	

Submitted Plans, Drawings and Documents 提交的圖則、繪圖及文件	·····	
	<u>Chinese</u> 中文	English 英文
Plans and Drawings 圖則及繪圖		
Master layout plan(s)/Layout plan(s) 總綱發展藍圖/布局設計圖		Z
Block plan(s) 樓宇位置圖		
Floor plan(s) 樓宇平面圖		
Sectional plan(s) 截視圖		
Elevation(s) 立視圖		
Photomontage(s) showing the proposed development 顯示擬議發展的合成照片		
Master landscape plan(s)/Landscape plan(s) 園境設計總圖/園境設計圖		
Others (please specify) 其他(請註明) Location Plan, Lot Index Plan, Excavation Plan and Extract of Kowloon		Z
Tong Outline Zoning Plan		
Reports 報告書		
Planning Statement/Justifications 規劃綱領/理據		\mathbf{Z}
Environmental assessment (noise, air and/or water pollutions)		
環境評估(噪音、空氣及/或水的污染)		
Traffic impact assessment (on vehicles) 就車輛的交通影響評估		
Traffic impact assessment (on pedestrians) 就行人的交通影響評估		
Visual impact assessment 視覺影響評估		
Landscape impact assessment 景觀影響評估		
Tree Survey 樹木調查		
Geotechnical impact assessment 土力影響評估		
Drainage impact assessment 排水影響評估		
Sewerage impact assessment 排污影響評估		
Risk Assessment 風險評估		
Others (please specify) 其他(請註明)		
Note: May insert more than one 「レ」、註:可在多於一個方格内加上「レ」號		

Response-to-Comments

	Departmental Comments		Responses
	DPO/Kln, Planning Department (PlanD)		*
1.	It is noted that the basement size is 715m ² , which is equivalent to about 76% of the site area and about 134% of the proposed GFA, please justify and demonstrate the scale of proposed basement is not excessive.		requirement, 1 no. of additional PC parking space at basement level and 1 no. of LGV L/UL bay is
			Nevertheless, the proposed basement area is reduced from 715m ² to 689.165m ² for minimizing the basement size to accommodate 282.279m ² of car parking spaces and manoeuvring spaces, 241.867m ² of ancillary plant rooms, 129.819m ² of ramp, 33.9m ² lift and circulation space and 1.3m ² of pipe duct.
2.	Please clarify and confirm if the proposed basement structure would limit the at-grade planting area.] i	Please note that the proposed basement will not limit the area for at-grade planting. The area immediately above the basement would be occupied by the building footprint while the remaining area would be a large lawn area with soil depth of about 600mm. Hence, the basement will not affect the area for at-grade planting.
3.	It is mentioned in paragraph 6.5 of planning statement that open landscaped area will be provided at ground level, however, no detailed information about the proposed open landscaped area was included in the planning statement. Please elaborate. Please also provide a landscape design proposal clearly demonstrate the landscape treatment and greenery ratio	E F	

for our assessment.

It is noted from paragraph 6.4 of planning statement | The proposed minor relaxation of BHR can that "Placing the proposed car parking spaces and ancillary plant rooms at the basement level can reduce the building bulk and provide more open spaces at ground level for gardening and landscaping purposes, which would definitely improve air ventilation and amenity in the area". Please elaborate how the proposed relaxation of BHR can improve air ventilation and amenity in the area. Please also provide an alternative scheme (with carparks and plant rooms NOT in the basement) to justify the necessity of the proposed basement.

improve air ventilation and amenity in the area due to the followings:

- (a) Building bulk is minimized as far as possible by placing the ancillary plant rooms and car parking spaces at the basement, and allowing the provision of a larger greenery / landscaping area.
- (b) Set back of 6m from Lincoln Road in accordance with the non-building area (NBA) requirement for streetscape enhancement as stipulated under the Kowloon Tong Outline Development Plan (ODP).
- (c) Stepped terraced design by setting back 2/F with landscaped flat roof are provided to break down the visual bulk of the proposed development as viewed from pedestrian level, and to allow the provision of curvilinear planter connecting the different floors, which soften the building mass and also enhance the amenity of the development as well as the neighbourhood.
- (d) Landscaping is proposed at grade with combination of trees, shrubs and ground cover within the site, which will be visible to the public to enhance the amenity of the public realm.

Please see the Alternative Scheme (without basement) at Appendix 2 for showing the difference below:

(a) The landscape area would reduce from 193,461m² to 64,304m². (b) The ancillary plant rooms would have to be provided at roof level and there would be more bulky building design. (c) The car parking spaces and loading/unloading (L/UL) bay for meeting the requirements from the Commissioner for Transport (C for T) and the required maneuvering areas would have to be located at-grade and would occupy major portion of the open area. Nevertheless, the proposed basement area is reduced from 715m² to 689.165m² for minimizing the basement size. The revised proposed basement area is devised based on the functional, building services, geotechnical and structural design requirements of the house. 5. Please provide planning and design merits to justify the Please see the planning and design merits in proposed relaxation of BHR. response to the assessment criteria as set out in the Explanatory Statement (ES) of the OZP for minor relaxation of BH restriction below: Providing Better Streetscape / Good Quality Street Level Public Urban Space Building bulk is minimized as far as possible by placing the ancillary plant rooms and car parking spaces and L/UL bay at the basement, and allowing the provision of a larger greenery / landscaping area. Set back of 6m from Lincoln Road in

accordance with the non-building area (NBA) requirement for streetscape enhancement as stipulated under the Kowloon Tong Outline Development Plan (ODP).

- Stepped terraced design by setting back 2/F with landscaped flat roof are provided to break down the visual bulk of the proposed development as viewed from pedestrian level, and to allow the provision of curvilinear planter connecting the different floors, which soften the building mass and also enhance the amenity of the development as well as the neighbourhood.
- Landscaping is proposed as grade with combination of trees, shrubs and ground cover within the site, which will be visible to the public to enhance the amenity of the public realm.

Providing Separation Between Buildings to Enhance Air and Visual Permeability

- Adopting a stepped terraced design by setting back 2/F with landscaped flat roof to break down the visual bulk of the proposed development as viewed from pedestrian level, hence air and visual permeability for pedestrians on Lincoln Road will be improved.

Innovative Building Design

 An innovative building design with more free-form design approach together with the stepped terrace (setting back 2/F with landscaped flat roof) and adequate greenery, will increase public visual interest to the

		neighbourhood as part of the Kowloon Tong Garden Estate (KTGE).
		Provision of At-grade Planting The proposed basement will not limit the area for at-grade planting. The area immediately above the basement would be occupied by the building footprint while the remaining area would be a large lawn area with soil depth of about 600mm. Hence, the basement will not affect the area for at-grade planting.
		Provision of Rainwater Recycling Plant Room - The proposed development includes a rainwater recycling plant room for compliance with Sustainable Building Design Guidelines.
	Landscape Unit, Planning Department (PlanD)	
1.	Based on the aerial image of GIH in 2024 and street view in Google Map in 2023, the site was covered with lush planting of trees. The applicant should clarify for the missing trees in the current application.	
2.	According to para. 6.4.1 of the current application, it was mentioned that the proposed development could provide more open spaces at ground level for gardening and landscaping purposes. The proposed landscape	1200mm) would be provided for at-grade tree planting.
	areas should be demarcated on plan for reference. The Applicant is also advised that sufficient soil depth (at least 1200mm) should be provided for at-grade tree planting.	·
3.	The applicant is reminded that approval of the s.16 application under Town Planning Ordinance does not imply approval of the site coverage of greenery requirements under BD's PNAP APP-152. The site	Noted.

τ,

	coverage of greenery calculation should be submitted separately to BD for approval as appropriate.	
	Transport Department (TD)	
	Please find below comments on the subject application from traffic engineering perspective:	•
(i)	I have no adverse comment on proposed vehicular access with clear width not exceeding 5m provided it is located within the specified X-Z-Y points according to the lease.	Noted.
(ii)	For the proposed development comprising one single family house with GFA>160m ² , 3 nos. of ancillary PC parking spaces, 1 no. of visitor PC parking space, and 1 no. of GV loading/unloading bay according to HKPSG should be provided.	In order to meet the requirement, additional 1 no. of ancillary PC parking spaces is provided at basement level and 1 no. of LGV L/UL Bay is provided at G/F. Please see the revised Proposed Layout Plans at Appendix 1.
(iii)	The applicant shall provide swept path analysis on the parking spaces and loading and unloading bay for GV.	Please see the revised Proposed Layout Plans at Appendix 1.
	Environmental Protection Department (EPD)	
	It is noted that the subject planning application does not include any environmental assessment. Based on the limited information, our comments on the subject planning application are given below:	•
(a)	On <u>air quality</u> , the applicant should provide clarification of the following for our further consideration.	*
(i)	Please confirm whether the buffer distance requirements for vehicular and chimney emissions (e.g. any active industrial chimney within 200m) stipulated under the Hong Kong Planning Standards and	Please note the followings: - there is no active industrial chimney within 200m from the site, as shown in the Indication Plan A at Appendix 4; and

	Guidelines (HKPSG) (re. Table 3.1, Chapter 9, HKPSG) can be met.	lot boundary in accordance with the non-building area (NBA) requirement for streetscape enhancement as stipulated under the Kowloon Tong Outline Development Plan (ODP). As shown in Indication Plan B at Appendix 4, a total of 8m buffer distance (6m NBA and 2m pavement) for vehicular
		emissions from Lincoln Road is provided; and - planters will also be provided in the 6m setback NBA as greenery buffer.
		Therefore, the buffer distance requirements for vehicular and chimney emissions stipulated under the Hong Kong Planning Standards and Guidelines (HKPSG) (re. Table 3.1, Chapter 9, HKPSG) can be met.
(ii)	As regards the proposed car parks at basement level,	It is confirmed that the relevant guidelines/practice
	please confirm whether the relevant guidelines/practice	
	notes, such as ProPECC PN 2/96 Control of Air	Pollution in Car Parks, etc will be followed.
	Pollution in Car Parks, etc will be followed.	•
(b)	On noise, adverse noise impact on the proposed	Noted.
	development are not anticipated. Nonetheless, the	
	applicant should ensure that the planning and design of	·
	the subject development will follow the relevant noise	•
	planning requirements under HKPSG to avoid causing any noise problems.	
	any noise problems.	
€	On sewerage, given the scale of the proposed	Noted.
	development, adverse sewerage impact arising from the	4
	proposed development are not anticipated. Please be	
	reminded that the implementation of local sewer	
	connection works shall meet the satisfaction of DSD.	
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	Buildings Department (BD)	
		2
	No objection to the application	
(a)	All building works are subject to compliance with the Buildings Ordinance (BO).	Noted.
(b)	Service Lane should be provided in accordance with Building (Planning) Regulation (B(P)R)28(1), if applicable. Such service lane should be excluded from site area for the purpose of plot ratio and site coverage calculations. B(P)R 23(2)(a) refers.	Noted.
€	Detailed comments under the BO on individual sites for private developments such as permissible plot ratio, site coverage, means of escape, emergency vehicular access, private streets, and/or access roads, open space, barrier free access and facilities, compliance with the sustainable building design guidelines, etc. will be formulated at the building plan submission stage.	Noted.
(d)	GFA concessions for the proposed basement carpark would be considered subject to compliance with the relevant criteria under PNAP APP-2.	Noted.
€	GFA concessions for the proposed basement for ancillary plant rooms and access staircase may be favourably considered at building plan submission stage.	Noted.
(f)	According to the general building plan approved on 23 May 2025, a 2-storey house over 1-level basement was proposed. The current proposal in this planning application for a 3-storey house over 1-level basement has not been submitted for approval under the BO.	Noted.
(g)	Second floor plan is not provided in Appendix 4 of	Please see the revised Proposed Layout Plans at

•;

	Planning Statement.	Appendix 1.
	Architectural Services Department (ArchSD)	e e
(1)	Based the information provided, it is noted that the proposed development mainly consists of an addition of a basement storey under a 3-storey house. As the proposal mainly pertains to planning issues which is outside ArchSD's purview, we are not in position to comment on it. Nevertheless, we would be glad to offer our advice when specific architectural or visual aspects of the case is called for.	Noted.
	The Geotechnical Engineering Office (GEO) of Civil Engineering and Development Department (GEO, CEDD)	
(1)	The Geotechnical Engineering Office (GEO) has no adverse geotechnical comment on the application.	Noted.
	Electrical and Mechanical Services Department (EMSD)	*
1.	No Comments from our regulatory services perspective.	Noted.


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Appendix 1

Revised Development Schedule and Proposed Layout Plans

Table 5.1 Proposed Development Schedule

. 178.0001		
Site Area	About 945.28m ²	
Plot Ratio	Not more than 0.6	
Site Coverage	About 24.24%	
Gross Floor Area	About 540.35m ²	
Building Height (Main Roof)	21.86m above PD	
No. of Storeys 4 (including a basement)		
No. of Units	1	
Proposed Floor Uses:		
Basement	Car Parking Spaces / Plant Rooms /	
	Water Tanks	
G/F	L/UL Bay / Garden / Study Room /	
	Living Room / Dining Room /	
	Kitchen	
1/F	Bedrooms	
2/F	Bedrooms / Flat Roof	
R/F	Flat Roof	
Provision of Internal Transport Facilities		
Car Parking Spaces (at Basement Level)		
- Private Car Parking Space (B/F)	3 (2.5m x 5m)	
- Accessible Visitor Car Parking Space (B/F)	1 (3.5m x 5m)	
- LGV L/UL Space (G/F)	1 (3.5m x 7m)	
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FOR APPLICATION UNDER S.16 OF TOWN PLANNING ORDINANCE (CAP. 131)

BD REF.

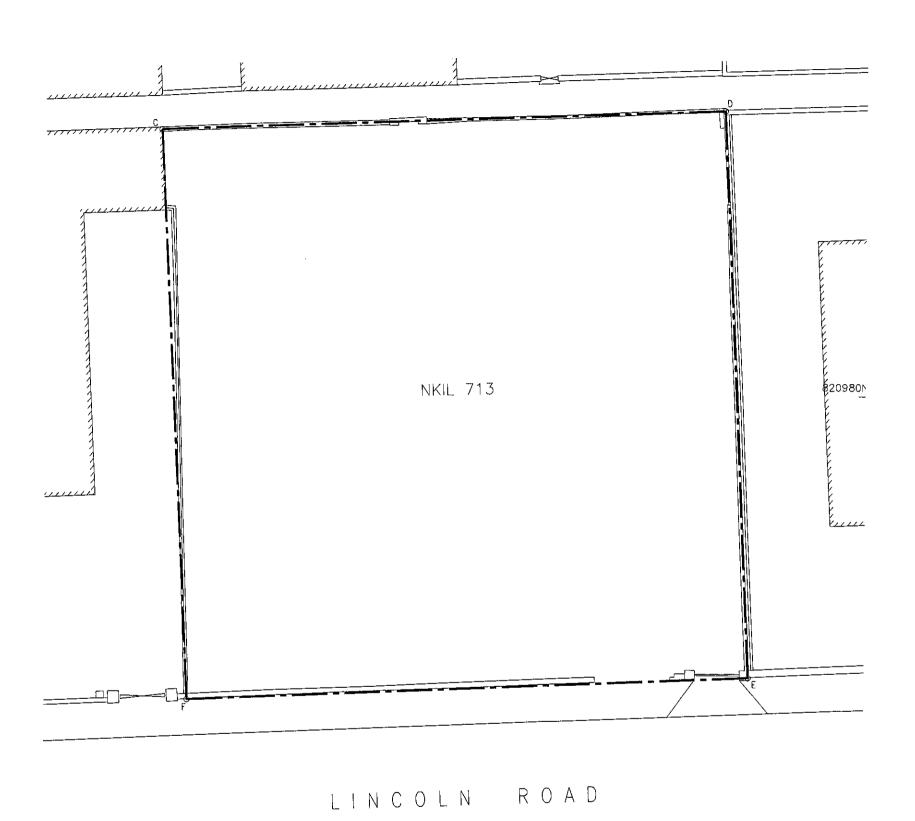FSD REF.

REV. DESCRIPTION DATE

A 1ST SUBMISSION 13 MAR 2025

CLIENT(S)

AUTHORIZED PERSON

SO CHI WANG MHKIS, RPS(BS) Authorized Person AP(S)1/16

STRUCTURAL ENGINEER

PROJECT TITLE

PROPOSED RESIDENTIAL DEVELOPMENT AT 3 LINCOLN ROAD, KOWLOON TONG, KOWLOON (N.K.I.L. 713)

DRAWING TITLE

BLOCK PLAN

DATE

13 MAR 2025 AS SHOWN

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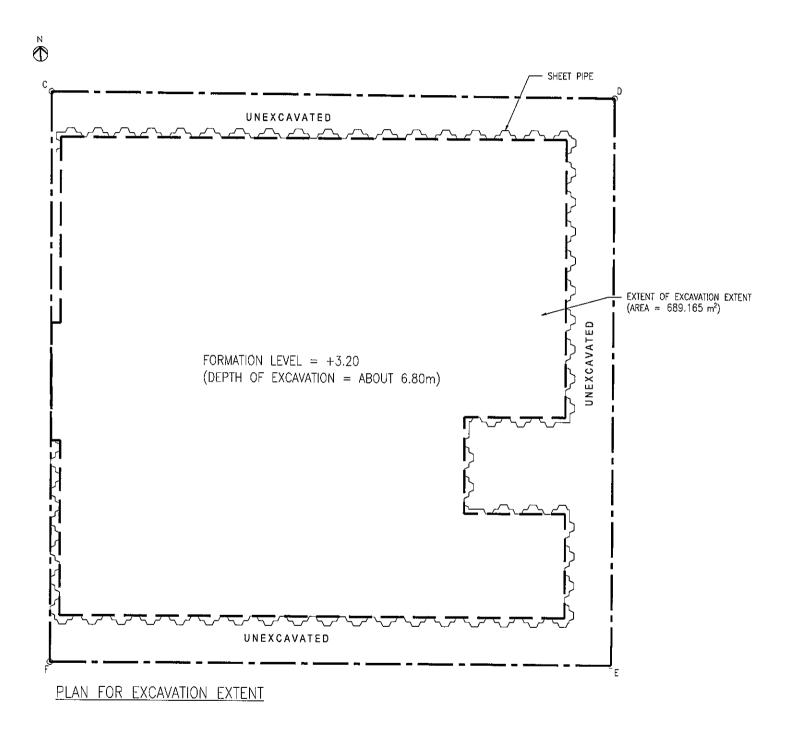
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> REV. DESCRIPTION A 1ST SUBMISSION 13 MAR 2025

CLIENT(S)

AUTHORIZED PERSON

SO CHI WANG MHKIS, RPS(BS) Authorized Person AP(S)1/16

STRUCTURAL ENGINEER

PROJECT TITLE

PROPOSED RESIDENTIAL DEVELOPMENT AT 3 LINCOLN ROAD, KOWLOON TONG, KOWLOON (N.K.I.L. 713)

DRAWING TITLE

PLAN FOR EXCAVATION EXTENT

DATE 13 MAR 2025 SCALE AS SHOWN

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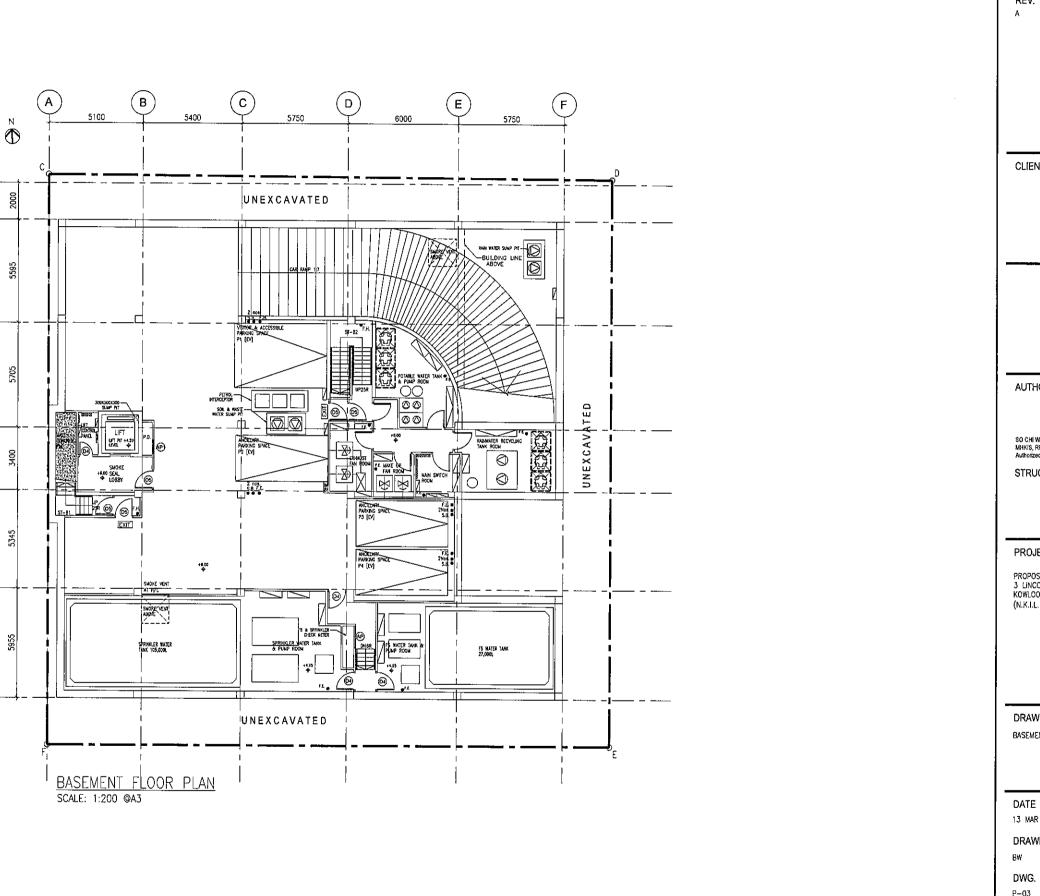
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FOR APPLICATION UNDER S.16 OF TOWN PLANNING ORDINANCE (CAP. 131)



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FOR APPLICATION UNDER S.16 OF TOWN PLANNING ORDINANCE (CAP. 131)

BD REF. FSD REF.

REV. DESCRIPTION DATE 1ST SUBMISSION 13 MAR 2025

CLIENT(S)

AUTHORIZED PERSON

STRUCTURAL ENGINEER

PROJECT TITLE

PROPOSED RESIDENTIAL DEVELOPMENT AT 3 LINCOLN ROAD, KWOLOON TONG, KOWLOON (N.K.I.L. 713)


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BASEMENT FLOOR PLAN

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REV. DESCRIPTION DATE

13 MAR 2025

1ST SUBMISSION

CLIENT(S)

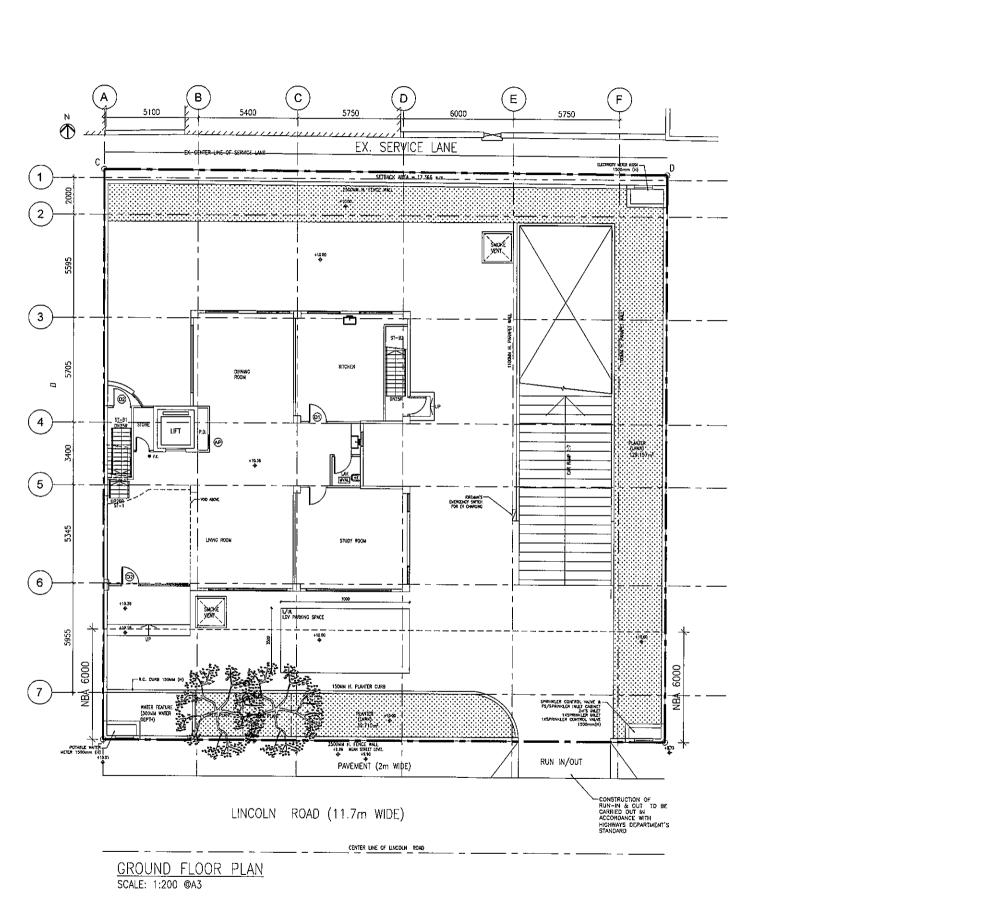AUTHORIZED PERSON

SO CHI WANG MHKIS, RPS(BS) Authorized Person AP(S)1/H

STRUCTURAL ENGINEER

PROJECT TITLE

PROPOSED RESIDENTIAL DEVELOPMENT AT 3 LINCOLN ROAD, KOWLOON TONG, KOWLOON (N.K.I.L. 713)

DRAWING TITLE

GROUND FLOOR

DATE SCALE
13 MAR 2025 AS SHOWN


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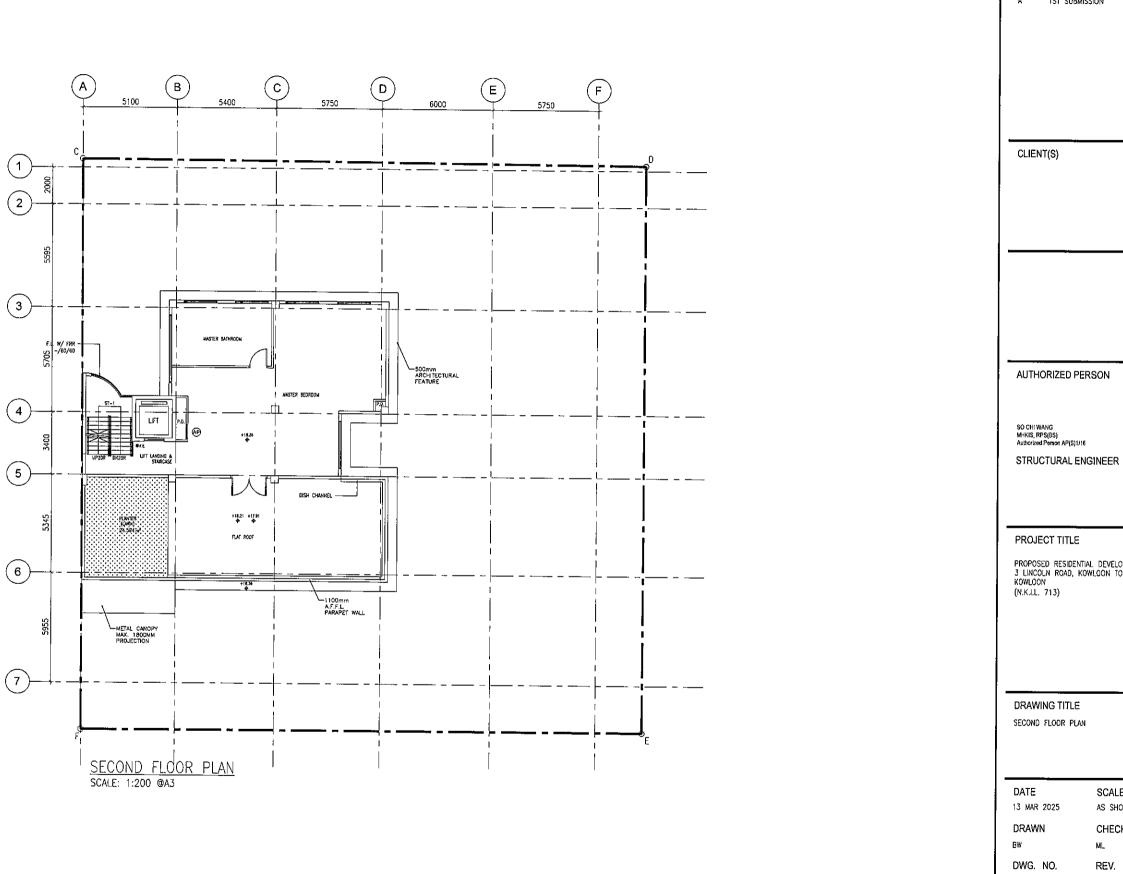
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FOR APPLICATION UNDER S.16 OF TOWN PLANNING ORDINANCE (CAP. 131)





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FOR APPLICATION UNDER S.16 OF TOWN PLANNING ORDINANCE (CAP. 131)

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REV. DESCRIPTION DATE 1ST SUBMISSION 13 MAR 2025

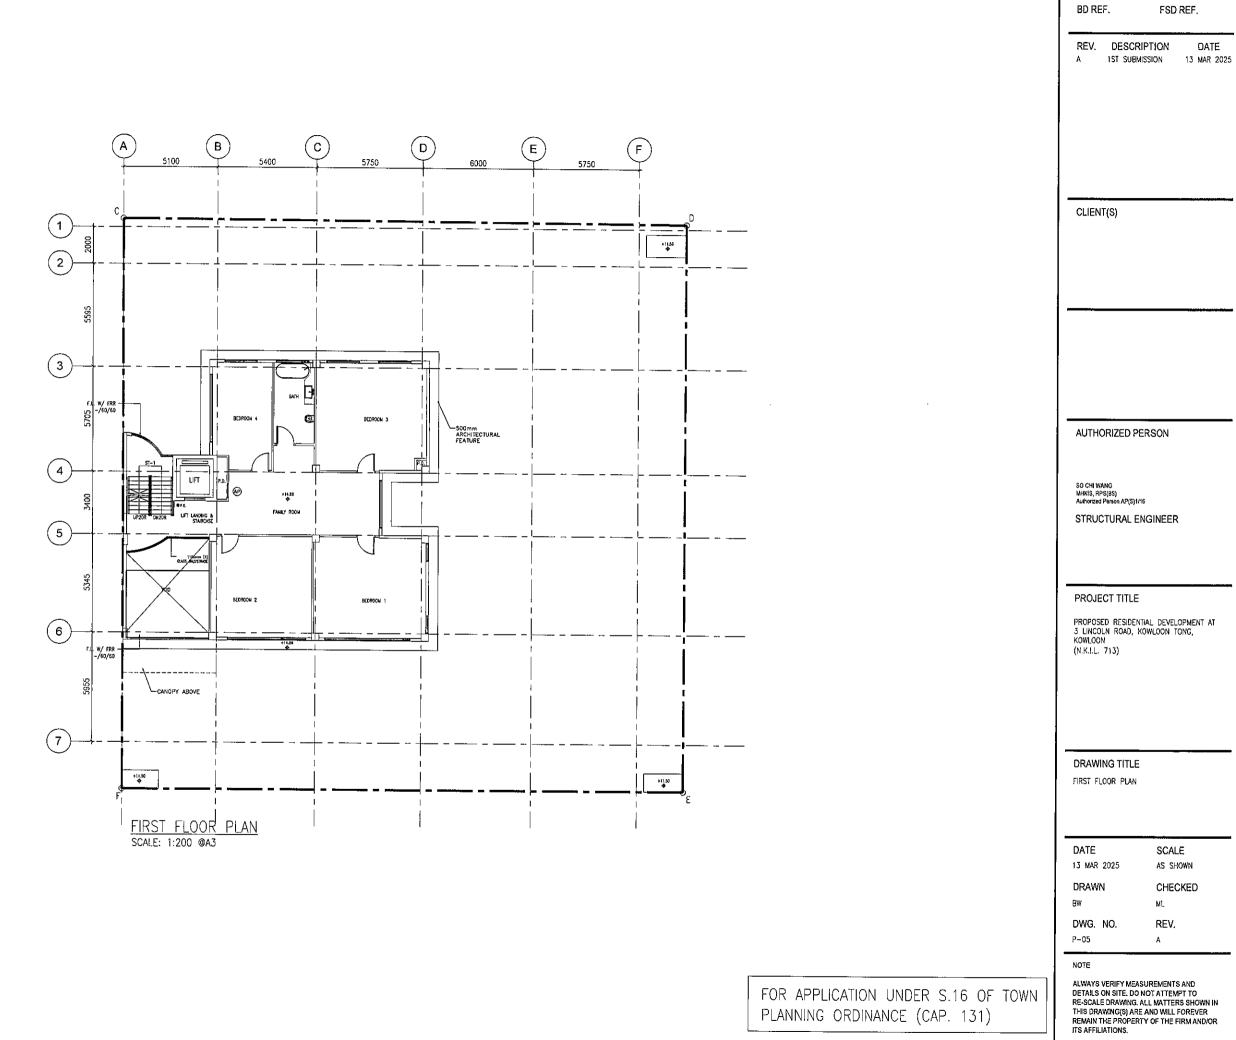PROPOSED RESIDENTIAL DEVELOPMENT AT 3 LINCOLN ROAD, KOWLOON TONG, KOWLOON (N.K.I.L. 713)

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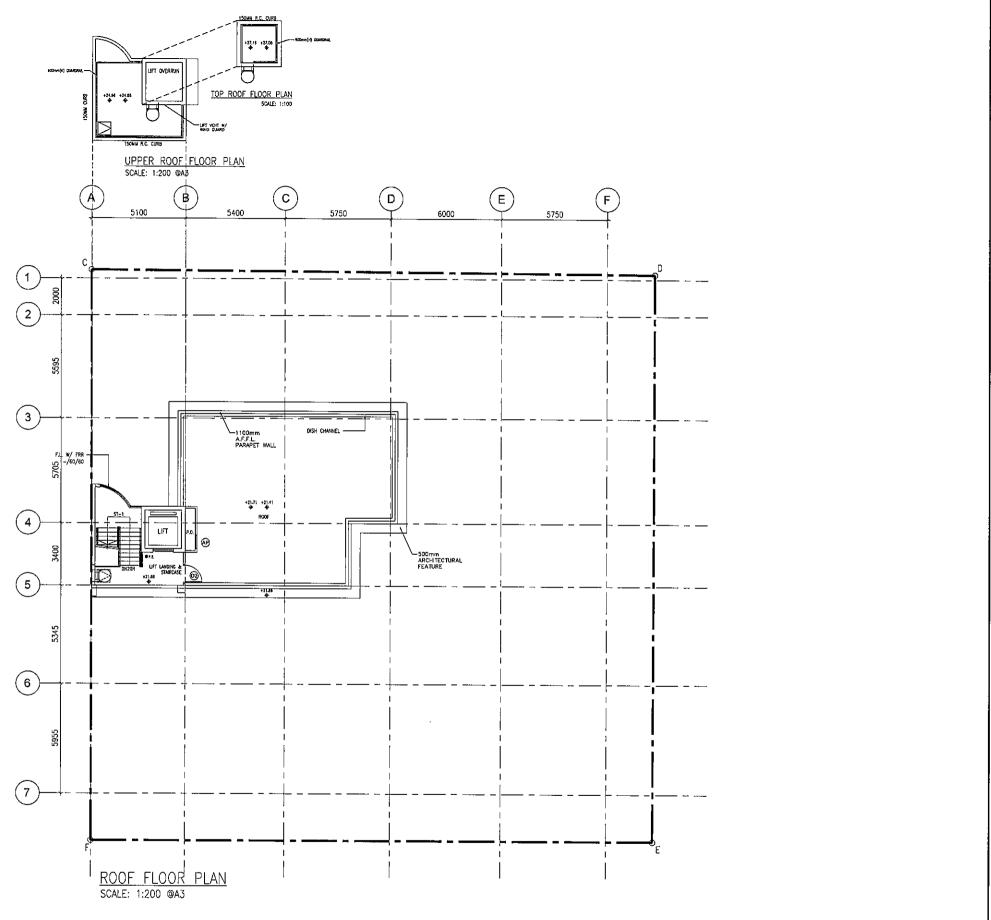
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FOR APPLICATION UNDER S.16 OF TOWN PLANNING ORDINANCE (CAP. 131)

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REV. DESCRIPTION DATE
A 1ST SUBMISSION 13 MAR 2025

CLIENT(S)

AUTHORIZED PERSON

SO CHI WANG MHKIS, RPS(BS) Authorized Person AP(S)1/16

STRUCTURAL ENGINEER

PROJECT TITLE

PROPOSED RESIDENTIAL DEVELOPMENT AT 3 LINCOLN ROAD, KOWLOON TONG, KOWLOON (N.K.I.L. 713)

DRAWING TITLE

ROOF AND UPPER ROOF FLOOR PLAN

 DATE
 SCALE

 13 MAR 2025
 AS SHOWN

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SITE COVERAGE AND PLOT RATIO CALCULATION SITE AREA = LOT AREA CLASS OF SITE = 945.28 m² BUILDING HEIGHT = A = ROOF LEVEL - GROUND FLOOR LEVEL = 21.86 -- 10 = 11.86m PROPOSED PLOT RATIO = 540.35 / 945.28 = 0.572 GROUND FLOOR = 205.212 m² FIRST FLOOR = 205.901 m² SECOND FLOOR = 129.238 m² ROOF = -

TOTAL GFA = 540.35 m²

PERMITTED SITE COVERAGE = 66.6%

PROPOSED SITE COVERAGE = 229.090 / 945.28

= 24.24 % (PRO.) < 66.6% (PER.)

AREA OF GFA CONCESSION

BASEMENT: 1. CAR PARKING SPACE & MANEUVERING SPACE 2. CAR RAMP 3. ESSENTIAL PLANT ROOMS 4. LIFT AND CIRCULATION SPACE 5. PIPE DUCT	= 282.279 m ² = 129.819 m ² = 241.867 m ² = 33.900 m ² = 1.300 m ²
TOTAL BASEMENT AREA	= 689.165 m ²
G/F: 1. INDEPENDENT STAIRCASE FOR EMERGENCY EXIT 2. F.S.I., ELECTRICITY METER KIOSK & POTABLE WATER METER	= 15.944 m ² = 6.765 m ²
1/F: 1. VOID	= 16.424 m ²
R/F: 1. DOG HOUSE 2. STAIRCASE & LIFT SHAFT	= 1.625 m ² = 24.398 m ²
TOTAL	= 754.321 m ²

TOTAL CONSTRUCTION AREA


BASEMENT FLOOR GROUND FLOOR FIRST FLOOR SECOND FLOOR ROOF	= = = = =	689.165 m ² 227.921 m ² 222.325 m ² 129.238 m ² 26.023 m ²
TOTAL AREA	_	1294.672 m ²

LANSCAPE AREA

TOTAL AREA		193.461 m ²
SECOND FLOOR	=	24,594 m ²
GROUND FLOOR	_	168.867 m ²

LANSCAPE RATIO

193.461 m^2 (PROVIDED) / 945.28 m^2 = 20.456 %

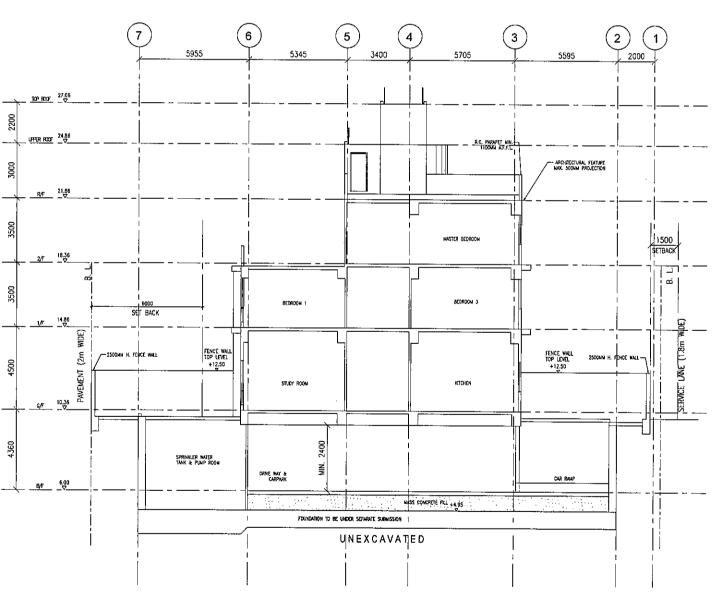

<u>SECTION 1-1</u> SCALE: 1:200 @A3

FOR APPLICATION UNDER S.16 OF TOWN PLANNING ORDINANCE (CAP. 131)

BD REF. FSD REF.

REV. DESCRIPTION DATE
A 1ST SUBMISSION 13 MAR 2025

CLIENT(S)

AUTHORIZED PERSON

SO CHI WANG
MHKIS, RPS(38)
Authorized Person AP(S)1/16
STRUCTURAL ENGINEER

PROJECT TITLE

PROPOSED RESIDENTIAL DEVELOPMENT AT 3 LINCOLN ROAD, KOWLOON TONG, KOWLOON (N.K.I.L. 713)


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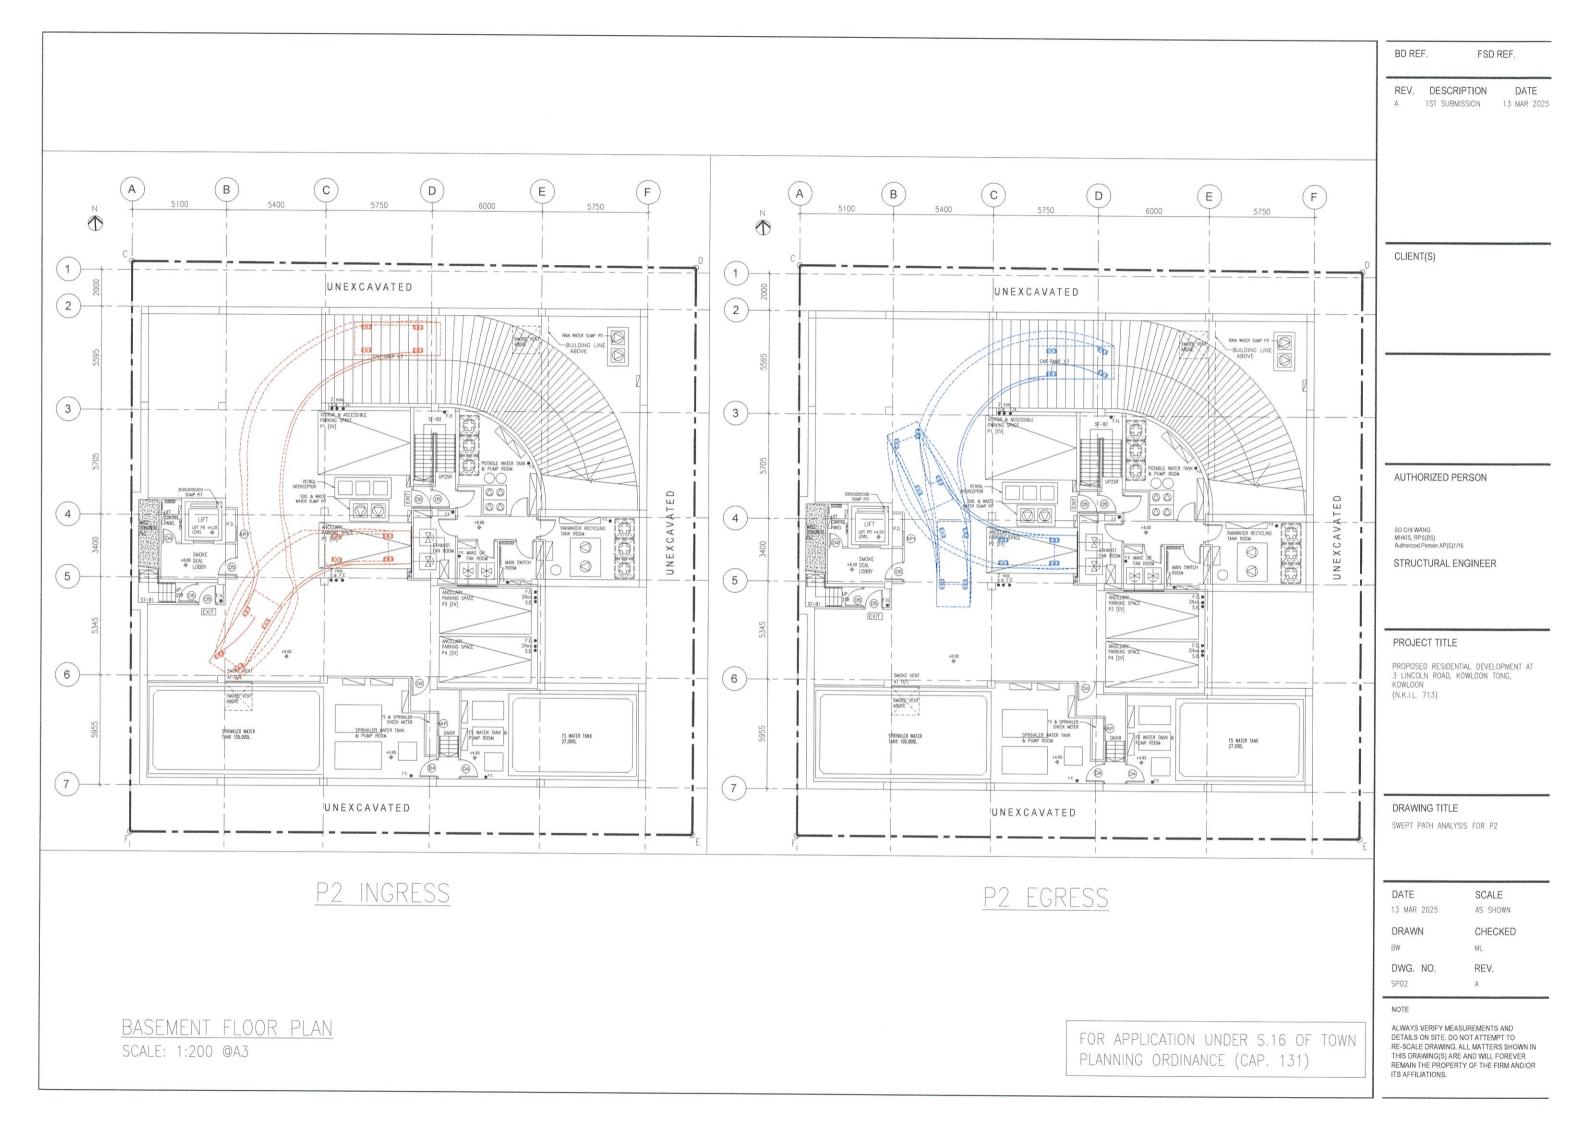
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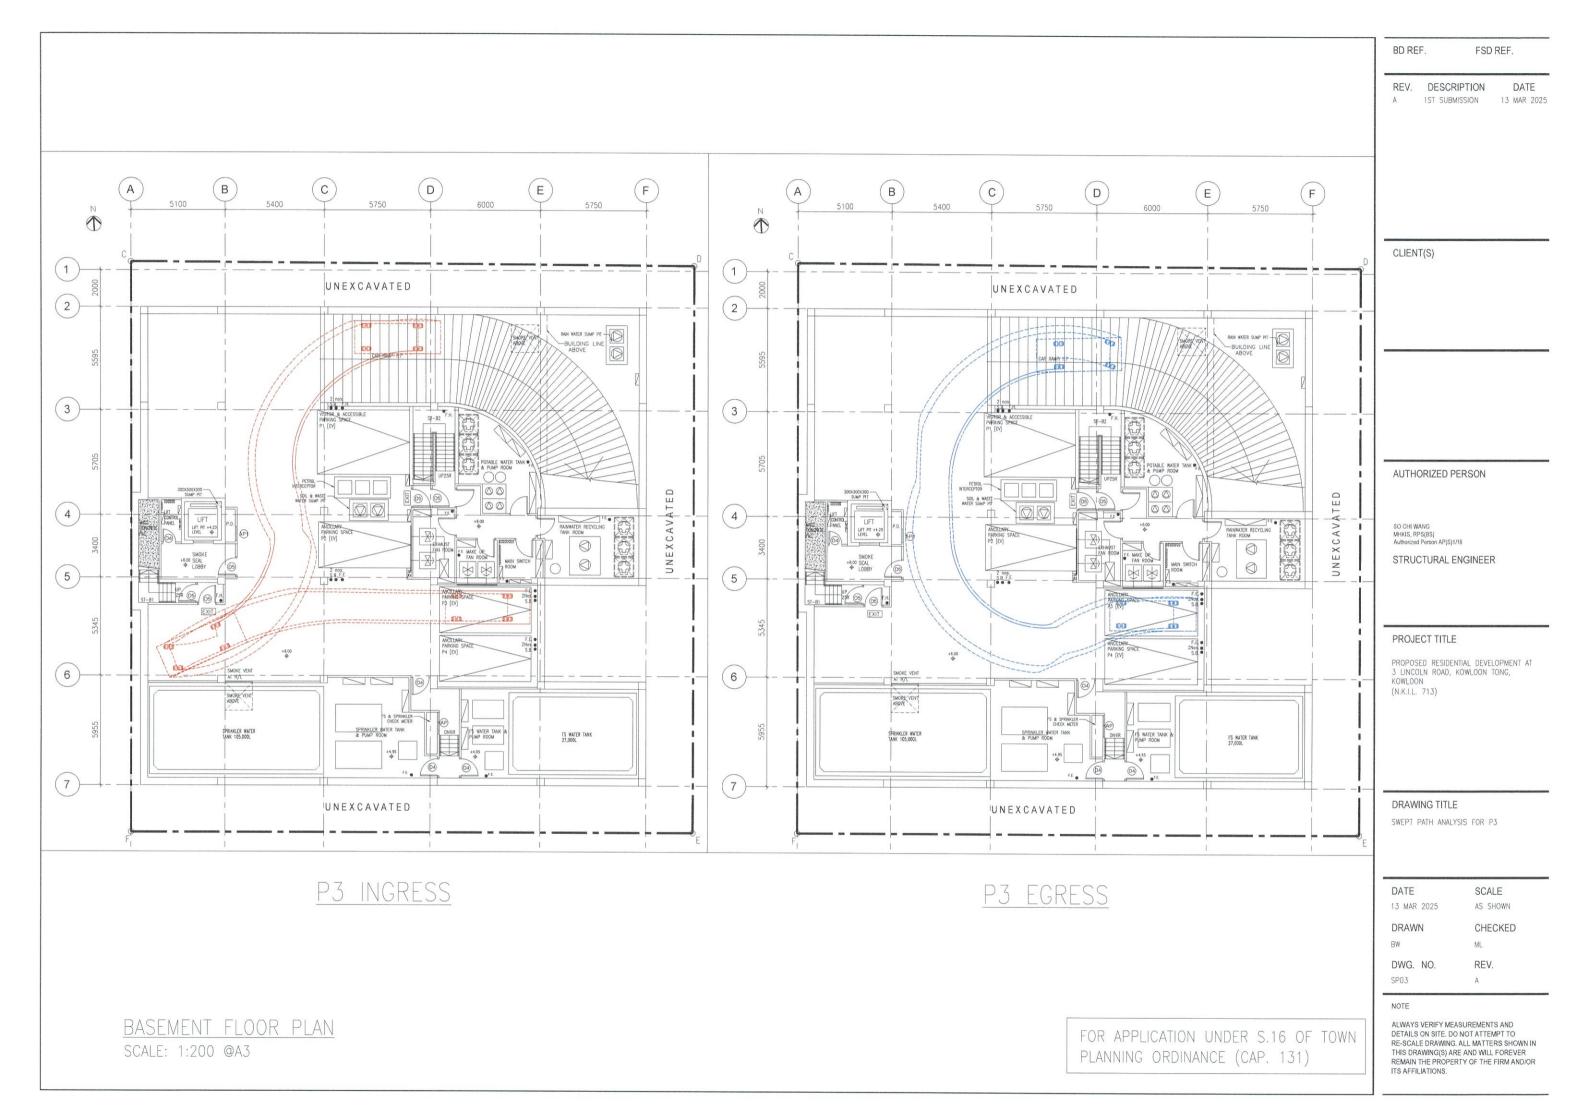
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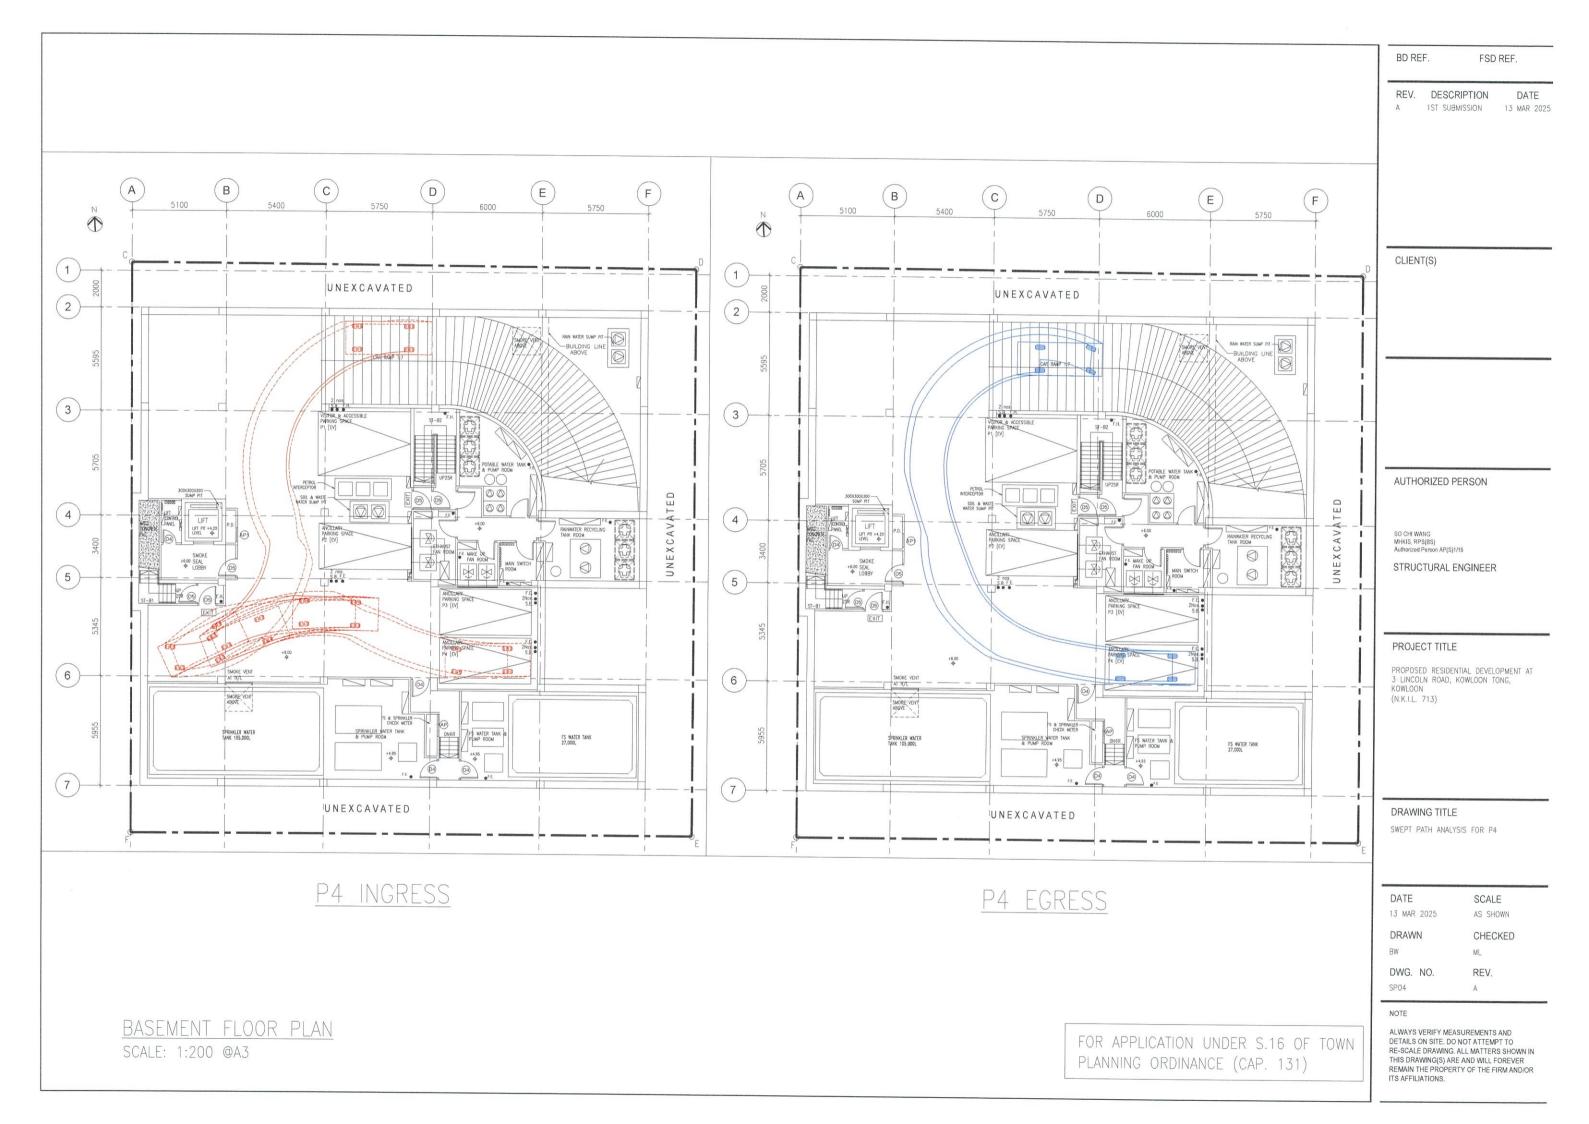
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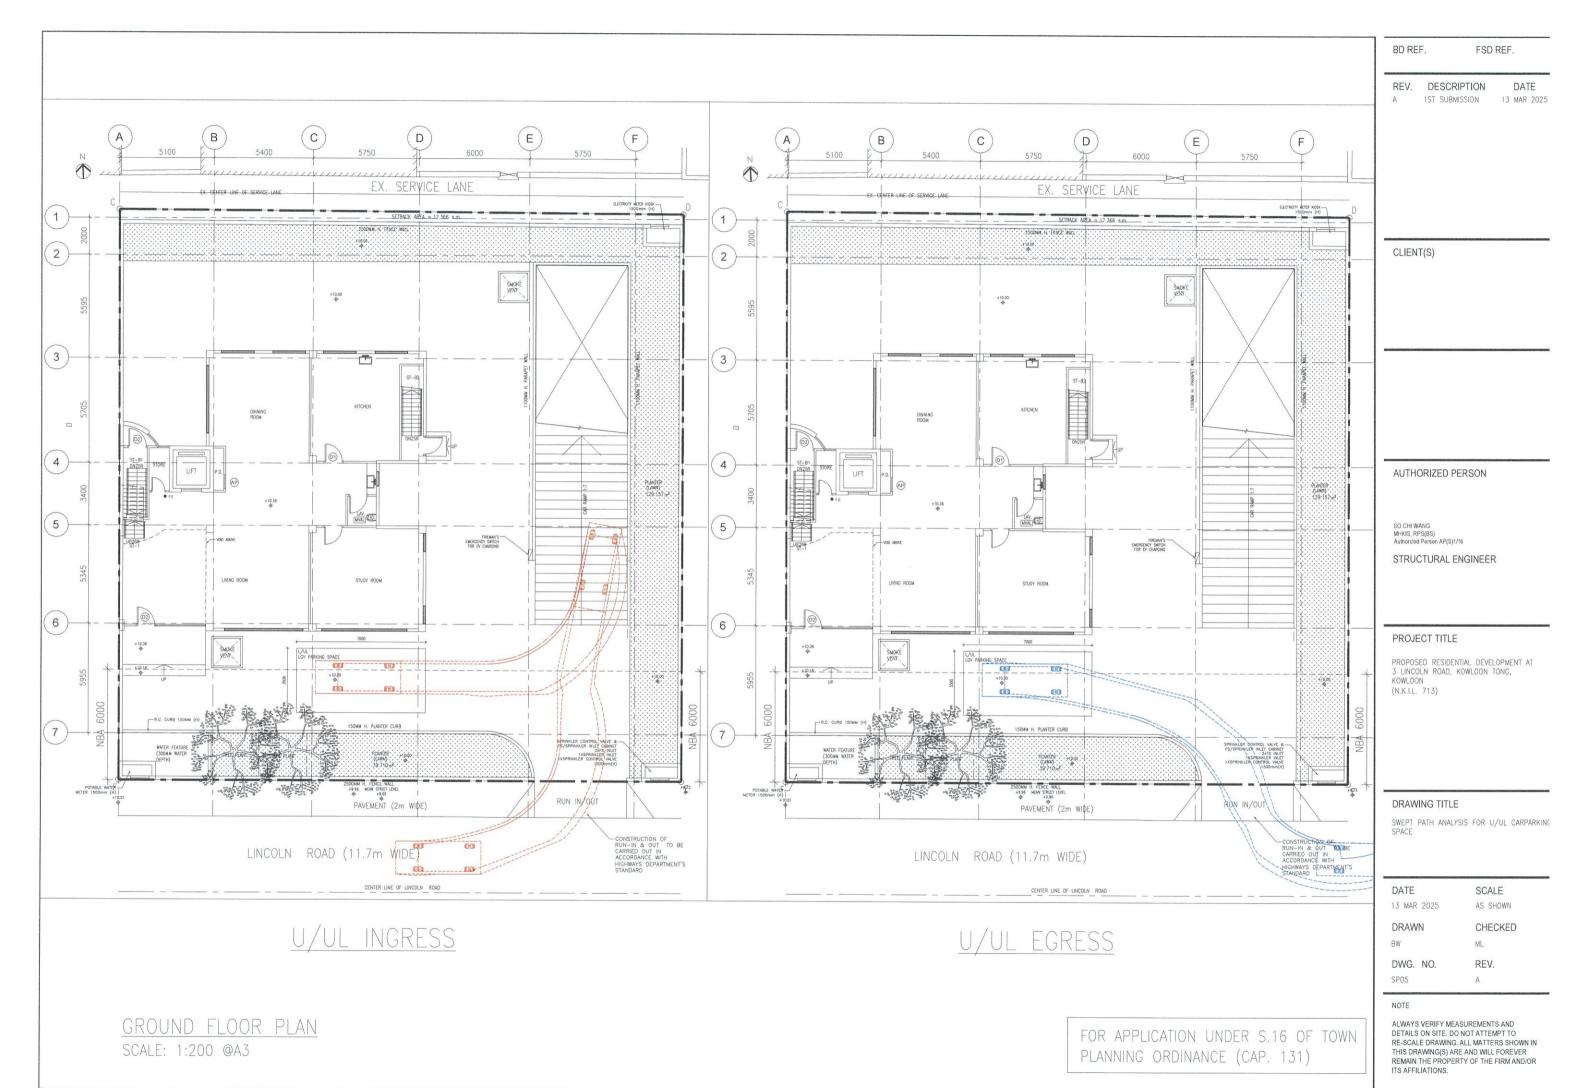
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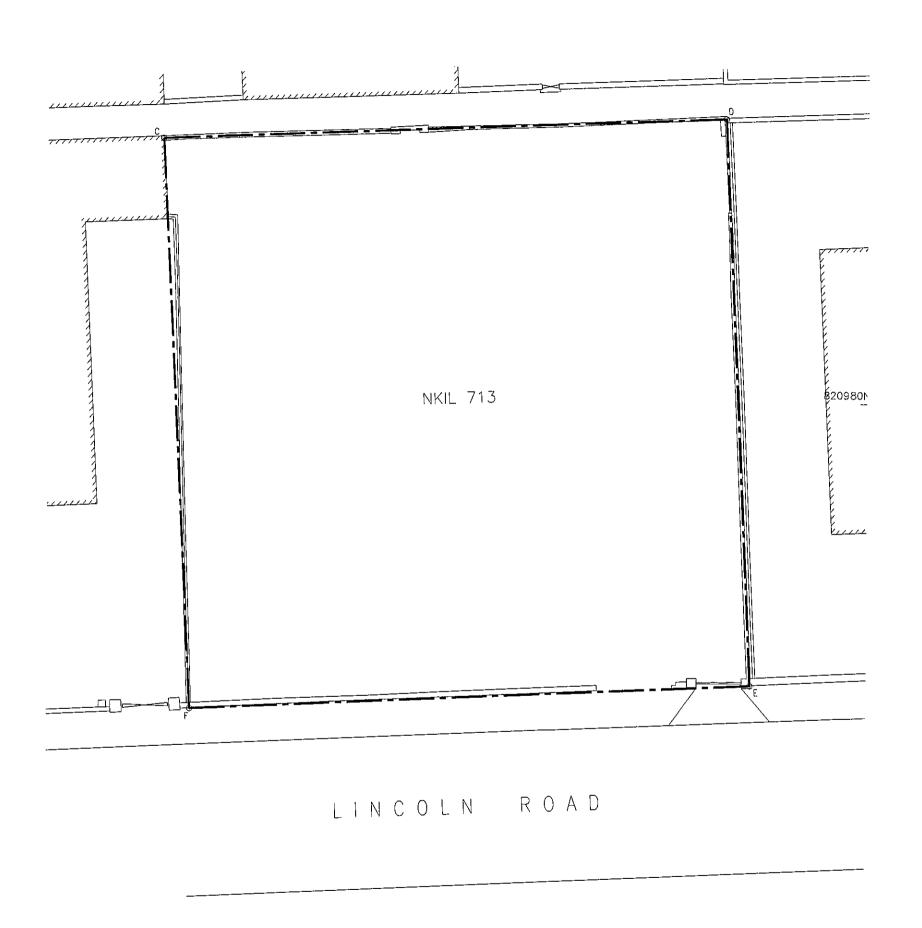






Appendix 2

Alternative Scheme (without Basement)

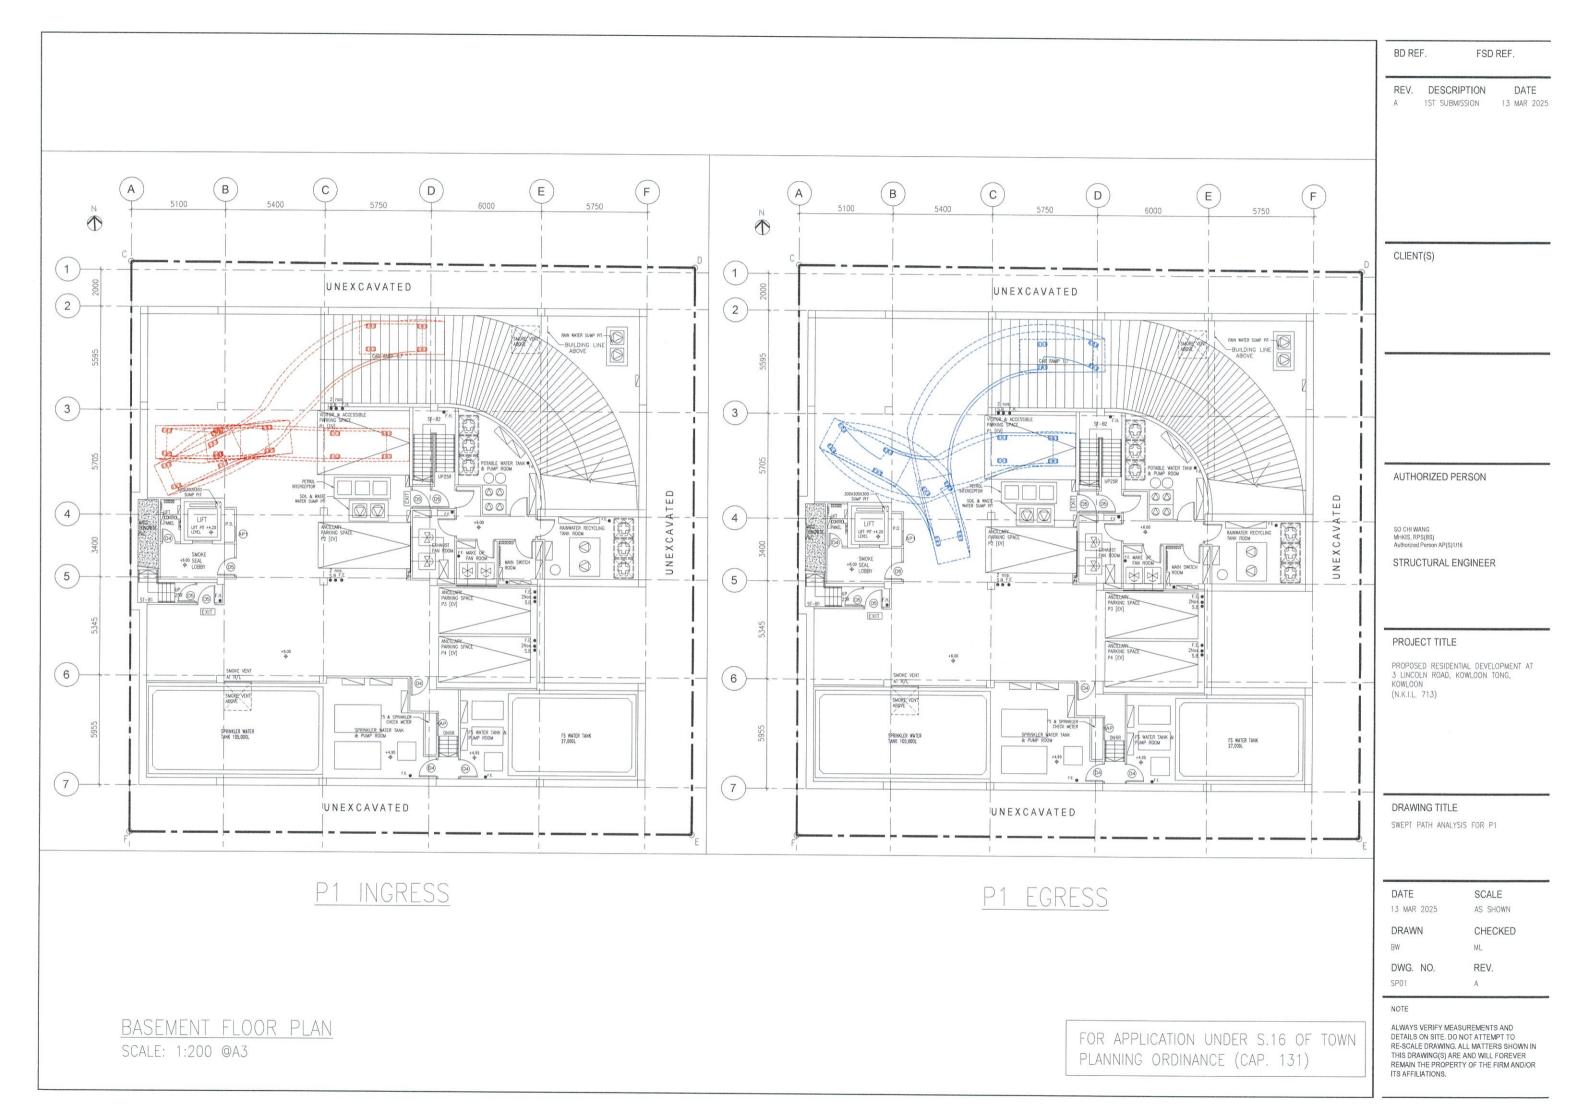

BD REF. FSD REF. REV. DESCRIPTION DATE 1ST SUBMISSION 13 MAR 2025

CLIENT(S)

AUTHORIZED PERSON

STRUCTURAL ENGINEER

PROJECT TITLE

PROPOSED RESIDENTIAL DEVELOPMENT AT 3 LINCOLN ROAD, KOWLOON TONG, KOWLOON (N.K.I.L. 713)

DRAWING TITLE BLOCK PLAN

DATE 13 MAR 2025

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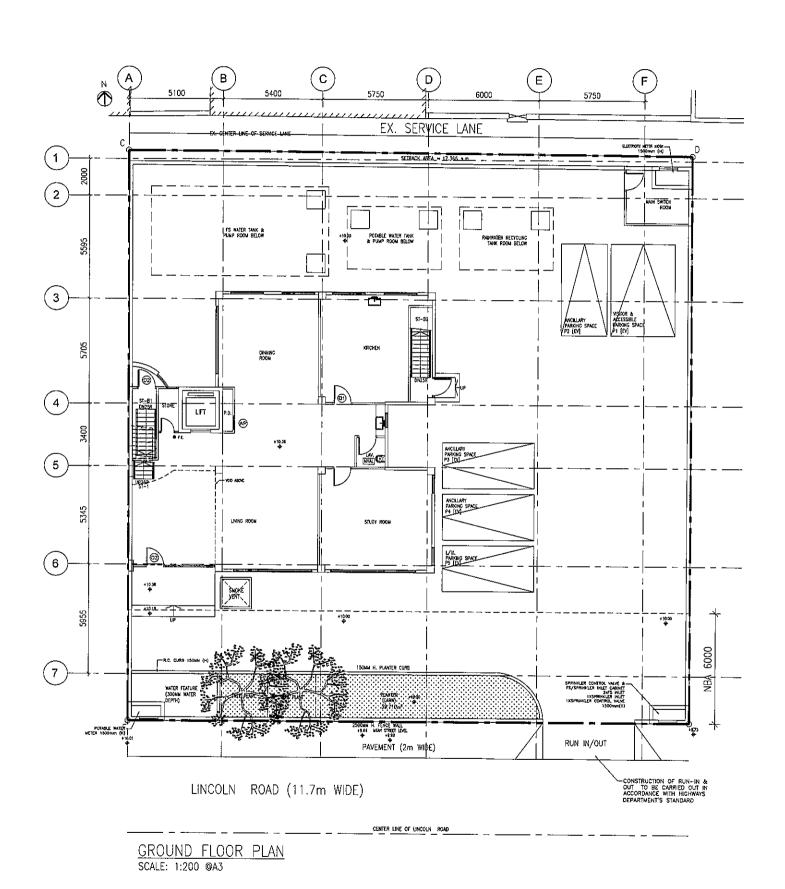
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FOR APPLICATION UNDER S.16 OF TOWN PLANNING ORDINANCE (CAP. 131)



BD REF. FSD REF.

> REV. DESCRIPTION DATE 1ST SUBMISSION 13 MAR 2025

CLIENT(S)

AUTHORIZED PERSON

STRUCTURAL ENGINEER

PROJECT TITLE

PROPOSED RESIDENTIAL DEVELOPMENT AT 3 LINCOLN ROAD, KOWLOON TONG, KOWLOON (N.K.I.L. 713)

DRAWING TITLE

GROUND FLOOR

DATE 13 MAR 2025 SCALE AS SHOWN

DRAWN

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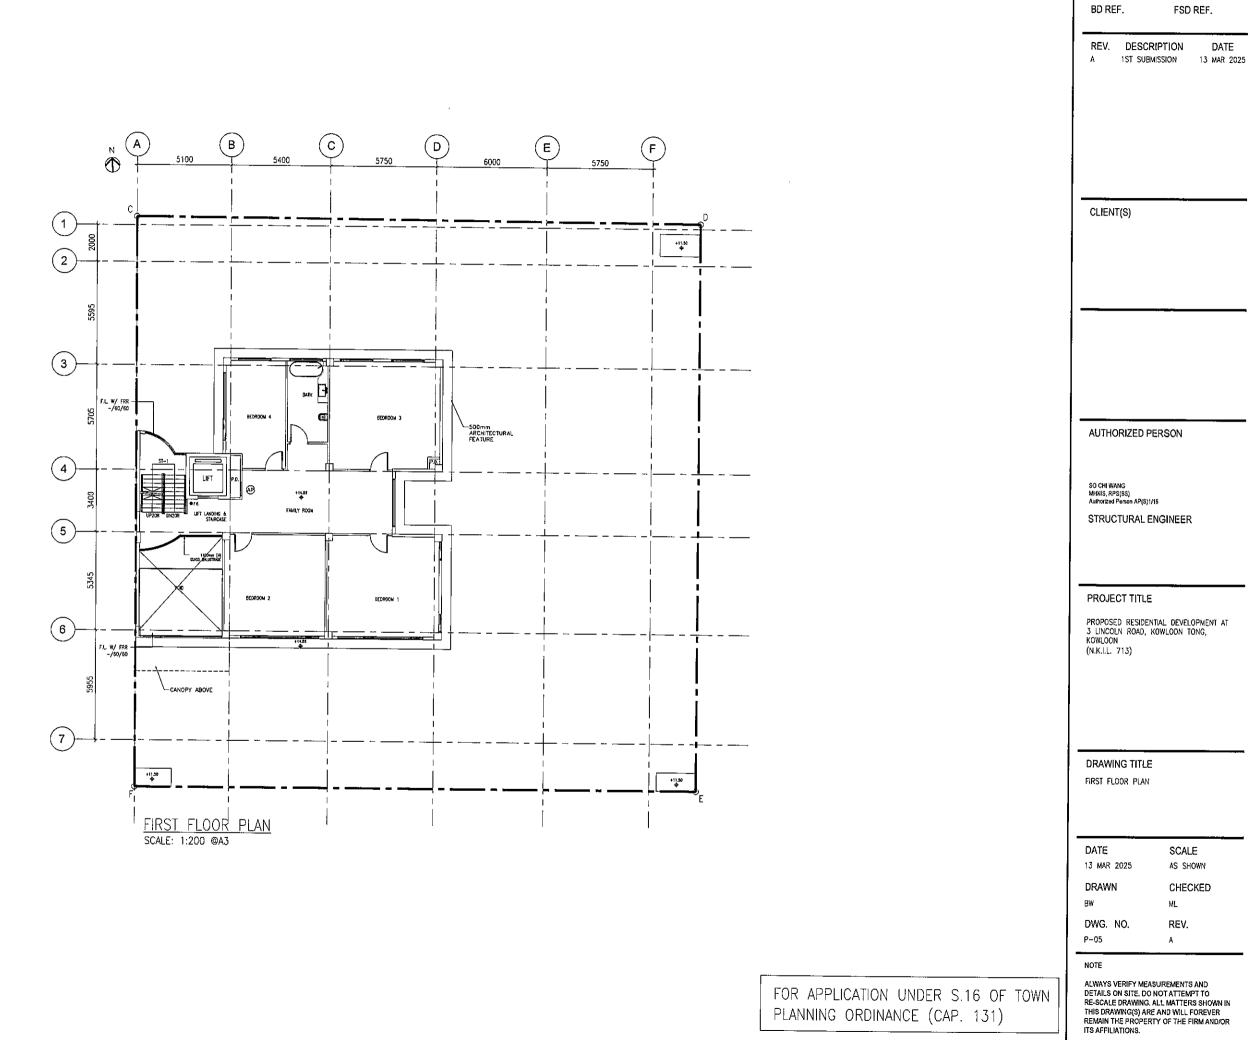
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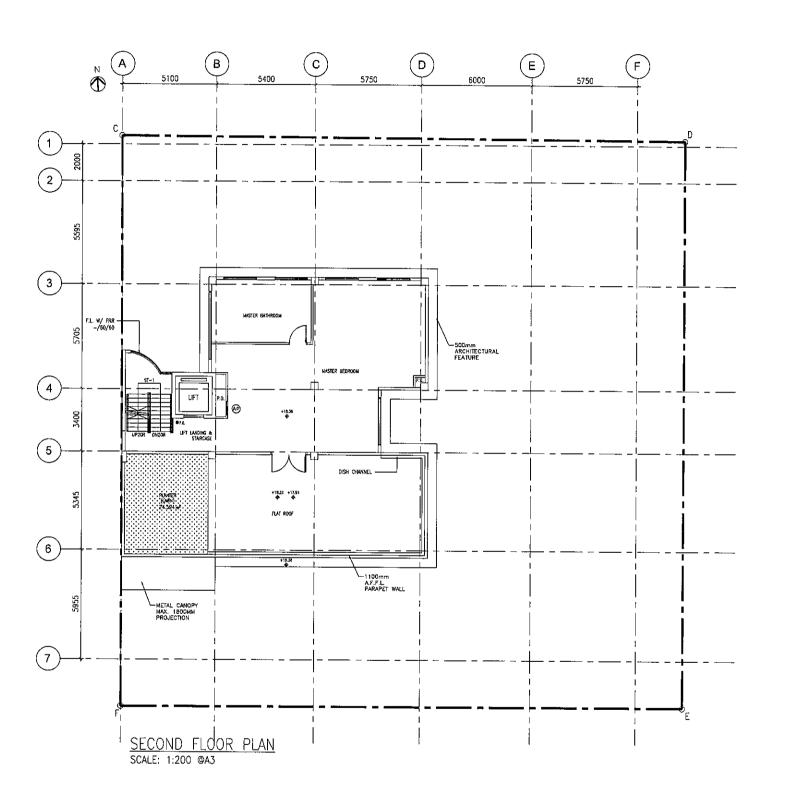
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FOR APPLICATION UNDER S.16 OF TOWN PLANNING ORDINANCE (CAP. 131)



PLANNING ORDINANCE (CAP. 131)



BD REF. F\$D REF.

REV. DESCRIPTION DATE

13 MAR 2025

1ST SUBMISSION

CLIENT(S)

AUTHORIZED PERSON

SO CHI WANG MHKIS, RPS(BS) Authorized Person AP(S)1/16

STRUCTURAL ENGINEER

PROJECT TITLE

PROPOSED RESIDENTIAL DEVELOPMENT AT 3 LINCOLN ROAD, KOWLOON TONG, KOWLOON (N.K.I.L. 713)

DRAWING TITLE
SECOND FLOOR PLAN

3030110 TESSIT TESS

 DATE
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 13 MAR 2025
 AS SHOWN

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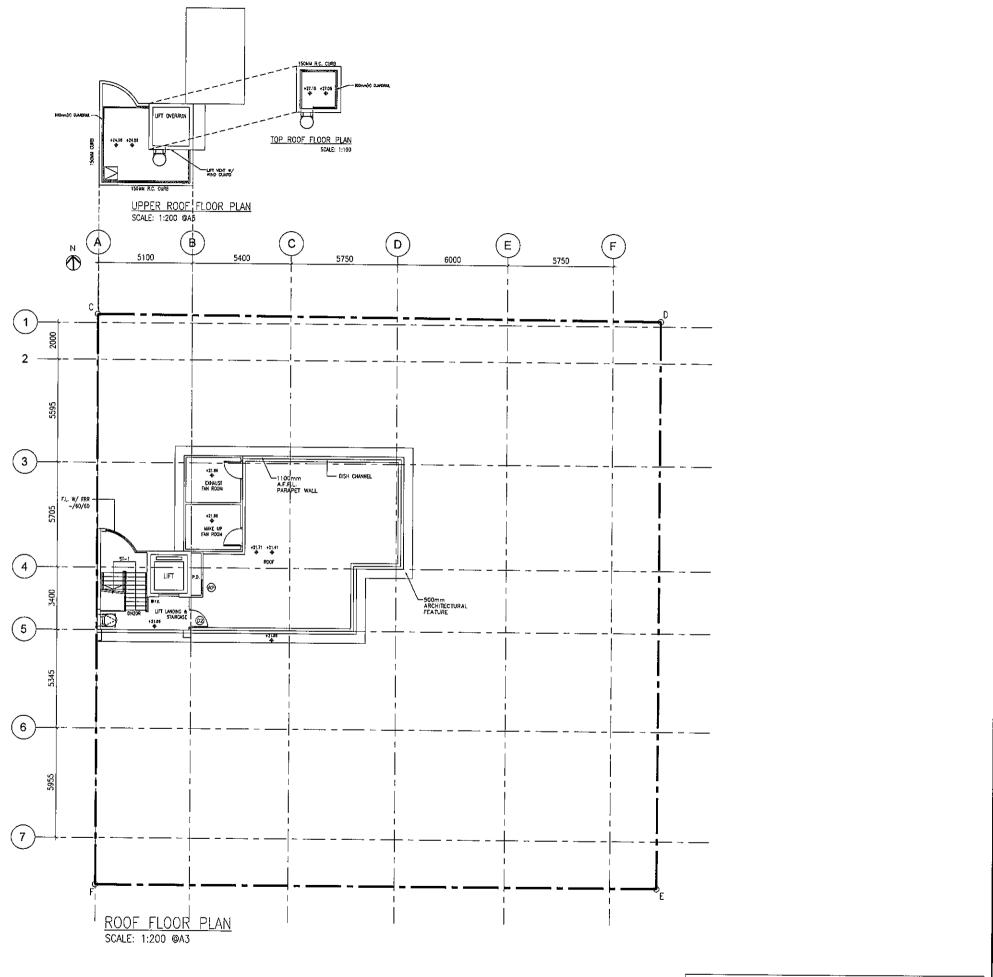
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FOR APPLICATION UNDER S.16 OF TOWN PLANNING ORDINANCE (CAP. 131)



FOR APPLICATION UNDER S.16 OF TOWN PLANNING ORDINANCE (CAP. 131)

BD REF.

REV. DESCRIPTION
A 1ST SUBMISSION

13 MAR 2025

FSD REF.

CLIENT(S)

AUTHORIZED PERSON

SO CHI WANG MHKIS, RPS(BS) Authorized Person AP(S)1/16

STRUCTURAL ENGINEER

PROJECT TITLE

PROPOSED RESIDENTIAL DEVELOPMENT AT 3 LINCOLN ROAD, KOWLOON TONG, KOWLOON (N.K.I.L. 713)

DRAWING TITLE

ROOF AND UPPER ROOF FLOOR PLAN

DATE SCALE
13 MAR 2025 AS SHOWN
DRAWN CHECKED

BW ML
DWG. NO. REV.

P-07 A

NC

ALWAYS VERIFY MEASUREMENTS AND DETAILS ON SITE. DO NOT ATTEMPT TO RE-SCALE DRAWING, ALL MATTERS SHOWN IN THIS DRAWING(S) ARE AND WILL FOREVER REMAIN THE PROPERTY OF THE FIRM AND/OR ITS AFFILIATIONS.

SITE COVERAGE AND PLOT RATIO CALCULATION = LOT AREA SITE AREA CLASS OF SITE

 $= 945.28 \text{ m}^2$ BUILDING HEIGHT = A

= ROOF LEVEL - GROUND FLOOR LEVEL

= 21.86 - 10 = 11.86m

PROPOSED PLOT RATIO = 540.35 / 945.28

= 0.572 GROUND FLOOR $= 205.212 \,\mathrm{m}^2$ FIRST FLOOR SECOND FLOOR = 205.901 m² = 129.238 m²

TOTAL GFA $= 540.35 \text{ m}^2$

PERMITTED SITE COVERAGE = 66.6% PROPOSED SITE COVERAGE = 229.090 / 945.28

= 24.24 % (PRO.) < 66.6% (PER.)

AREA OF GFA CONCESSION

TOTAL

B/F: 1. ESSENTIAL PLANT ROOM $= 81.468 \text{ m}^2$ = 6.765 m²= 9.186 m²F.S.I., ELECTRICITY METER KIOSK & POTABLE WATER METER ESSENTIAL PLANT ROOM 1/F: 1. VOID $= 16.424 \text{ m}^2$

= 1.625 m²= 24.398 m²= 16.656 m²DOG HOUSE
 STAIRCASE & LIFT SHAFT
 ESSENTIAL PLANT ROOM

 $= 156.522 \text{ m}^2$

TOTAL CONSTRUCTION AREA

TOTAL AREA $= 686.975 \text{ m}^2$


LANSCAPE AREA

GROUND FLOOR SECOND FLOOR = 39.710 m^2 = 24.594 m^2 TOTAL AREA = 64.304 m²

LANSCAPE RATIO

64.304 m² (PROVIDED) / 945.28 m²

= 6.803 %

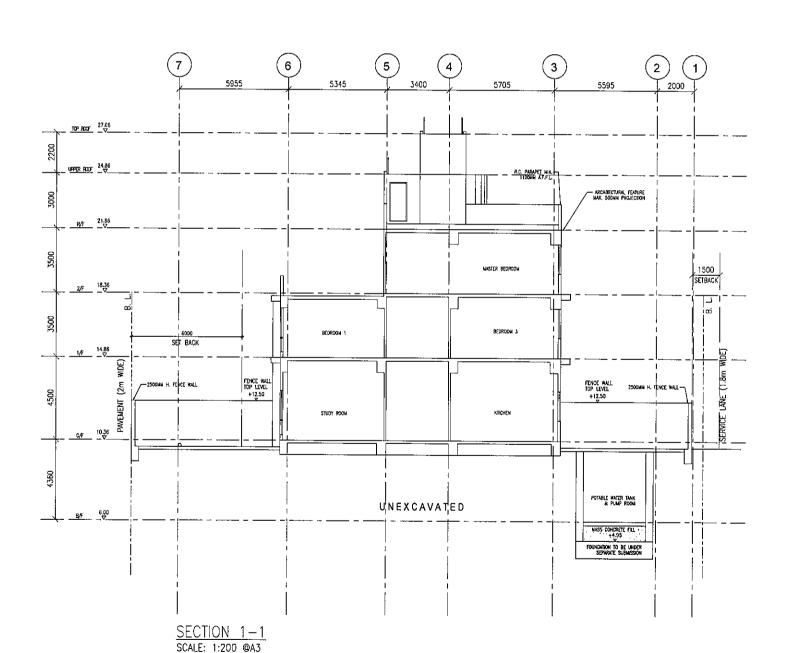

P-08 NOTE FOR APPLICATION UNDER S.16 OF TOWN

PLANNING ORDINANCE (CAP. 131)

BD REF. FSD REF. REV. DESCRIPTION DATE 1ST SUBMISSION 13 MAR 2025 CLIENT(S)

AUTHORIZED PERSON

SO CHI WANG MHKIS, RPS(BS) Authorized Person AP(S)1/16

STRUCTURAL ENGINEER

PROJECT TITLE

PROPOSED RESIDENTIAL DEVELOPMENT AT 3 LINCOLN ROAD, KOWLOON TONG, KOWLOON (N.K.I.L. 713)

DRAWING TITLE


SECTION AND CALCULATION


DATE SCALE 13 MAR 2025 AS SHOWN


DRAWN CHECKED ML

REV. DWG. NO.

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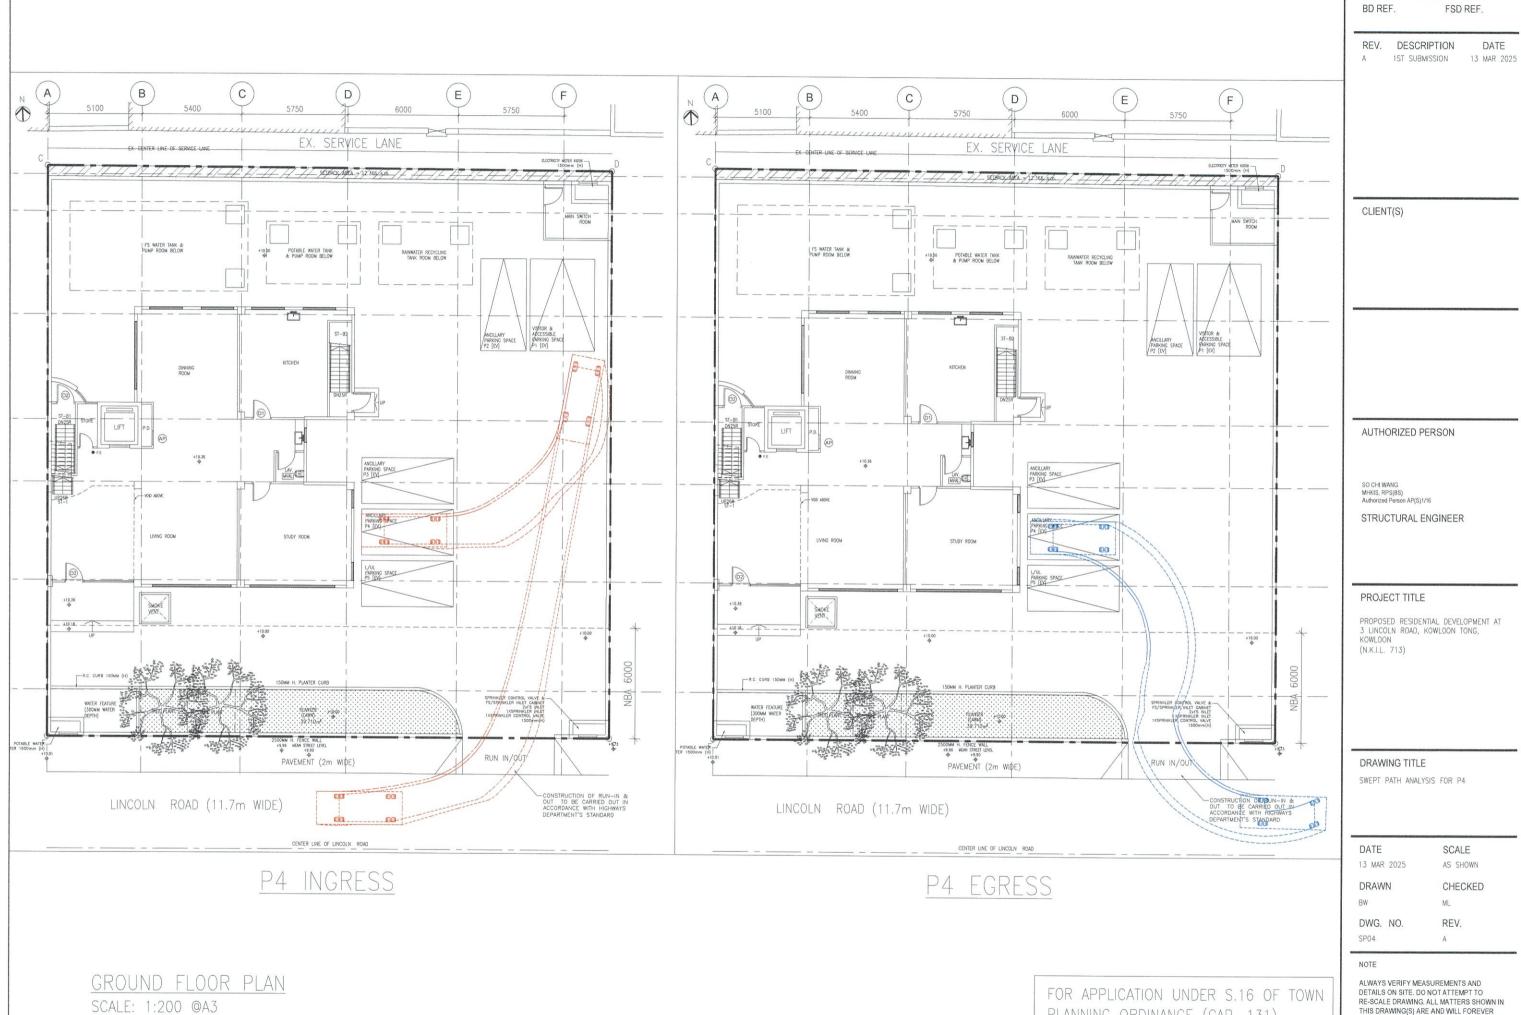


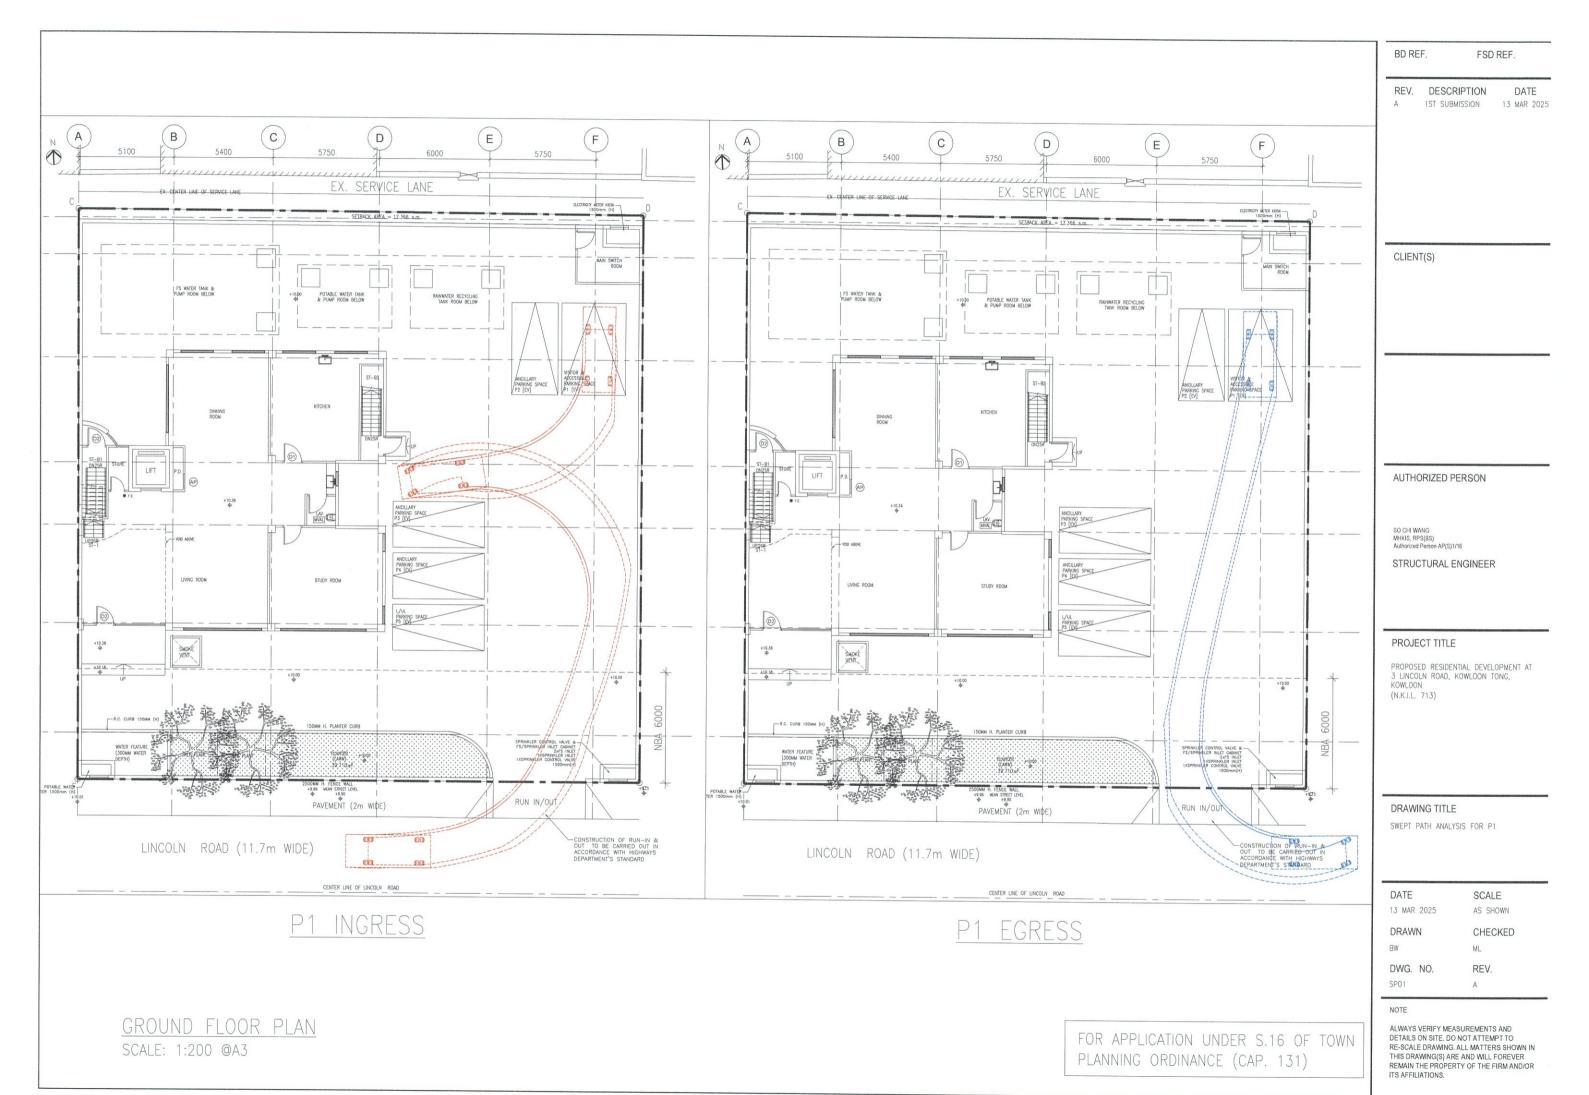

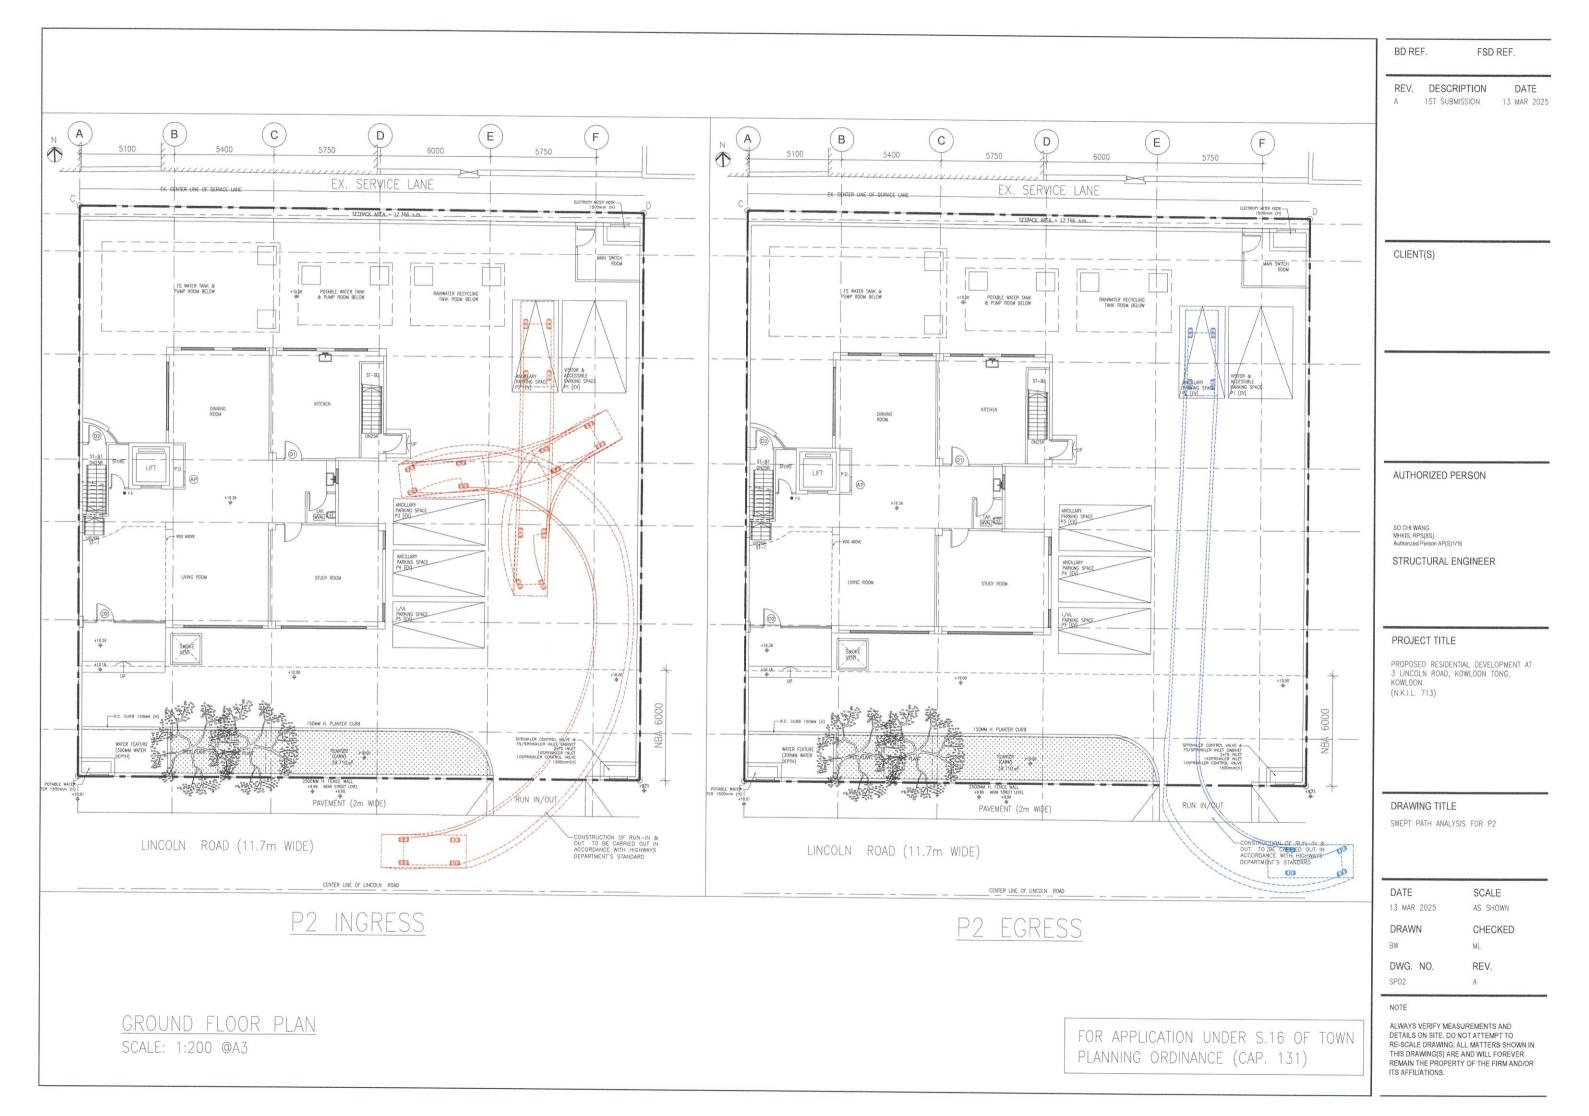

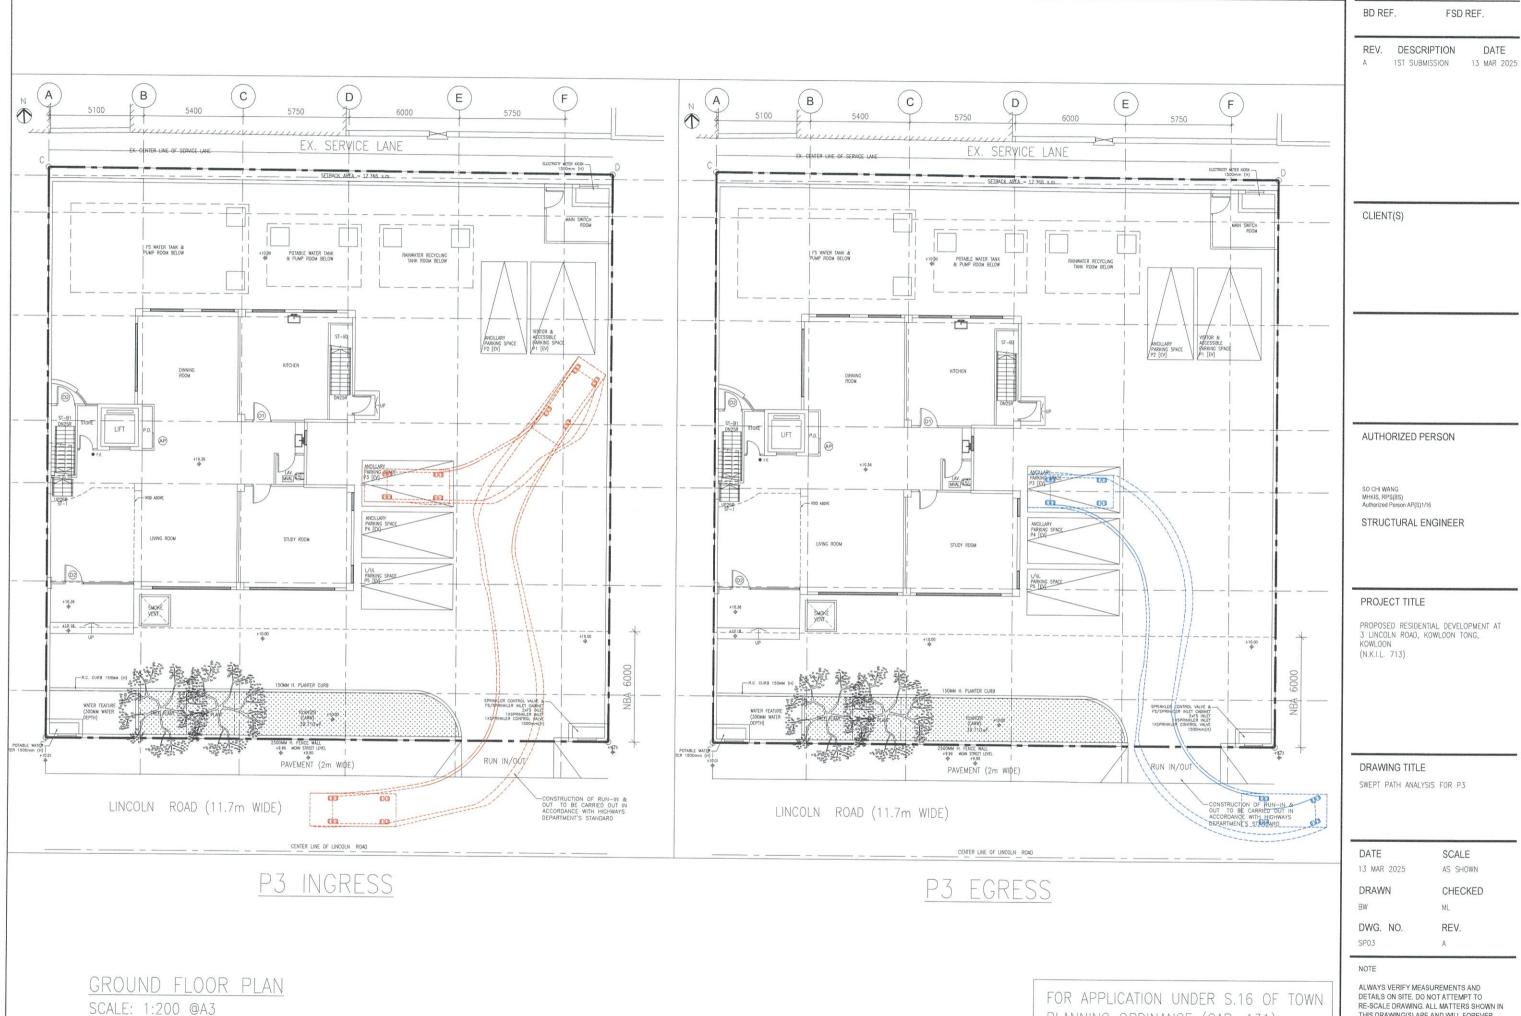
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PLANNING ORDINANCE (CAP. 131)



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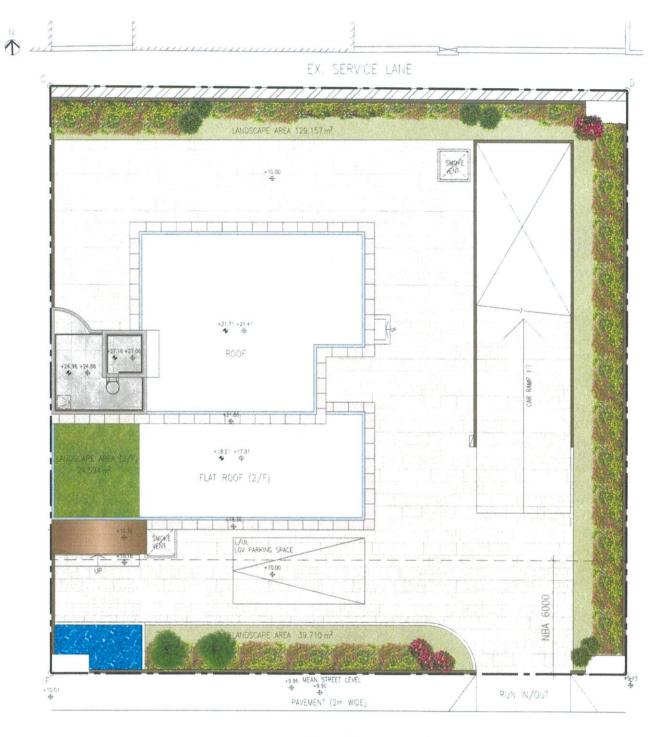
PLANNING ORDINANCE (CAP. 131)



Appendix 3

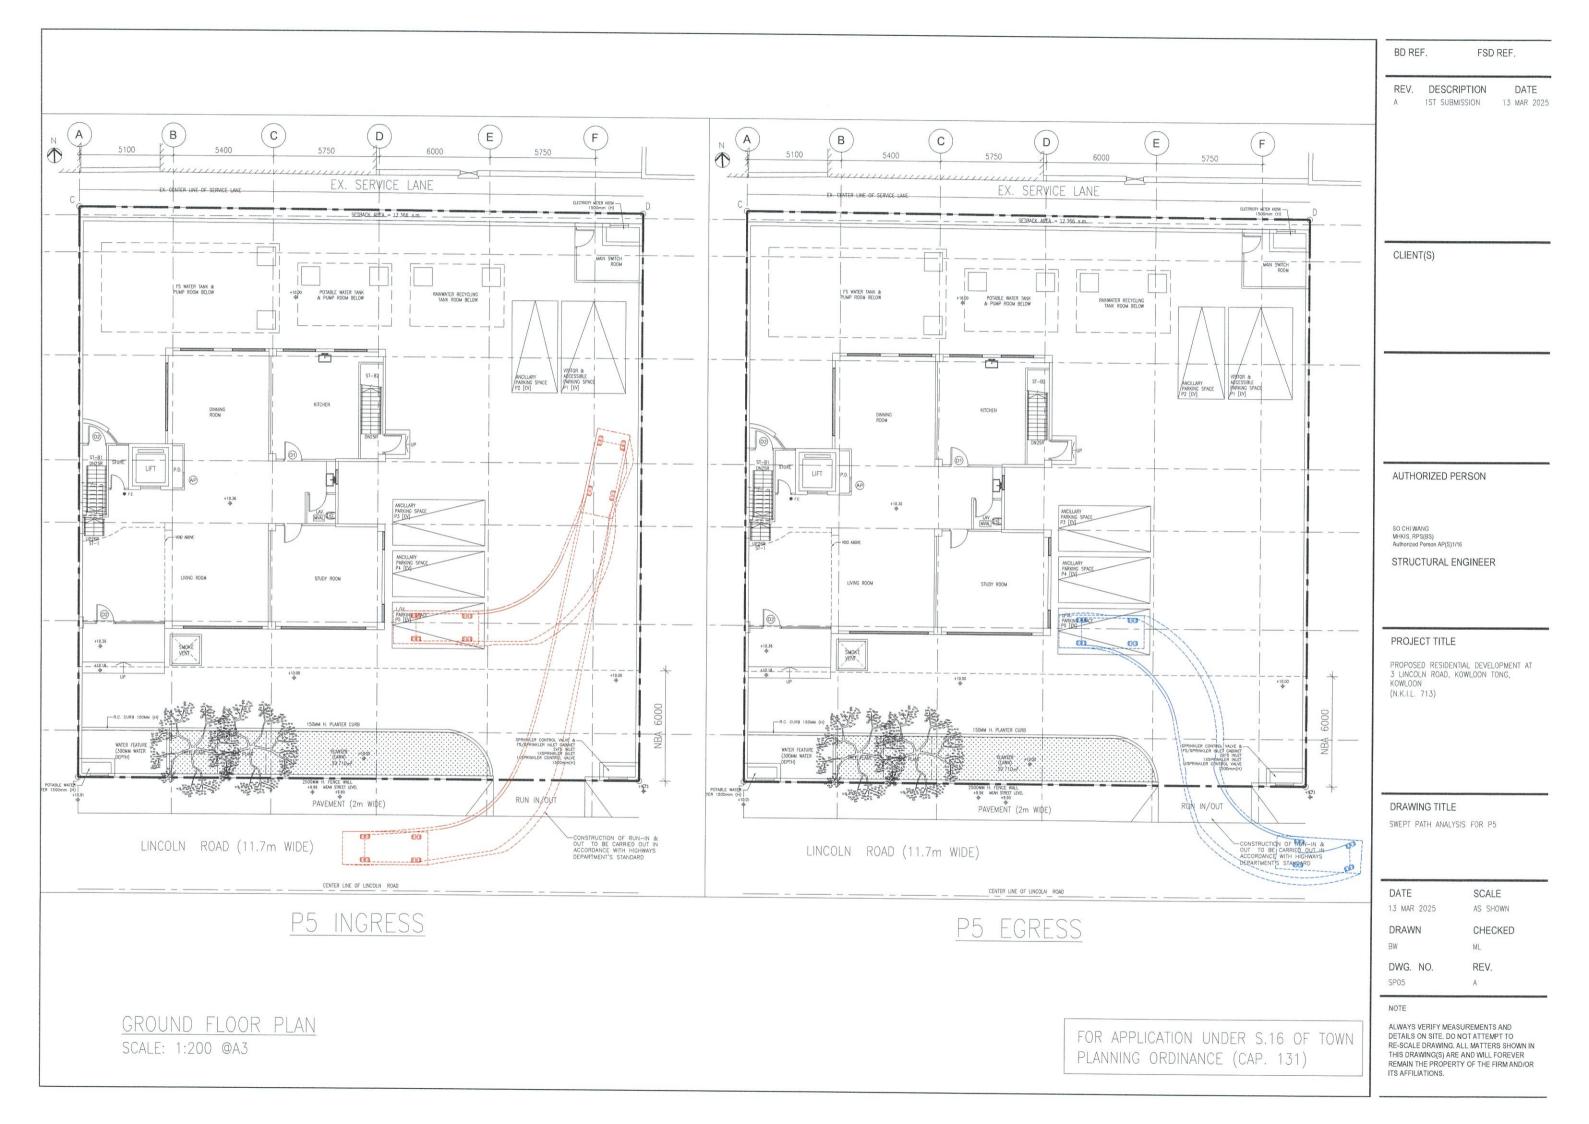Landscape Proposal

3 Lincoln Road, Kowloon Tong (N.K.I.L. 713)



LINCOLN ROAD (11.7m WIDE)

Master Landscape Plan

Planting Schedule

Trees						
Botanical Name	Chinese Name	DBH (mm)	Height(m)	Spread(m)	Live Crown Ratio	Spacing (mm)
Terminalia mantaly	小葉欖仁	90mm	4.5	4	40%	4000

Schrubs & Ground Covers							
Botanical Name	Chinese Name	Height(mm) x Spread(mm)	Spacing (mm)				
Bougainvillea sp 'mary palmer'	雙色(鴛鴦)三角梅	600 × 600	500				
Duranta Repens 'variegata'	花葉假連翹	300 x 300	250				
Rhododendron simsii	杜鵑	300 × 300	200				
Lxora coccinea	黃花龍船花	250 x 250	200				
Hibiscus rosa-sinensis	朱槿	500 × 500	400				
Duranta erecta	金連翹	300 × 300	250				
Ficus microcarpa 'Golden Leaves'	黄金榕	500 × 500	400				

Legend



Feature Tree



Terminalia mantaly 小葉欖仁

Planting Photos

Schrubs & Ground Covers



Duranta erecta 金連翹



Ficus microcarpa 'Golden Leaves' 黄金榕



Duranta Repens 'variegata' 花葉假連翹



Bougainvillea sp 'mary palmer' 雙色(鴛鴦)三角梅



Rhododendron simsii 杜鵑




Lxora coccinea 黃花龍船花



Hibiscus rosa-sinensis 朱槿

Appendix 4


Indication Plan A

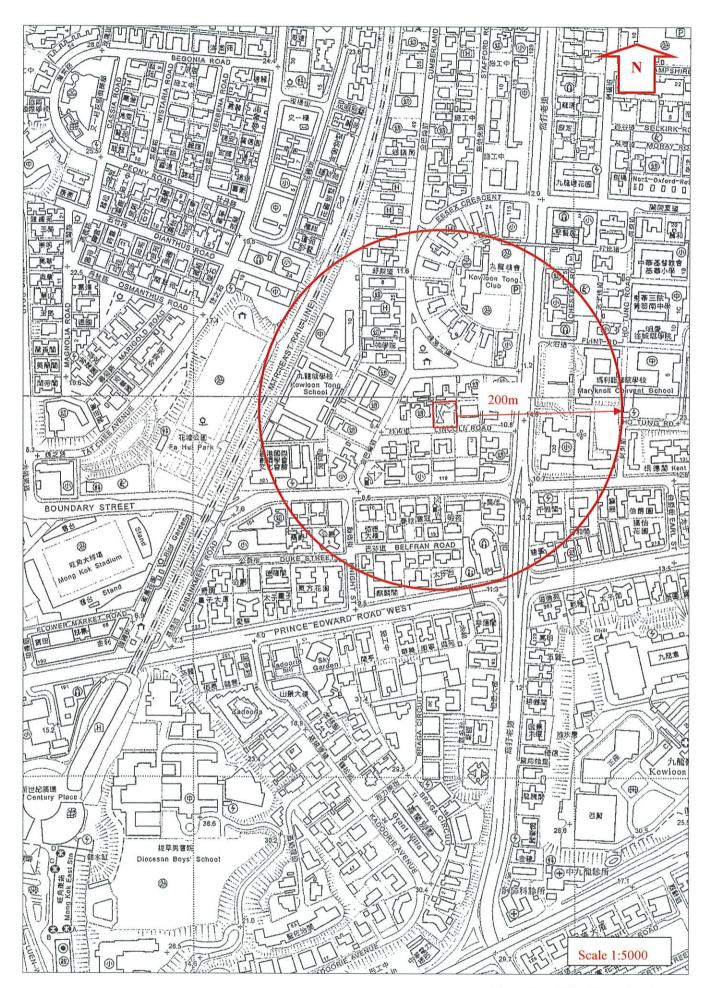

For Identification Only

Appendix 5

Indication Plan B

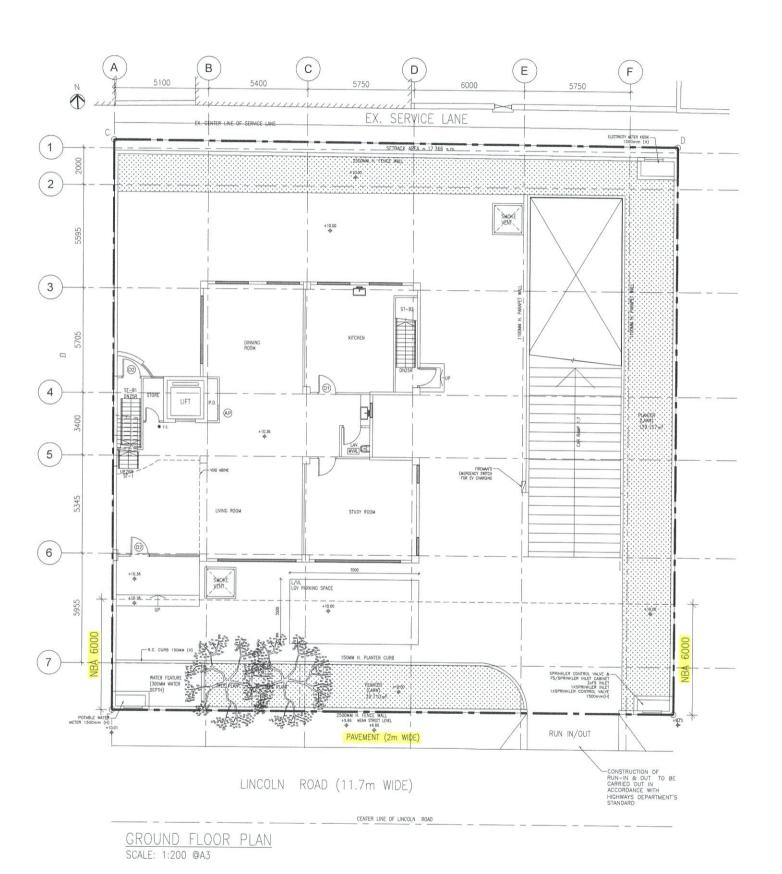

BD REF. FSD REF.

REV. DESCRIPTION DATE
A 1ST SUBMISSION 13 MAR 2025

CLIENT(S)

AUTHORIZED PERSON

SO CHI WANG MHKIS, RPS(BS) Authorized Person AP(S)1/16

STRUCTURAL ENGINEER

PROJECT TITLE

PROPOSED RESIDENTIAL DEVELOPMENT AT 3 LINCOLN ROAD, KOWLOON TONG, KOWLOON (N.K.I.L. 713)

DRAWING TITLE

GROUND FLOOR

DATE SCALE

13 MAR 2025 AS SHOWN

DRAWN CHECKED

BW ML

DWG. NO. REV.

P-04 A

NOT

FOR APPLICATION UNDER S.16 OF TOWN PLANNING ORDINANCE (CAP. 131)

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