Appendix I

規劃署

粉嶺、上水及元朗東規劃處



Planning Department

Farding, Sheung Shui & Yuen Long East District Planning Office

來函檔號 Your Reference: DD107 Lot 1058 RP & VL

本署檔號 Our Reference: TPB/A/YL-KTN/806

密話號碼 Tel. No.: 傳真機號碼 Fax No.:

R-riches Property Consultants Limited

(Attn.: Mr. Louis TSE / Christian CHIM)

4 November 2024

Dear Sir/Madam.

Submission for Compliance with Approval Condition (a)

— the Submission of a Drainage Proposal

Proposed Temporary Place of Recreation, Sports or Culture (Hobby Farm) for a Period of 5 Years and Filling of Land in "Agriculture" Zone, Lots 1058 RP, 1059 RP, 1060 and 1061 in D.D. 107, Fung Kat Heung, Kam Tin, Yuen Long

(Planning Application No. A/YL-KTN/806)

I refer to your submission dated 3.10.2024 for compliance with the captioned approval condition. The relevant department has been consulted on your submission. Your submission is considered:

- Acceptable. The captioned condition <u>has been complied with</u>. Please find detailed departmental comments in *Appendix*.
- Acceptable. Since the captioned condition requires both the submission and implementation of the proposal, it <u>has not been fully complied with</u>. Please proceed to implement the accepted proposal for full compliance with the approval condition.
- Not acceptable. The captioned condition <u>has not been complied with</u>. Please find detailed departmental comment in *Appendix*.

Should you have any queries, please contact Mr. Terence TANG (Tel: of the Drainage Services Department directly.

Yours faithfully,

(Josephine Lo) for District Planning Officer/

Fanling Sheung Shui & Yuen Long East Planning Department

透過規劃工作,使香港成為一個宜居、具競爭力和可持續發展的**亞洲國際都會**We plan to make Hong Kong a Liveable • Competitive • Sustainable ASIA'S WORLD CITY

- 2

c.c. CE/MN, DSD

(Attn.: Mr. Terence TANG)

Internal CTP/TPB

AM/AY/jc

<u> Appendix</u>

Comments from the Chief Engineer/Mainland North, Drainage Services Department:

1. Please be noted that the proposed drainage works, whether within or outside the lot boundary, should be constructed and maintained by the applicant/ lot owner at their own expense during the planning application period.



Our Ref.: DD107 Lot 1058 RP & VL Your Ref.: TPB/A/YL-KTN/806

The Secretary,
Town Planning Board,
15/F, North Point Government Offices,
333 Java Road,
North Point, Hong Kong

By Email

2 October 2024

Dear Sir,

Compliance with Approval Condition (a)

Proposed Temporary Place of Recreation, Sports or Culture (Hobby Farm) for a Period of 5 Years and Filling of Land in "Agriculture" Zone, Lots 1058 RP, 1059 RP, 1060 and 1061 in D.D. 107, Fung Kat Heung, Kam Tin, Yuen Long, New Territories

(S.16 Planning Application No. A/YL-KTN/806)

We are writing to submit a response-to-comments table and a revised drainage proposal for compliance with approval condition (a) of the subject application, i.e. *the submission of a drainage proposal* (**Appendices I** and **II**).

Should you require more information regarding the application, please contact the undersigned at your convenience. Thank you for your kind attention.

Yours faithfully,

For and on behalf of

R-riches Property Consultants Limited

Danny NG

Assistant Town Planner








<u>Appendix I – Response to Comments of the Chief Engineer/Mainland North, Drainage Services</u> <u>Department (CE/MN, DSD)</u>

Comments of the CE/MN, DSD		
(Con	ntact Person Mr. Terrence TANG; Tel:)
(i)	SDM corrigendum nos. 1/2022 and 1/2024	Noted. SDM corrigendum nos. 1/2022 and
	should be considered in the assessment.	1/2024 are followed, and the drain size is also
	Please consider to upgrade the drain size.	upgraded accordingly (Appendix II).
(ii)	According to the SDM, the impact of a	Noted. A 50-year return period is also
	50-year event should also be assessed.	adopted in the proposal (Appendix II).
(iii)	Sediment reduction should be considered	Noted. Sedimentation is also considered in
	in the assessment.	the proposal (Appendix II).



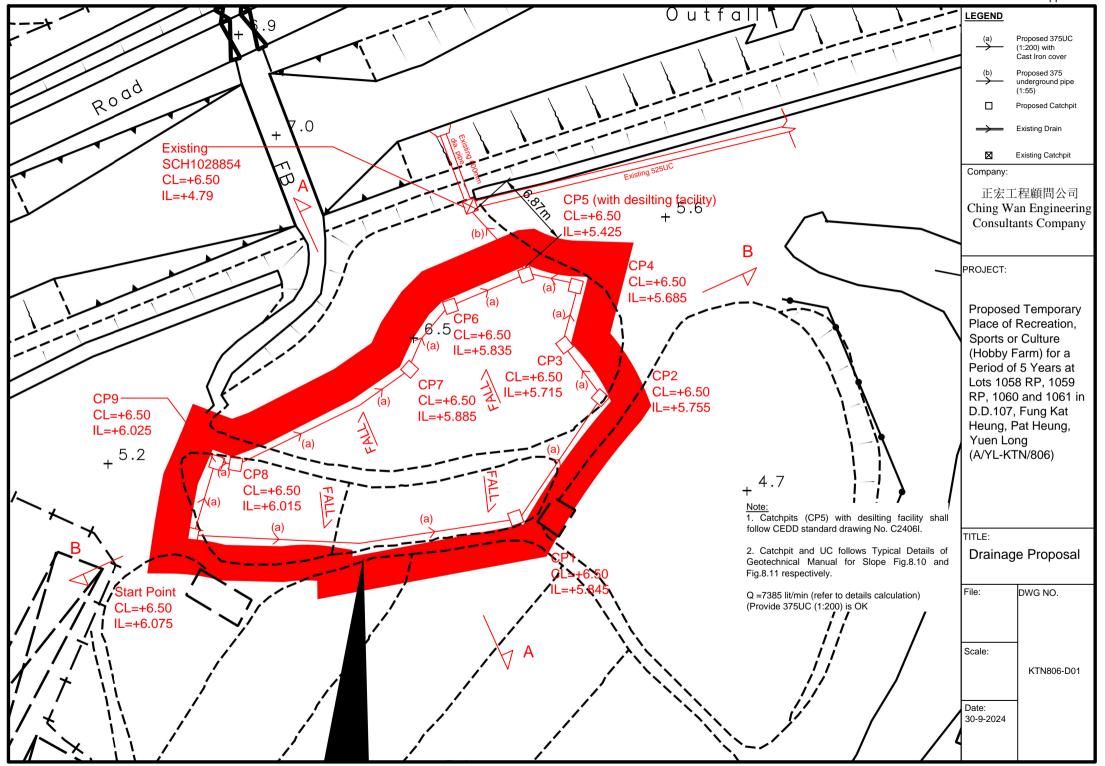

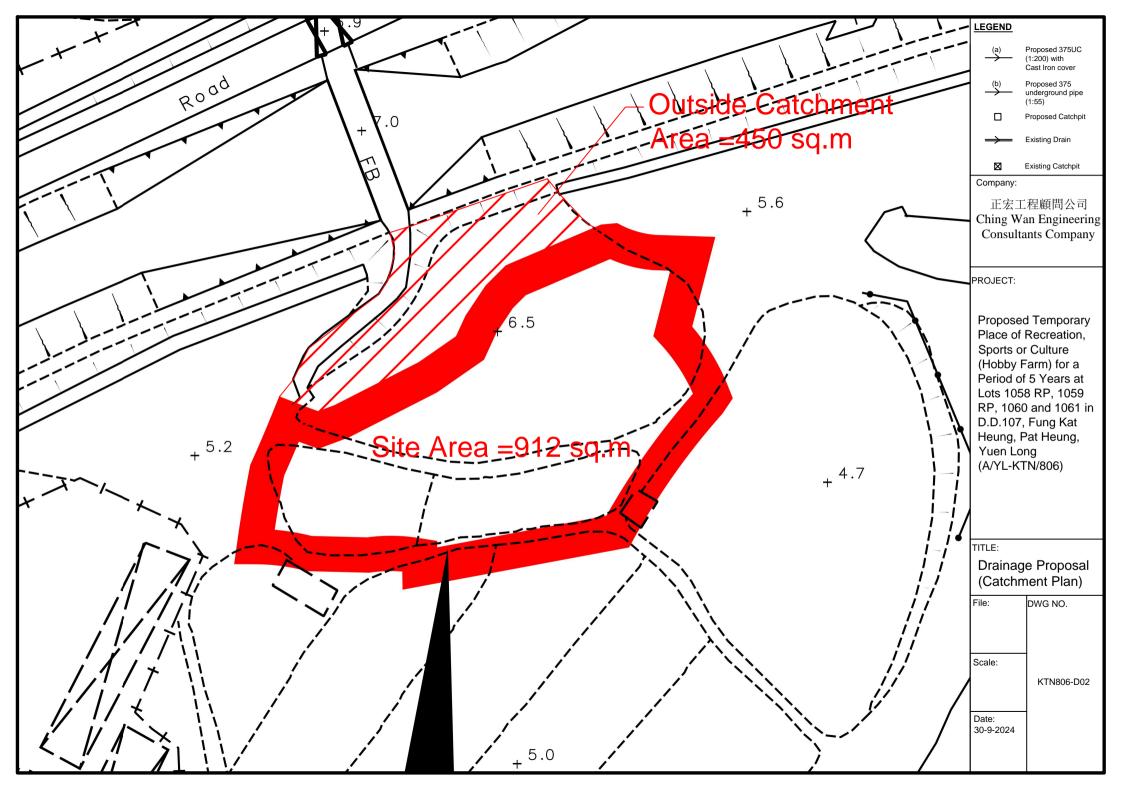

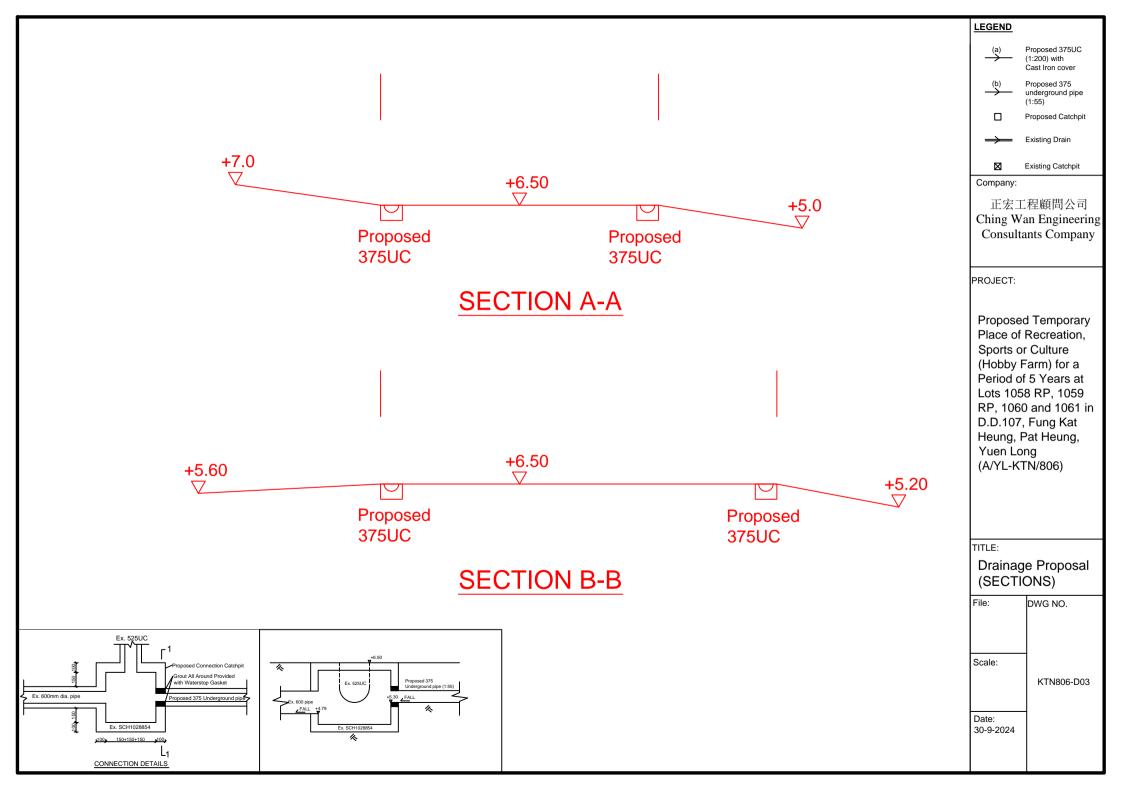

Calculation of Runoff from the Proposed Development, $= 0.278 \,\mathrm{CiA}$ The site will be hard praved = 0.95 m^2 = 1362 km^2 = 0.001362 $= 0.14465 \text{ L/ H}^{0.2} \text{A}^{0.1}$ $= 0.14465*10/1^{0.2}*1362^{0.1}$ = 0.703min i (Values of a, b and c are from Table 3d of $= a/(t+b)^c$ Corrigendum 2024, SDM with 50yrs return period) $= 474.6/(0.703+2.90)^{0.371}$ = 295 mm/hr Therefore, = 0.278*0.95*295*0.001362*1.16 (16% for rainfall increase due to climate change) = 0.1231m³/sec lit/min = 7385

Check 375mm dia. Pipes by Colebrook-White Equation

Gradient of Proposed 375mm dia. pipe: (5.425-5.3)/6.87, i.e. 1:55

$$V = -\sqrt{(8gDs)} \log(\frac{ks}{3.7D} + \frac{2.51v}{D\sqrt{(2gDs)}})$$

where: V g D ks v s	= = = = =	9.81 0.375 0.0006 1.14E-06 0.018182		mean velocity (m/s) gravitational acceleration (m/s2) internal pipe diameter (m) hydraulic pipeline roughness (m) kinematic viscosity of fluid (m2/s) hydraulic gradient	(Table 14 from SDM 2018, concrete pipe)
Therefore, design V of pipe capacity	=	2.4459	m/s	< 3 m/s	
Capacity of pipe	=	VA	=	3.14*0.175*0.175*2.6646	
Apply 0.9 factor for sedimentation	= =	0.173 9336	m3/s lit/min	> 7385 lit/min	OK



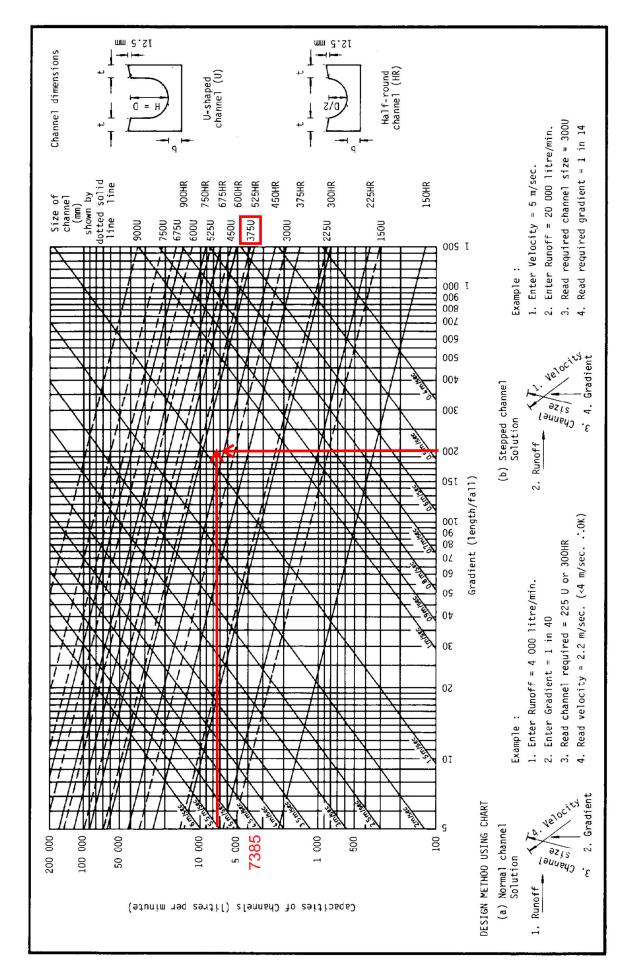


Figure 8.7 - Chart for the Rapid Design of Channels

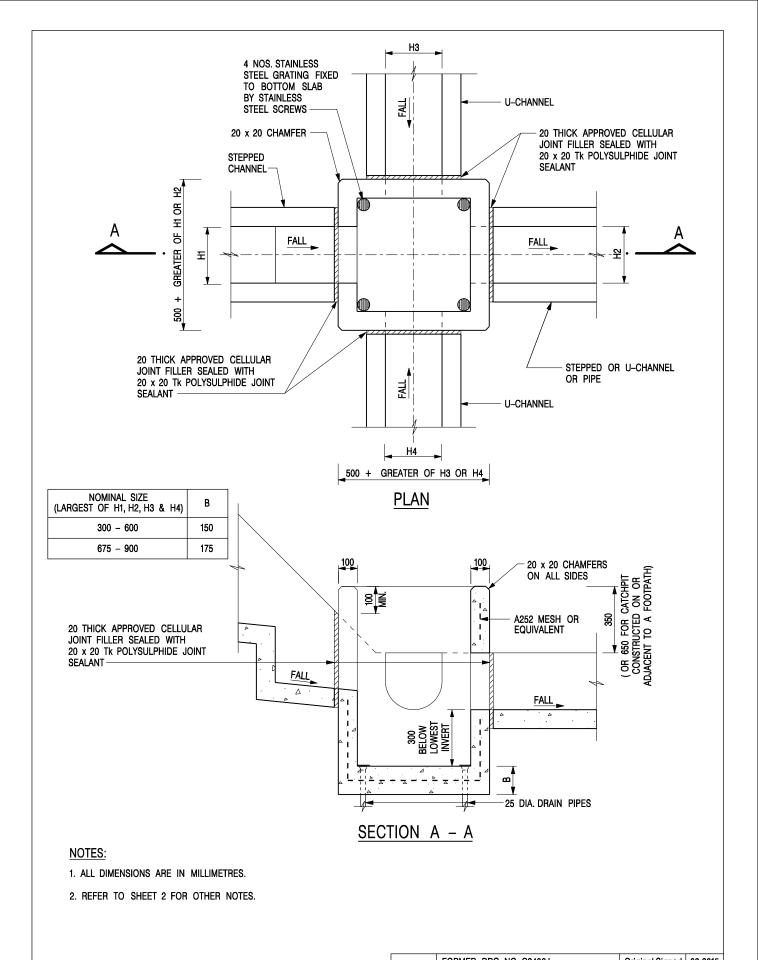

	-	FORMER DRG. NO. C2406J.		Original Signed	03.2015
	REF.	REVISION		SIGNATURE	DATE
CATCHPIT WITH TRAP		CIVIL ENGINEERING AND DEVELOPMENT DEPARTMENT			
(CHEET 1 OF 0)	SCAL	. E 1 : 20	DRAWI		
(SHEET 1 OF 2)	DATE	JAN 1991	C24	406 /1	
卓越工程 建設香港	V	Ve Engineer Hong I	Cong's De	velopment	

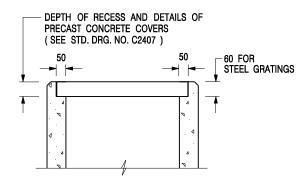

ALTERNATIVE TOP SECTION FOR PRECAST CONCRETE COVERS / GRATINGS

NOTES:

- 1. ALL DIMENSIONS ARE IN MILLIMETRES.
- 2. ALL CONCRETE SHALL BE GRADE 20 /20.
- 3. CONCRETE SURFACE FINISH SHALL BE CLASS U2 OR F2 AS APPROPRIATE.
- 4. FOR DETAILS OF JOINT, REFER TO STD. DRG. NO. C2413.
- 5. CONCRETE TO BE COLOURED AS SPECIFIED.
- UNLESS REQUESTED BY THE MAINTENANCE PARTY AND AS DIRECTED BY THE ENGINEER, CATCHPIT WITH TRAP IS NORMALLY NOT PREFERRED DUE TO PONDING PROBLEM.
- 7. UPON THE REQUEST FROM MAINTENANCE PARTY, DRAIN PIPES AT CATCHPIT BASE CAN BE USED BUT THIS IS FOR CATCHPITS LOCATED AT SLOPE TOE ONLY AND AS DIRECTED BY THE ENGINEER.
- FOR CATCHPITS CONSTRUCTED ON OR ADJACENT TO A FOOTPATH, STEEL GRATINGS (SEE DETAIL 'A' ON STD. DRG. NO. C2405) OR CONCRETE COVERS (SEE STD. DRG. NO. C2407) SHALL BE PROVIDED AS DIRECTED BY THE ENGINEER.
- 9. IF INSTRUCTED BY THE ENGINEER, HANDRAILING (SEE DETAIL 'G' ON STD. DRG. NO. C2405; EXCEPT ON THE UPSLOPE SIDE) IN LIEU OF STEEL GRATINGS OR CONCRETE COVERS CAN BE ACCEPTED AS AN ALTERNATIVE SAFETY MEASURE FOR CATCHPITS NOT ON A FOOTPATH NOR ADJACENT TO IT. TOP OF THE HANDRAILING SHALL BE 1 000 mm MIN. MEASURED FROM THE ADJACENT GROUND LEVEL.
- 10. MINIMUM INTERNAL CATCHPIT WIDTH SHALL BE 1 000 mm FOR CATCHPITS WITH A HEIGHT EXCEEDING 1 000 mm MEASURED FROM THE INVERT LEVEL TO THE ADJACENT GROUND LEVEL. AND, STEP IRONS (SEE DSD STD. DRG. NO. DS1043) AT 300 ℃ STAGGERED SHALL BE PROVIDED. THICKNESS OF CATCHPIT WALL FOR INSTALLATION OF STEP IRONS SHALL BE INCREASED TO 150 mm.
- FOR RETROFITTING AN EXISTING CATCHPIT WITH STEEL GRATING, SEE DETAIL 'F' ON STD. DRG. NO. C2405.
- SUBJECT TO THE APPROVAL OF THE ENGINEER, OTHER MATERIALS CAN ALSO BE USED AS COVERS / GRATINGS.

- FORMER DRG. NO. C2406J. Original Signed 03.2015
REF. REVISION SIGNATURE DATE

CIVIL ENGINEERING AND
DEVELOPMENT DEPARTMENT

CATCHPIT WITH TRAP (SHEET 2 OF 2)

 SCALE 1:20
 DRAWING NO.

 DATE JAN 1991
 C2406 /2

卓越工程 建設香港 We Engineer Hong Kong's Development

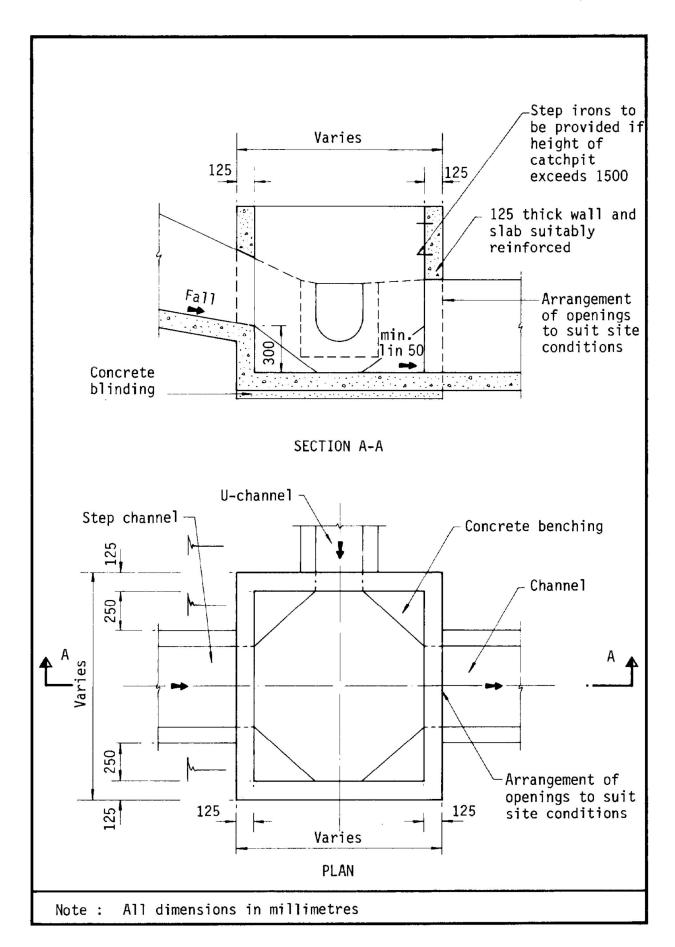


Figure 8.10 - Typical Details of Catchpits

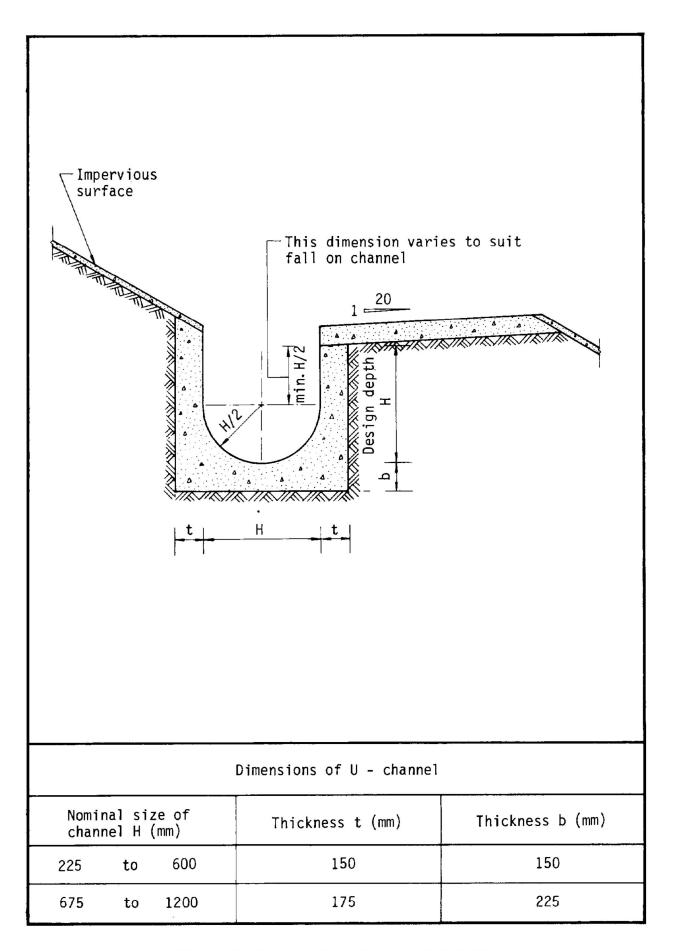


Figure 8.11 - Typical U-channel Details

FSYLE/DPO

P.001/002

Appendix II

規劃署

粉嶺、上水及元朗東規劃處



Planning Department

Fanling, Sheung Shui & Yuen Long East District Planning Office

來函檔號 Your Reference: DD107 Lot 1058 RP & VL

本署檔號 Our Reference: TPB/A/YL-KTN/806

電話號碼 Tcl. No.: 傳真機號碼 Fax No.:

R-riches Property Consultants Ltd. 208F, Kat Hing Wai Kam Tin Yuen Long, New Territories (Attn.: Orpheus LEE / Grace WONG)

27 November 2023

Dear Sir/Madam,

Submission for Compliance with Approval Condition (d)

the Submission of a Fire Service Installations Proposal

Proposed Temporary Place of Recreation, Sports or Culture (Hobby Farm) for a Period of 5 Years and Filling of Land in "Agriculture" Zone, Lots 1058 RP, 1059 RP, 1060 and 1061 in D.D. 107, Fung Kat Heung, Kam Tin, Yuen Long

(Planning Application No. A/YL-KTN/806)

I refer to your submission dated 6.9.2023 for compliance with the captioned approval condition. The relevant department has been consulted on your submission. Your submission is considered:

v	detailed departmental comment in Appendix.
	Acceptable. Since the captioned condition requires both the submission and implementation of the proposal, it <u>has not been fully complied with</u> . Please proceed to implement the accepted proposal for full compliance with the approval condition.
	Not acceptable. The captioned condition has not been complied with. Please

Should you have any queries, please contact Mr. CHEUNG Wing Hei (Tel:) of the Fire Services Department directly.

find detailed departmental comment in Appendix.

Yours faithfully,

(Anthony LUK)
District Planning Officer/

Fanling Sheung Shui & Yuen Long East Planning Department

Servino the community

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<u>c.c.</u> D of FS

(Attn.: Mr. CHEUNG Wing Hei)

(Fax:

Internal CTP/TPB

AL/AY/on

Appendix

Comments from the Director of Fire Services:

i. The applicant is advised that the installation /maintenance/ modification/ repair work of fire service installation (FSI) shall be undertaken by an Registered Fire Service Installation Contractor (RFSIC). The RFSIC shall after completion of the installation/maintenance/ modification/ repair work issue to the person on whose instruction the work was undertaken a certificate (FS 251) and forward a copy of the certificate to the Director of Fire Services.

FIRE SERVICES NOTES:

- HOSE REEL SYSTEM
- 1.1 HOSE REEL SHALL BE PROVIDED AT POSITIONS AS INDICATED ON PLANS.
- 1.2 THERE SHALL BE SUFFICIENT HOSE REELS TO ENSURE THAT EVERY PART OF THE BUILDING CAN BE REACHED BY A LENGTH OF NOT MORE THAN 30M OF HOSE REEL TUBING. ONE ACTUATING POINT AND ONE AUDIO WARNING DEVICE TO BE LOCATED AT EACH HR POINT. THE ACTUATING POINT SHOULD INCLUDE FACILITIES FOR THE FIRE PUMP START DEVICE INITIATION.
- 1.3 A MODIFIED HOSE REEL SYSTEM OF 2.000 LITRES WATER TANK TO BE PROVIDED FOR THE ENTIRE BUILDING AS INDICATED ON PLAN.
- 1.4 NO FIRE SERVICES INLET TO BE PROVIDED FOR THE MODIFIED HOSE REEL SYSTEM.
- 1.5 WATER SUPPLY FOR THE MODIFIED HOSE REEL SYSTEM TO BE SINGLE END FEED FROM THE GOVERNMENT TOWN MAIN.
- 1.6 TWO FIXED FIRE PUMPS (DUTY/STANDBY) TO BE PROVIDED AT F.S. & PUMP ROOM.
- 1.7 THE HR SYSTEM INSTALLED SHOULD BE IN ACCORDANCE OF THE CODE OF PRACTICE FOR MINIMUM FIRE SERVICE INSTALLATION AND EQUIPMENT 2022.
- 1.8 AN INSTRUCTION PLATE SHALL BE PROVIDED NEXT TO THE BREAK GLASS UNIT FOR OPERATION OF HOSE REEL.
- FIRE ALARM SYSTEM
- 2.1 FIRE ALARM SYSTEM SHALL BE PROVIDED THROUGHOUT THE ENTIRE BUILDING IN ACCORDANCE WITH BS 5839-1: 2017 AND FSD CIRCULAR LETTER N0.6/2021. ONE ACTUATING POINT AND ONE AUDIO WARNING DEVICE SHOULD BE LOCATED AT EACH HOSE REEL POINT. THE ACTUATION POINT SHOULD INCLUDE FACILITIES FOR FIRE PUMP START AND AUDIO / VISUAL WARNING DEVICE INITIATION.
- 3. MISCELLANEOUS F.S. INSTALLATION
- 3.1 PORTABLE FIRE EXTINGUISHER WITH SPECIFIED TYPE AND CAPACITY TO BE PROVIDED AT LOCATIONS AS INDICATED ON PLANS.
- 3.2 SUFFICIENT EMERGENCY LIGHTING SHALL BE PROVIDED THROUGHOUT THE ENTIRE BUILDINGS/STRUCTURES IN ACCORDANCE WITH BS 5266-1:2016, BS EN 1838:2013 AND FSD CL 4/2021.
- 3.3 SUFFICIENT DIRECTIONAL AND EXIT SIGN SHALL BE PROVIDED IN ACCORDANCE WITH BS 5266: PART 1 AND FSD CIRCULAR LETTER 5/2008.
- 3.4 NO EMERGENCY GENERATOR TO BE PROVIDED FOR SERVING THE EMERGENCY POWER. DUPLICATED POWER SUPPLIES FOR ALL FIRE SERVICES INSTALLATIONS COMPRISING A CABLE CONNECTED FROM ELECTRICITY MAINS DIRECTLY BEFORE THE MAIN SWITCH.
- 3.5 WHEN A VENTILATION/ AIR CONDITIONING CONTROL SYSTEM TO A BUILDING IS PROVIDED, IT SHALL STOP MECHANICALLY INDUCED AIR MOVEMENT WITHIN A DESIGNATED FIRE COMPARTMENT.

Drawing No.	Ver.
FSIs	02

Project


PROPOSED TEMPORARY PLACE OF RECREATION, SPORTS OR CULTURE FOR A PERIOD OF 5 YEARS AND LAND FILLING

VARIOUS LOTS IN D.D. 107, FUNG KAT HEUNG, KAM TIN, YUEN LONG, NEW TERRITORIES

Drawing Title

FSIs PROPOSAL (1/2)

Drawn	Date
OL	22.3.2022
Revised	Date
OΙ	28 7 2023

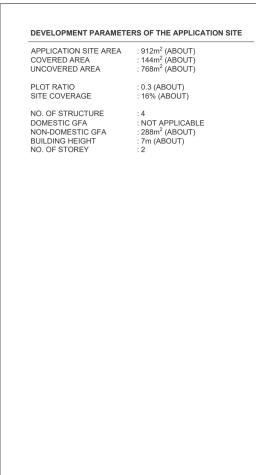



LANDSCAPING

AREA

В4

STRUCTURE USE **COVERED AREA** GFA **BUILDING HEIGHT** B1 RECEPTION AND SITE OFFICE 36m2 (ABOUT) 72m² (ABOUT) 7m (ABOUT) (2-STOREY) 72m² (ABOUT) B2 TOILET AND CHANGING ROOM 36m² (ABOUT) 7m (ABOUT) (2-STOREY) В3 STORAGE OF FARM TOOLS 36m² (ABOUT) 72m² (ABOUT) 7m (ABOUT) (2-STOREY) PLANT NURSERY & STORAGE OF FARM TOOLS 72m² (ABOUT) 7m (ABOUT) (2-STOREY) B4 36m² (ABOUT) 144m² (ABOUT) 288m² (ABOUT)

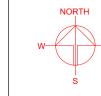

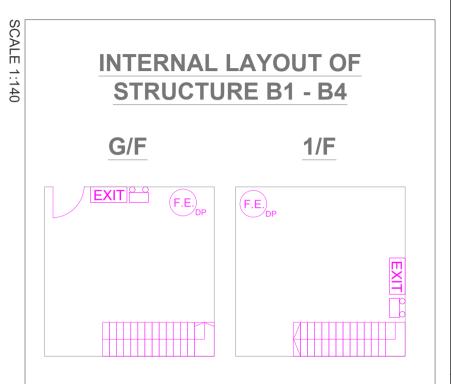

APPENDIX 1 01

Project

PROPOSED TEMPORARY
PLACE OF RECREATION,
SPORTS OR CULTURE FOR
A PERIOD OF 5 YEARS AND
LAND FILLING

Drawing No.

VARIOUS LOTS IN D.D. 107, FUNG KAT HEUNG, KAM TIN, YUEN LONG, NEW TERRITORIES

LEGEND

ENTRANCE / EXIT 3m (ABOUT)(W)

FARMLAND AREA

PUMP ROOM

PROPOSED 2m³

FIBRE GLASS

WATER TANK

B2

LANDSCAPING

AREA

H.R.

APPLICATION SITE-

B3

FARMLAND AREA

H.R.

B1

FARMLAND

AREA

- LANDSCAPING

AREA

APPLICATION SITE

STRUCTURE

≥ ENTRANCE / EXIT

4KG DRY POWDER TYPE FIRE EXTINGUISHER

VISUAL ALARM DEVICE
H.R. HOSE REEL SET

HOSE REEL SET 1
HOSE REEL PUMP

O BREAK GLASS UNIT