□Urgent	□Return receipt	□Expand Group	□Restricted	□Prevent Copy	
From:					
Sent:		2025	5-10-22 星期	= 10:59:46	

Subject: A/YL-PH/1079 排水建議及補充資料

Attachment: A_YL-PH_1079 排水建議.pdf; A_YL-PH_1079 回應渠務署意

見.pdf; 補充資料.pdf; 補充資料 2.pdf

現就相關規劃申請編號提交補充資料及排水建議,請查閱附件,謝謝。

另特此補充:

To:

- 1. 申請地點只允許持有香港車牌之指定車輛(即私家車及輕型貨車)停泊,其他類型及無牌車輛一律禁止進入。
- 2. 本人將在是次規劃申請獲批後為申請地點內的構築物申請短期豁免書。

如有疑問請致電

申請人 夏佩娟 2025 年 10 月 22 日 聯絡地址:新界元朗八鄉橫台山永寧里2號1樓

電話:

申請地點:新界元朗八鄉丈量約份第111約地段編號第2622號(部份)及2623號(部份)

規劃編號: A/YL-PH/1079

致 粉嶺、上水及元朗東規劃處:

申請地點的補充資料

(a) 車輛流量:

07:00至09:00	估計約6輛車駛出申請地點,5車輛停泊。
09:00至11:00	約2輛車駛出,1輛進入申請地點,3車輛停泊。
11:00至12:00	約1輛車駛出,1輛進入申請地點,3車輛停泊。
12:00至13:00	約1輛車駛出,1輛進入申請地點,3車輛停泊。
13:00至14:00	約1輛車駛出,2輛進入申請地點,4車輛停泊。
14:00至15:00	約2輛車駛出,2輛進入申請地點,4車輛停泊。
15:00至16:00	約2輛車駛出,2輛進入申請地點,4車輛停泊。
16:00至17:00	約2輛車駛出,2輛進入申請地點,4車輛停泊。
17:00至18:00	約2輛車駛出,3輛進入申請地點,5車輛停泊。
18:00至19:00	約3輛車進入申請地點,8車輛停泊。
19:00至20:00	約3輛車駛出,3輛進入申請地點,8車輛停泊。
20:00至21:00	約2輛車駛出,2輛進入申請地點,8車輛停泊。
21:00至22:00	約2輛車駛出,2輛進入申請地點,8車輛停泊。
22:00至23:00	約2輛車駛出,3輛進入申請地點,9車輛停泊。
23:00至00:00	約2輛車駛出,2輛進入申請地點,9車輛停泊。
00:00至07:00	約2輛車進入申請地點,11車輛停泊。

車位數目是固定11架,而實際車輛出入次數會更少。

(b) 目標用戶:提供月租車位給橫台山散村村民及附近倉地的工作者,皆為在周邊生活的人。

致 城規會及相關部門

申請地點:新界元朗八鄉丈量約份第111約地段編號第2622號(部份)及2623號(部

份)

規劃編號: A/YL-PH/1079

提議兩水渠務報告 (Proposed)

- 1. 提議雨水渠道(簡介)
- 2. a. 申請人提議的渠管道建造是由申請人自費的。
 - b. 申請人提議的渠管道日後維修保養是申請人的責任。
 - c. 申請人提議的渠管道,也明白地權是政府/私人的。
 - d. 申請人承諾會得到政府部門同意/私人地段同意才會建設渠道工程。
 - e. 申請人聘任了 <u>PERRY LEE BUILDING CONSULTANCY COMPANY</u>公司作此次渠務顧問。

申請人聯絡方式	渠務顧問聯絡方式
電話:	電話:
Email:	Email:

簡介 回復2025-08-28日信函


簡介 回復2025-08-28日信 Comment	回答		
2. I have the following comments on the drainage plan: -	四位		
(a) Please refer to DSD's Stormwater Drainage Manual and its			
corrigenda for preparation of the drainage assessment/proposal.	知道		
(b) The ground level at the southern side of the application site is	在圖b2-1 中以加大Catchment Area和		
higher. The applicant should review the existing site condition,	ALIGIOZ-1 PANITA Cateminent Arca/a		
take into account any overflow and review the total catchment			
area adopted in the drainage design and calculation.	改用Proposed 400UC		
(c) Land filling is proposed under the application. In view of (b)	申請實際是不用填土,而是流程所須,		
above, please take into account in the proposed drainage			
arrangement and ensure that the existing drain path/overland flow	申請地段早以是現在的G.L. 所以沒有		
from adjacent land would not be affected.	影響		
(d) Where walls or hoarding are erected or laid along the site	我司沒有曾加任何圍牆或圍板,所有		
boundary, adequate opening should be provided to intercept the			
existing overland flow passing through the site.	圍牆或圍板薺有的, 有足夠的開口.		
(e) Cross sections A-A should be extended to show the levels at	左 科 1 由子		
the southern side of the site, up to the existing road.	在d1-1中示		
(f) Please show the discharge point details and the standard	在b2-1 中示		
details in separate drawings.			
(g) The development should neither obstruct overland flow nor			
adversely affect existing natural streams, village drains, ditches	知道和明白		
and the adjacent areas, etc.			
(h) The proposed channel between CP4 to the discharge point on			
government land is sole for the proposed development. The	知道和明白		
applicant is responsible for the operation and maintenance of this			
channel at his own costs.			
(i) The existing drainage channel of the proposed discharge point			
is not maintained by this Department. The applicant shall resolve			
any conflict/disagreement with relevant lot owner(s) and seek	知道和明白		
LandsD's permission for laying new drains/channels and/or			
modifying/upgrading			
existing ones in other private lots or on Government land outside	知道和明白		
the application site.			
3. Please note that the above comments are provided from			
drainage point of view. Since the site formation levels and any			
associated works proposed by the applicant may affect adjacent	() \ (\ \) \ (\ \ \) \ (\ \ \) \ (\ \ \ \		
land and cause other impacts and/or other issues to public, please	知道和明白		
consider to require the applicant to submit technical			
assessment(s) in other aspect(s) and seek comment from relevant			
departments as necessary.			

城規編號: A/YL-PH/1079 <u>提議渠務報告(Proposed)</u>


提議渠務報告 (Proposed)三年臨時用地


簡介

b1	Site Location & EX Soil Nullah Location
b2	Site Location, Catchmant, Proposed Drainage
b3	雨水計算
b4~b7	Proposed UC, Proposed CP
c1~c2	現場相片和拍照位置
d1	Section Plan

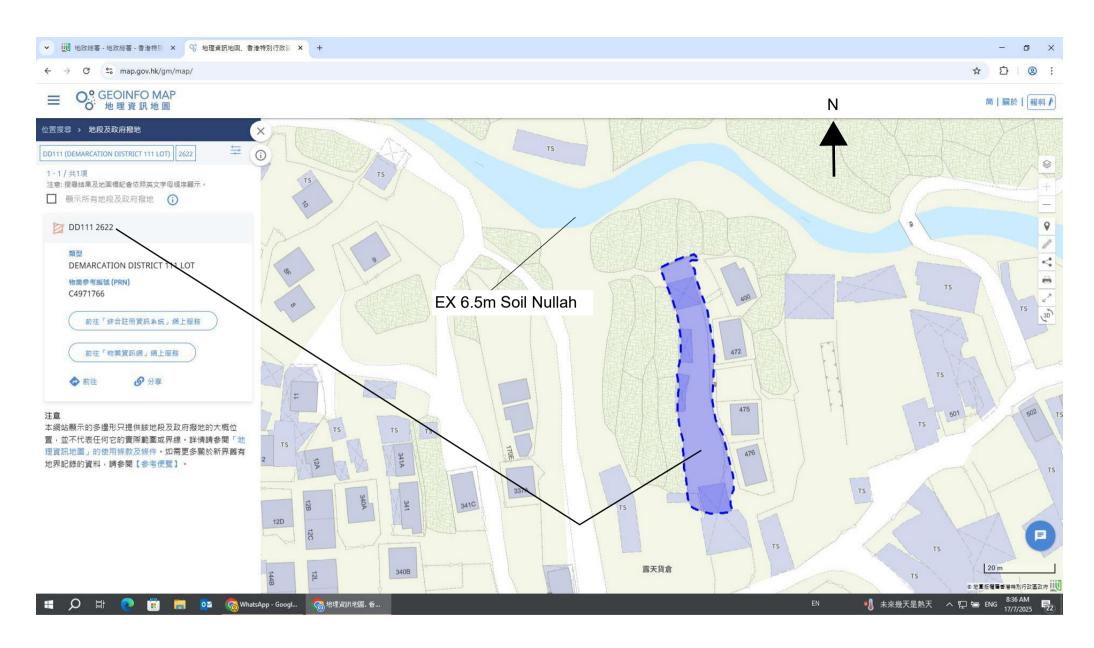


Site Location & EX Nullah

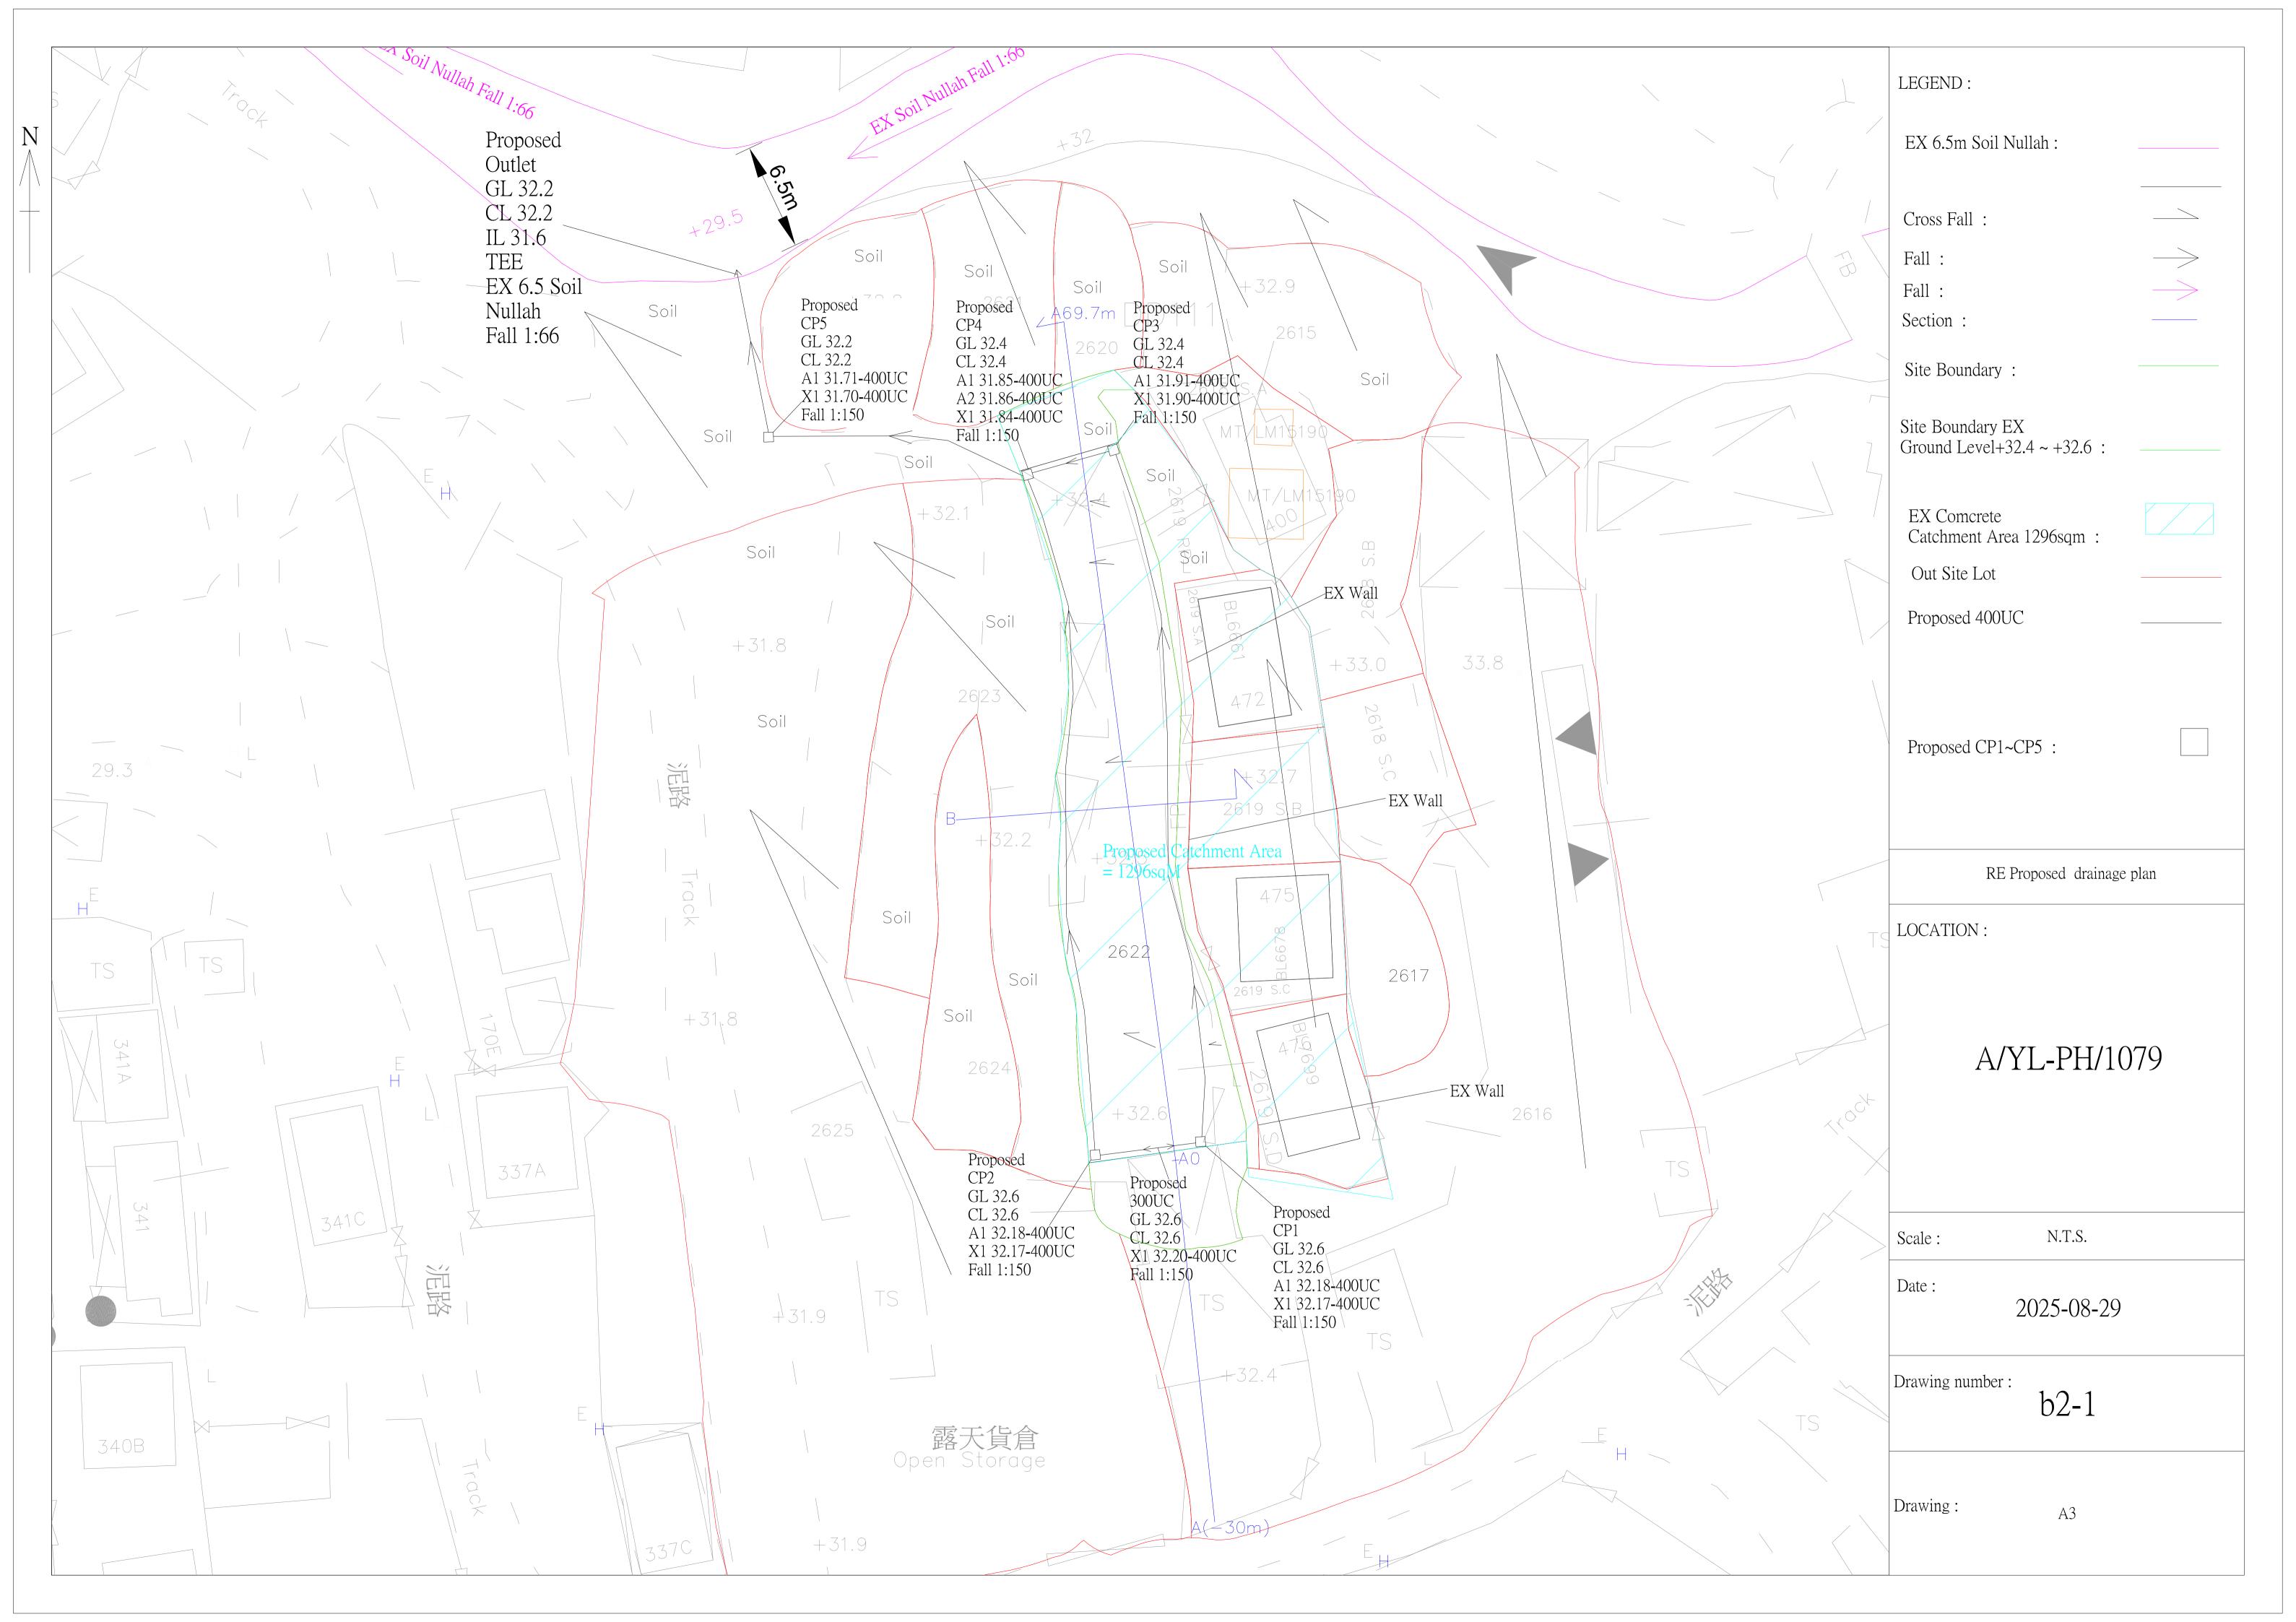


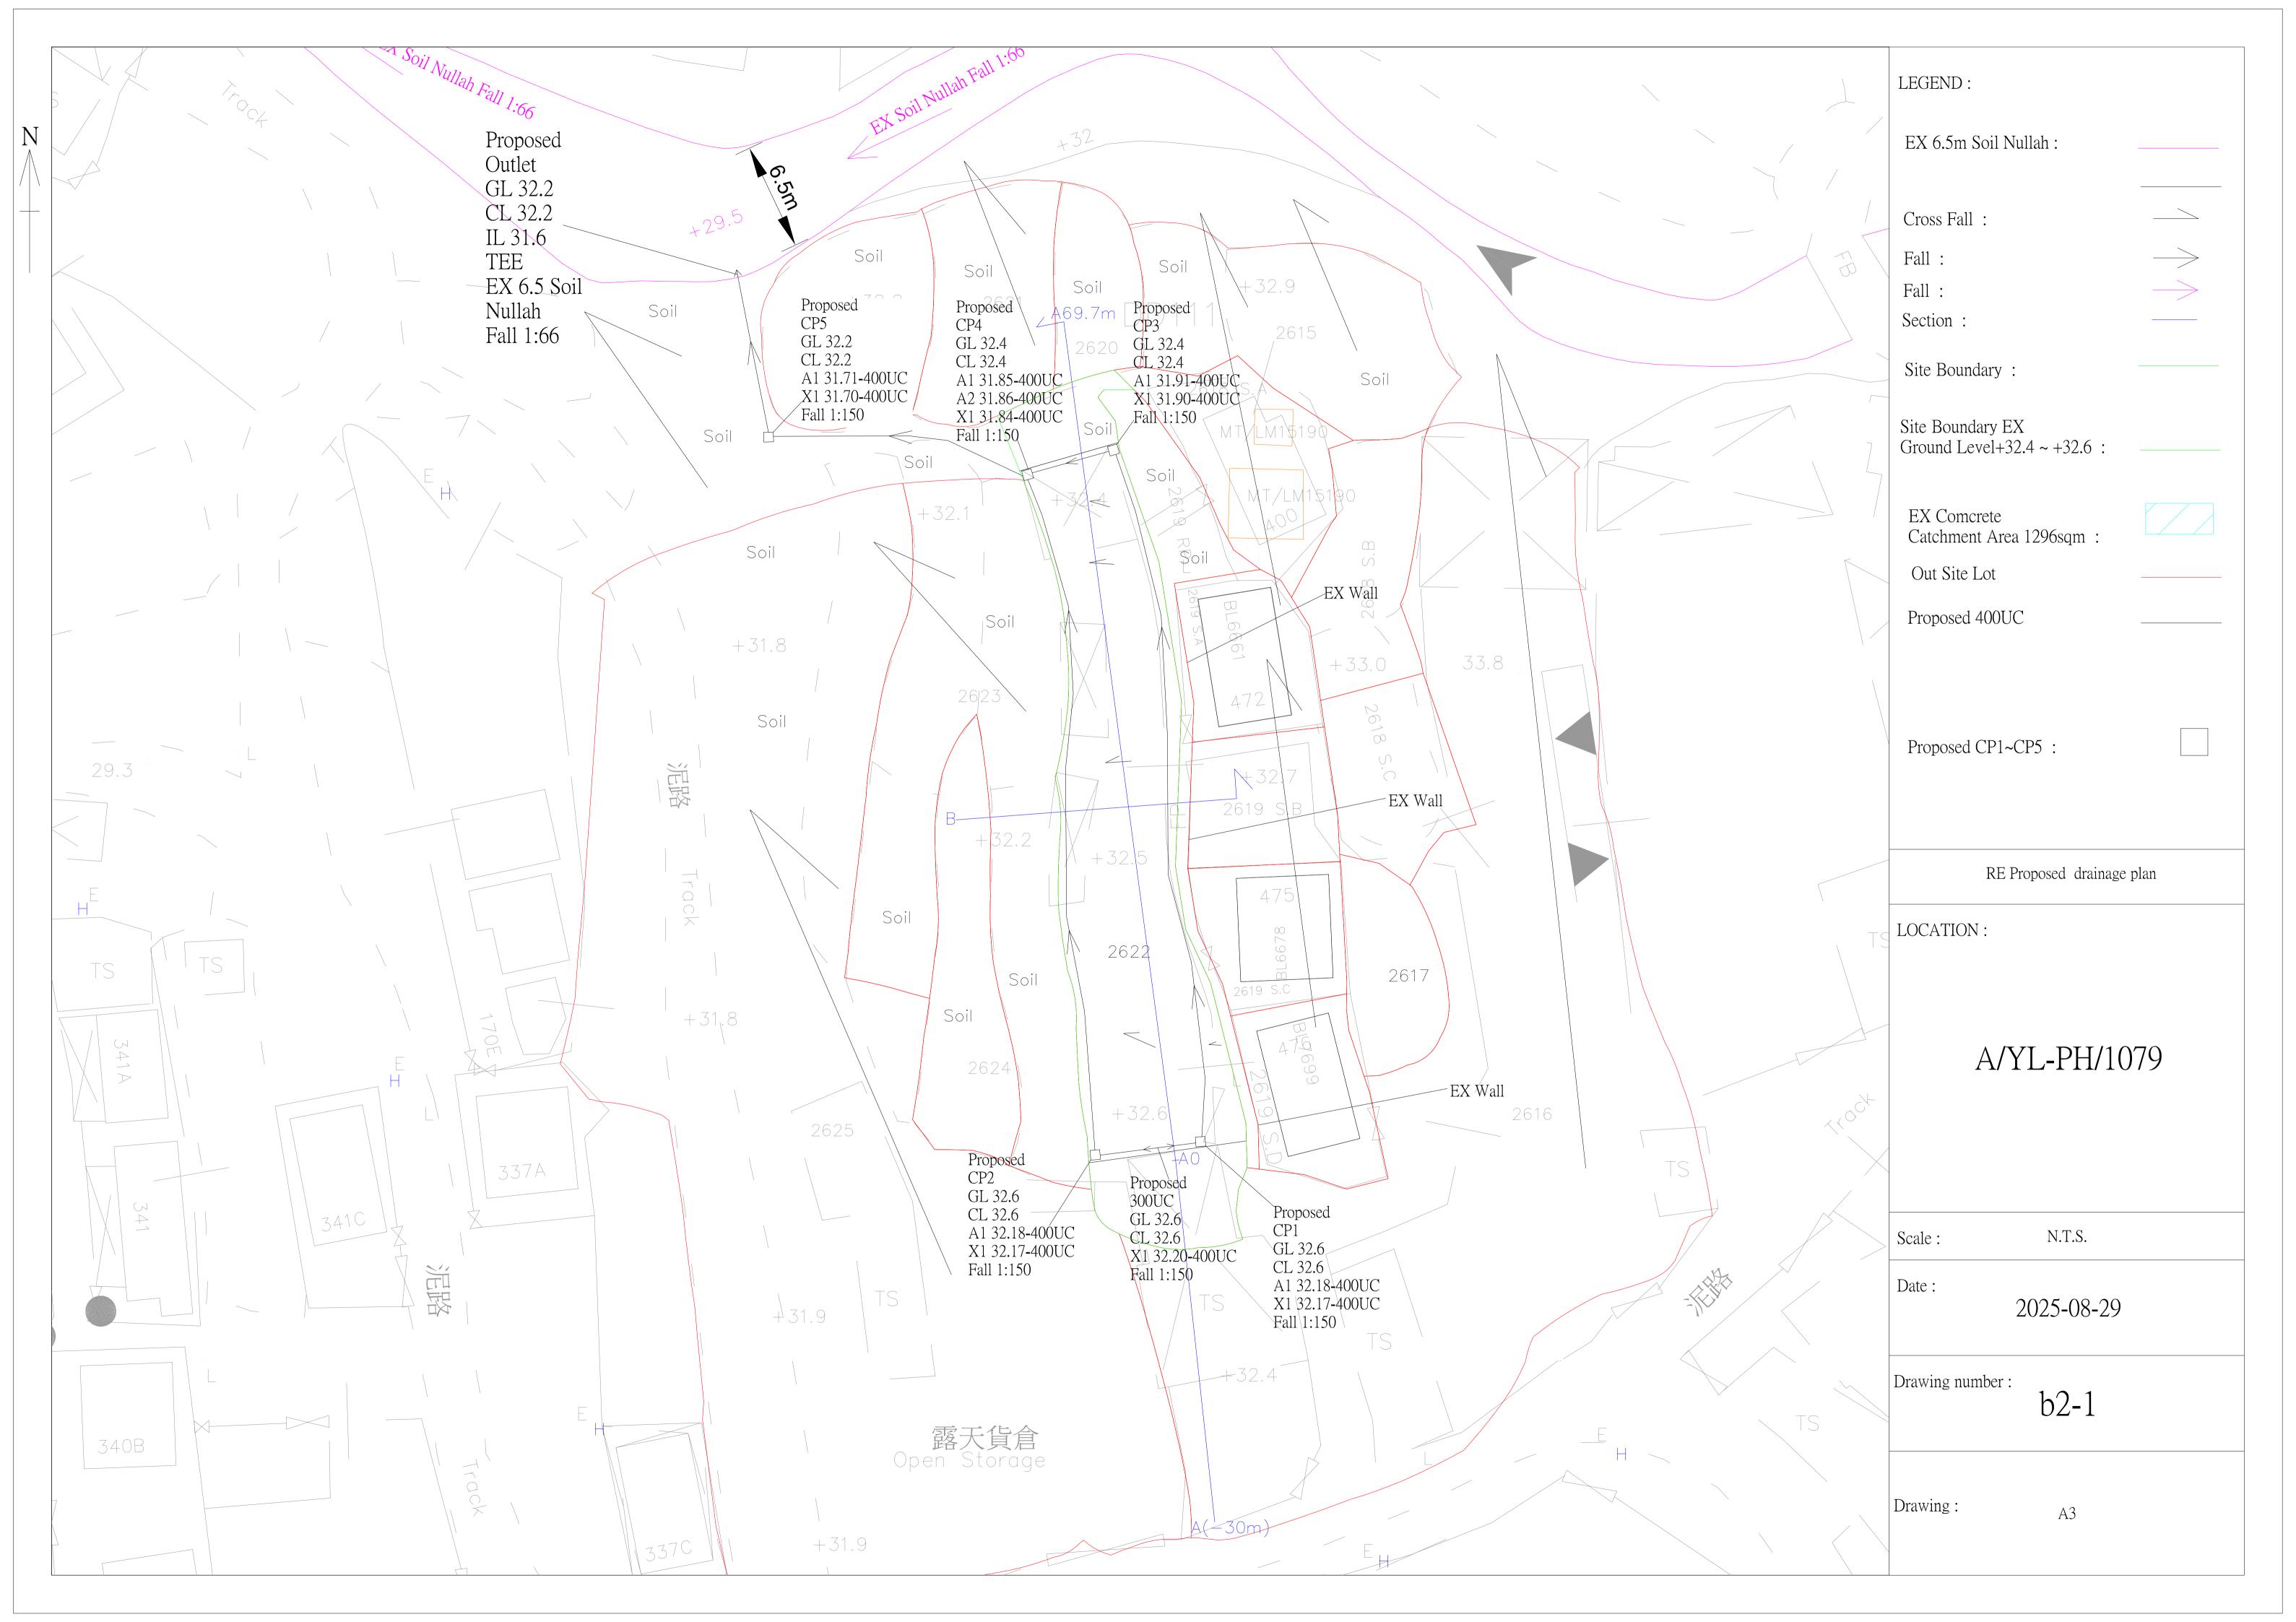

PH-1079 MH schedule

TYPE / DRAWING	MH no	GL	CL	A I.L	X I.L	TO MH / Existing	% Fall
C2405/1	CP1	32.60	32.60	A1 32.18 - 400UC	X1 32.17 - 400UC	CP3	1:150
C2405/1	CP2	32.60	32.60	A1 32.18 - 400UC	X1 32.17 - 400UC	CP4	1:150
C2405/1	CP3	32.40	32.40	A1 31.91 - 400UC	X1 31.90 - 400UC	CP4	1:150
C2405/1	CP4	32.40	32.40	A1 31.85 - 400UC A2 31.86 - 400UC	X1 31.84 - 400UC	CP5	1:150
C2406/1	CP5	32.20	32.20	A1 31.71 - 400UC	X1 31.70 - 400UC	EX 6.5m Soil Nullah	1:150
C2412E	CP1 - CP2 UC	32.60	32.60		X1 32.20 - 400UC		1:150
C2412E	CP1 - CP3 UC	32.60 to 32.40	32.60 to 32.40		X1 32.17 - 400UC		1:150
C2412E	CP2 - CP4 UC	32.60 to 32.40	32.60 to 32.40		X1 32.17 - 400UC		1:150
C2412E	CP3 - CP4 UC	32.40	32.40		X1 31.90 - 400UC		1:150
C2412E	CP4 - CP5 UC	32.40 to 32.20	32.40 to 32.20		X1 31.84 - 400UC		1:150
C2412E	CP5 - EX Nullah UC	32.20	32.20		X1 31.70 - 400UC		1:150

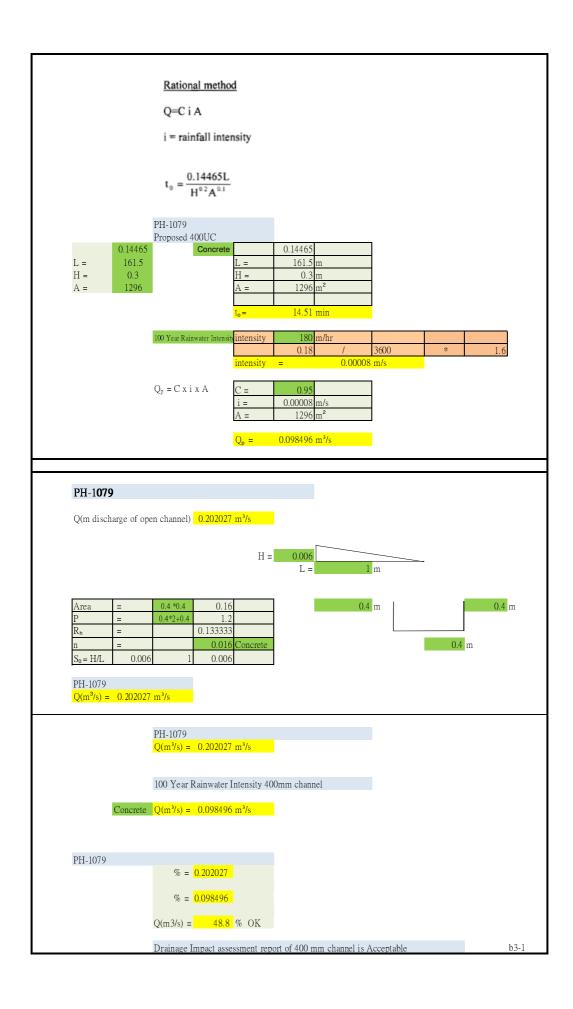

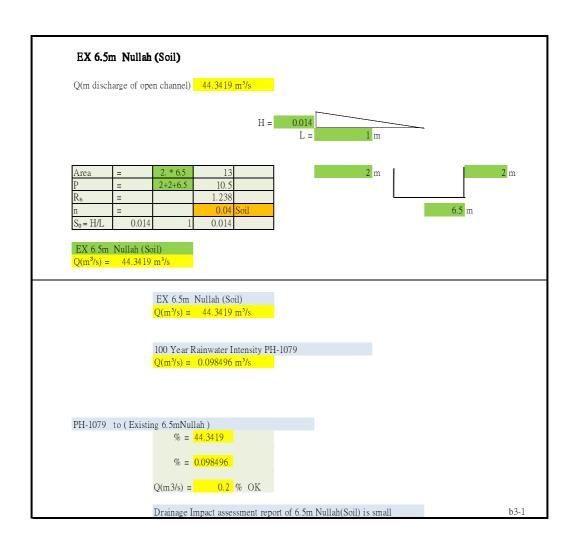

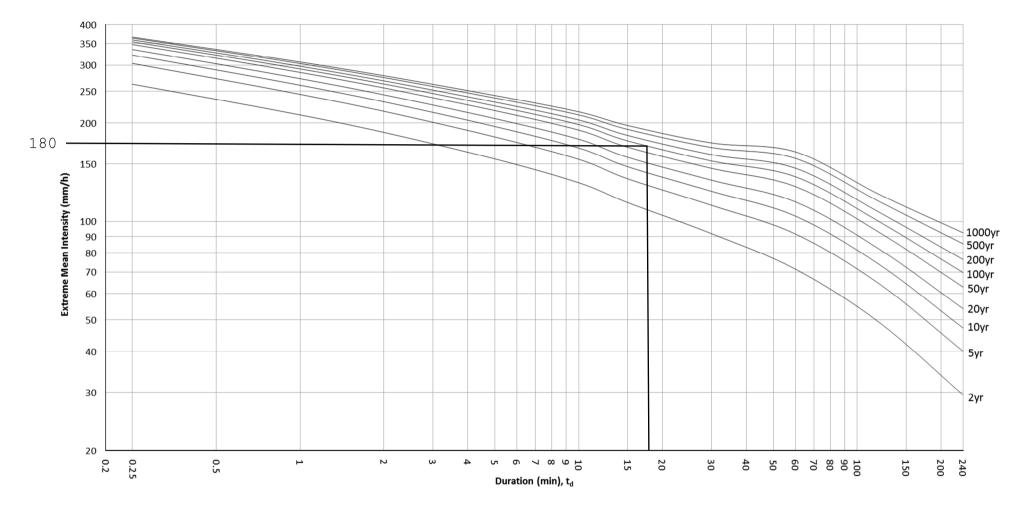


Figure 4a – Intensity-Duration-Frequency Curves of HKO Headquarters (for durations not exceeding 4 hours)

	7,200m ²	300mm	7
χ,	$2,400\text{m}^2$	375mm	
	4,000m ²	450mm)

(b) Complicated Sites

As pointed out in Section 3(b), the drainage submission for complicated sites will be in the form of a DIA, in accordance with DSD Advice Note No. 1, which includes a drainage proposal to mitigate the adverse drainage impacts, instead of just a drainage proposal as for simple sites.

7. Forwarding drainage submissions and vetting time


When the drainage submission is ready, the applicant should forward it to Plan D and DSD at the same time. DSD will comment on the submission and return comments to the applicant via Plan D. The normal vetting time is four weeks from the date of receipt of the drainage submissions.


8. Arrangements for final inspection of drainage works upon completion

Upon the satisfactory drainage submission, the applicants should implement and complete the proposed drainage facilities as per their submissions as soon as possible. When they are completed on site, the applicant should serve a notice of completion of works (with photos showing the completed works) to Plan D and DSD at the same time. DSD will arrange a completion inspection, normally two weeks from the date of receipt of the notice, to check on site if they are in order. The applicant will be informed of the results of the inspections via Plan D. In view of the increasing public expectation on flood protection, the applicants should only operate the development site after the satisfactory completion of the final inspection.

9. Maintenance of completed drains

Regular maintenance such as routine desilting is essential for all drains, catchpits and streamcourses to avoid blockage and deterioration. Hence, the applicant should ensure and keep all drainage works proposed by him, after construction, under proper maintainance during occupancy of the site. In this connection, the applicant shall ensure during the design stage that those drains constructed under his drainage proposal are accessible and maintainable at all times.

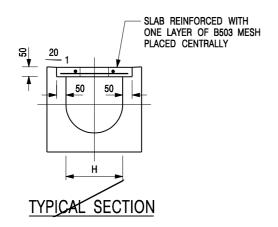


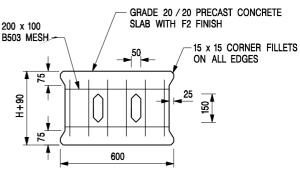


PLAN OF SLAB

U-CHANNELS WITH PRECAST CONCRETE SLABS

(UP TO H OF 525)

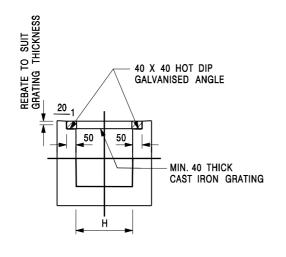

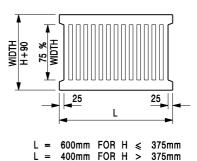

TYPICAL SECTION

CAST IRON GRATING

(DIMENSIONS ARE FOR GUIDANCE ONLY, CONTRACTOR MAY SUBMIT EQUIVALENT TYPE)

U-CHANNEL WITH CAST IRON GRATING

(UP TO H OF 525)

NOTES:

- 1. ALL DIMENSIONS ARE IN MILLIMETRES.
- 2. H=NOMINAL CHANNEL SIZE.
- 3. ALL CAST IRON FOR GRATINGS SHALL BE GRADE EN-GJL-150 COMPLYING WITH BS EN 1561.
- 4. FOR COVERED CHANNELS TO BE HANDED OVER TO HIGHWAYS DEPARTMENT FOR MAINTENANCE, THE GRATING DETAILS SHALL FOLLOW THOSE AS SHOWN ON HyD STD. DRG. NO. H3156.

REF.	REVISION	SIGNATURE	DATE
Α	CAST IRON GRATING AMENDED.	Original Signed	12.2002
В	NAME OF DEPARTMENT AMENDED.	Original Signed	01.2005
С	MINOR AMENDMENT. NOTE 3 ADDED.	Original Signed	12.2005
D	NOTE 4 ADDED.	Original Signed	06.2008
E	NOTES 3 & 4 AMENDED.	Original Signed	12.2014

COVER SLAB AND CAST IRON GRATING FOR CHANNELS

卓越工程 建設香港





CIVIL ENGINEERING AND DEVELOPMENT DEPARTMENT

b4

SCALE 1:20 DRAWING NO. C2412E

We Engineer Hong Kong's Development

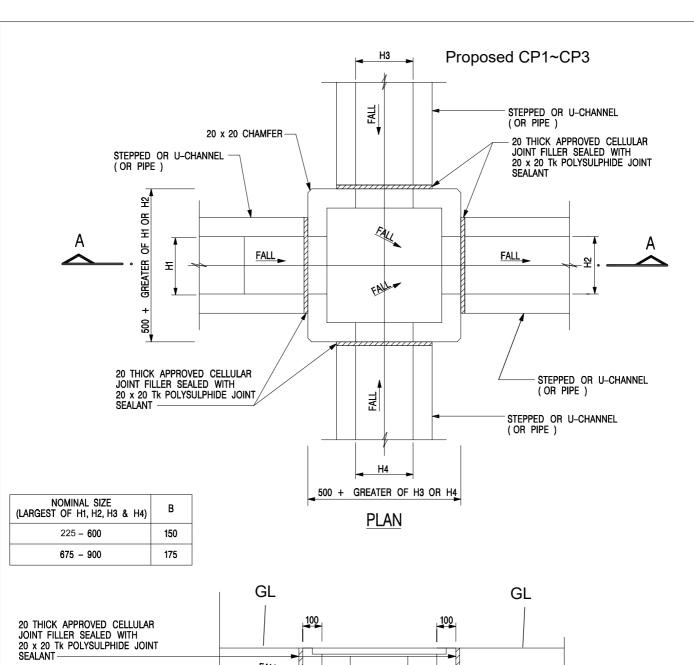

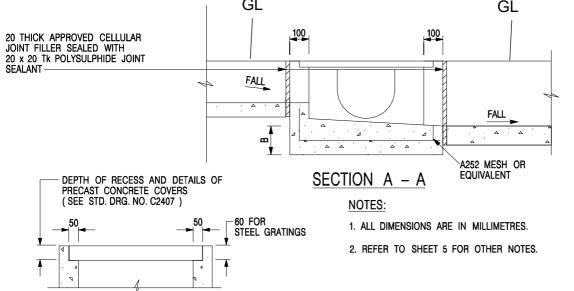


ALTERNATIVE TOP SECTION FOR PRECAST CONCRETE COVERS / GRATINGS


b5

-		Original Signed	
REF.	REVISION	SIGNATURE	

STANDARD CATCHPIT DETAILS (SHEET 1)

SCALE 1:20 **DRAWING NO.** C2405 /1

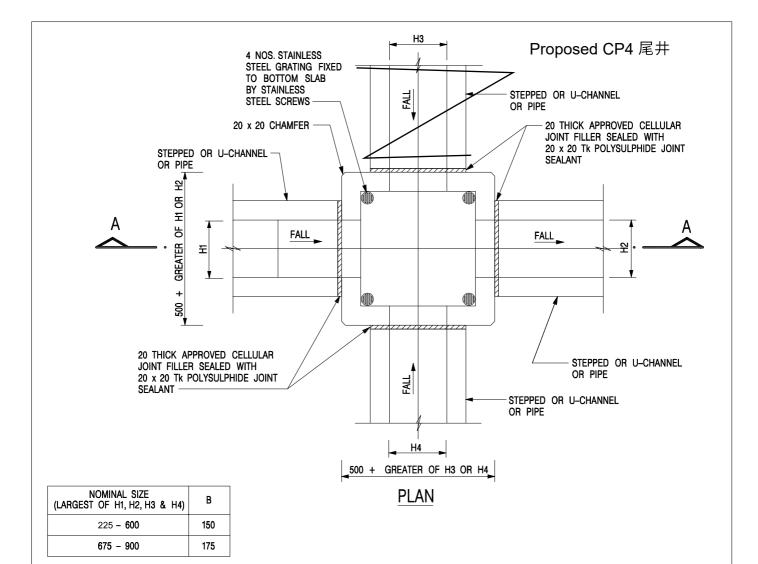

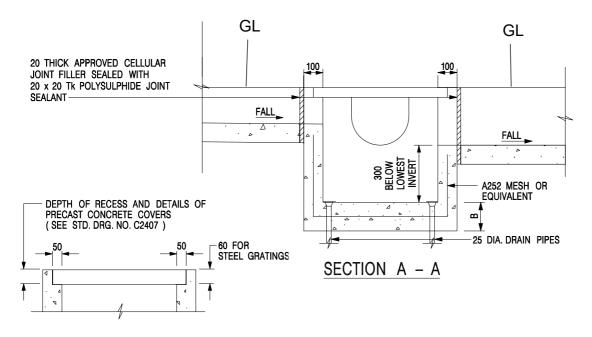

NOTES:

1. ALL DIMENSIONS ARE IN MILLIMETRES.

2. REFER TO SHEET 2 FOR OTHER NOTES.


CATCHPIT WITH TRAP (SHEET 1)


REF.	REVISION	SIGNATURE	DAIE
255	BEVIOLON	CLONATURE	BATE
-		Original Signed	


b6

REF.	REVISION	SIGNATURE	DATE

SCALE 1:20	DRAWING NO.
DATE	C2406 /1

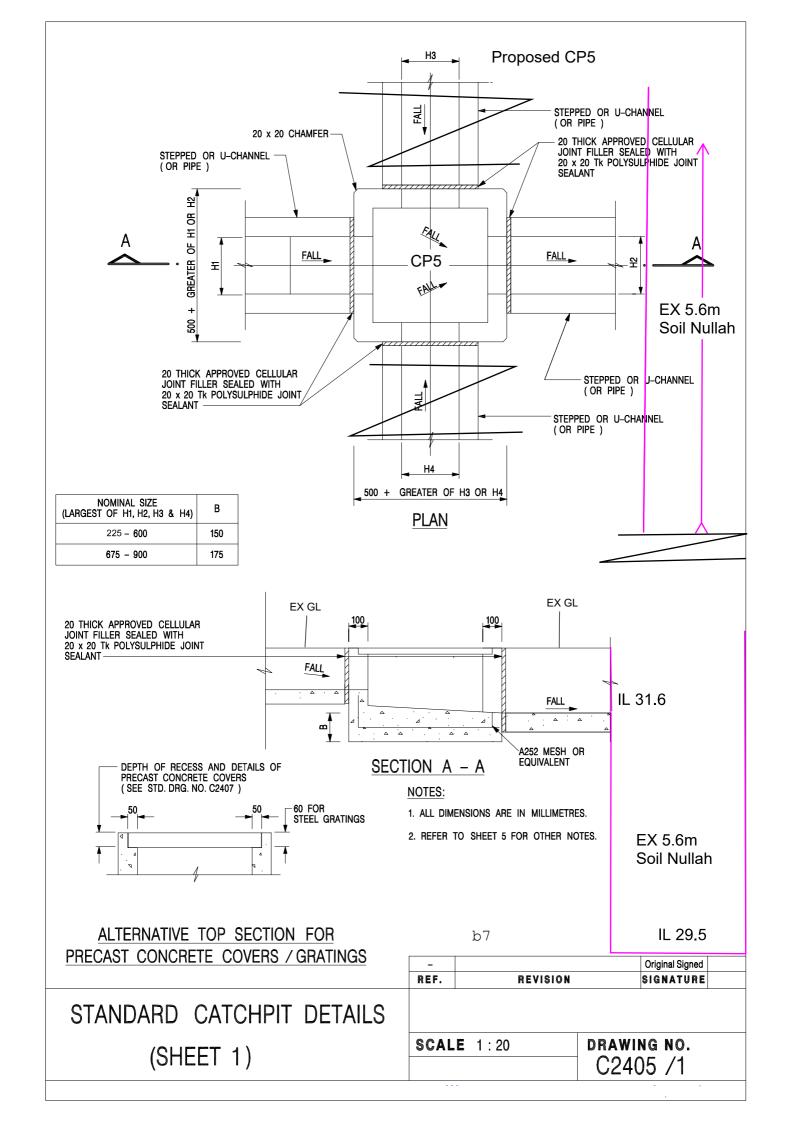

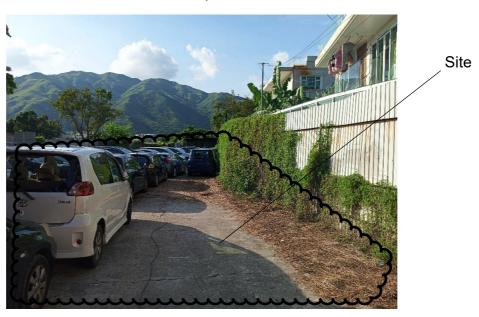

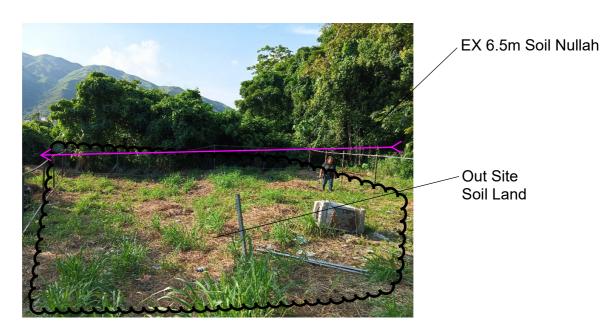



EX 6.5m Soil Nullah


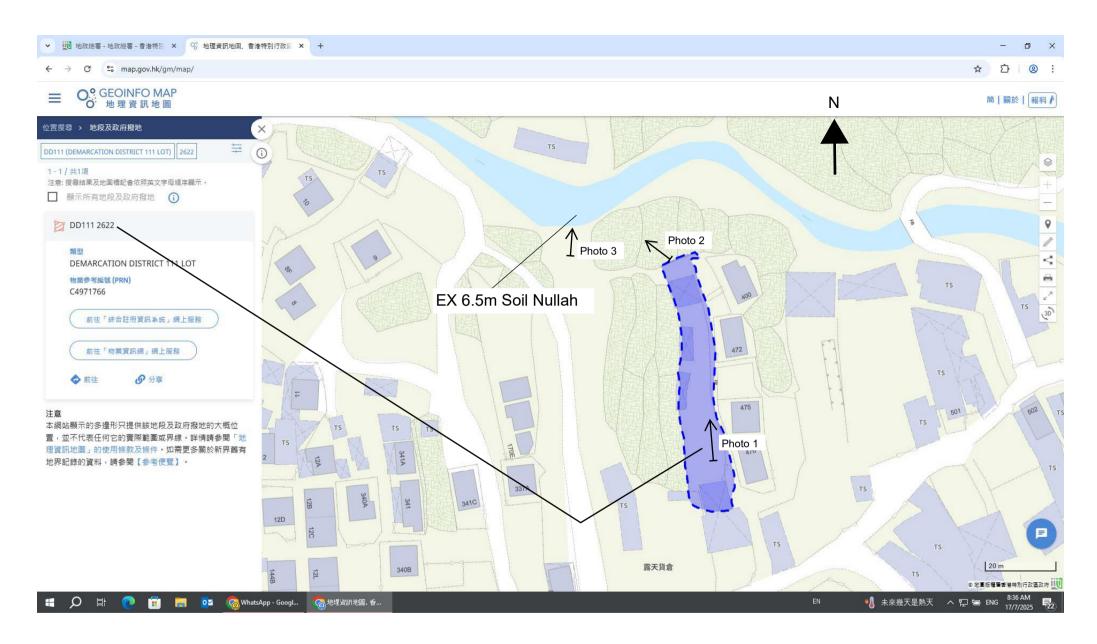



Photo Location







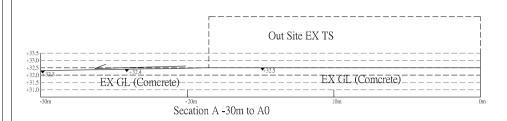

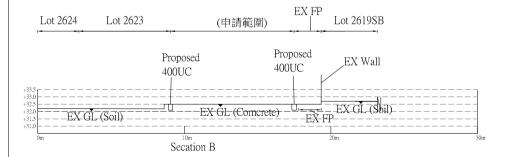

d1-1 Secation

Scale: 1:250 A4