2024年 08月 27日 收到。城市規劃委員會

27 AUG 2024 This document is received on The Town Planning Board will formally acknowledge the date of receipt of the application only upon receipt of all the required information and documents.

Form No. S16-III 表格第 S16-III 號

APPLICATION FOR PERMISSION **UNDER SECTION 16 OF** THE TOWN PLANNING ORDINANCE (CAP. 131)

根據《城市規劃條例》(第131章) 第16條遞交的許可申請

Applicable to Proposal Only Involving Temporary Use/Development of Land and/or Building Not Exceeding 3 Years in Rural Areas or Regulated Areas, or Renewal of Permission for such Temporary Use or Development*

適用於祇涉及位於鄉郊地區或受規管地區土地上及/或建築物內進行 為期不超過三年的臨時用途/發展或該等臨時用途/發展的許可續期的建議*

*Form No. S16-I should be used for other Temporary Use/Development of Land and/or Building (e.g. temporary use/developments in the Urban Area) and Renewal of Permission for such Temporary Use or Development. *其他土地上及/或建築物內的臨時用途/發展(例如位於市區內的臨時用途或發展)及有關該等臨時用途/發 展的許可續期,應使用表格第 S16-I 號。

Applicant who would like to publish the notice of application in local newspapers to meet one of the Town Planning Board's requirements of taking reasonable steps to obtain consent of or give notification to the current land owner, please refer to the following link regarding publishing the notice in the designated newspapers: https://www.tpb.gov.hk/en/plan_application/apply.html

申請人如欲在本地報章刊登申請通知,以採取城市規劃委員會就取得現行土地擁有人的同意或通知現行 土地擁有人所指定的其中一項合理步驟,請瀏覽以下網址有關在指定的報章刊登通知: https://www.tpb.gov.hk/tc/plan_application/apply.html

General Note and Annotation for the Form 填寫表格的一般指引及註解

- "Current land owner" means any person whose name is registered in the Land Registry as that of an owner of the land to which the application relates, as at 6 weeks before the application is made 「現行土地擁有人」指在提出申請前六星期,其姓名或名稱已在土地註冊處註冊為該申請所關乎的 土地的擁有人的人
- * Please attach documentary proof 請來附證明文件
- ^ Please insert number where appropriate 請在適當地方註明編號

Please fill "NA" for inapplicable item 請在不適用的項目填寫「不適用」

Please use separate sheets if the space provided is insufficient 如所提供的空間不足,請另頁說明

Please insert a 「 v 」 at the appropriate box 請在適當的方格内上加上「 v 」號

For Official Use Only 請勿填寫此欄	Application No. 申請編號	A/NE-TKL/773
	Date Received 收到日期	2 7 AUG 2024

- 1. The completed form and supporting documents (if any) should be sent to the Secretary, Town Planning Board (the Board), 15/F, North Point Government Offices, 333 Java Road, North Point, Hong Kong. 申請人須把填妥的申請表格及其他支持申請的文件 (倘有),送交香港北角渣華道 333 號北角政府合署 15 樓城市規劃委員會(下稱「委員會」)秘書收。
- 2. Please read the "Guidance Notes" carefully before you fill in this form. The document can be downloaded from the Board's website at http://www.tpb.gov.hk/. It can also be obtained from the Secretariat of the Board at 15/F, North Point Government Offices, 333 Java Road, North Point, Hong Kong (Tel: 2231 4810 or 2231 4835), and the Planning Enquiry Counters of the Planning Department (Hotline: 2231 5000) (17/F, North Point Government Offices, 333 Java Road, North Point, Hong Kong and 14/F, Sha Tin Government Offices, 1 Sheung Wo Che Road, Sha Tin, New Territories). 請先細閱《申請須知》的資料單張,然後填寫此表格。該份文件可從委員會的網頁下載(網址: http://www.tpb.gov.hk/),亦可向委員會秘書處 (香港北角渣華道 333 號北角政府合署 15 樓-電話: 2231 4810 或 2231 4835)及規劃署的規劃資料查詢處(熱線: 2231 5000) (香港北角渣華道 333 號北角政府合署 17 樓及新界沙田上禾輋路 1 號沙田政府合署 14 樓)索取。
- 3. This form can be downloaded from the Board's website, and obtained from the Secretariat of the Board and the Planning Enquiry Counters of the Planning Department. The form should be typed or completed in block letters. The processing of the application may be refused if the required information or the required copies are incomplete. 此表格可從委員會的網頁下載,亦可向委員會秘書處及規劃署的規劃資料查詢處索取。申請人須以打印方式或以正楷填寫表格。如果申請人所提交的資料或文件副本不齊全,委員會可拒絕處理有關申請。

1. Name of Applicant	申請人姓名/名稱
----------------------	----------

(□Mr. 先生 /□Mrs. 夫人 /□Miss 小姐 /□Ms. 女士 /ଢ Company 公司 /□Organisation 機構)

焯陞資產有限公司 JSK Assets Limited

2. Name of Authorised Agent (if applicable) 獲授權代理人姓名/名稱(如適用)

(□Mr. 先生/□Mrs. 夫人/□Miss 小姐/□Ms. 女士/☑Company 公司/□Organisation 機構)

領嶠物業顧問有限公司 Top Planning Property Consultants Limited

3.	Application Site 申請地點	
(a)	Full address / location / demarcation district and lot number (if applicable) 詳細地址/地點/丈量約份及地段號碼(如適用)	新界粉嶺軍地丈量約份第83約地段第456號餘段、第459號、 第460號、第461號、第462號及第2229號餘段 Lots 456 RP, 459, 460, 461, 462 and 2229 RP in D.D. 83, Kwan Tei, Fanling, NewTerritories
(b)	Site area and/or gross floor area involved 涉及的地盤面積及/或總樓面面 積	☑Site area 地盤面積 6,300 sq.m 平方米☑About 約 ☑Gross floor area 總樓面面積 4,856 sq.m 平方米☑About 約
(c)	Area of Government land included (if any) 所包括的政府土地面積(倘有)	N/A sq.m 平方米 □About 約

(d)	Name and number of the statutory plan(s) 有關法定圖則的名稱及約		坪华及打鼓嶺分區計劃大綱核准圖編號 S/NE-T Approved Ping Che and Ta Kwu Ling Outline Zon		
(e)	Land use zone(s) involved 涉及的土地用途地帶				
(f)	Current use(s) 現時用途		物流中心 Logistics Centre (If there are any Government, institution or community plan and specify the use and gross floor area) (如有任何政府、機構或社區設施,請在圖則上顯示	_	
4.	"Current Land Own	ier" of A	pplication Site 申請地點的「現行土均	也擁有人」	
The	applicant 申請人 _				
	is the sole "current land ov 是唯一的「現行土地擁有	wner"**& (ple 引人」**& (誤	ease proceed to Part 6 and attach documentary proof 指繼續填寫第 6 部分,並夾附業權證明文件)。	of ownership).	
	is one of the "current land。 是其中一名「現行土地擀	owners'" ^{# &} 推有人」 ^{#&}	(please attach documentary proof of ownership). (請夾附業權證明文件)。		
₩	is not a "current land owne 並不是「現行土地擁有人	:r'' [#] .			
	The application site is entirely on Government land (please proceed to Part 6). 申請地點完全位於政府土地上(請繼續填寫第 6 部分)。				
5.	Statement on Owner 就土地擁有人的同		nt/Notification 訂土地擁有人的陳述		
(a)	involves a total of	"cı	年	•	
(b)	The applicant 申請人 —				
			"current land owner(s)".		
	已取得	名「:	現行土地擁有人」"的同意。		
	Details of consent of	f "current la	and owner(s)" # obtained 取得「現行土地擁有人	」"同意的詳情	
	「現行土地擁有」R	Registry whe	address of premises as shown in the record of the Landere consent(s) has/have been obtained 冊處記錄已獲得同意的地段號碼/處所地址	Date of consent obtained (DD/MM/YYYY) 取得同意的日期 (日/月/年)	
	(Please use separate sher	ets if the spa	ce of any box above is insufficient,如上列任何方格的空	期不足,誠足百治阳)	

		rrent land owner(s)"# notified	已獲通知「現行土地擁有人」	
	No. of 'Current Land Owner(s)' 「現行土地擁 有人」數目	Lot number/address of premis Land Registry where notificat 根據土地註冊處記錄已發出		Date of notification given (DD/MM/YYYY) 通知日期(日/月/年)
			is insufficient. 如上列任何方格的?	2間不足,請另頁說明)
\checkmark	已採取合理步驟以	le steps to obtain consent of or g 以取得土地擁有人的同意或向記	亥人發給通知。詳情如下:	
			取得土地擁有人的同意所採取	
			wner(s)" on 「現行土地擁有人」"郵遞要求同	— ·
	Reasonable Steps to	o Give Notification to Owner(s)	向土地擁有人發出通知所採即	2的合理步驟
		ces in local newspapers on (日/月/年)在指定報道	(DD/MM/YY 章就申請刊登一次通知&	YY) ^{&}
	posted notice 16/07/20	in a prominent position on or ne	ear application site/premises on	
	於16/07/20	10.4	點/申請處所或附近的顯明位置	貼出關於該申請的通知
	office(s) or ru	ral committee on16/07/202		., -
	//×	2024(日/月/年)把通知寄 引鄉事委員會 ^{&}	往相關的業主立案法團/業主國	萨員會/互助委員會或管
	Others 其他			
	□ others (please 其他(請指明	. •,		

6. Type(s) of Application	n 申請類別			
(A) Temporary Use/Development of Land and/or Building Not Exceeding 3 Years in Rural Areas or Regulated Areas 位於鄉郊地區或受規管地區土地上及/或建築物內進行為期不超過三年的臨時用途/發展 (For Renewal of Permission for Temporary Use or Development in Rural Areas or Regulated Areas, please proceed to Part (B)) (如屬位於鄉郊地區或受規管地區臨時用途/發展的規劃許可續期,請填寫(B)部分)				
(a) Proposed use(s)/development 擬議用途/發展	臨時物流中心 Temporary Logistics Centre (Please illustrate the details of the propo	sal on a layout plan) (請用平面圖說明擬議詳情)		
(b) Effective period of permission applied for 申請的許可有效期	♥ year(s) 年 □ month(s) 個月	3		
(c) Development Schedule 發展網	<u>出節表</u>			
Proposed uncovered land area	· 擬議露天土地面積	1,502sq.m ☑About 約		
Proposed covered land area 携	A A B B B B B B B B B B B B B B B B B B	4,798sq.m ☑About 約		
·	s/structures 擬議建築物/構築物數目	4		
Proposed domestic floor area		N/A sq.m □About 約		
_		4,856 sq.m ☑About 終		
Proposed non-domestic floor		4,856 sq.m ☑About 紛		
Proposed height and use(s) of different floors of buildings/structures (if applicable) 建築物/構築物的擬議高度及不同樓層的擬議用途 (如適用) (Please use separate sheets if the space below is insufficient) (如以下空間不足,請另頁說明)				
構築物B2,用途:辦公室,上 構築物B3,用途:洗手間,上	蓋面積:約42平方米,髙度不多於6 蓋面積:約16平方米,髙度不多於3	多於14米,一層高,總樓面面積:約4,530平方米 米,兩層高,總樓面面積:約84平方米 米,一層高,總樓面面積:約16平方米 ※3米,一層高,總樓面面積:約16方米		
Proposed number of car parking s	spaces by types 不同種類停車位的携			
Private Car Parking Spaces 私家	車車位	0		
Motorcycle Parking Spaces 電單		0		
Light Goods Vehicle Parking Spa		0		
Medium Goods Vehicle Parking Heavy Goods Vehicle Parking Sp	•	0		
Others (Please Specify) 其他 (訂		N/A		
	47 4 7 4 7 4 7			
Proposed number of loading/unlo	ading spaces 上落客貨車位的擬議數	· ————————————————————————————————————		
Taxi Spaces 的士車位		0		
Coach Spaces 旅遊巴車位		0		
Light Goods Vehicle Spaces 輕型		0		
Medium Goods Vehicle Spaces	<u> </u>			
Heavy Goods Vehicle Spaces 重型貨車車位 0				
Others (Please Specify) 其他 (請列明) 8個貨櫃車上落貨位 8個貨櫃車上落貨位				

Pr 濫	oposed operating hours 運時間為星期一至星	擬議營進 期六上午	時間 8時至下	午6時,星月	明日及公眾假」	胡休息		
	***********************			• • • • • • • • • • • • • • • • • • • •				***************************************
(d)) Any vehicular acc the site/subject buil 是否有車路通往 有關建築物?	cess to ding?	Yes 是 No 否	appro 有一個 從沙頭角 There	priate) 条現有車路。(龍躍頭段經一 is a proposed a	請註明車路 條小路進入 ccess. (pleas	名稱(如適用))	the street name, where an and specify the width) 路的闊度)
(e)	(If necessary, please justifications/reason 措施,否則請提供	use separa s for not p	nte sheets roviding	to indicate	the proposed m	easures to m 話,請另頁	inimise possible 註明可盡量減	adverse impacts or give 少可能出現不良影響的
(ii)	Does the development proposal involve alteration of existing building? 擬議發展計劃是否包括現有建築物的改動? Does the development proposal involve the operation on the right? 擬議發展是否涉及右列的工程?	Yes 是 No 否 Yes 是	(P) div (簡和	ease indicate of ersion, the external management of procession of procession of procession of the procession of except of except of the procession of except of the procession of except of e	on site plan the bent of filling of land 顯示有關土地/河 of stream 河道 ond 填塘 ing 填塘面積 ling 填土面積 ling 填土 面積 ling 填土 下度 of land 挖土 avation 挖土面	oundary of con l/pond(s) and/or 也塘界線,以及 收道	excavation of land 河道改道、填塘、 sq.m 平方 sq.m 平方 sq.m 平方	s), and particulars of stream) 真土及/或挖土的細節及/或 ※ □ About 約 ※ □ About 約 ※ □ About 約
(iii)	Would the development proposal cause any adverse impacts? 擬議發展計劃會否造成不良影響?	Landscap Tree Felli Visual Im	: 對交通 supply ige 對排 ige 對斜坡 by slopes e Impact ng 砍你 pact 構	i 對供水 水 s 受斜坡影 構成景觀	杉響		Yes 會	No No 不不不不不不不不不不不不不不不不不不不不不不不不不不不不不不不不不

diamet 請註明 幹直径 (B) Renewal of Permission fo	state measure(s) to minimise the impact(s). For tree felling, please state the number, er at breast height and species of the affected trees (if possible) 盡量減少影響的措施。如涉及砍伐樹木,請說明受影響樹木的數目、及胸高度的樹及品種(倘可) Temporary Use or Development in Rural Areas or Regulated Areas 區臨時用途/發展的許可續期
(a) Application number to which the permission relates	A//
與許可有關的申請編號	
(b) Date of approval 獲批給許可的日期	(DD 日/MM 月/YYYY 年)
(c) Date of expiry 許可屆滿日期	(DD 日/MM 月/YYYY 年)
(d) Approved use/development 已批給許可的用途/發展	
(e) Approval conditions 附帶條件	The permission does not have any approval condition 許可並沒有任何附帶條件 Applicant has complied with all the approval conditions 申請人已履行全部附帶條件 Applicant has not yet complied with the following approval condition(s): 申請人仍未履行下列附帶條件: Reason(s) for non-compliance: 仍未履行的原因: (Please use separate sheets if the space above is insufficient) (如以上空間不足,請另頁說明)
(f) Renewal period sought 要求的續期期間	□ year(s) 年 □ month(s) 個月

7. Justifications 理由
The applicant is invited to provide justifications in support of the application. Use separate sheets if necessary. 現請申請人提供申請理由及支持其申請的資料。如有需要,請另頁說明)。
請參考附件申請報告書
,,,,,,,,,,,,,,,,,,,,,,,,,,,,,,,,,,,,,,,
,

,

8. Declaration 聲明	
I hereby declare that the particulars given in this application are 本人謹此聲明,本人就這宗申請提交的資料,據本人所知及	correct and true to the best of my knowledge and belief. 所信,均屬真實無誤。
I hereby grant a permission to the Board to copy all the materials to the Board's website for browsing and downloading by the pub本人現准許委員會酌情將本人就此申請所提交。	submitted in this application and/or to upload such materials
簽署	□ Applicant 申請人 / ☑ Authorised Agent 獲授權代理人
Jacky Wong	Manager
Name in Block Letters 姓名(請以正楷填寫)	Position (if applicable) 職位 (如適用)
Professional Qualification(s) 專業資格 □ HKIP 香港規劃師學會 □ HKIS 香港測量師學會 □ HKILA 香港園境師學會 □ RPP 註冊專業規劃師 Others 其他	of 資深會員 / □ HKIA 香港建築師學會 / □ HKIE 香港工程師學會 /
on behalf of 代表 領嶠物業顧問有限公司Top Planning Property	y Consultants Limited
☑ Company 公司 / ☐ Organisation Name and O	Chop (if applicable) 機構名稱及蓋章(如適用)
Date 日期 31/07/2024	DD/MM/YYYY 日/月/年)

Remark 備註

The materials submitted in this application and the Board's decision on the application would be disclosed to the public. Such materials would also be uploaded to the Board's website for browsing and free downloading by the public where the Board considers appropriate.

委員會會向公眾披露申請人所遞交的申請資料和委員會對申請所作的決定。在委員會認為合適的情況下,有關申請資料亦會上載至委員會網頁供公眾免費瀏覽及下載。

Warning 警告

Any person who knowingly or wilfully makes any statement or furnish any information in connection with this application, which is false in any material particular, shall be liable to an offence under the Crimes Ordinance. 任何人在明知或故意的情況下,就這宗申請提出在任何要項上是虛假的陳述或資料,即屬違反《刑事罪行條例》。

Statement on Personal Data 個人資料的聲明

1. The personal data submitted to the Board in this application will be used by the Secretary of the Board and Government departments for the following purposes:

委員會就這宗申請所收到的個人資料會交給委員會秘書及政府部門,以根據《城市規劃條例》及相關的城市規劃委員會規劃指引的規定作以下用途:

(a) the processing of this application which includes making available the name of the applicant for public inspection when making available this application for public inspection; and 處理這宗申請,包括公布這宗申請供公眾查閱,同時公布申請人的姓名供公眾查閱;以及

(b) facilitating communication between the applicant and the Secretary of the Board/Government departments. 方便申請人與委員會秘書及政府部門之間進行聯絡。

- 2. The personal data provided by the applicant in this application may also be disclosed to other persons for the purposes mentioned in paragraph 1 above. 申請人就這宗申請提供的個人資料,或亦會向其他人士披露,以作上述第 1 段提及的用途。
- 3. An applicant has a right of access and correction with respect to his/her personal data as provided under the Personal Data (Privacy) Ordinance (Cap. 486). Request for personal data access and correction should be addressed to the Secretary of the Board at 15/F, North Point Government Offices, 333 Java Road, North Point, Hong Kong. 根據《個人資料(私隱)條例》(第 486 章)的規定,申請人有權查閱及更正其個人資料。如欲查閱及更正個人資料,應向委員會秘書提出有關要求,其地址為香港北角渣華道 333 號北角政府合署 15 樓。

Gist of Application 申請摘要
(Please provide details in both English and Chinese as far as possible. This part will be circulated to relevant consultees, uploaded to the Town Planning Board's Website for browsing and free downloading by the public and
available at the Planning Enquiry Counters of the Planning Department for general information.)
(請盡量以英文及中文填寫。此部分將會發送予相關諮詢人士、上載至城市規劃委員會網頁供公眾免費瀏覽及
下載及於規劃署規劃資料查詢處供一般參閱。)

下 以 及 於 稅 對 者 稅 !	副員科宣問處民一放多園。)
Application No. 申請編號	(For Official Use Only) (請勿填寫此欄)
Location/address 位置/地址	新界粉嶺軍地丈量約份第83約地段第456號餘段、第459號、第460號、第461號、第462號及第2229號餘段 Lots 456 RP, 459, 460, 461, 462 and 2229 RP in D.D. 83, Kwan Tei, Fanling, NewTerritories
Site area 地盤面積	6,300 sq.m 平方米 ☑ About 約
产也,强田,有	(includes Government land of包括政府土地 N / A sq. m 平方米 □ About 約)
Plan 圖則	坪輋及打鼓嶺分區計劃大綱核准圖編號 S/NE-TKL/14 Approved Ping Che and Ta Kwu Ling Outline Zoning Plan No. S/NE-TKL/14
Zoning 地帶	露天貯物及農業 Open Storage and Agriculture
Type of Application 申請類別	▼ Temporary Use/Development in Rural Areas or Regulated Areas for a Period of 位於鄉郊地區或受規管地區的臨時用途/發展為期 □ Year(s) 年3 □ Month(s) 月
	□ Renewal of Planning Approval for Temporary Use/Development in Rural Areas or Regulated Areas for a Period of 位於鄉郊地區或受規管地區臨時用途/發展的規劃許可續期為期
	□ Year(s) 年 □ Month(s) 月
Applied use/ development 申請用途/發展	臨時物流中心 Temporary Logistics Centre

(i)	Gross floor area		sq.m	1 平方米	Plot R	latio 地積比率
	and/or plot ratio 總樓面面積及/或 地積比率	Domestic 住用	N/A	□ About 約 □ Not more than 不多於	N/A	□About 約 □Not more than 不多於
		Non-domestic 非住用	4,856	☑ About 約 □ Not more than 不多於	0.77	☑About 約 □Not more than 不多於
(ii)	No. of blocks 幢數	Domestic 住用	•	N/A		
		Non-domestic 非住用	- 1	4		
(iii)	Building height/No. of storeys 建築物高度/層數	Domestic 住用		N/A	□ (Not	m 米 more than 不多於)
				N/A	□ (Not	Storeys(s) 層 more than 不多於)
		Non-domestic 非住用		14	☑ (Not	m 米 more than 不多於)
				2	☑ (Not	Storeys(s) 層 more than 不多於)
(iv)	Site coverage 上蓋面積			76	%	☑ About 約
(v)	No. of parking spaces and loading / unloading spaces 停車位及上落客貨車位數目	Medium Goods V	ng Spaces 私家ng Spaces 電單icle Parking Specify Parking Spaces 管理 (and the parking Space) 其他 (语 中	E車車位 D車車位 Daces 輕型貨車泊車 Spaces 中型貨車泊車 paces 重型貨車泊車 請列明) Disconsideration D	車位	0 0 0 0 0 0 0 N/A 8 0 0 0 0 0 0 0 0 8 0 0 0 0 0 0 0 0 0

	<u>Chinese</u> 中文	English 英文
Plans and Drawings 圖則及繪圖		_/
Master layout plan(s)/Layout plan(s) 總綱發展藍圖/布局設計圖		☒
Block plan(s) 樓宇位置圖 Floor plan(s) 樓宇平面圖		
Floor plan(s) 楔子中山圓 Specience plan(s) 松叶原		
Sectional plan(s) 截視圖 Elevation(s) 立視圖		₽
Photomontage(s) showing the proposed development 顯示擬議發展的合成照片		
Master landscape plan(s)/Landscape plan(s) 園境設計總圖/園境設計圖 Others (please specify) 其他(請註明)	<u> </u>	
Land status plan, Location and access plan	لسة	! M
Reports 報告書		
Reports 報告者 Planning Statement/Justifications 規劃綱領/理據	oxdet	- 1
Environmental assessment (noise, air and/or water pollutions)	<u> </u>	
環境評估(噪音、空氣及/或水的污染)	L	Ļ
Traffic impact assessment (on vehicles) 就車輛的交通影響評估	П	
Traffic impact assessment (on pedestrians) 就行人的交通影響評估		
Visual impact assessment 視覺影響評估	i i	
Landscape impact assessment 景觀影響評估		
Tree Survey 樹木調查		
Geotechnical impact assessment 土力影響評估		
Drainage impact assessment 排水影響評估		
Sewerage impact assessment 排污影響評估		
Risk Assessment 風險評估	<u> </u>	
Others (please specify) 其他(請註明) 行政摘要,申請報告書		

Note: The information in the Gist of Application above is provided by the applicant for easy reference of the general public. Under no circumstances will the Town Planning Board accept any liabilities for the use of the information nor any inaccuracies or discrepancies of the information provided. In case of doubt, reference should always be made to the submission of the applicant. 注: 上述申請摘要的資料是由申請人提供以方便市民大眾參考。對於所載資料在使用上的問題及文義上的歧異,城市規劃委員會概不負責。若有任何疑問,應查閱申請人提交的文件。

行政摘要

根據《城市規劃條例》(第131章)第16條遞交的許可申請擬議在

新界粉嶺軍地丈量約份第 83 約地段第 456 號餘段、第 459 號、第 460 號、第 461 號、第 462 號及第 2229 號餘段

作擬議臨時物流中心(為期3年)

- 1. 本擬議申請臨時物流中心(為期3年),座落於坪輋及打鼓嶺分區計劃大綱 核准圖編號 S/NE-TKL/14上的約 97%「露天貯物」及約 3%「農業」地 帶。根據該大綱圖的註釋,「物流中心」需不屬於「露天貯物」及「農 業」地帶內的第一或二欄用途,然而不超過三年土地或建築物的臨時用途 或發展,須先向城規會提出申請。
- 2. 本擬議發展的地盤面積為約6,300平方米,當中不涉及政府土地,總樓面面 積為約4,856平方米,分別為4個樓高一層(高度不超過14米)的物流中心、辦 公室、洗手間、消防泵房,並有遮雨篷,現時申請範圍土地為石屎地因此 並不涉及填土工程。申請地點不設訪客停車位,但設有8個貨櫃車上落貨車 位。擬議發展的營運時間為星期一至六早上8時至下午6時(星期日及公眾假 期休息)。
- 3. 規劃申請理據如下:
 - 3.1 本擬議發展為臨時性質,因此不會影響申請地點用途長遠規劃的發展;
 - 3.2 本擬議發展約 97%土地屬規劃指引編號13G的「第一類地區」,而物流中心屬於露天貯物和港口後勤用途的發展;
 - 3.3 本擬議發展與周邊十地用途及性質兼容;
 - 3.4 本擬議發展不會對附近地方構成不良的交通、環境及排水影響;
 - 3.5 本擬議發展涉及先前一個獲批的申請:A/NE-TKL/708,本次申請與 A/NE-TKL/708的所有內容一樣,申請人一直嚴格履行相關附帶條件, 因為排水建議正按部門意見作出修改及需要待地政署批出短期轄免書 方可落實消防裝置,所以未能如期履行附帶條件,需要再次提交規劃 許可申請,而本次申請會一併提交已獲批准的消防裝置建議及已修訂的排水建議;
- 4. 根據以上各點,申請人懇請城市規劃委員會寬大批准新界粉嶺軍地丈量約份第83約地段第456號餘段、第459號、第460號、第461號、第462號 及第2229號餘段作擬議臨時物流中心(為期3年)。

申請報告書

1. 背景

- 1.1 本擬議申請地點位於新界粉嶺軍地丈量約份第83約地段第456號餘段、 第459號、第460號、第461號、第462號及第2229號餘段,現根據城市規 劃條例第16條在上述地點向城市規劃委員會作出規劃許可申請擬議臨時 物流中心(為期3年)。
- 1.2 本擬議臨時物流中心主要是配合規劃用途作相關的露天貯物和港口後勤用途的發展。

2. 擬議發展細節

2.1 本擬議發展的地盤面積為約 6,300 平方米,當中不涉及政府土地(申請人在第一次獲批規劃許可申請編號: A/NE-TKL/708 時已向地政署作短期豁免書申請),總樓面面積為約 4,856 平方米,全部為樓高一層(高度不超過 14 米)的構築物,上蓋面積為 76%,地積比率為 77%,是次申請地點土地現為石屎地,不涉及填土工程。整個範圍內分別為 4 個樓高一層(高度不超過 14 米)的物流中心、辦公室、洗手間、消防泵房,並有遮雨篷。申請地點不設訪客停車位,但設有 8 個貨櫃車上落貨車位。擬議發展的營運時間為星期一至六早上 8 時至下午 6 時(星期日及公眾假期休息),場內的工作人他們只會在營業時間內工作。

構築物列	表			
構築物	用途	上蓋面積	總樓面面積	高度
B1	物流中心	約 4,530 平方米	約 4,530 平方米	不多於 14 米(1 層高)
B2	辦公室	約42平方米	約84平方米	不多於 6 米(2 層高)
В3	洗手間	約 16 平方米	約16平方米	不多於 3 米(1 層高)
B4	消防泵房	約 16 平方米 在遮雨篷之下	約16平方米	不多於 3 米(1 層高)
遮雨篷	/	約 210 平方米	約 210 平方米	/

2.2 本擬議申請地點可從沙頭角龍躍頭段經由小路前往,申請場內出入閘口濶度為約24米(位於西面),不設有訪客車位,由於是作為物流中心,因此設有8個貨櫃車上落貨車位(面積為3.5米 x 16米)作上落貨之用,全部進出時間皆為預約制。申請場內有足夠空間作迴旋轉動(直徑14米的迴旋圈),因此貨櫃車不需以倒車方式進出,對附近道路不會造成安全影響。

貨櫃車車輛流量預算							
星期一至六早上8時至下午6時							
時間	入	出	每小時車輛入出次數				
08:00-09:00	1	0	1				
09:00-10:00	1	0	1				
10:00-11:00	1	1	2				
11:00-12:00	2	2	4				
12:00-13:00	0	1	1				
13:00-14:00	1	0	1				
14:00-15:00	1	1	2				
15:00-16:00	1	2	3				
16:00-17:00	0	1	1				
17:00-18:00	0	0	0				
合計	8	8	16				

2.3 申請人承諾在同一時段內不會有8輛貨櫃車同時進出申請地點,由於是預約制,每次最多都只是2輛貨櫃車進出,不會影響附近道路交通。如申請獲批准,申請人會在營業時間內,聘請專人負責管理申請地點的出人口車輛流量管制,每次有車輛要進人申請地點時,都需預先30分鐘通知該職員,等職員視察現場後,確保申請地點內有空置車位,才通知司機可以在指定時間內進入申請地點,而該職員亦會站在申請地點的出入口協調車輛出入,指揮交通,確保不會有車輛排隊阻塞出人口或周邊地方。同時亦會在營業時間內,聘請一名交通指揮員負責管理申請地點出入口交通,並會在申請地點出入口安裝感應警報器。每當有車輛靠近申請地點出入口時,警報器會發出聲響,提醒周邊行人這裡將有車輛出入,令他們注意路面交通;同一時間,交通指揮員亦會在申請地點門口指揮交通,並向行人發出手號及指示牌,確保行人在得到正確的指示才過馬路,確保周邊行人的安全。

3. 規劃背景


- 3.1 本擬議申請座落於坪輋及打鼓嶺分區計劃大綱核准圖編號 S/NE-TKL/14 上的的約 97%「露天貯物」及約 3%「農業」地帶。根據該大綱圖的 註釋,「物流中心」需不屬於「露天貯物」及「農業」地帶內的第一 或二欄用途,然而不超過三年土地或建築物的臨時用途或發展,須先 向城規會提出申請。
- 3.2 本擬議發展涉及先前一個獲批的申請:A/NE-TKL/708。
- 3.3 本擬議發展約 97%屬規劃指引編號13G的「第一類地區」,屬於露天貯物和港口後勤用途的發展。


4. 規劃申請理據


- 4.1 本擬議發展為臨時性質,因此不會影響申請地點用途長遠規劃的發展;
- 4.2 本擬議發展約 97%土地屬規劃指引編號13G的「第一類地區」,而物流中心屬於露天貯物和港口後勤用途的發展;
- 4.3 本擬議發展與周邊十地用途及性質兼容;
- 4.4 本擬議發展不會對附折地方構成不良的交通、環境及排水影響;
- 4.5 本擬議發展涉及先前一個獲批的申請:A/NE-TKL/708,本次申請與 A/NE-TKL/708的所有內容一樣,申請人一直嚴格履行相關附帶條件, 因為排水建議正按部門意見作出修改及需要待地政署批出短期轄免書 方可落實消防裝置,所以未能如期履行附帶條件,需要再次提交規劃 許可申請,而本次申請會一併提交已獲批准的消防裝置建議及已修訂的排水建議;

5. 總結

- 5.1 本擬議發展為臨時性質,只是作為物流中心,而本次申請與上次獲批的A/NE-TKL/708的所有內容一樣,用途符合規劃意向,與周邊土地用途及環境兼容,不會對生態、環境、空氣及噪音帶來負面影響。申請人一直嚴格履行相關附帶條件,因為排水建議正按部門意見作出修改及需要待地政署批出短期轄免書方可落實消防裝置,所以未能如期履行附帶條件,需要再次提交規劃許可申請,而本次申請會一併提交已獲批准的消防裝置建議及修訂的排水建議,申請人承諾必定會在本次規劃許可申請期內完成一切相關附帶條件。同時有關臨時構築物亦已向地政署申請短期豁免書。
- 5.2 根據以上各點,申請人懇請城市規劃委員會寬大批准新界粉嶺軍地丈量約份第83約地段第456號餘段、第459號、第460號、第461號、第462號及第2229號餘段作擬議臨時物流中心(為期3年)

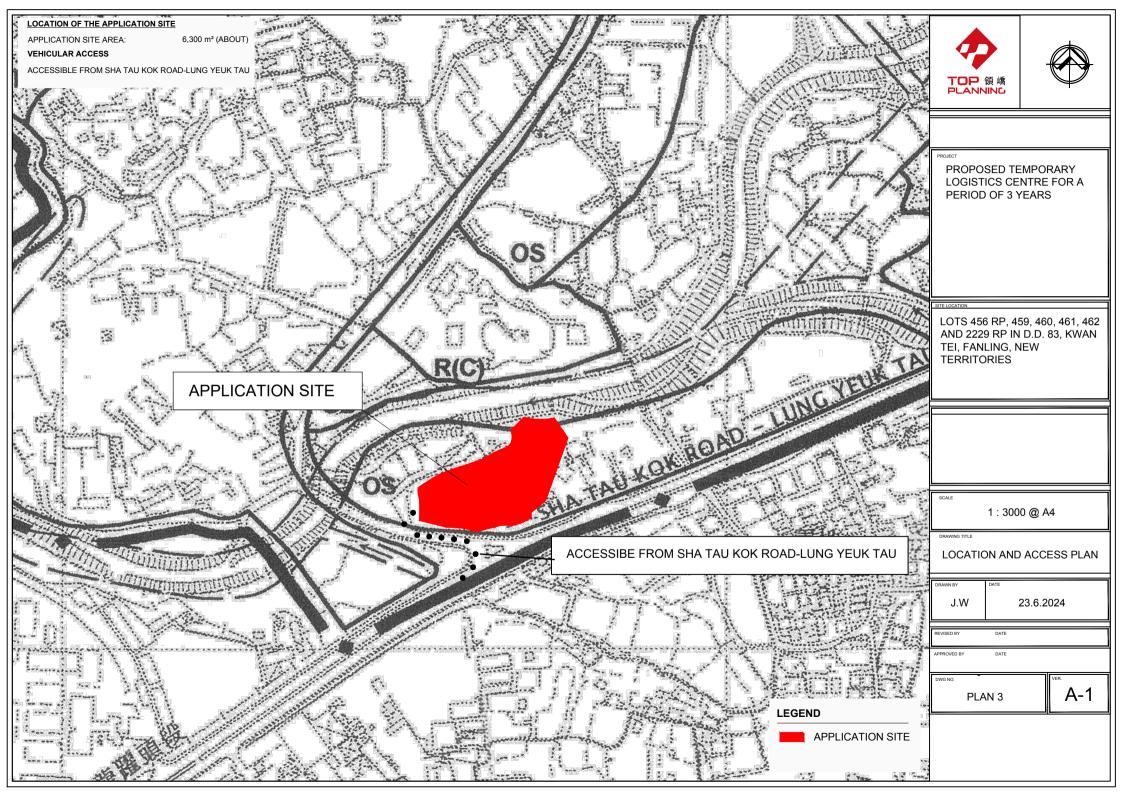

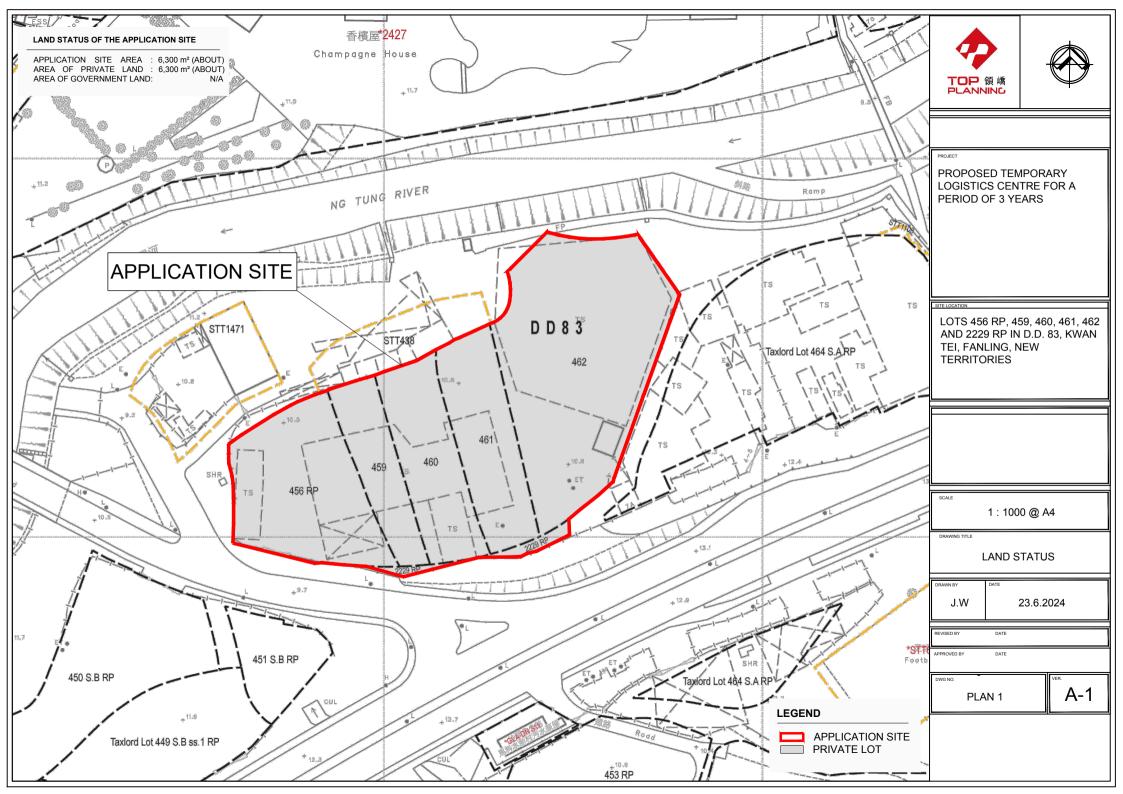

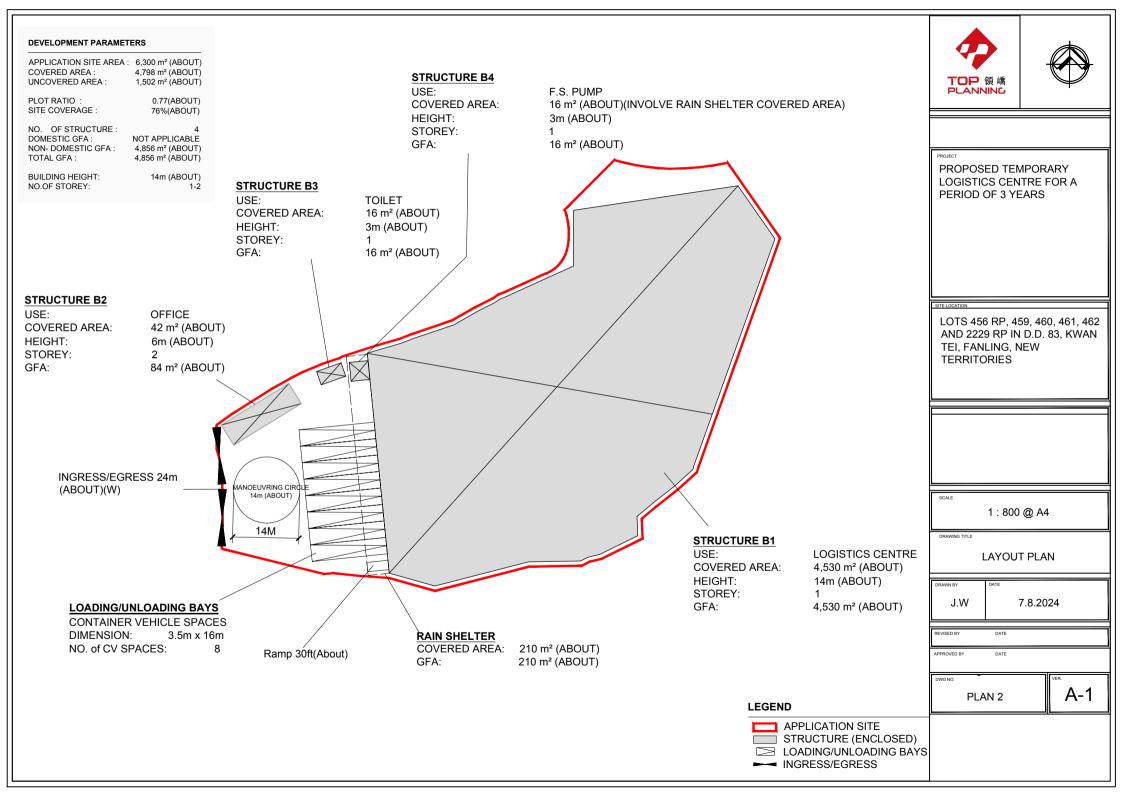

F.S.NOTES:

1. GENERAL

- 1.1 FIRE SERVICE INSTALLATIONS SHALL BE PROVIDED IN ACCORDANCE WITH THE CODES OF PRACTICE FOR MINIMUM FIRE SERVICE INSTALLATIONS AND EQUIPMENT AND INSPECTION, TESTING AND MAINTENANCE OF INSTALLATIONS AND EQUIPMENT 2022 (COP 2022), FSD CIRCULAR LETTERS AND THE HONG KONG WATERWORKS STANDARD REQUIREMENTS.
- 1.2 ALL TUBES AND FITTINGS SHALL BE G.M.S. TO BS1387 MEDIUM GRADE WHERE PIPEWORK UP TO Ø150mm.
- 1.3 ALL TUBES AND FITTINGS SHALL BE DUCTILE IRON TO BS EN545 K12 WHERE PIPEWORK ABOVE Ø150mm.
- 1.4 ALL DRAIN PIPES SHALL BE DISCHARGED TO A CONSPICUOUS POSITION WITHOUT THE POSSIBILITY OF BEING SUBMERGED.
- 1.5 ALL PUDDLE FLANGES SHALL BE MADE OF DUCTILE IRON
- 1.6 THE AGGREGATE AREA OF OPENABLE WINDOWS NOT LESS THAN 6.25% OF THE FLOOR AREA OF THE STRUCTURE
- 1.7 SMOKE EXTRACTION SYSTEM NOT TO BE PROVIDED.

2. HOSE REEL SYSTEM

- 2.1 NEW FIRE HOSE REEL SHALL BE PROVIDED AS INDICATED ON PLAN TO ENSURE THAT EVERY PART OF THE BUILDING CAN BE REACHED BY A LENGTH OF NOT MORE THAN 30m HOSE REEL TUBING.
- 2.2 THE WATER SUPPLY FOR HOSE REEL SYSTEM WILL BE FED FROM A NEW 2m³ F.S. FIBREGLASS WATER TANK VIA TWO HOSE REEL PUMPS (DUTY/ STANDBY) LOCATED INSIDE FS PUMP ROOM AT EXTERNAL AREA.
- 2.3 HOSE REEL PUMPS SHALL BE STARTED BY ACTUATION OF ANY BREAKGLASS UNIT FITTED ASIDE EACH HOSE REEL SETS
- 2.4 ALL FIRE HOSE REEL OUTLETS SHOULD BE HOUSED IN GLASS FRONTED CABINET SECURED UNDER LOCK & KEY.
- 2.5 ALL FIRE HOSE REEL SHOULD BE PROVIDED WITH FSD APPROVED TYPE INSTRUCTION PLATE & WSD WARNING PLATE
- 2.6 SECONDARY ELECTRICITY SUPPLY DIRECTLY TEE OFF BEFORE CLP'S INCOMING MAIN SWITCH SHALL BE PROVIDED FOR THE FS PUMPS.

3. AUTOMATIC SPRINKLER SYSTEM

- 3.1 NEW AUTOMATIC SPRINKLER SYSTEM SHALL BE PROVIDED AND INSTALLED IN ACCORDANCE WITH LPC RULES FOR AUTOMATIC SPRINKLER INSTALLATIONS INCORPORATING BS EN 12845: 2015 (INCLUDING TECHNICAL BULLETINS, NOTES, COMMENTARY AND RECOMMENDATIONS) AND FSD CIRCULAR LETTER NO. 5/2020. THE CLASSIFICATION OF THE OCCUPANCIES WILL BE ORDINARY HAZARD GROUP III.
- 3.2 ONE NEW 135m3 SPRINKLER WATER TANK WILL BE PROVIDED AS INDICATED ON PLAN. THE TOWN MAIN WATER SUPPLY WILL BE FED FROM SINGLE END.
- 3.3 TWO NEW SPRINKLER PUMPS (DUTY/STANDBY) AND ONE JOCKEY PUMP SHALL BE PROVIDED IN FS PUMP ROOM LOCATED AT EXTERNAL AREA.
- 3.4 NEW SPRINKLER CONTROL VALVE SET AND SPRINKLER INLET SHALL BE PROVIDED AS INDICATED ON PLAN.
- 3.5 ALL SUBSIDIARY STOP VALVES TO BE ELECTRIC MONITORING TYPE.
- 3.6 SECONDARY ELECTRICITY SUPPLY DIRECTLY TEE OFF BEFORE CLP'S INCOMING MAIN SWITCH SHALL BE PROVIDED FOR THE SPRINKLER PUMPS.
- 3.7 THE SPRINKLER SYSTEM DESIGN IS BASED ON THE FOLLOWINGS: HAZARD CLASS : ORDINARY HAZARD GROUP III TYPE OF STORAGE: POST-PALLET (ST2) STORAGE CATEGORY: CATEGORY II MAXIMUM STORAGE HEIGHT: 3.5m SPRINKLER PROTECTION: CEILING PROTECTION ONLY

4. FIRE ALARM SYSTEM

- 4.1 NEW FIRE ALARM SYSTEM SHALL BE PROVIDED IN ACCORDANCE WITH BS 5839-1:2017 AND FSD CIRCULAR LETTERS NO. 6/2021.
- 4.2 NEW BREAKGLASS UNITS AND FIRE ALARM BELLS SHALL BE PROVIDED AT ALL NEW FIRE HOSE REEL POINTS. THE FIRE ALARM INTALLATION WILL BE INTEGRATED WITH THE HOSE REEL SYSTEM.

5. EMERGENCY LIGHTING

5.1 EMERGENCY LIGHTING SHALL BE PROVIDED IN ACCORDANCE WITH 'BS 5266-1:2016 AND BS EN 1838:2013", AND FSD CIRCULAR LETTERS NO. 4/2021. COVERING ALL AREA. EMERGENCY LIGHTINGS SHALL BE BACKED UP BY BUILT-IN BATTERY AND CAPABLE OF MAINTAINING FUNCTION OF NOT LESS THAN 2 HOURS IN CASE OF POWER FAILURE

6. EXIT SIGN


FOR THE BUILDING. EXIT SIGNS/DIRECTIONAL EXIT SIGNS SHALL BE BACKED UP BY BUILT-IN BATTERY AND CAPABLE OF MAINTAINING FUNCTION OF NOT LESS THAN 2 HOURS IN CASE OF POWER FAILURE.

7. PORTABLE APPLIANCES

7.1 PORTABLE HAND OPERATED APPLIANCES SHALL BE PROVIDED AS INDICATED ON PLAN.

LEGEND



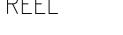

BREAK GLASS UNIT

FIRE ALARM BELL



NON-RETURN VALVE

EMERGENCY LIGHT



REV

SUBSIDIARY VALVE / FLOW SWITCH

SPRINKLER CONTROL VALVE SET GATE VALVE

GATE TYPE (With MONITORING)


ARCHITECT :

DATE

8 loading / unloading

spaces of 16m x 3.5m

for container vehicles

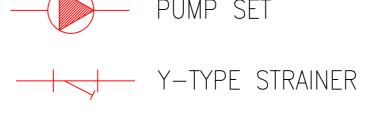

Ramp 30ft(About)

SPRINKLER INLET

SPRINKLER HEAD (ON PLAN)

PRESSURE GAUGE

5KG DRY POWDER FIRE EXTINGUISHER

PROJECT

Proposed Temporary Logistics Centre for a Period of 3 Years at Lots 456R.P., 459, 460, 461, 462 and 2229R. P. in D.D. 83, Kwan Tei, Fanling, N.T.

DRAWING TITLE : F.S. Notes, Legend, Fire Service Installation Layout Plan

DESCRIPTION

FIRE SERVICE CONTRACTOR : CONSULTANT **Century Fire Service**

Rain Shelter 210m²(About)


Engineering Co., Ltd.

DRAWING NO DATE **FS-01** C.K.NG 24 JUN 2024 DRAWN BY SCALE : 1:250 (A0) CHECKED BY SOURCE: B.O.O. Ref. BD APPROVED BY F.S.D. Ref. FP

GFA: 4,530m²(About)

Height: 14m(About)

No of storey: 1

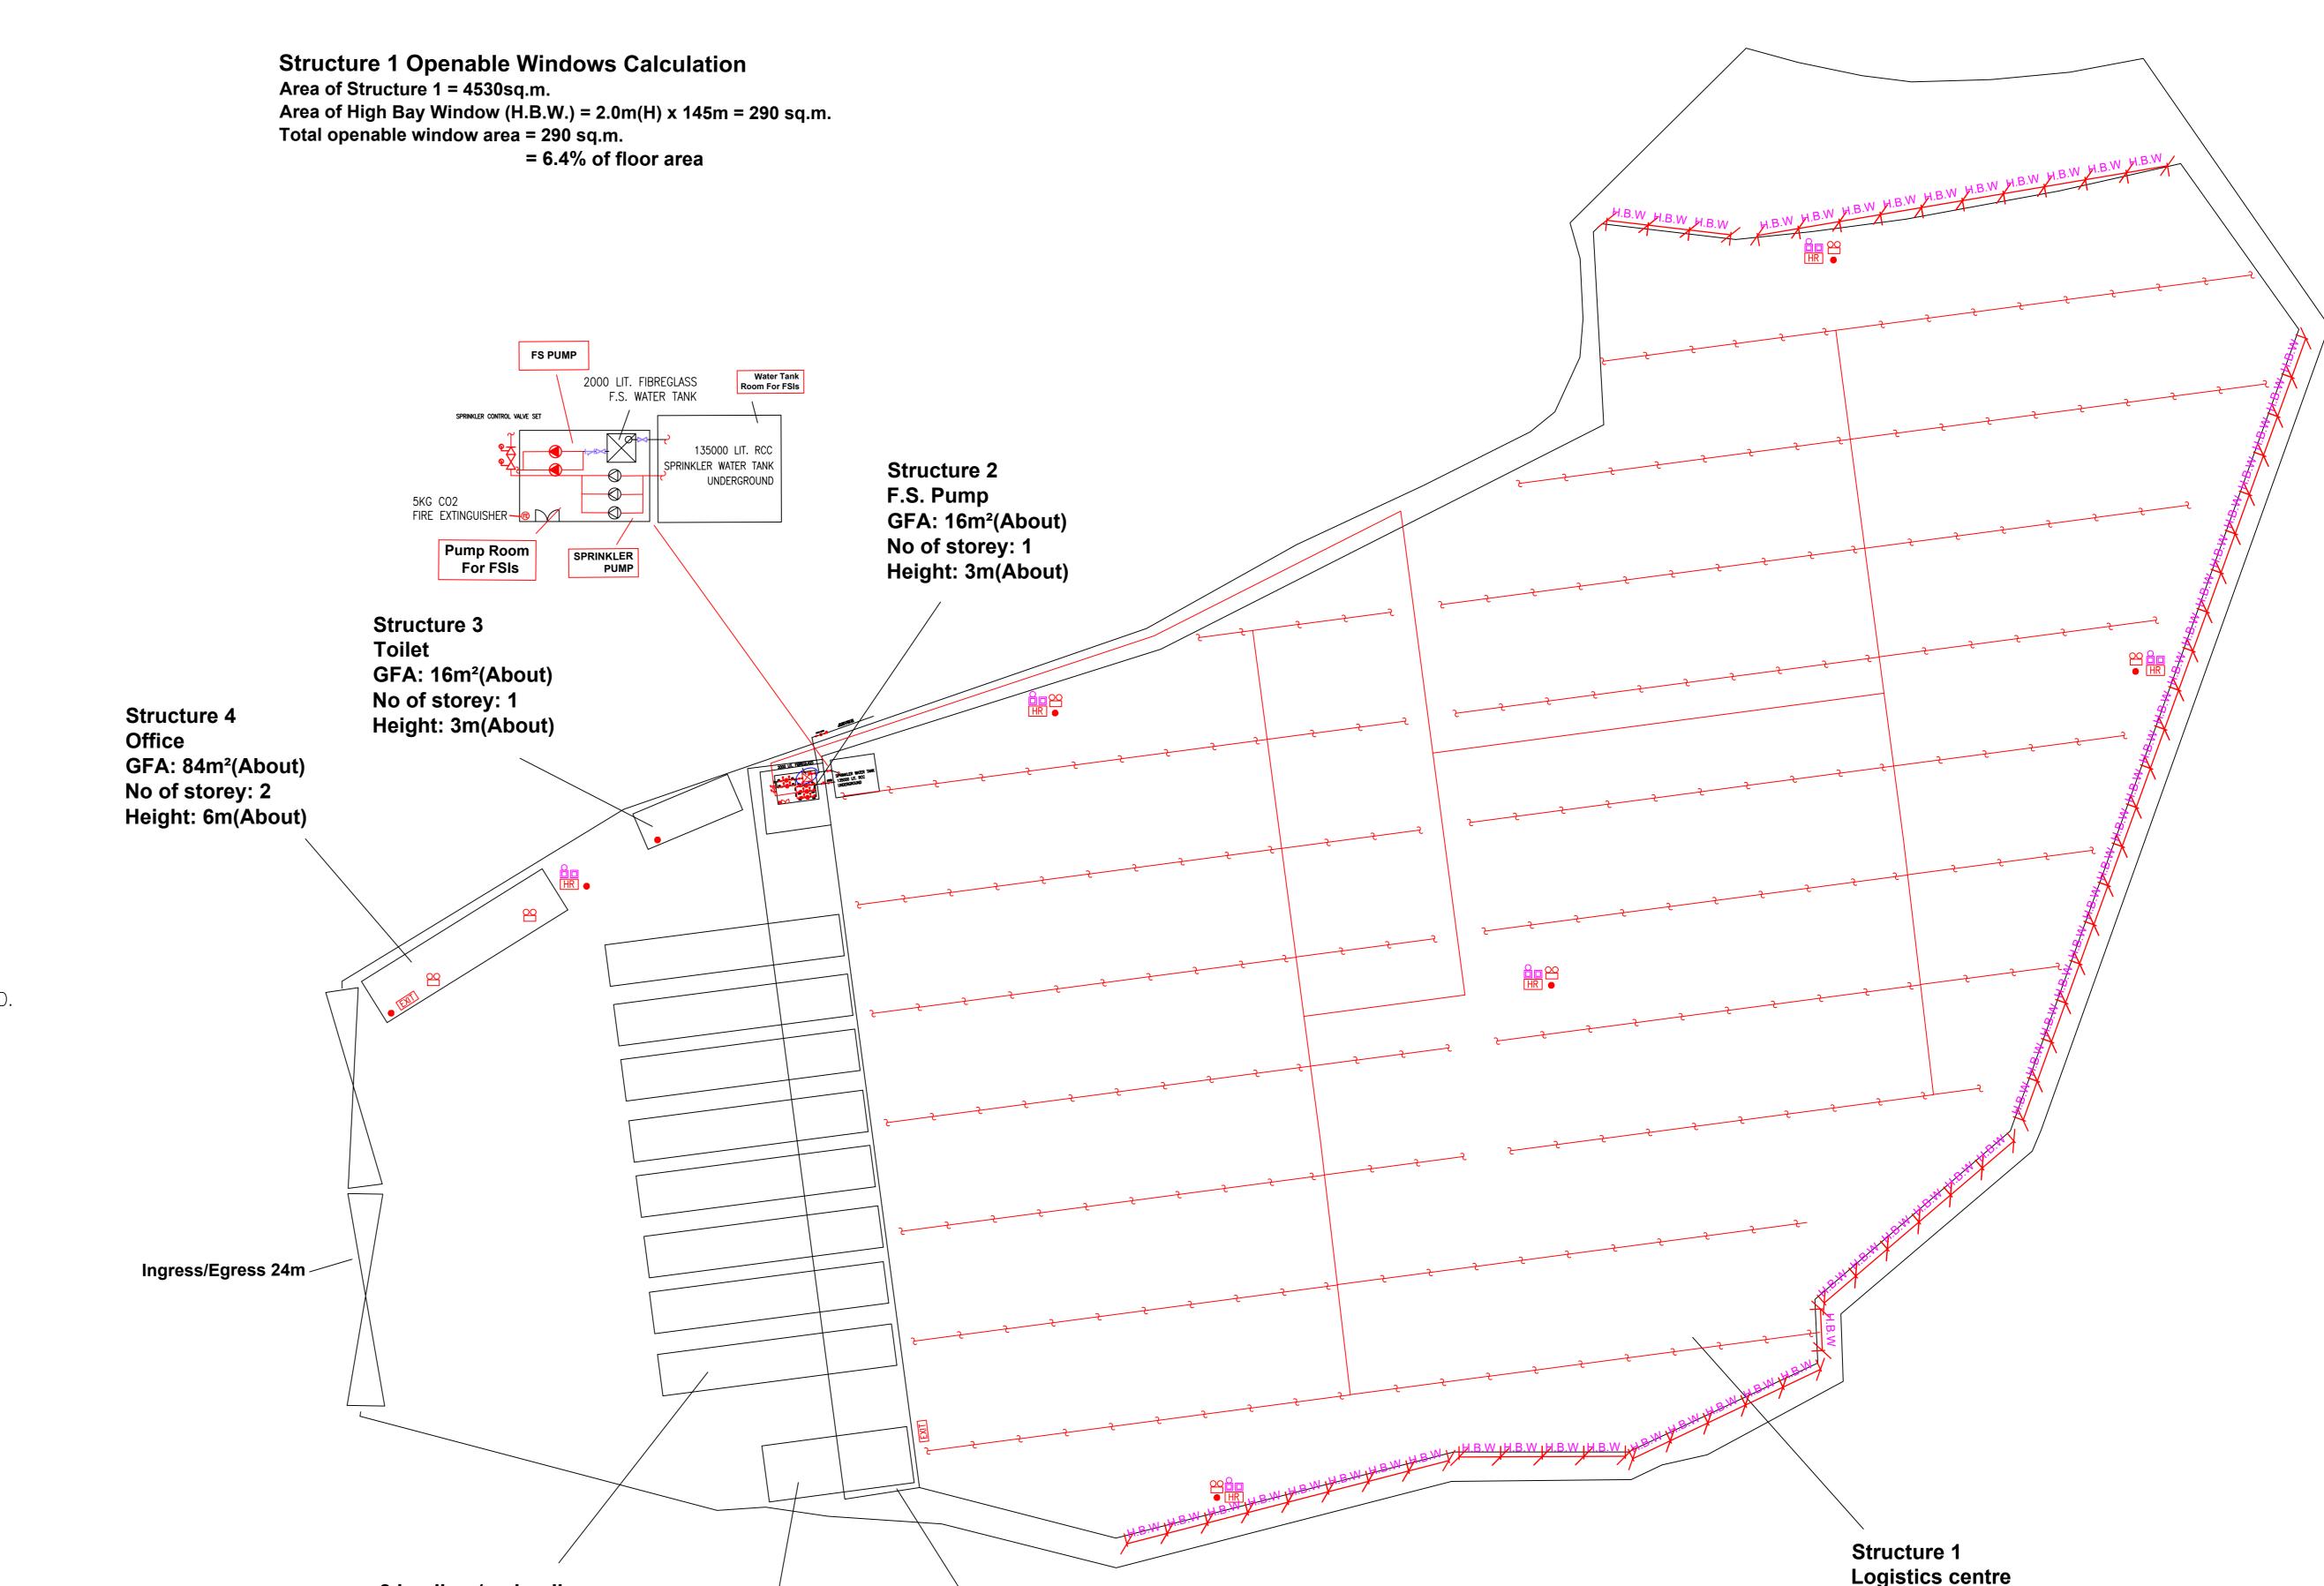

ISSUE 1

TEMPORARY DRAINAGE PROPOSAL (Final)

APPLICATION SITE OF THE PROPOSED TEMPORARY LOGISTICS CENTRE FOR A PERIOD OF 3 YEARS AT LOTS 456 RP, 459, 460, 461, 462 AND 2229 RP IN D.D. 83, KWAN TEI, FANLING, NEW TERRITORIES

PROJECT NO. AGLA/TDM/016

PREPARED FOR

APPLICATION NO. A/NE-TKL/708

20 August 2024

Table of Contents

1	Intro	oduction1
	1.1	Background1
	1.2	Objectives of the Report
	1.3	Report Structure
2	Deve	elopment Proposal1
	2.1	Location of the Application Site
3	Asse	ssment Criteria2
	3.1	Design Return Periods
	3.2	Calculation Methodology for Runoff
	3.3	Calculation Methodology for Pipe Capacity Checking
4	Pote	ntial Drainage Impact3
_	4.1	Existing Site Condition
	4.2	Changes in Drainage Characteristics
	4.3	Potential Drainage Impact
5	Cons	truction Stage4
_	5.1	Temporary Drainage Arrangements
6	Conc	lusions5
Ū	6.1	Conclusion
LI	ST OF	APPENDICES
B. C. D. E.	. Desigi	t Plan sed Drainage Plan n Calculation of the Proposed Drainage al Standard Drawings Of U-Channel and Catchpit
LI	ST OF	TABLES
Та	able 3-1	Recommended Design Return Periods based on Flood Levels
Ta	able 4-1	Change in sub-catchment within the site
Та	able 4-2	Design calculation of the proposed drainage work4

1 Introduction

1.1 Background

1.1.1 This report presents the Drainage Proposal for supporting the application site of the proposed temporary logistics centre for a period of 3 years at Lots 456 RP, 459, 460, 461, 462 and 2229 RP in D.D. 83, Kwan Tei, Fanling, New Territories. For the site location plan, please refer to the **Appendix A.**

1.2 Objectives of the Report

- 1.2.1 This report shall be prepared to include the following:
 - Identify the potential drainage impact assessment from the proposed Application Site
 - recommend and implement all necessary measures to mitigate adverse drainage impacts arising from the application site

1.3 Report Structure

- 1.3.1 The report contains the following sections:
 - Section 1 on Introduction;
 - Section 2 on Development Proposal;
 - Section 3 on Assessment Criteria;
 - Section 4 on Potential Drainage Impact; and
 - Section 5 on Conclusion.

2 Development Proposal

2.1 Location of the Application Site

- 2.1.1 The application Site is located within the Kwan Tei, Fanling with an area of around 6,300m² and ground level varying between + 11.4mPD and + 10.8mPD. The layout plan is provided in **Appendix B.**
- 2.1.2 This application site is "Open Storage" and "Agriculture" zoning, the type of application is the Temporary Use/Development in Rural Areas for a Period of 3 Years.

3 Assessment Criteria

3.1 Design Return Periods

3.1.1 The drainage system in the Application site is to collect surface flows and convey to downstream village drain. The recommended design return periods based on the flood levels for the various drainage systems depend on the drainage system, land use, hazard to public safety and community expectations. The recommended design return period is reproduced in Table 3-1 below:

Table 3-1 Recommended Design Return Periods based on Flood Levels

DESCRIPTION	DESIGN RETURN PERIODS
Intensively Used Agricultural Land	2 – 5 Years
Village Drainage including internal Drainage System under a polder Scheme	10 Years
Main Rural Catchment Drainage Channels	50 Years
Urban Drainage Trunk System	200 Years
Urban Drainage Branch System	50 Years

- 3.1.2 As per Storm Drainage Manuel (SDM) Section 6.6.2 Urban Drainage Branch and Urban Drainage Trunk Systems "An 'Urban Drainage Branch System' is defined as a group or network of connecting drains collecting runoff from the urban area and conveying stormwater to a trunk drain, river or sea. For a simple definition, the largest pipe size or the equivalent diameter in case of a box culvert in a branch system will normally be less than 1.8m.
- 3.1.3 An 'Urban Drainage Trunk System' collects stormwater from branch drains and/or river inlets, and conveys the flow to outfalls in river or sea. Pipes with size or diameter equal to or larger than 1.8m are normally considered as trunk drains."
- 3.1.4 As per SDM, since the proposed U-channels are sized smaller than 1.8m, the drainage system would be defined as an urban drainage branch with recommended design return period of 50 years.
- 3.1.5 The 50 years design return period will be considered to ensure adequacy of the stormwater drainage system.

3.2 Calculation Methodology for Runoff

3.2.1 Peak instantaneous runoff values before and after the development were calculated based on the Rational Method and with recommended physical parameters including runoff coefficient I and storm constants for different return periods referred to the SDM, based on the following equation:

$$Q_p = 0.278 \text{ C i A}$$

where $Q_p = Peak Runoff, m^3/s$ C = Runoff Coefficient i = Rainfall Intensity, mm/hr

A = Catchment Area, km²

- 3.2.2 The paved area of the site will account for 6,300 m². For conservative, the runoff coefficient of 0.95 is assumed, such that the all the run-off would be collected from the catchment area without any infiltration as the critical scenario.
- 3.2.3 Based on the storm constants for 10-year return period recommended in the SDM, the appropriate rainfall intensities (i) are calculated as detailed in **Appendix D**

3.3 Calculation Methodology for Pipe Capacity Checking

- 3.3.1 Because the catchment areas are less than 1ha, U-channels are recommended to be constructed to collect the stormwater runoff within the site. The collected stormwater should finally be diverted to the downstream via the proposed U-channel system.
- 3.3.2 For the worst-case scenario, bad condition of concrete pipe is assumed for the Manning's roughness coefficient (coefficient value is 0.016) for calculating capacities of concrete Uchannel using Manning's Equation.
- 3.3.3 Manning's Equation for calculating the channel and pipe capacities is adopted.

4 Potential Drainage Impact

4.1 Existing Site Condition

- 4.1.1 The application Site is located within the Kwan Tei, Fanling with an area of around 6,300m² and ground level varying between + 11.4mPD and + 10.8mPD.
- 4.1.2 Only the application site with a projected area of 6,300 m² is considered as part of the catchment. There is no external catchment were identified as the application site is generally higher than the adjacent land.

4.2 Changes in Drainage Characteristics

- 4.2.1 The characteristics of the sub-catchment areas are remained unchanged due to the temporary development for the application site, which are paved area.
- 4.2.2 The application site is fully covered by concrete surface currently. This application does not propose adding any additional concrete area, the difference in surface runoff that can be attributed to this application is negligible. The change in sub-catchment is summarized in Table 4-2.

Table 4-1 Change in sub-catchment within the site

	BEFORE	AFTER
Grassland (m²)	0	0
Unpaved Area (m²)	0	0
Paved Area (m²)	6,300	6,300
Total Catchment Area (m²)	6,300	6,300

4.3 Potential Drainage Impact

- 4.3.1 The details of the proposed drainage works are illustrated in **Appendix C**.
- 4.3.2 To effectively convey stormwater away from the application site and minimize the potential impact to the drainage infrastructure of the village area, drainage works consists of U-channels, are proposed to convey the flow to the terminate catchpit with trap (TCP).
- 4.3.3 The runoff from the Application site is collected by 600mm U-channels along the boundary and discharged to the catchpit with trap (TCP), which is connected to the further downstream leading to the discharge point of a well-established Existing Village via 600mm U-Channel at the southern direction of the application site.
- 4.3.4 The 450mm U-channel receives stormwater from the surface and the upstream catchment. For Conservative, the critical scenario is considered for collecting all the flow leading to the village drainage. The design calculation of the proposed drainage is provided in **Appendix D**.

Note:

- [1] Rainfall increase due to climate change at the end of 21st century is considered according to stormwater drainage manual Table 28.
- [2] The reserve capacity is calculated by assuming that the 450mm U-channel reach its full capacity for conservative.
- 4.3.5 The design runoff arise from the proposed Application Site is to be discharged into the proposed 450mm UC with gradient 1:100 and Ng Tung River.
- 4.3.6 Since there are no changes in Drainage Characteristics, it is considered that the drainage discharge from the Application Site will not cause adverse impact to the entire downstream drainage system.
- 4.3.7 All u-channels & catch pits will be constructed according to the CEDD's standard drawings, please refer to the **Appendix E.**

5 Construction Stage

5.1 Temporary Drainage Arrangements

- 5.1.1 Proper measures shall be taken to maintain the existing drainage characteristics of the catchment areas and to minimize drainage impacts associated with the construction works. The principal drainage impacts which are associated with construction of the works have been identified as follows:
 - (a) Erosion of ground materials;
 - (b) Sediment transportation to existing downstream drainage system; and
 - (c) Obstruction to drainage systems.
- 5.1.2 Regular inspections shall be carried out to ensure integrity of the works. These inspections shall cover works under construction as well as recently completed areas.

- 5.1.3 To ensure proper operation of the site drainage channels and desilting facilities, inspection of the perimeter drains shall be carried out on a weekly basis and the desilting facilities shall be cleaned on a daily basis.
- 5.1.4 If excavated materials are not possible to transport away the excavated material within the same day, the material should be covered by tarpaulin/impervious sheets. Stockpiles of construction materials (for examples aggregate, fill materials) of more than 50 m³ in an open area shall also be covered with tarpaulin or similar fabric during rainstorms.
- 5.1.5 All runoff discharged into the existing drainage system will be settled in a silt trap to ensure no sediment will be discharged into the channel. Silt traps will normally be provided along the site drainage immediately upstream of the proposed discharge point to the existing Site. The silt traps will be inspected daily and immediately after each rainstorm.
- 5.1.6 Liaison will be carried out with relevant parties regarding temporary drainage arrangements to ensure that the drainage system is functioning adequately.


6 Conclusions

6.1 Conclusion

- 6.1.1 The analysed catchment area of 6,300 m² consists of the site area of the proposed Application Site , with no external attachment area.
- 6.1.2 U-channels are proposed to convey runoff from the application site for collection. The proposed U-channels are located along the site boundary which is subject to change to suit the building layout.
- 6.1.3 The assessment reviews the drainage pipe have the sufficient capacity to cater for the drainage flow from the Application Site.
- 6.1.4 Mitigation measures are proposed during the application site proposed Application Site and to ensure that the existing drainage system within the site will not be affected during the construction stage.


END OF TEXT

APPENDIX A SITE LAYOUT PLAN

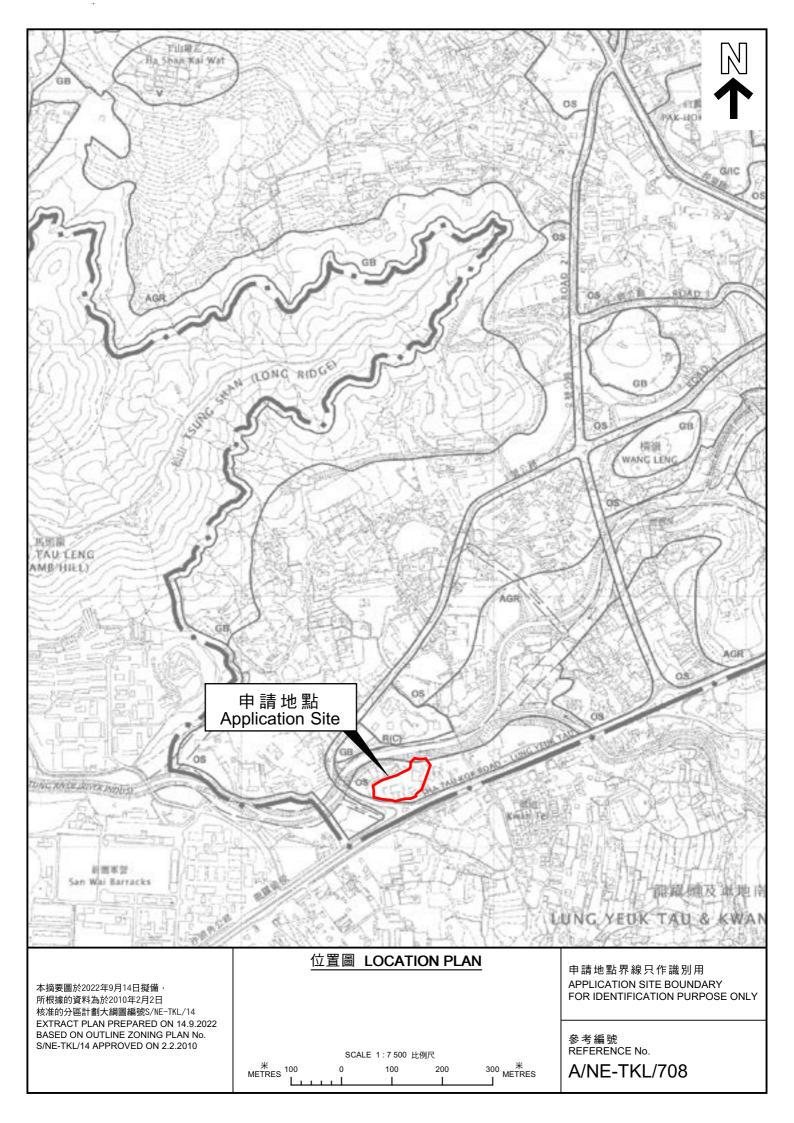


APPENDIX B

LAYOUT PLAN

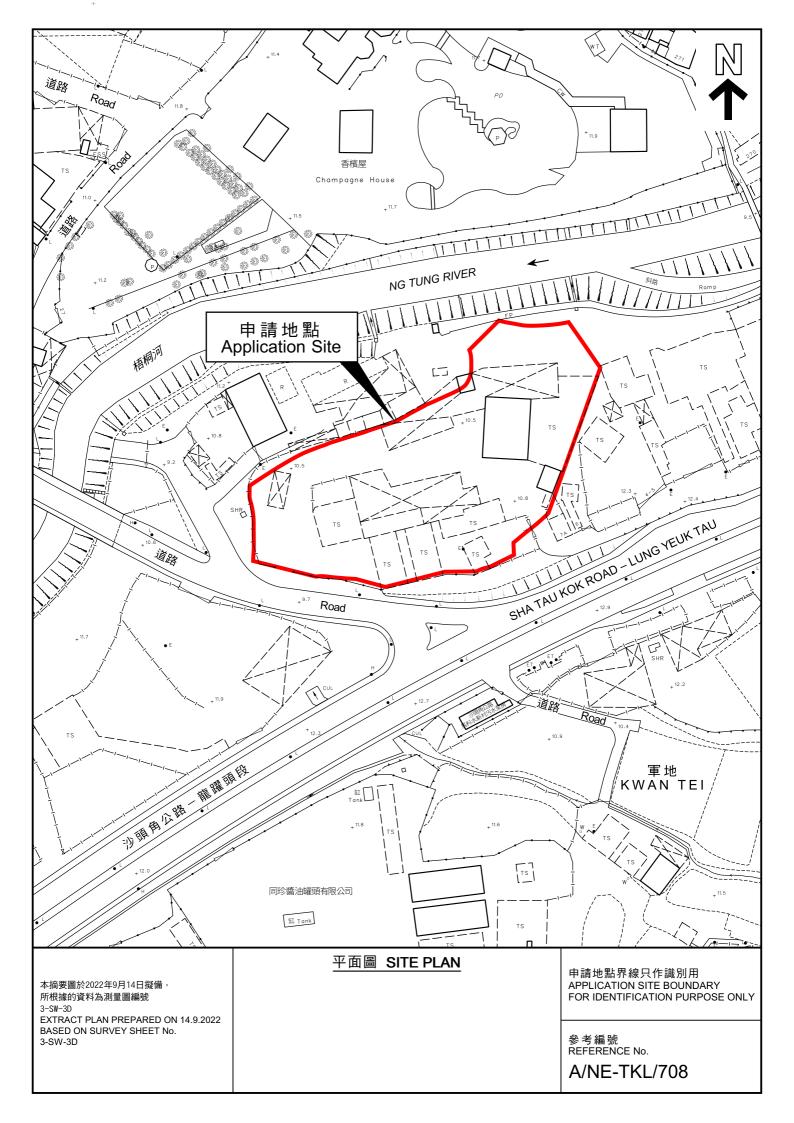

APPENDIX C
PROPOSED DRAINAGE PLAN

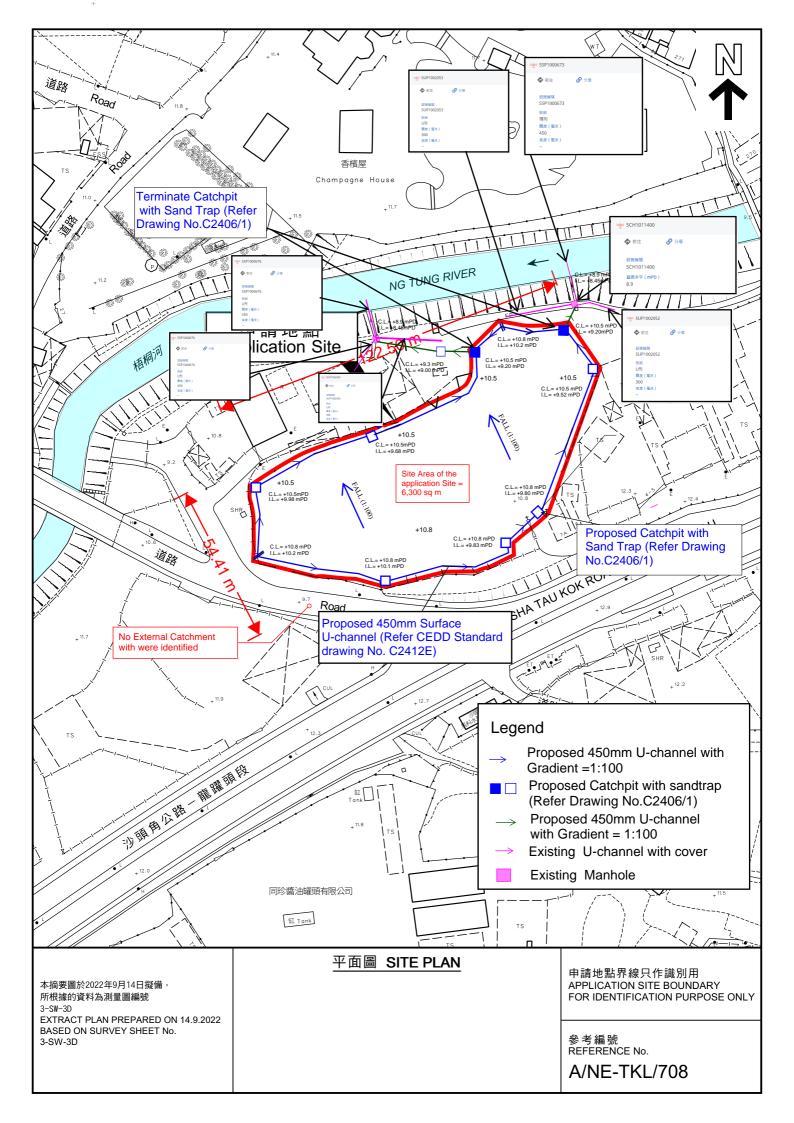

TEMPOP	APV D	DAINIAGE	PROPOSAL	(Einal)
IEIVIPUR	ARID	RAINAGE	PRUPUSAL	(Fillal)

APPENDIX D

DESIGN CALCULATION OF THE PROPOSED DRAINAGE

Company: Project:

Date: 20/8/2024

6300 Site Area = m2 (C = 0.95, hard-paved)

Outside Catchment Area = m2 (C=0.6, Grassland, heavy soil, Steep Slope) (Ratio of concrete paved: ratio of soil paved = 1:2) 0

Total Catchmnet Area= 6300 m2

$$I_o = \frac{0.14465L}{H^{0.3}A^{0.1}}$$

time of concentration of a natural catchment (min.)

catchment area (m2)

average slope (m per 100 m), measured along the line of natural flow, from the summit of the catchment to the point under consideration

distance (on plan) measured on the line of natural flow between the summit and the point under consideration

$$i = \frac{a}{(r_c + b)^c}$$

where - extreme mean intensity in mm/hr,

= duration in minutes (t_d < 240), and

a, b, c = storm constants given in Tables 3a, 3b, 3c and 3d.

Assume 10 yrs return period

a = 1157.7b= 19.04 c = 0.597

i = 174.996504 mm/hr

Therefore, i = 180mm/hr take

Company: Project:	
Date:	20/8/2024
Calculation for channels:	


Catchment Area of site

Site Area	= =	6300 0.0063	m^2 km^2							
Peak runoff in m^3/s	= = =	0.278 0.299489 17969	x m^3/s liter/min	0.95	X	180	mm/hr	X	0.0063	km^2
Outside Area	= =	0	m^2 km^2							
Peak runoff in m^3/s	= = =	0.278 0 0	x m^3/s liter/min	0.6	X	180	mm/hr	Х	0	km^2
Total Peak Runoff for Site	=	0.299489	m^3/s	=		17969.	364		liter/min	

Collected Surface runoff will be divided into two paths and two independent drainage path in the site can collect half of catchment Area (site area)

Peak runoff for half area = 0.150 m/3/s = 8985 liter/min

For checking existing 450UC

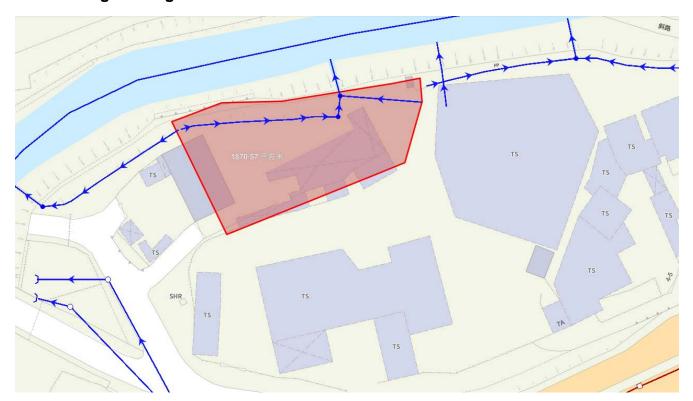

(i) Catchment Area = 1871m2 for Existing 450 UC



(ii) Catchment Area = 763m2 for Existing 450 UC

(i) Case is critical and adopted. Total Surface Runoff for Existing 450UC = $8985 + 0.278(180)(1871 \times 10^{-6})/60/1000$ = 14602 lit/hr

As a result, 450UC in proposed site can cater the surface runoff.

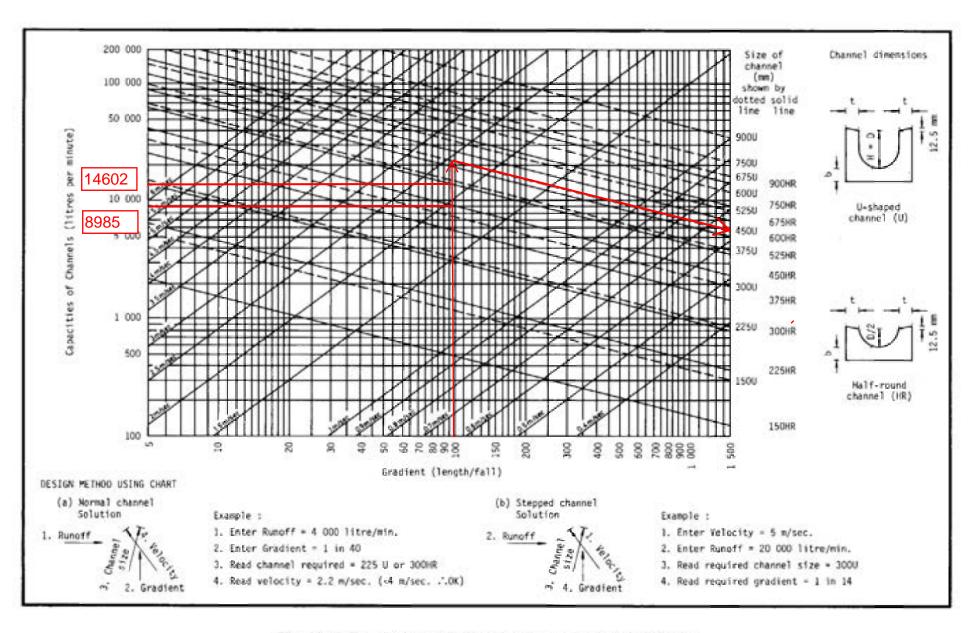



Figure 8.7 - Chart for the Rapid Design of Channels

As a result, 450UC in proposed site can cater the surface runoff and Existing 450UC can cater additional surface runoff from proposed development.

APPENDIX E

TYPICAL STANDARD DRAWINGS OF U-CHANNEL AND CATCHPIT

(EXTRACTED FROM CEDD, FOR REFERNCE ONLY)

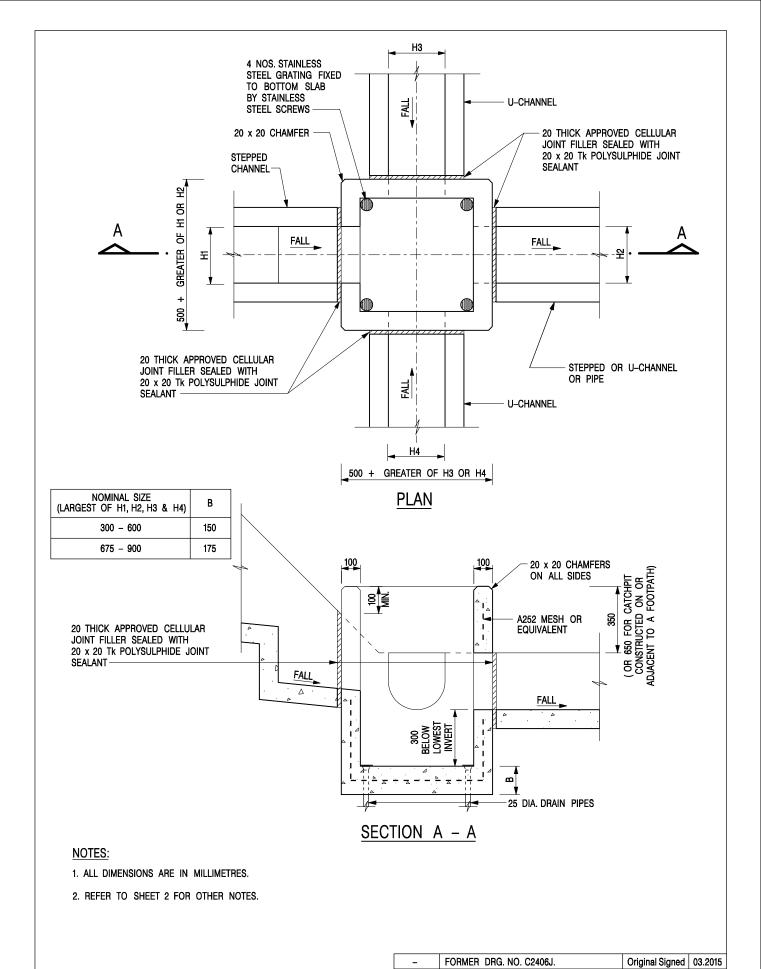

CATCHPIT WITH TRAP
(SHEET 1 OF 2)

CIVIL ENGINEERING AND DEVELOPMENT DEPARTMENT

SCALE 1:20 DRAWING NO.

REVISION


DATE JAN 1991

REF.

C2406 /1

SIGNATURE DATE

卓越工程 建設香港

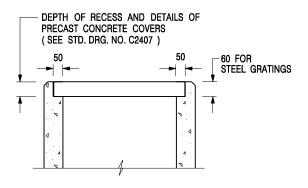

ALTERNATIVE TOP SECTION FOR PRECAST CONCRETE COVERS / GRATINGS

NOTES:

- 1. ALL DIMENSIONS ARE IN MILLIMETRES.
- 2. ALL CONCRETE SHALL BE GRADE 20 /20.
- 3. CONCRETE SURFACE FINISH SHALL BE CLASS U2 OR F2 AS APPROPRIATE.
- 4. FOR DETAILS OF JOINT, REFER TO STD. DRG. NO. C2413.
- 5. CONCRETE TO BE COLOURED AS SPECIFIED.
- UNLESS REQUESTED BY THE MAINTENANCE PARTY AND AS DIRECTED BY THE ENGINEER, CATCHPIT WITH TRAP IS NORMALLY NOT PREFERRED DUE TO PONDING PROBLEM.
- 7. UPON THE REQUEST FROM MAINTENANCE PARTY, DRAIN PIPES AT CATCHPIT BASE CAN BE USED BUT THIS IS FOR CATCHPITS LOCATED AT SLOPE TOE ONLY AND AS DIRECTED BY THE ENGINEER.
- FOR CATCHPITS CONSTRUCTED ON OR ADJACENT TO A FOOTPATH, STEEL GRATINGS (SEE DETAIL 'A' ON STD. DRG. NO. C2405 /2) OR CONCRETE COVERS (SEE STD. DRG. NO. C2407) SHALL BE PROVIDED AS DIRECTED BY THE ENGINEER.
- 9. IF INSTRUCTED BY THE ENGINEER, HANDRAILING (SEE DETAIL 'J' ON STD. DRG. NO. C2405 /5; EXCEPT ON THE UPSLOPE SIDE) IN LIEU OF STEEL GRATINGS OR CONCRETE COVERS CAN BE ACCEPTED AS AN ALTERNATIVE SAFETY MEASURE FOR CATCHPITS NOT ON A FOOTPATH NOR ADJACENT TO IT. TOP OF THE HANDRAILING SHALL BE 1 000 mm MIN. MEASURED FROM THE ADJACENT GROUND LEVEL.
- 10. MINIMUM INTERNAL CATCHPIT WIDTH SHALL BE 1 000 mm FOR CATCHPITS WITH A HEIGHT EXCEEDING 1 000 mm MEASURED FROM THE INVERT LEVEL TO THE ADJACENT GROUND LEVEL. AND, STEP IRONS (SEE DSD STD. DRG. NO. DS1043) AT 300 c/c STAGGERED SHALL BE PROVIDED. THICKNESS OF CATCHPIT WALL FOR INSTALLATION OF STEP IRONS SHALL BE INCREASED TO 150 mm.
- FOR RETROFITTING AN EXISTING CATCHPIT WITH STEEL GRATING, SEE DETAIL 'G' ON STD. DRG. NO. C2405 /4.
- SUBJECT TO THE APPROVAL OF THE ENGINEER, OTHER MATERIALS CAN ALSO BE USED AS COVERS / GRATINGS.

İ	REF.	REVISION	SIGNATURE	DATE
	-	FORMER DRG. NO. C2406J.	Original Signed	03.2015
	Α	MINOR AMENDMENT.	Original Signed	04.2016

CATCHPIT WITH TRAP (SHEET 2 OF 2)


卓越工程 建設香港



CIVIL ENGINEERING AND DEVELOPMENT DEPARTMENT

 SCALE 1:20
 DRAWING NO.

 DATE JAN 1991
 C2406 /2A

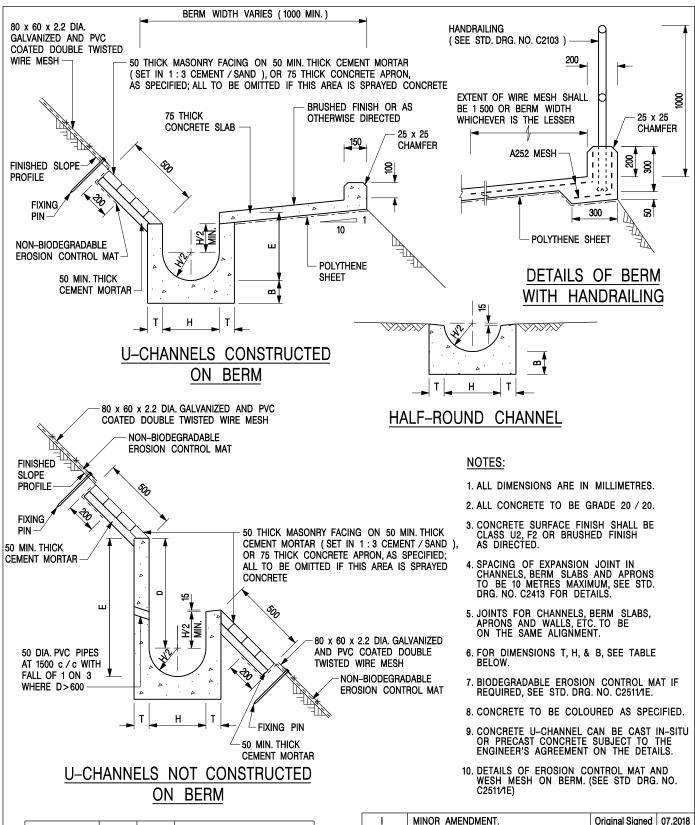

NOMINAL SIZE H	Т	В	REINFORCEMENT
300	80	100	A252 MESH PLACED CENTRALLY AND T=100
375 - 600	100	150	WHEN E>650
675 - 900	125	175	A252 MESH PLACED

I	MINOR AMENDMENT.	Original Signed	07.2018
Н	THICKNESS OF MASONRY FACING AMENDED.	Original Signed	01.2005
G	MINOR AMENDMENT.	Original Signed	01.2004
F	GENERAL REVISION.	Original Signed	12.2002
E	DRAWING TITLE AMENDED.	Original Signed	11.2001
D	MINOR AMENDMENT.	Original Signed	08.2001
С	150 x 100 UPSTAND ADDED AT BERM.	Original Signed	6.99
В	MINOR AMENDMENTS.	Original Signed	3.94
REF.	REVISION	SIGNATURE	DATE

DETAILS OF HALF-ROUND AND U-CHANNELS (TYPE A -WITH MASONRY APRON


卓越工程 建設香港

CENTRALLY




CIVIL ENGINEERING AND **DEVELOPMENT DEPARTMENT**

DRAWING NO. SCALE 1:25 C24091 DATE JAN 1991

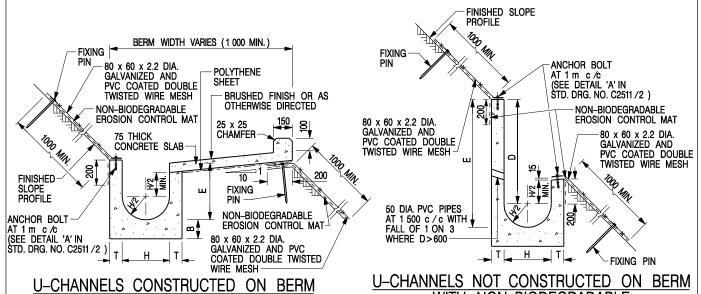

U-CHANNELS CONSTRUCTED ON BERM
WITH NON-BIODEGRADABLE
EROSION CONTROL MAT

<u>J-CHANNELS NOT CONSTRUCTED ON BERM</u>
<u>WITH NON-BIODEGRADABLE</u>
EROSION CONTROL MAT

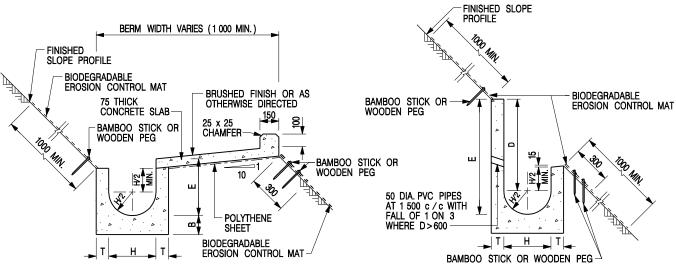

U-CHANNELS CONSTRUCTED ON BERM WITH BIODEGRADABLE EROSION CONTROL MAT

U-CHANNELS NOT CONSTRUCTED ON BERM WITH BIODEGRADABLE EROSION CONTROL MAT

NOTES:

- 1. ALL DIMENSIONS ARE IN MILLIMETRES.
- 2. ALL CONCRETE TO BE GRADE 20 /20.
- 3. CONCRETE SURFACE FINISH SHALL BE CLASS U2, F2 OR BRUSHED FINISH AS DIRECTED.
- 4. SPACING OF EXPANSION JOINT IN CHANNELS, BERM SLABS AND APRONS TO BE 10 METRES MAXIMUM, SEE STD. DRG. NO. C2413 FOR DETAILS.
- 5. JOINTS FOR CHANNELS, BERM SLABS, APRONS AND WALLS, ETC. TO BE ON THE SAME ALIGNMENT.
- 6. FOR DIMENSIONS T, H, & B, SEE TABLE BELOW.
- FOR TYPICAL FIXING PIN DETAILS, SEE STD. DRG. NO. C2511/2.
- 8. MINIMUM SIZE OF 25 x 50 x 300mm SHALL BE PROVIDED FOR WOODEN PEG.
- MINIMUM SIZE OF 10mm DIAMETER WITH 200mm LONG SHALL BE PROVIDED FOR BAMBOO STICK.
- 10. THE FIXING DETAILS OF NON-BIODEGRADABLE AND BIODEGRADABLE EROSION CONTROL MATS ON EXISTING BERM SHALL REFER TO STD. DRG. NO. C2511/1.

NOMINAL SIZE H	Т	В	REINFORCEMENT
300	80	100	A252 MESH PLACED CENTRALLY AND T=100
375 - 600	100	150	WHEN E>650
675 - 900	125	175	A252 MESH PLACED CENTRALLY

DETAILS OF HALF-ROUND AND U-CHANNELS (TYPE B - WITH EROSION CONTROL MAT APRON)

REF.	REVISION	SIGNATURE	DATE
Α	MINOR AMENDMENT.	Original Signed	10.92
В	MINOR AMENDMENT.	Original Signed	3.94
С	150 x 100 UPSTAND ADDED AT BERM.	Original Signed	6.99
D	MINOR AMENDMENT.	Original Signed	08.2001
E	GENERAL REVISION.	Original Signed	12.2002
F	MINOR AMENDMENT.	Original Signed	01.2004
G	DIMENSION TABLE AMENDED.	Original Signed	01.2005
Н	FIXING DETAILS OF BIODEGRADABLE EROSION CONTROL MAT ADDED.	Original Signed	12.2017
- 1	MINOR AMENDMENT.	Original Signed	07.2018




CIVIL ENGINEERING AND DEVELOPMENT DEPARTMENT


SCALE DIAGRAMMATIC

DATE JAN 1991

DRAWING NO. C24101

卓越工程 建設香港

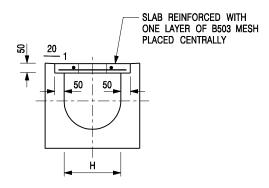

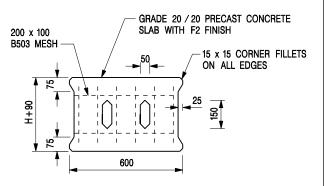



TYPICAL SECTION

PLAN OF SLAB

U-CHANNELS WITH PRECAST CONCRETE SLABS

(UP TO H OF 525)

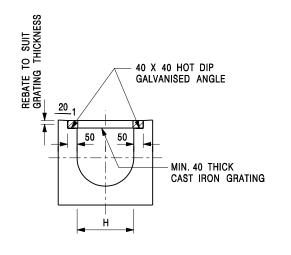

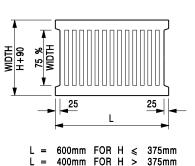

TYPICAL SECTION

CAST IRON GRATING

(DIMENSIONS ARE FOR GUIDANCE ONLY, CONTRACTOR MAY SUBMIT EQUIVALENT TYPE)

U-CHANNEL WITH CAST IRON GRATING

(UP TO H OF 525)

NOTES:

- 1. ALL DIMENSIONS ARE IN MILLIMETRES.
- 2. H=NOMINAL CHANNEL SIZE.
- ALL CAST IRON FOR GRATINGS SHALL BE GRADE EN-GJL-150 COMPLYING WITH BS EN 1561.
- 4. FOR COVERED CHANNELS TO BE HANDED OVER TO HIGHWAYS DEPARTMENT FOR MAINTENANCE, THE GRATING DETAILS SHALL FOLLOW THOSE AS SHOWN ON HyD STD. DRG. NO. H3156.

Е	NOTES 3 & 4 AMENDED.	Original Signed	12.2014
D	NOTE 4 ADDED.	Original Signed	06.2008
С	MINOR AMENDMENT. NOTE 3 ADDED.	Original Signed	12.2005
В	NAME OF DEPARTMENT AMENDED.	Original Signed	01.2005
Α	CAST IRON GRATING AMENDED.	Original Signed	12.2002
REF.	REVISION	SIGNATURE	DATE

COVER SLAB AND CAST IRON GRATING FOR CHANNELS




CIVIL ENGINEERING AND DEVELOPMENT DEPARTMENT

 SCALE 1:20
 DRAWING NO.


 DATE JAN 1991
 C2412E

卓越工程 建設香港 We Engineer Hong Kong's Development

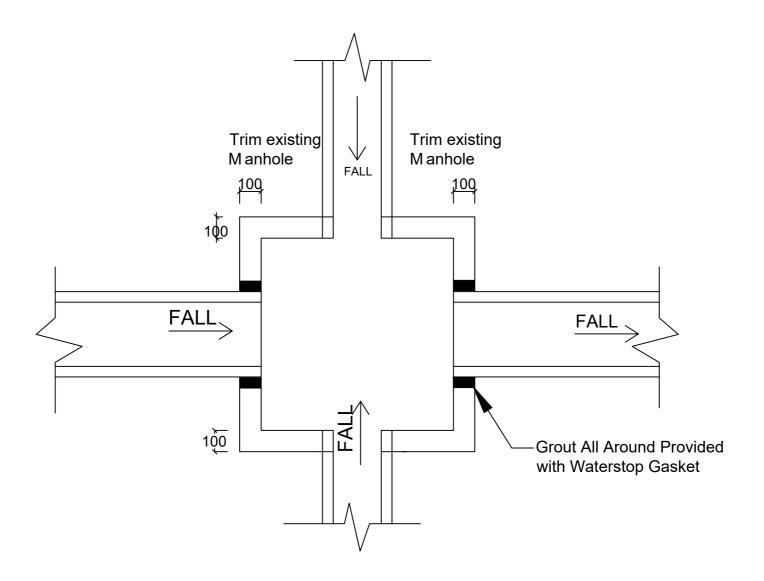

Connection Detail of SCH1011400 and SCH1011402

APPENDIX F
SITE PHOTO

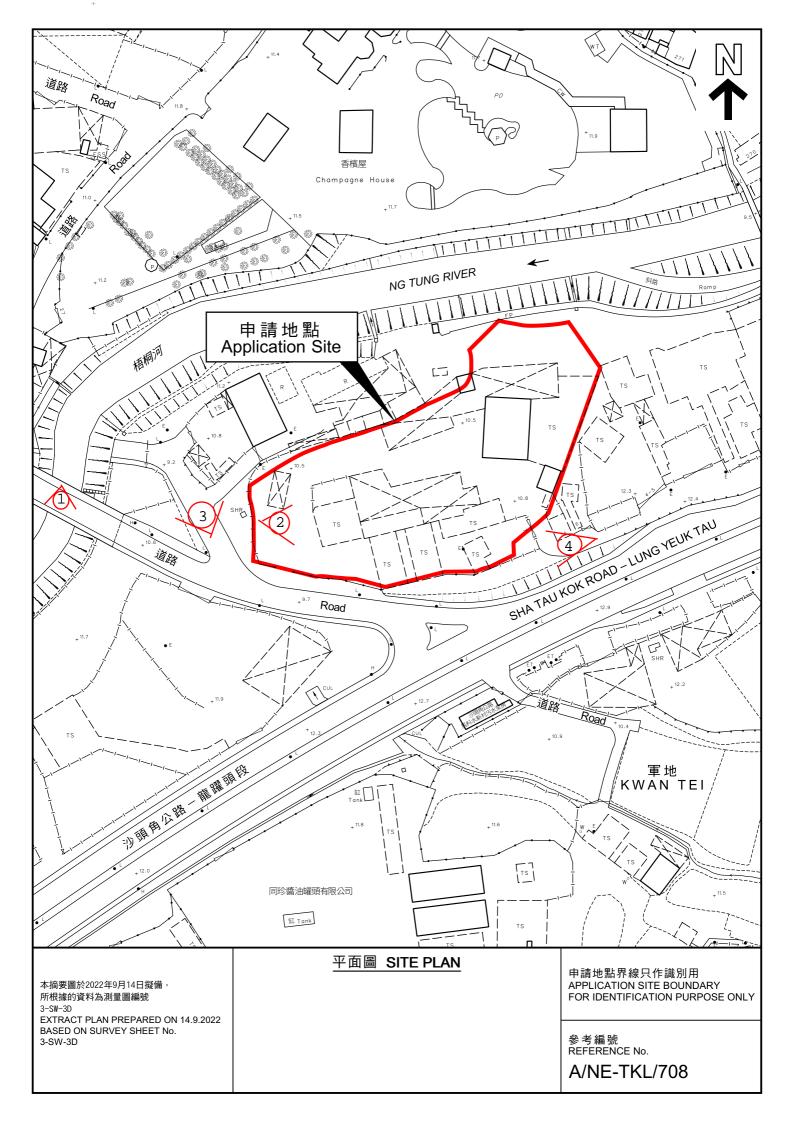



VIEW 1: Existing Nullah Ng Tung River



VIEW 2: Entrance of the Site



VIEW 3: Entrance of the Site



VIEW 4: Outside of the Site

□Urgent □Return receipt □Expand Group □Restricted □Prevent Copy □Confidential		
Timothy Wai Pui WU/PLAN	D	
寄件者: 寄件日期: 收件者: 副本: 主旨: 附件:	2024年12月24日星期二 0:04 tpbpd/PLAND Timothy Wai Pui WU/PLAND 有關A/NE-TKL/773 消防處、運輸署及渠務署意見回覆 TKL773部門意見回覆_20241212.pdf; TKL773_FS Drawing_20241212.pdf; TKL708- SWEPT PATH_20241212.pdf; Temporary Drainage Proposal forANE-TKL773 (Issue 3)-compressed.pdf	
敬啟者,		
有關 A/NE-TKL/773 消防處、	運輸署及渠務署意見回覆可見附件。	
如有任何查詢,可隨時與本人	人聯絡。	
黄先生 電話:		

A/NE-TKL/773

部門意見回覆

消防處

In consideration of the design/nature of the proposal, FSIs are anticipated to be required. Therefore, the applicant is advised to submit relevant layout plans (*since the GFA has changed, the applicant is advised to submit a new FSI proposal) incorporated with the proposed FSIs to this Department for approval. In addition, the applicant should also be advised on the following points:

i) The layout plans should be drawn to scale and depicted with dimensions and nature of occupancy; and

ii) The location of where the proposed FSI to be installed should be clearly marked on the layout plans.

運輸署

a) The applicant shall use swept path analysis to	見附件 Plan4 Swept Path
demonstrate the satisfactory maneuvering of	
container trucks entering to and existing from the	
subject site, maneuvering within the subject site and	
into/out of the parking spaces;	
b) Please clarify whether there will be a gate installed	出入口會安裝大閘,不會有車
at the entry. If so, please ensure such arrangement	輛停泊在場外或在場外等候。
will not cause queueing of vehicles outside the subject	
site; and	
c) The vehicular access between the site and Sha Tau	申請人知悉
Kok Road is not managed by TD. The applicants should	
seek comment from the responsible party.	

(i) Para 3.1.5 and Appendix D refer. Discrepancy is	Design Return Period is adopted
observed for the adopted design return period, the	as 10 years
applicant should clarify. The applicant should also	
validate if the latest requirements under the	
Corrigendum No. 1/2024 of the Stormwater	
Drainage Manual are incorporated in the design;	
(ii) the cover levels of proposed channels should be	Noted
flush with the existing adjoining ground level;	
(iii) Appendix D refers. The applicant should advise	Maximum utilisation of the
the utilisation of the proposed drainage, and the	proposed drainage, and the
existing drainage proposed for connection;	existing drainage proposed for
	connection is 73%
(iv) Appendix C refers. The applicant should advise	Connection Detail is provided in
the legend for lines in green. Also, the existing	Appendix E
manhole SCH1011400 and SCH1011402 to which the	
applicant proposed to discharge the storm water	
from the Site are maintained by her office. The	
applicant should provide the connection details for	
agreement. After obtaining her agreement, the	
applicant shall submit a duly completed Form HBP1	
with a cross cheque covering the technical audit fee	
and a plan showing the details of the proposed	
connection works to this Division for formal	
application for the required connection. Upon my	
acceptance of the connection application, the	
applicant shall carry out the proposed connection	
works in accordance with DSD Standard Drawings at	
the resources of the applicant	
(v) photos should be submitted clearly showing the	Site photos are provided for your
current conditions of the Site, the existing	reference
drainage/flowpaths around the Site, the proposed	
drainage from the Site to the downstream existing	
watercourse and the existing watercourse. The	
locations of the camera and the direction of each	
photo should also be indicated on a plan;	
	<u>i</u>

(vi) the applicant should check and ensure that the	Noted
existing drainage downstream to which the	Noted
proposed connection will be made have adequate	
capacity and satisfactory condition to cater for the	
additional discharge from the Site. The applicant	
should also ensure that the flow from the Site will	
not overload the existing drainage system;	
(vii) the applicant is reminded that where walls are	Noted
erected or kerbs are laid along the boundary of the	
same, peripheral channels should be provided on	
both sides of the walls or kerbs, and/or adequate	
openings should be provided at the walls/kerbs to	
allow existing overland flow passing through the Site	
to be intercepted by the drainage system of the Site	
with details to be agreed by DSD, unless justified not	
necessary;	
(viii) the applicant is reminded that all existing flow	Noted
paths as well as the run-off falling onto and passing	
through the Site should be intercepted and disposed	
of via proper discharge points. The applicant shall	
also ensure that no works, including any site	
formation works, shall be carried out as may	
adversely interfere with the free flow condition of	
the existing drains, channels and watercourses on or	
in the vicinity of the Site any time during or after the	
works;	
(ix) the proposed drainage works, whether within or	Noted
outside the site boundary, should be constructed	
and maintained properly by the applicant and rectify	
the system if it is found to be inadequate or	
ineffective during operation at his/her own expense;	
(x) for works to be undertaken outside the lot	Noted
boundary, the applicant should obtain prior consent	
and agreement from DLO/N and/or relevant private	
lot owners;	
(xi) the applicant should make good all the adjacent	Noted
affected areas upon the completion of the drainage	
works;	
,	

(xii) the applicant shall allow all time free access for	Noted
the Government and its agent to conduct site	
inspection on his completed drainage works;	
(xiii) the applicant and the successive lot owners	Noted
shall allow connections from the adjacent lots to the	
completed drainage works on GL when so required.	

F.S.NOTES:

1. GENERAL

- 1.1 FIRE SERVICE INSTALLATIONS SHALL BE PROVIDED IN ACCORDANCE WITH THE CODES OF PRACTICE FOR MINIMUM FIRE SERVICE INSTALLATIONS AND EQUIPMENT AND INSPECTION, TESTING AND MAINTENANCE OF INSTALLATIONS AND EQUIPMENT 2022 (COP 2022), FSD CIRCULAR LETTERS AND THE HONG KONG WATERWORKS STANDARD REQUIREMENTS.
- 1.2 ALL TUBES AND FITTINGS SHALL BE G.M.S. TO BS1387 MEDIUM GRADE WHERE PIPEWORK UP TO Ø150mm.
- 1.3 ALL TUBES AND FITTINGS SHALL BE DUCTILE IRON TO BS EN545 K12 WHERE PIPEWORK ABOVE Ø150mm.
- 1.4 ALL DRAIN PIPES SHALL BE DISCHARGED TO A CONSPICUOUS POSITION WITHOUT THE POSSIBILITY OF BEING SUBMERGED.
- 1.5 ALL PUDDLE FLANGES SHALL BE MADE OF DUCTILE IRON
- 1.6 THE AGGREGATE AREA OF OPENABLE WINDOWS NOT LESS THAN 6.25% OF THE FLOOR AREA OF THE STRUCTURE
- 1.7 SMOKE EXTRACTION SYSTEM NOT TO BE PROVIDED.

2. HOSE REEL SYSTEM

- 2.1 NEW FIRE HOSE REEL SHALL BE PROVIDED AS INDICATED ON PLAN TO ENSURE THAT EVERY PART OF THE BUILDING CAN BE REACHED BY A LENGTH OF NOT MORE THAN 30m HOSE REEL TUBING.
- 2.2 THE WATER SUPPLY FOR HOSE REEL SYSTEM WILL BE FED FROM A NEW 2m³ F.S. FIBREGLASS WATER TANK VIA TWO HOSE REEL PUMPS (DUTY/ STANDBY) LOCATED INSIDE FS PUMP ROOM AT EXTERNAL AREA.
- 2.3 HOSE REEL PUMPS SHALL BE STARTED BY ACTUATION OF ANY BREAKGLASS UNIT FITTED ASIDE EACH HOSE REEL SETS
- 2.4 ALL FIRE HOSE REEL OUTLETS SHOULD BE HOUSED IN GLASS FRONTED CABINET SECURED UNDER LOCK & KEY.
- 2.5 ALL FIRE HOSE REEL SHOULD BE PROVIDED WITH FSD APPROVED TYPE INSTRUCTION PLATE & WSD WARNING PLATE
- 2.6 SECONDARY ELECTRICITY SUPPLY DIRECTLY TEE OFF BEFORE CLP'S INCOMING MAIN SWITCH SHALL BE PROVIDED FOR THE FS PUMPS.

3. AUTOMATIC SPRINKLER SYSTEM

- 3.1 NEW AUTOMATIC SPRINKLER SYSTEM SHALL BE PROVIDED AND INSTALLED IN ACCORDANCE WITH LPC RULES FOR AUTOMATIC SPRINKLER INSTALLATIONS INCORPORATING BS EN 12845: 2015 (INCLUDING TECHNICAL BULLETINS, NOTES, COMMENTARY AND RECOMMENDATIONS) AND FSD CIRCULAR LETTER NO. 5/2020. THE CLASSIFICATION OF THE OCCUPANCIES WILL BE ORDINARY HAZARD GROUP III.
- 3.2 ONE NEW 135m3 SPRINKLER WATER TANK WILL BE PROVIDED AS INDICATED ON PLAN. THE TOWN MAIN WATER SUPPLY WILL BE FED FROM SINGLE END.
- 3.3 TWO NEW SPRINKLER PUMPS (DUTY/STANDBY) AND ONE JOCKEY PUMP SHALL BE PROVIDED IN FS PUMP ROOM LOCATED AT EXTERNAL AREA.
- 3.4 NEW SPRINKLER CONTROL VALVE SET AND SPRINKLER INLET SHALL BE PROVIDED AS INDICATED ON PLAN.
- 3.5 ALL SUBSIDIARY STOP VALVES TO BE ELECTRIC MONITORING TYPE.
- 3.6 SECONDARY ELECTRICITY SUPPLY DIRECTLY TEE OFF BEFORE CLP'S INCOMING MAIN SWITCH SHALL BE PROVIDED FOR THE SPRINKLER PUMPS.
- 3.7 THE SPRINKLER SYSTEM DESIGN IS BASED ON THE FOLLOWINGS: HAZARD CLASS : ORDINARY HAZARD GROUP III TYPE OF STORAGE: POST-PALLET (ST2) STORAGE CATEGORY: CATEGORY II MAXIMUM STORAGE HEIGHT: 3.5m SPRINKLER PROTECTION: CEILING PROTECTION ONLY

4. FIRE ALARM SYSTEM

- 4.1 NEW FIRE ALARM SYSTEM SHALL BE PROVIDED IN ACCORDANCE WITH BS 5839-1:2017 AND FSD CIRCULAR LETTERS NO. 6/2021.
- 4.2 NEW BREAKGLASS UNITS AND FIRE ALARM BELLS SHALL BE PROVIDED AT ALL NEW FIRE HOSE REEL POINTS. THE FIRE ALARM INTALLATION WILL BE INTEGRATED WITH THE HOSE REEL SYSTEM.

5. EMERGENCY LIGHTING

5.1 EMERGENCY LIGHTING SHALL BE PROVIDED IN ACCORDANCE WITH 'BS 5266-1:2016 AND BS EN 1838:2013", AND FSD CIRCULAR LETTERS NO. 4/2021. COVERING ALL AREA. EMERGENCY LIGHTINGS SHALL BE BACKED UP BY BUILT-IN BATTERY AND CAPABLE OF MAINTAINING FUNCTION OF NOT LESS THAN 2 HOURS IN CASE OF POWER FAILURE

6. EXIT SIGN


FOR THE BUILDING. EXIT SIGNS/DIRECTIONAL EXIT SIGNS SHALL BE BACKED UP BY BUILT-IN BATTERY AND CAPABLE OF MAINTAINING FUNCTION OF NOT LESS THAN 2 HOURS IN CASE OF POWER FAILURE.


7. PORTABLE APPLIANCES

7.1 PORTABLE HAND OPERATED APPLIANCES SHALL BE PROVIDED AS INDICATED ON PLAN.

LEGEND



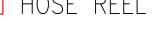

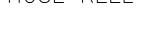









EMERGENCY LIGHT



REV

SUBSIDIARY VALVE / FLOW SWITCH

DESCRIPTION

SPRINKLER CONTROL VALVE SET GATE VALVE GATE TYPE (With MONITORING)

Structure 1 Openable Windows Calculation

Area of High Bay Window (H.B.W.) = $2.0m(H) \times 145m = 290 \text{ sq.m.}$

5KG CO2 FIRE EXTINGUISHER @

Pump Room For FSIs

HEIGHT: 3m (ABOUT)

MANOEUVRING CIRCLE

14m (ABOUT)

LOADING/UNLOADING BAYS

DIMENSION: 3.5m x 16m

NO. of CV SPACES:

CONTAINER VEHICLE SPACES

GFA: 16 m² (ABOUT)

COVERED AREA: 16 m² (ABOUT)

STRUCTURE B3

USE: TOILET

STOREY: 1

STRUCTURE B2

COVERED AREA: 42 m² (ABOUT)

HEIGHT: 6m (ABOUT)

INGRESS/EGRESS 24m ~

(ABOUT)(W)

GFA: 84 m² (ABOUT)

USE: OFFICE

STOREY: 2

= 6.4% of floor area

SSTRUCTURE B4

USE: F.S. PUMP

STOREY: 1

HEIGHT: 3m (ABOUT)


GFA: 16 m² (ABOUT)

COVERED AREA: 16 m² (ABOUT)(INVOLVE RAIN SHELTER COVERED AREA)

Area of Structure 1 = 4530sq.m.

Total openable window area = 290 sq.m.

Y-TYPE STRAINER

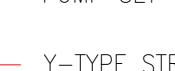

SPRINKLER INLET



RAIN SHELTER

GFA: 210 m² (ABOUT)

COVERED AREA: 210 m² (ABOUT)

PRESSURE GAUGE SPRINKLER HEAD (ON PLAN)

FIRE SERVICE CONTRACTOR

5KG DRY POWDER FIRE EXTINGUISHER

DATE C.K.NG 15 Oct 2024 CHECKED BY

DRAWING NO DRAWN BY SCALE :

PROJECT Proposed Temporary Logistics Centre for a Period of 3 Years at Lots 456R.P., 459, 460, 461, 462 and 2229R. P. in D.D. 83, Kwan Tei, Fanling, N.T.

DRAWING TITLE : F.S. Notes, Legend, **Fire Service Installation** Layout Plan

ARCHITECT :

DATE

CONSULTANT

Ramp 30ft(About)

Century Fire Service Engineering Co., Ltd.

FS-01 1:250 (A0) SOURCE: B.O.O. Ref. BD APPROVED BY F.S.D. Ref. FP

STRUCTURE B1


STOREY: 1

USE: LOGISTICS CENTRE

HEIGHT: 14m (ABOUT)

GFA: 4,530 m² (ABOUT)

COVERED AREA: 4,530 m² (ABOUT)

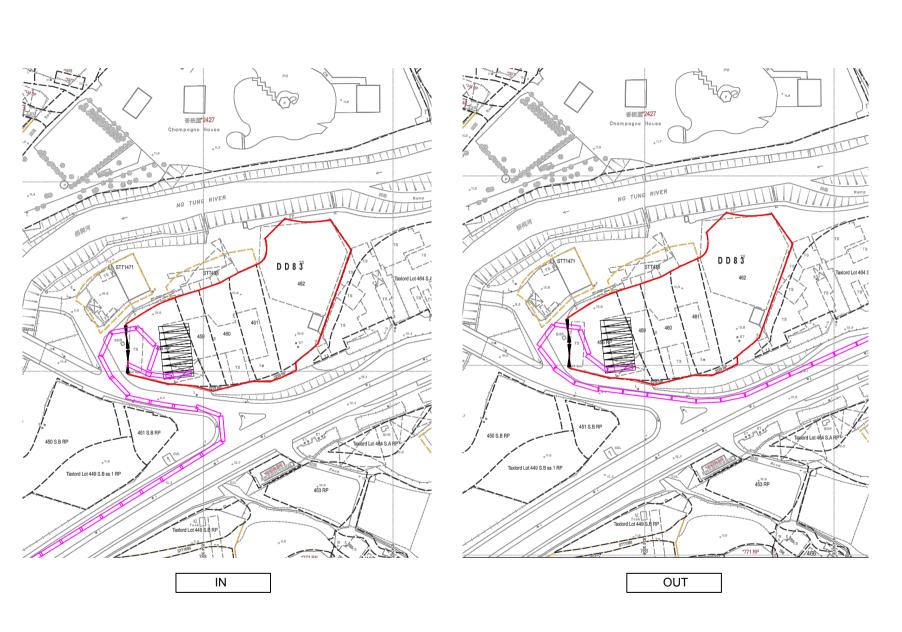





PROJEC

Proposed Temporary Logistics Centre fora period of 3 Year at lot 456R.p.,459,460,461,462 and 2229R.P. in D.D 83,Kwan Tei, Fanling, N.T

SITE LOCATI

VARIOUS LOTS IN D.D. 83 KWAN TEI FANLING

SCALE

1:1000@ A4

DRAWING TITLE

SWEPT PATH

J.W 12.12.2024

APPROVED BY DA

DWG NO.

PLAN 4

A-1

ISSUE 3

TEMPORARY DRAINAGE PROPOSAL (Final)

APPLICATION SITE OF THE PROPOSED TEMPORARY LOGISTICS CENTRE FOR A PERIOD OF 3 YEARS AT LOTS 456 RP, 459, 460, 461, 462 AND 2229 RP IN D.D. 83, KWAN TEI, FANLING, NEW TERRITORIES

PROJECT NO. AGLA/TDM/016

PREPARED FOR

APPLICATION NO. A/NE-TKL/773

16 December 2024

Table of Contents

1	Introduction		
	1.1	Background1	
	1.2	Objectives of the Report	
	1.3	Report Structure	
2	Deve	elopment Proposal1	
	2.1	Location of the Application Site	
3	Asse	ssment Criteria2	
	3.1	Design Return Periods	
	3.2	Calculation Methodology for Runoff	
	3.3	Calculation Methodology for Pipe Capacity Checking	
4	Pote	ntial Drainage Impact3	
-	4.1	Existing Site Condition	
	4.2	Changes in Drainage Characteristics	
	4.3	Potential Drainage Impact	
5	Cons	truction Stage4	
•	5.1	Temporary Drainage Arrangements	
6	Conc	lusions5	
Ū	6.1	Conclusion	
LI	ST OF	APPENDICES	
B. C. D. E.	. Desig	t Plan sed Drainage Plan n Calculation of the Proposed Drainage al Standard Drawings Of U-Channel and Catchpit	
LI	ST OF	TABLES	
Та	able 3 - 1	Recommended Design Return Periods based on Flood Levels	
Та	able 4 - 1	Change in sub-catchment within the site	
Та	able 4-2	Design calculation of the proposed drainage work4	

1 Introduction

1.1 Background

1.1.1 This report presents the Drainage Proposal for supporting the application site of the proposed temporary logistics centre for a period of 3 years at Lots 456 RP, 459, 460, 461, 462 and 2229 RP in D.D. 83, Kwan Tei, Fanling, New Territories. For the site location plan, please refer to the **Appendix A.**

1.2 Objectives of the Report

- 1.2.1 This report shall be prepared to include the following:
 - Identify the potential drainage impact assessment from the proposed Application Site
 - recommend and implement all necessary measures to mitigate adverse drainage impacts arising from the application site

1.3 Report Structure

- 1.3.1 The report contains the following sections:
 - Section 1 on Introduction;
 - Section 2 on Development Proposal;
 - Section 3 on Assessment Criteria;
 - Section 4 on Potential Drainage Impact; and
 - Section 5 on Conclusion.

2 Development Proposal

2.1 Location of the Application Site

- 2.1.1 The application Site is located within the Kwan Tei, Fanling with an area of around 6,300m² and ground level varying between + 11.4mPD and + 10.8mPD. The layout plan is provided in **Appendix B.**
- 2.1.2 This application site is "Open Storage" and "Agriculture" zoning, the type of application is the Temporary Use/Development in Rural Areas for a Period of 3 Years.

3 Assessment Criteria

3.1 Design Return Periods

3.1.1 The drainage system in the Application site is to collect surface flows and convey to downstream village drain. The recommended design return periods based on the flood levels for the various drainage systems depend on the drainage system, land use, hazard to public safety and community expectations. The recommended design return period is reproduced in Table 3-1 below:

Table 3-1 Recommended Design Return Periods based on Flood Levels

DESCRIPTION	DESIGN RETURN PERIODS
Intensively Used Agricultural Land	2 – 5 Years
Village Drainage including internal Drainage System under a polder Scheme	10 Years
Main Rural Catchment Drainage Channels	50 Years
Urban Drainage Trunk System	200 Years
Urban Drainage Branch System	50 Years

- 3.1.2 As per Storm Drainage Manuel (SDM) Section 6.6.2 Urban Drainage Branch and Urban Drainage Trunk Systems "An 'Urban Drainage Branch System' is defined as a group or network of connecting drains collecting runoff from the urban area and conveying stormwater to a trunk drain, river or sea. For a simple definition, the largest pipe size or the equivalent diameter in case of a box culvert in a branch system will normally be less than 1.8m.
- 3.1.3 An 'Urban Drainage Trunk System' collects stormwater from branch drains and/or river inlets, and conveys the flow to outfalls in river or sea. Pipes with size or diameter equal to or larger than 1.8m are normally considered as trunk drains."
- 3.1.4 As per SDM, since the proposed U-channels are sized smaller than 1.8m, the drainage system would be defined as an urban drainage branch with recommended design return period of 50 years.
- 3.1.5 The 10 years design return period will be considered to ensure adequacy of the stormwater drainage system.

3.2 Calculation Methodology for Runoff

3.2.1 Peak instantaneous runoff values before and after the development were calculated based on the Rational Method and with recommended physical parameters including runoff coefficient I and storm constants for different return periods referred to the SDM, based on the following equation:

$$Q_p = 0.278 \text{ C i A}$$

where $Q_p = Peak Runoff, m^3/s$ C = Runoff Coefficient i = Rainfall Intensity, mm/hr

A = Catchment Area, km²

- 3.2.2 The paved area of the site will account for 6,300 m². For conservative, the runoff coefficient of 0.95 is assumed, such that the all the run-off would be collected from the catchment area without any infiltration as the critical scenario.
- 3.2.3 Based on the storm constants for 10-year return period recommended in the SDM, the appropriate rainfall intensities (i) are calculated as detailed in **Appendix D**

3.3 Calculation Methodology for Pipe Capacity Checking

- 3.3.1 Because the catchment areas are less than 1ha, U-channels are recommended to be constructed to collect the stormwater runoff within the site. The collected stormwater should finally be diverted to the downstream via the proposed U-channel system.
- 3.3.2 For the worst-case scenario, bad condition of concrete pipe is assumed for the Manning's roughness coefficient (coefficient value is 0.016) for calculating capacities of concrete Uchannel using Manning's Equation.
- 3.3.3 Manning's Equation for calculating the channel and pipe capacities is adopted.

4 Potential Drainage Impact

4.1 Existing Site Condition

- 4.1.1 The application Site is located within the Kwan Tei, Fanling with an area of around 6,300m² and ground level varying between + 11.4mPD and + 10.8mPD.
- 4.1.2 Only the application site with a projected area of 6,300 m² is considered as part of the catchment. There is no external catchment were identified as the application site is generally higher than the adjacent land.

4.2 Changes in Drainage Characteristics

- 4.2.1 The characteristics of the sub-catchment areas are remained unchanged due to the temporary development for the application site, which are paved area.
- 4.2.2 The application site is fully covered by concrete surface currently. This application does not propose adding any additional concrete area, the difference in surface runoff that can be attributed to this application is negligible. The change in sub-catchment is summarized in Table 4-2.

Table 4-1 Change in sub-catchment within the site

	BEFORE	AFTER
Grassland (m²)	0	0
Unpaved Area (m²)	0	0
Paved Area (m²)	6,300	6,300
Total Catchment Area (m²)	6,300	6,300

4.3 Potential Drainage Impact

- 4.3.1 The details of the proposed drainage works are illustrated in **Appendix C**.
- 4.3.2 To effectively convey stormwater away from the application site and minimize the potential impact to the drainage infrastructure of the village area, drainage works consists of U-channels, are proposed to convey the flow to the terminate catchpit with trap (TCP).
- 4.3.3 The runoff from the Application site is collected by 600mm U-channels along the boundary and discharged to the catchpit with trap (TCP), which is connected to the further downstream leading to the discharge point of a well-established Existing Village via 600mm U-Channel at the southern direction of the application site.
- 4.3.4 The 450mm U-channel receives stormwater from the surface and the upstream catchment. For Conservative, the critical scenario is considered for collecting all the flow leading to the village drainage. The design calculation of the proposed drainage is provided in **Appendix D**.

Note:

- [1] Rainfall increase due to climate change at the end of 21st century is considered according to stormwater drainage manual Table 28.
- [2] The reserve capacity is calculated by assuming that the 450mm U-channel reach its full capacity for conservative.
- 4.3.5 The design runoff arise from the proposed Application Site is to be discharged into the proposed 450mm UC with gradient 1:100 and Ng Tung River.
- 4.3.6 Since there are no changes in Drainage Characteristics, it is considered that the drainage discharge from the Application Site will not cause adverse impact to the entire downstream drainage system.
- 4.3.7 All u-channels & catch pits will be constructed according to the CEDD's standard drawings, please refer to the **Appendix E.**

5 Construction Stage

5.1 Temporary Drainage Arrangements

- 5.1.1 Proper measures shall be taken to maintain the existing drainage characteristics of the catchment areas and to minimize drainage impacts associated with the construction works. The principal drainage impacts which are associated with construction of the works have been identified as follows:
 - (a) Erosion of ground materials;
 - (b) Sediment transportation to existing downstream drainage system; and
 - (c) Obstruction to drainage systems.
- 5.1.2 Regular inspections shall be carried out to ensure integrity of the works. These inspections shall cover works under construction as well as recently completed areas.

- 5.1.3 To ensure proper operation of the site drainage channels and desilting facilities, inspection of the perimeter drains shall be carried out on a weekly basis and the desilting facilities shall be cleaned on a daily basis.
- 5.1.4 If excavated materials are not possible to transport away the excavated material within the same day, the material should be covered by tarpaulin/impervious sheets. Stockpiles of construction materials (for examples aggregate, fill materials) of more than 50 m³ in an open area shall also be covered with tarpaulin or similar fabric during rainstorms.
- 5.1.5 All runoff discharged into the existing drainage system will be settled in a silt trap to ensure no sediment will be discharged into the channel. Silt traps will normally be provided along the site drainage immediately upstream of the proposed discharge point to the existing Site. The silt traps will be inspected daily and immediately after each rainstorm.
- 5.1.6 Liaison will be carried out with relevant parties regarding temporary drainage arrangements to ensure that the drainage system is functioning adequately.


6 Conclusions

6.1 Conclusion

- 6.1.1 The analysed catchment area of 6,300 m² consists of the site area of the proposed Application Site , with no external attachment area.
- 6.1.2 U-channels are proposed to convey runoff from the application site for collection. The proposed U-channels are located along the site boundary which is subject to change to suit the building layout.
- 6.1.3 The assessment reviews the drainage pipe have the sufficient capacity to cater for the drainage flow from the Application Site.
- 6.1.4 Mitigation measures are proposed during the application site proposed Application Site and to ensure that the existing drainage system within the site will not be affected during the construction stage.


END OF TEXT

APPENDIX A SITE LAYOUT PLAN

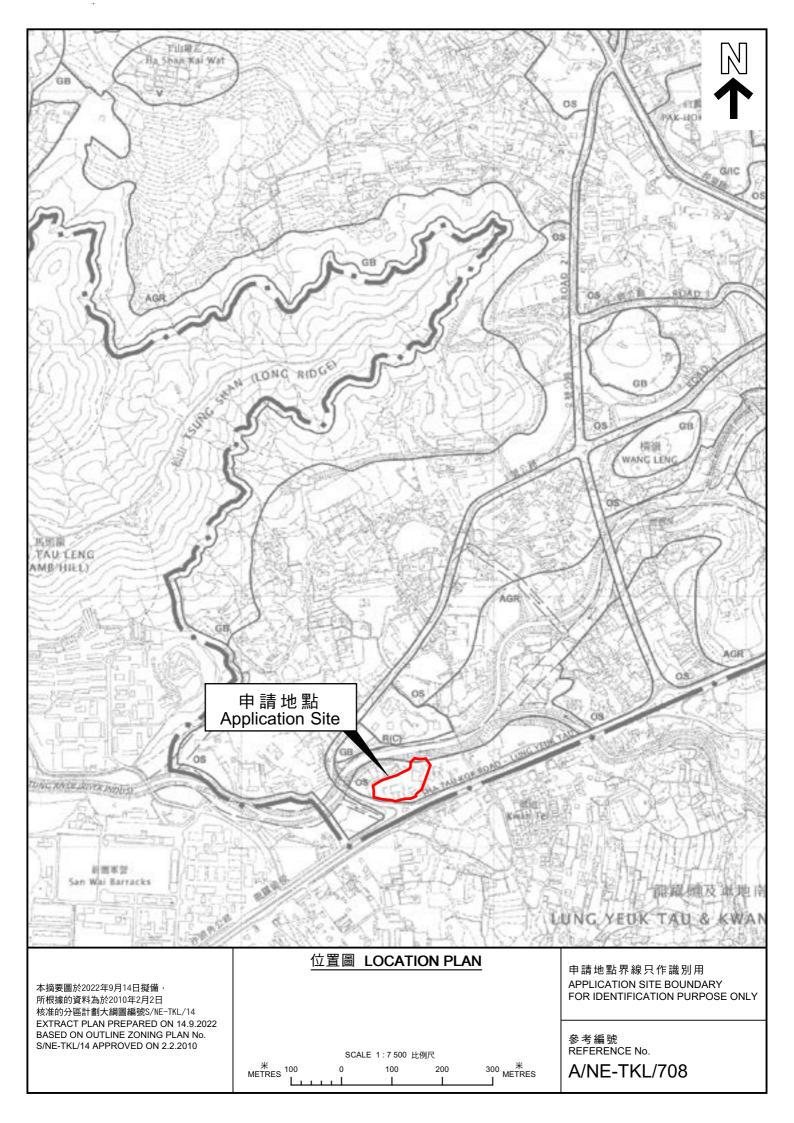


APPENDIX B

LAYOUT PLAN

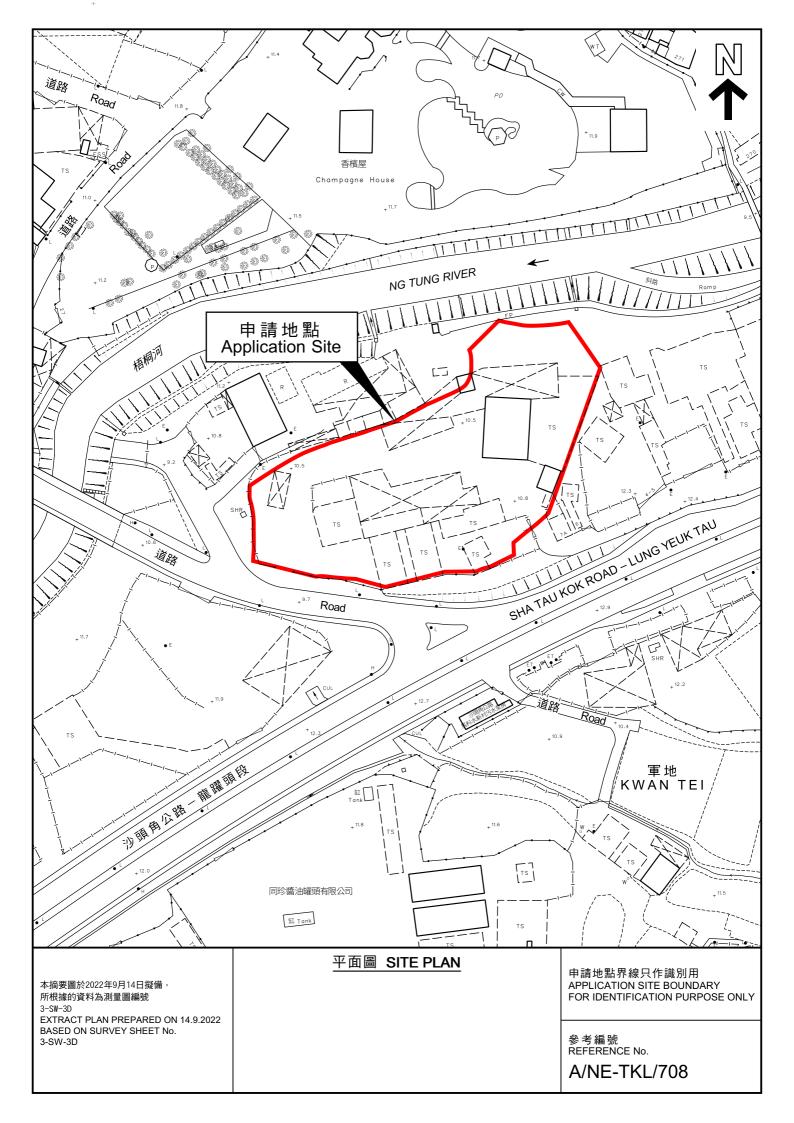

APPENDIX C
PROPOSED DRAINAGE PLAN

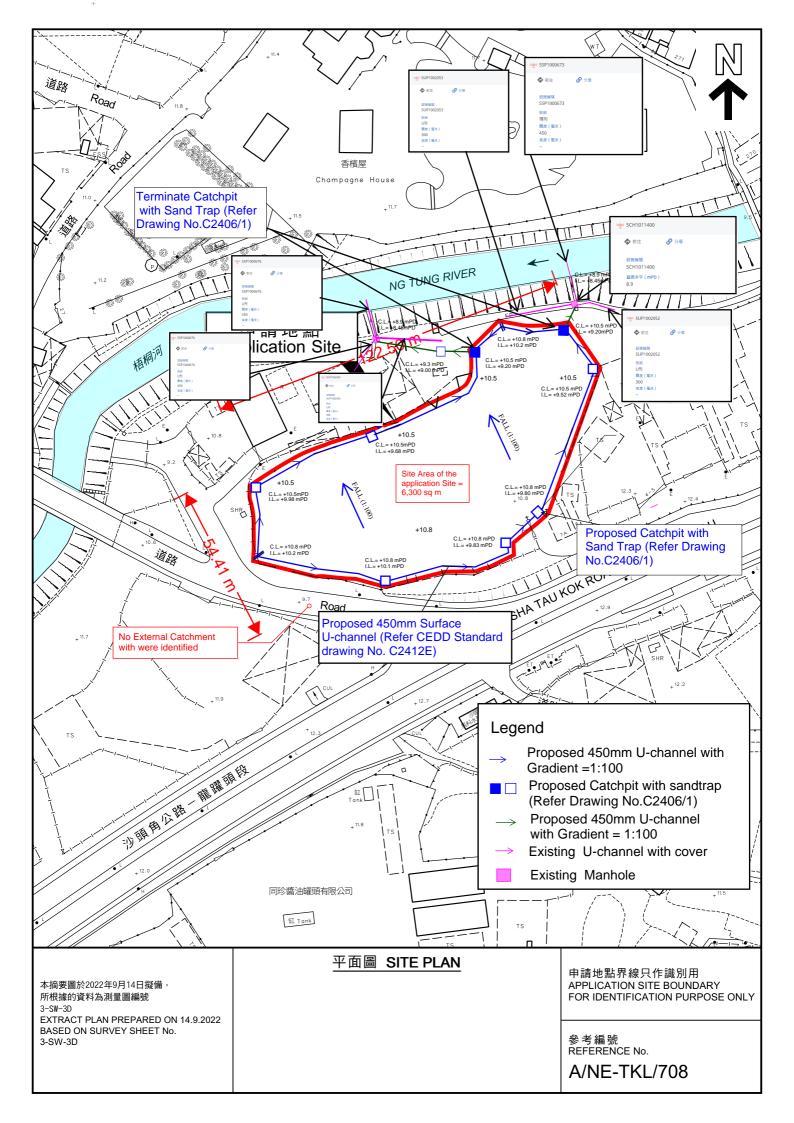

TEMPOP	APV D	DAINIAGE	PROPOSAL	(Einal)
IEIVIPUR	ARID	RAINAGE	PRUPUSAL	(Fillal)

APPENDIX D

DESIGN CALCULATION OF THE PROPOSED DRAINAGE

Company: Project:

Date: 20/8/2024

6300 Site Area = m2 (C = 0.95, hard-paved)

Outside Catchment Area = m2 (C=0.6, Grassland, heavy soil, Steep Slope) (Ratio of concrete paved: ratio of soil paved = 1:2) 0

Total Catchmnet Area= 6300 m2

$$I_o = \frac{0.14465L}{H^{0.3}A^{0.1}}$$

time of concentration of a natural catchment (min.)

catchment area (m2)

average slope (m per 100 m), measured along the line of natural flow, from the summit of the catchment to the point under consideration

distance (on plan) measured on the line of natural flow between the summit and the point under consideration

$$i = \frac{a}{(r_c + b)^c}$$

where - extreme mean intensity in mm/hr,

= duration in minutes (t_d < 240), and

a, b, c = storm constants given in Tables 3a, 3b, 3c and 3d.

Assume 10 yrs return period

a = 1157.7b= 19.04 c = 0.597

i = 174.996504 mm/hr

Therefore, i = 180mm/hr take

Company: Project:	
Date:	20/8/2024
Calculation for channels:	


Catchment Area of site

Site Area	= =	6300 0.0063	m^2 km^2							
Peak runoff in m^3/s	= = =	0.278 0.299489 17969	x m^3/s liter/min	0.95	X	180	mm/hr	X	0.0063	km^2
Outside Area	= =	0	m^2 km^2							
Peak runoff in m^3/s	= = =	0.278 0 0	x m^3/s liter/min	0.6	X	180	mm/hr	X	0	km^2
Total Peak Runoff for Site	=	0.299489	m^3/s	=		17969.364			liter/min	

Collected Surface runoff will be divided into two paths and two independent drainage path in the site can collect half of catchment Area (site area)

Peak runoff for half area = 0.150 m/3/s = 8985 liter/min

For checking existing 450UC

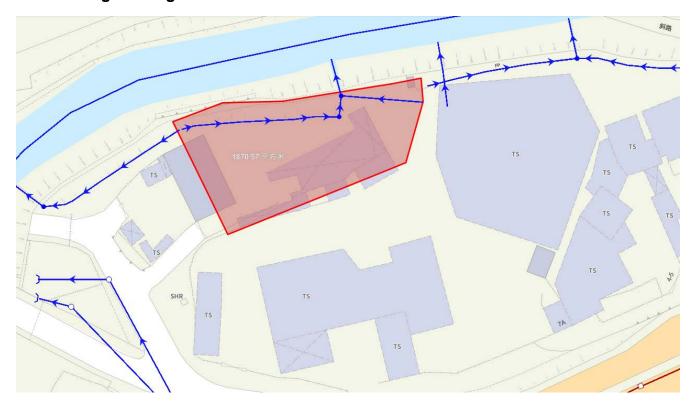

(i) Catchment Area = 1871m2 for Existing 450 UC



(ii) Catchment Area = 763m2 for Existing 450 UC

(i) Case is critical and adopted. Total Surface Runoff for Existing 450UC = $8985 + 0.278(180)(1871 \times 10^{-6})/60/1000$ = 14602 lit/hr

utilisation of the proposed drainage :450UC = 14602 /20000 = 73%

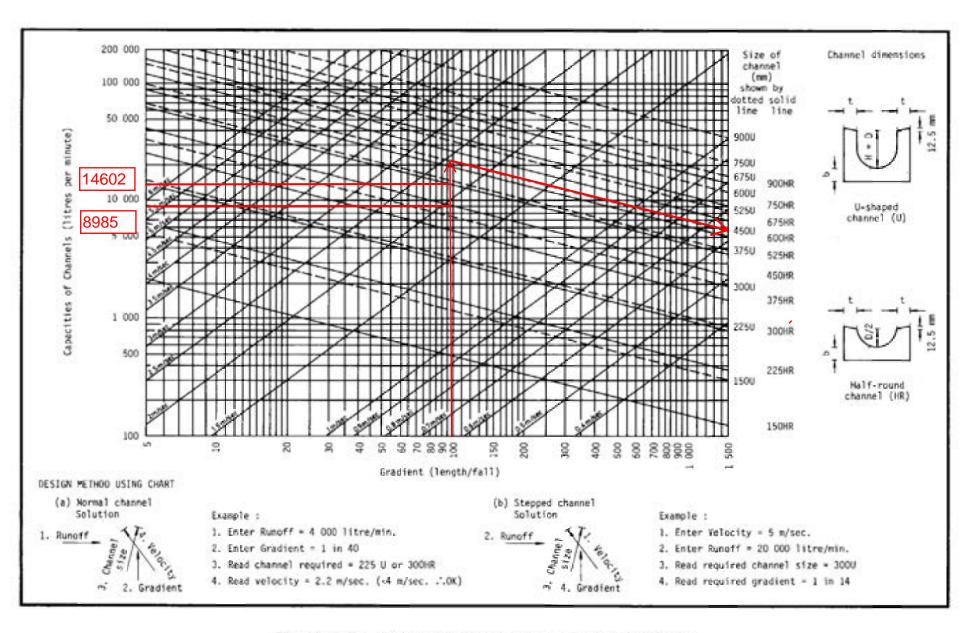



Figure 8.7 - Chart for the Rapid Design of Channels

As a result, 450UC in proposed site can cater the surface runoff and Existing 450UC can cater additional surface runoff from proposed development.

APPENDIX E

TYPICAL STANDARD DRAWINGS OF U-CHANNEL AND CATCHPIT

(EXTRACTED FROM CEDD, FOR REFERNCE ONLY)

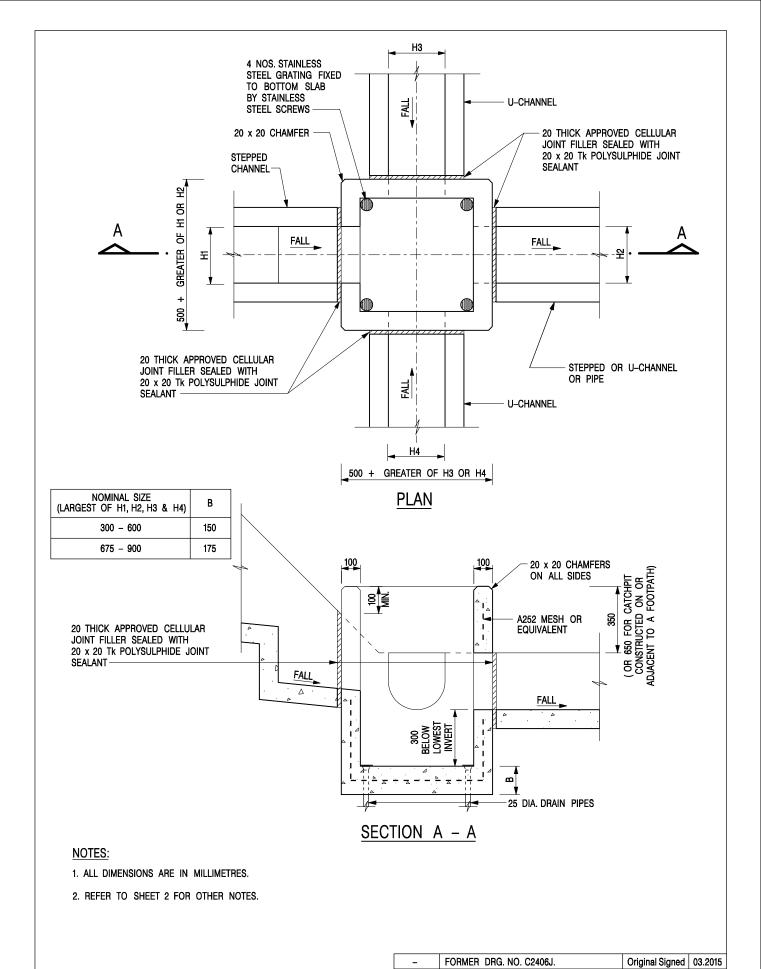

CATCHPIT WITH TRAP
(SHEET 1 OF 2)

CIVIL ENGINEERING AND DEVELOPMENT DEPARTMENT

SCALE 1:20 DRAWING NO.

REVISION


DATE JAN 1991

REF.

C2406 /1

SIGNATURE DATE

卓越工程 建設香港

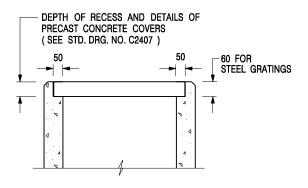

ALTERNATIVE TOP SECTION FOR PRECAST CONCRETE COVERS / GRATINGS

NOTES:

- 1. ALL DIMENSIONS ARE IN MILLIMETRES.
- 2. ALL CONCRETE SHALL BE GRADE 20 /20.
- 3. CONCRETE SURFACE FINISH SHALL BE CLASS U2 OR F2 AS APPROPRIATE.
- 4. FOR DETAILS OF JOINT, REFER TO STD. DRG. NO. C2413.
- 5. CONCRETE TO BE COLOURED AS SPECIFIED.
- UNLESS REQUESTED BY THE MAINTENANCE PARTY AND AS DIRECTED BY THE ENGINEER, CATCHPIT WITH TRAP IS NORMALLY NOT PREFERRED DUE TO PONDING PROBLEM.
- 7. UPON THE REQUEST FROM MAINTENANCE PARTY, DRAIN PIPES AT CATCHPIT BASE CAN BE USED BUT THIS IS FOR CATCHPITS LOCATED AT SLOPE TOE ONLY AND AS DIRECTED BY THE ENGINEER.
- FOR CATCHPITS CONSTRUCTED ON OR ADJACENT TO A FOOTPATH, STEEL GRATINGS (SEE DETAIL 'A' ON STD. DRG. NO. C2405 /2) OR CONCRETE COVERS (SEE STD. DRG. NO. C2407) SHALL BE PROVIDED AS DIRECTED BY THE ENGINEER.
- 9. IF INSTRUCTED BY THE ENGINEER, HANDRAILING (SEE DETAIL 'J' ON STD. DRG. NO. C2405 /5; EXCEPT ON THE UPSLOPE SIDE) IN LIEU OF STEEL GRATINGS OR CONCRETE COVERS CAN BE ACCEPTED AS AN ALTERNATIVE SAFETY MEASURE FOR CATCHPITS NOT ON A FOOTPATH NOR ADJACENT TO IT. TOP OF THE HANDRAILING SHALL BE 1 000 mm MIN. MEASURED FROM THE ADJACENT GROUND LEVEL.
- 10. MINIMUM INTERNAL CATCHPIT WIDTH SHALL BE 1 000 mm FOR CATCHPITS WITH A HEIGHT EXCEEDING 1 000 mm MEASURED FROM THE INVERT LEVEL TO THE ADJACENT GROUND LEVEL. AND, STEP IRONS (SEE DSD STD. DRG. NO. DS1043) AT 300 c/c STAGGERED SHALL BE PROVIDED. THICKNESS OF CATCHPIT WALL FOR INSTALLATION OF STEP IRONS SHALL BE INCREASED TO 150 mm.
- 11. FOR RETROFITTING AN EXISTING CATCHPIT WITH STEEL GRATING, SEE DETAIL 'G' ON STD. DRG. NO. C2405 /4.
- SUBJECT TO THE APPROVAL OF THE ENGINEER, OTHER MATERIALS CAN ALSO BE USED AS COVERS / GRATINGS.

REF.	REVISION	SIGNATURE	DATE
-	FORMER DRG. NO. C2406J.	Original Signed	03.2015
Α	MINOR AMENDMENT.	Original Signed	04.2016

CATCHPIT WITH TRAP (SHEET 2 OF 2)


卓越工程 建設香港



CIVIL ENGINEERING AND DEVELOPMENT DEPARTMENT

SCALE 1:20 **DATE** JAN 1991

DRAWING NO. C2406 /2A

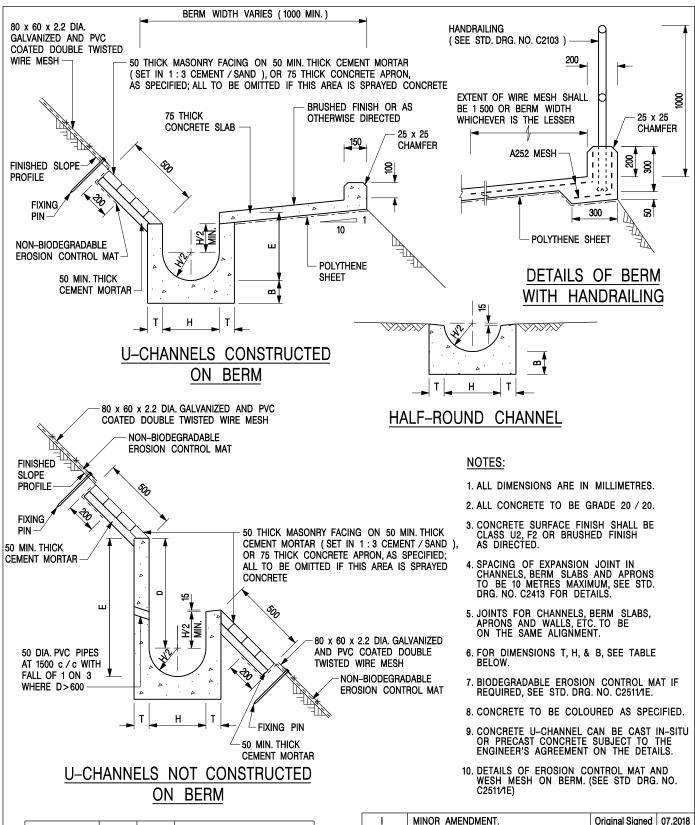

NOMINAL SIZE H	Т	В	REINFORCEMENT
300	80	100	A252 MESH PLACED CENTRALLY AND T=100
375 - 600	100	150	WHEN E>650
675 - 900	125	175	A252 MESH PLACED

ı	MINOR AMENDMENT.	Original Signed	07.2018
Н	THICKNESS OF MASONRY FACING AMENDED.	Original Signed	01.2005
G	MINOR AMENDMENT.	Original Signed	01.2004
F	GENERAL REVISION.	Original Signed	12.2002
E	DRAWING TITLE AMENDED.	Original Signed	11.2001
D	MINOR AMENDMENT.	Original Signed	08.2001
С	150 x 100 UPSTAND ADDED AT BERM.	Original Signed	6.99
B MINOR AMENDMENTS.		Original Signed	3.94
REF.	REVISION	SIGNATURE	DATE

DETAILS OF HALF-ROUND AND U-CHANNELS (TYPE A -WITH MASONRY APRON


卓越工程 建設香港

CENTRALLY




CIVIL ENGINEERING AND **DEVELOPMENT DEPARTMENT**

DRAWING NO. SCALE 1:25 C24091 DATE JAN 1991

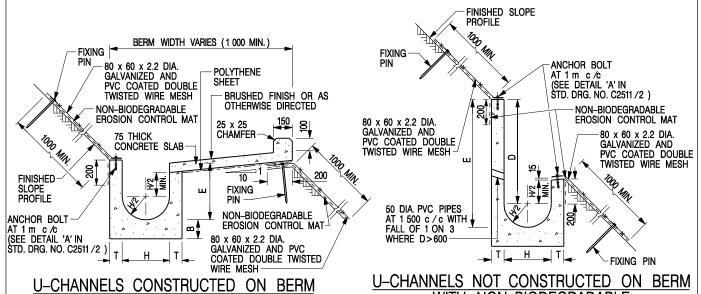

U-CHANNELS CONSTRUCTED ON BERM WITH NON-BIODEGRADABLE EROSION CONTROL MAT <u>J-CHANNELS NOT CONSTRUCTED ON BERM</u>
<u>WITH NON-BIODEGRADABLE</u>
EROSION CONTROL MAT

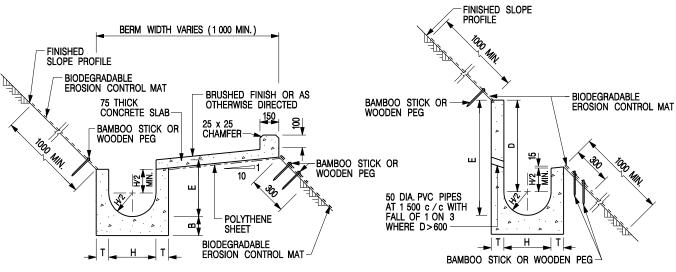

U-CHANNELS CONSTRUCTED ON BERM WITH BIODEGRADABLE EROSION CONTROL MAT

U-CHANNELS NOT CONSTRUCTED ON BERM WITH BIODEGRADABLE EROSION CONTROL MAT

NOTES:

- 1. ALL DIMENSIONS ARE IN MILLIMETRES.
- 2. ALL CONCRETE TO BE GRADE 20 /20.
- 3. CONCRETE SURFACE FINISH SHALL BE CLASS U2, F2 OR BRUSHED FINISH AS DIRECTED.
- 4. SPACING OF EXPANSION JOINT IN CHANNELS, BERM SLABS AND APRONS TO BE 10 METRES MAXIMUM, SEE STD. DRG. NO. C2413 FOR DETAILS.
- 5. JOINTS FOR CHANNELS, BERM SLABS, APRONS AND WALLS, ETC. TO BE ON THE SAME ALIGNMENT.
- 6. FOR DIMENSIONS T, H, & B, SEE TABLE BELOW.
- FOR TYPICAL FIXING PIN DETAILS, SEE STD. DRG. NO. C2511/2.
- 8. MINIMUM SIZE OF 25 x 50 x 300mm SHALL BE PROVIDED FOR WOODEN PEG.
- MINIMUM SIZE OF 10mm DIAMETER WITH 200mm LONG SHALL BE PROVIDED FOR BAMBOO STICK.
- 10. THE FIXING DETAILS OF NON-BIODEGRADABLE AND BIODEGRADABLE EROSION CONTROL MATS ON EXISTING BERM SHALL REFER TO STD. DRG. NO. C2511/1.

NOMINAL SIZE H	Т	В	REINFORCEMENT
300	80	100	A252 MESH PLACED CENTRALLY AND T=100
375 - 600	100	150	WHEN E>650
675 - 900	125	175	A252 MESH PLACED CENTRALLY

DETAILS OF HALF-ROUND AND U-CHANNELS (TYPE B - WITH EROSION CONTROL MAT APRON)

REF.	REF. REVISION		DATE
Α	A MINOR AMENDMENT.		10.92
В	MINOR AMENDMENT.	Original Signed	3.94
С	150 x 100 UPSTAND ADDED AT BERM.	Original Signed	6.99
D	MINOR AMENDMENT.	Original Signed	08.2001
E	GENERAL REVISION.	Original Signed	12.2002
F	MINOR AMENDMENT.	Original Signed	01.2004
G	DIMENSION TABLE AMENDED.	Original Signed	01.2005
Н	FIXING DETAILS OF BIODEGRADABLE EROSION CONTROL MAT ADDED.	Original Signed	12.2017
1	MINOR AMENDMENT.	Original Signed	07.2018




CIVIL ENGINEERING AND DEVELOPMENT DEPARTMENT


SCALE DIAGRAMMATIC

DATE JAN 1991

DRAWING NO. C24101

卓越工程 建設香港

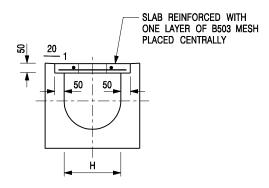

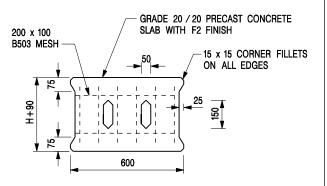



TYPICAL SECTION

PLAN OF SLAB

U-CHANNELS WITH PRECAST CONCRETE SLABS

(UP TO H OF 525)

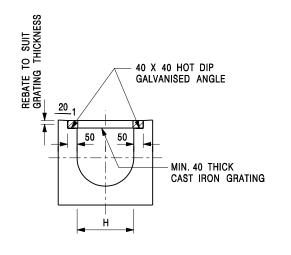

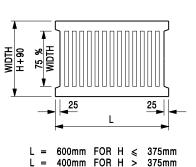

TYPICAL SECTION

CAST IRON GRATING

(DIMENSIONS ARE FOR GUIDANCE ONLY, CONTRACTOR MAY SUBMIT EQUIVALENT TYPE)

U-CHANNEL WITH CAST IRON GRATING

(UP TO H OF 525)

NOTES:

- 1. ALL DIMENSIONS ARE IN MILLIMETRES.
- 2. H=NOMINAL CHANNEL SIZE.
- 3. ALL CAST IRON FOR GRATINGS SHALL BE GRADE EN-GJL-150 COMPLYING WITH BS EN 1561.
- 4. FOR COVERED CHANNELS TO BE HANDED OVER TO HIGHWAYS DEPARTMENT FOR MAINTENANCE, THE GRATING DETAILS SHALL FOLLOW THOSE AS SHOWN ON HyD STD. DRG. NO. H3156.

Е	NOTES 3 & 4 AMENDED.	Original Signed	12.2014
D	NOTE 4 ADDED.	Original Signed	06.2008
С	MINOR AMENDMENT. NOTE 3 ADDED.	Original Signed	12.2005
В	NAME OF DEPARTMENT AMENDED.	Original Signed	01.2005
Α	CAST IRON GRATING AMENDED.	Original Signed	12.2002
REF.	REVISION	SIGNATURE	DATE

COVER SLAB AND CAST IRON GRATING FOR CHANNELS


CEDD

CIVIL ENGINEERING AND DEVELOPMENT DEPARTMENT

 SCALE 1:20
 DRAWING NO.


 DATE JAN 1991
 C2412E

卓越工程 建設香港

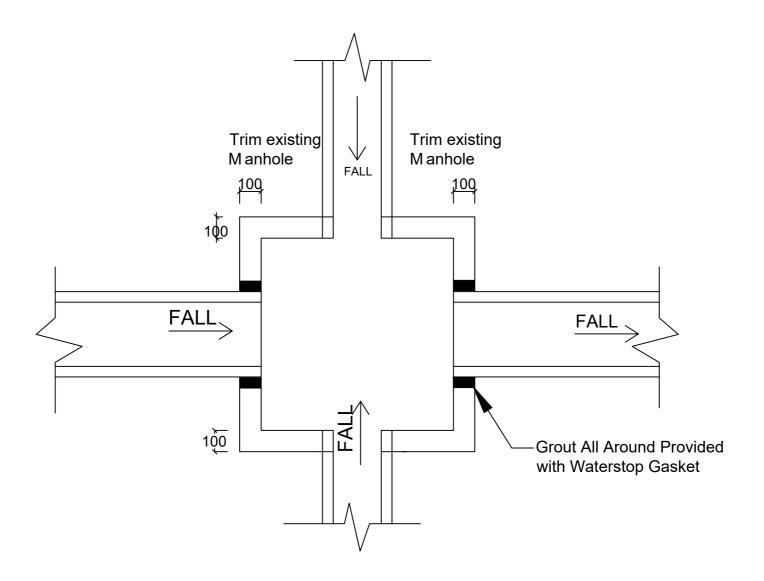

Connection Detail of SCH1011400 and SCH1011402

APPENDIX F
SITE PHOTO

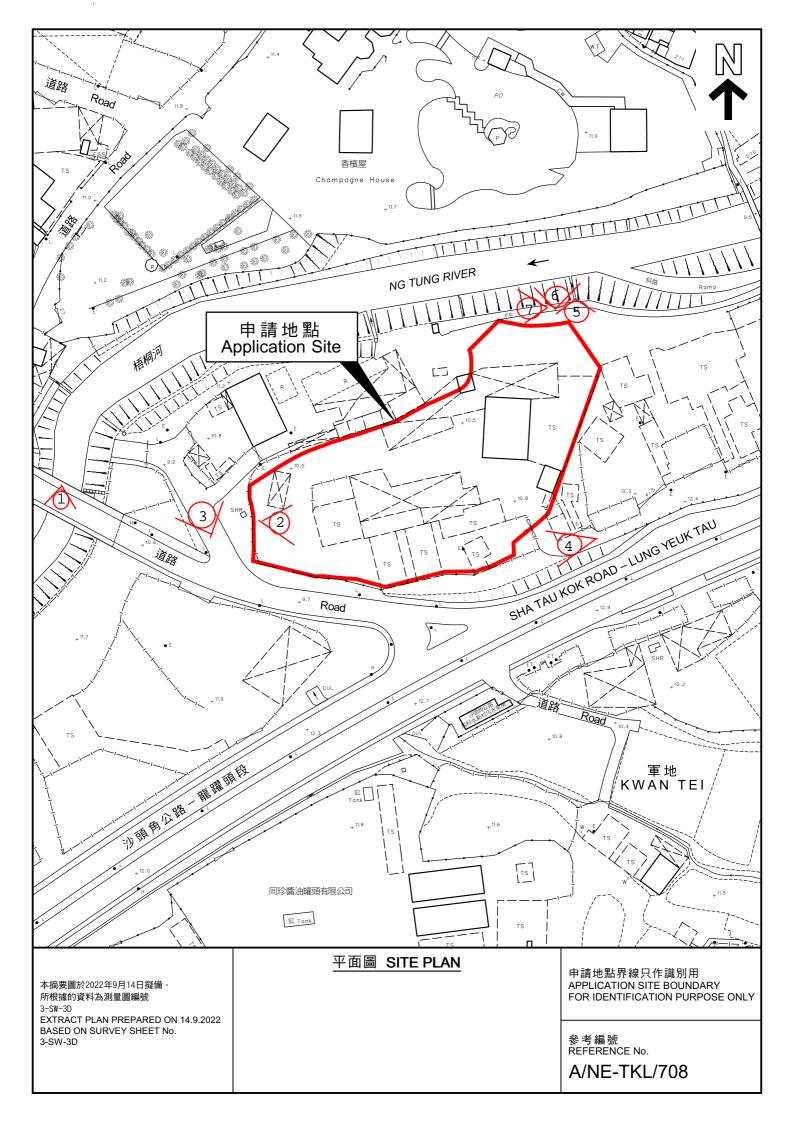



VIEW 1: Existing Nullah Ng Tung River



VIEW 2: Entrance of the Site



VIEW 3: Entrance of the Site



VIEW 4: Outside of the Site



VIEW 5: Existing Final Discharge



VIEW 6: Existing UC



VIEW 7: Existing UC

□Urgent □Return receipt □Expand Group □Restricted □Prevent Copy □Confidential							
Timothy Wai Pui WU/PLAND							
寄件者: 寄件日期: 收件者: 副本: 主旨: 附件:	2025年04月14日星期一 17:16 tpbpd/PLAND Timothy Wai Pui WU/PLAND 有關A/NE-TKL/773 運輸署及漁農自然護理署意見回覆 TKL773-SWEPT PATH_20250401.pdf; TKL773部門意見回覆_20250401.pdf						
類別:	Internet Email						
敬啟者,							
有關 A/NE-TKL/773 運輸署及	漁農自然護理署意見回覆可見附件。						
如有任何查詢,可隨時與本力	如有任何查詢,可隨時與本人聯絡。						
黄先生 電話:							

A/NE-TKL/773

部門意見回覆

運輸署


As container vehicle is an articulated vehicle, both the	見附件 Plan4 Swept Path
tractor and the trailer should be shown in the swept	
path. The swept path submitted by the applicant	
showed the movement of a rigid vehicle only.	
Continuous lines should be used in swept path	
analysis to show the path of the outermost	
extremities on the lateral sides of the vehicle all along	
its movement. Please also indicate the type and	
dimensions of the vehicle used in swept path analysis.	
For the swept path for entering the parking space, the	見附件 Plan4 Swept Path
vehicle seems to be clashing with the gate. Please	場內出入閘口濶度為約24米並
review.	會保持打開。
It is noted that the site entrance is only wide enough	全部進出時間皆為預約制,需
for one-way traffic flow at the entrance of the site at a	要通知場內工作人員作安排,
time. Please advise the management measures to	所以不會造成同一時間有車進
avoid simultaneous two-way traffic at the entrance of	入及離開。
the site.	
Please clarify whether the gate will be kept open	場內出入閘口會保持打開。
during working hours.	

漁農自然護理署

The subject site falls within the "AGR" and "OS" zones and is generally vacant with some structures.

Agricultural infrastructures such as road access and water source are available. The subject site can be used for agricultural activities such as open-field cultivation, greenhouses, plant nurseries, etc. As the subject site possesses potential for agricultural rehabilitation, the proposed development is not supported from agricultural perspective.

本擬議發展涉及先前一個獲批 的申請:A/NE-TKL/708,全部 發展參數相同,因此有關 AGR 面積一早已作平整,而申請人 亦有考慮早後所以沒有在上述 範圍興建物流中心。

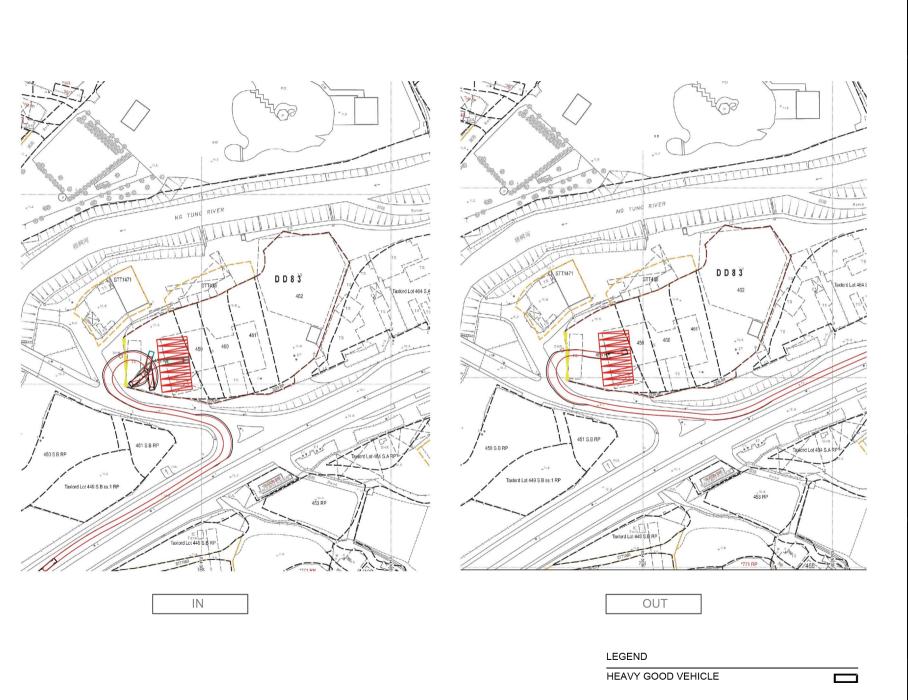





PROJEC:

PROPOSED TEMPORARY LOGISTICS CENTRE FOR A PERIOD OF 3 YEAR

SITE LOCATION

LOTS 456R.P, 459, 460, 461, 462 AND 2229R.P. IN D.D 83,KWAN TEI, FANLING, N.T

SCALE

1:1000@ A4

DRAWING TITL

SWEPT PATH

J.W

01.04.2025

APPROVED BY DA

DWG NO. PLAN 4

A-1

Relevant Extracts of Town Planning Board Guidelines on Application for Open Storage and Port Back-up Uses (TPB PG-No. 13G)

- 1. On 14.4.2023, the Town Planning Board Guidelines for Application for Open Storage and Port Back-up Uses under Section 16 of the Town Planning Ordinance (TPB PG-No. 13G) were promulgated, which set out the following criteria for the various categories of area:
 - (a) Category 1 areas: favourable consideration will normally be given to applications within these areas, subject to no major adverse departmental comments and local objections, or the concerns of the departments and local residents can be addressed through the implementation of approval conditions. Technical assessments should be submitted if the proposed uses may cause significant environmental and traffic concerns;
 - (b) Category 2 areas: planning permission could be granted on a temporary basis up to a maximum period of 3 years, subject to no adverse departmental comments and local objections, or the concerns of the departments and local residents can be addressed through the implementation of approval conditions. Technical assessments, where appropriate or if required, should be submitted to demonstrate that the proposed uses would not have adverse drainage, traffic, visual, landscaping and environmental impacts on the surrounding areas;
 - (c) Category 3 areas: applications would normally not be favourably considered unless the applications are on sites with previous planning approvals (irrespective of whether the application is submitted by the applicant of previous approval or a different applicant). Sympathetic consideration may be given if genuine efforts have been demonstrated in compliance with approval conditions of the previous planning applications and/or relevant technical assessments/proposals have been included in the fresh applications, if required, to demonstrate that the proposed uses would not generate adverse drainage, traffic, visual, landscaping and environmental impacts on the surrounding areas. Planning permission could be granted on a temporary basis up to a maximum period of 3 years, subject to no adverse departmental comments and local objections, or the concerns of the departments and local residents can be addressed through the implementation of approval conditions; and
 - (d) Category 4 areas: applications would normally be rejected except under exceptional circumstances. For applications on sites with previous planning approvals (irrespective of whether the application is submitted by the applicant of previous approval or a different applicant), and subject to no adverse departmental comments and local objections, sympathetic consideration may be given if genuine efforts have been demonstrated in compliance with approval conditions of the previous planning applications and/or relevant technical assessments/proposals have been included in the fresh applications, if required, to demonstrate that the proposed uses would not generate adverse drainage, traffic, visual, landscaping and environmental impacts on the surrounding areas. The intention is however to encourage the phasing out of such non-conforming uses as early as possible. Planning permission for a maximum period of 3 years may be allowed for an applicant to identify suitable sites for relocation. Application for renewal of approval will be assessed on its individual merits.

- 2. In assessing applications for open storage and port back-up uses, the other major relevant assessment criteria are also summarised as follows
 - (a) port back-up sites and those types of open storage generating adverse noise, air pollution and visual intrusion and frequent heavy vehicle traffic should not be located adjacent to sensitive receivers such as residential dwellings, hospitals, schools and other community facilities;
 - (b) adequate screening of the sites through landscaping and/or fencing should be provided where sites are located adjacent to public roads or are visible from surrounding residential areas;
 - (c) port back-up uses are major generators of traffic, with container trailer/tractor parks generating the highest traffic per unit area. In general, port back-up sites should have good access to the strategic road network, or be accessed by means of purpose built roads;
 - (d) to minimise environmental nuisances generated by open storage and port back-up uses, such as air and noise pollution, the environmental measures recommended in the latest "Code of Practice on Handling the Environmental Aspects of Temporary Uses & Open Storage Sites" issued by Environmental Protection Department should be adopted;
 - (e) there is a general presumption against conversion of agricultural land and fish ponds to other uses on an ad-hoc basis, particularly in flood prone areas or sites which would obstruct natural drainage channels and overland flow; and
 - (f) for applications involving sites with previous planning approvals, should there be no evidence to demonstrate that the applicants have made any genuine effort to comply with the approval conditions of the previous planning applications, planning permission may be refused, notwithstanding other criteria set out in the Guidelines are complied with

Previous S.16 Applications

Approved Applications

	Application No.	<u>Uses/Developments</u>	<u>Date of</u> <u>Consideration</u>
1.	A/NE-TKL/50	Temporary Marble Workshop for a Period of 12 Months	24.10.1997
2.	A/NE-TKL/73	Open Storage of Scrap Metal for a Temporary Period of 12 Months	6.3.1998
3.	A/NE-TKL/102	Marble workshop and open storage of marbles for a temporary period of 12 months	22.1.1999
4.	A/NE-TKL/148	Temporary Open Storage of Marble and Steel Materials for Construction, and Vehicle Repair Workshop for a Period of 3 Years	13.10.2000 (Revoked on 13.7.2001)
5.	A/NE-TKL/154	Temporary Marble Workshop and Open Storage of Marble for a Period of 3 Years	22.12.2000 (Revoked on 22.9.2001)
6.	A/NE-TKL/708	Temporary Logistics Centre for a Period of 3 Years	17.3.2023 (Revoked on 17.9.2024)

Government Departments' General Comments

1. Landscape

Comments of the Chief Town Planner/Urban Design and Landscape, Planning Department (CTP/UD&L, PlanD):

- no adverse comment on the application from the landscape planning perspective;
- with reference to the aerial photo of 2023, the Site is located in an area of miscellaneous rural fringe landscape character comprising temporary structures, open storages and clusters of tree groups. The applied use is considered not incompatible with its surrounding environment;
- based on the site photos taken on 2.5.2025, the Site is hard-paved and occupied by temporary structures. Few trees are observed at the periphery of the Site. According to the Application Form, there will be no tree felling. Significant adverse impact on the existing landscape resources within the Site arising from the applied use is not anticipated; and
- her advisory comments are at **Appendix V**.

2. Drainage

Comments of the Chief Engineer/Mainland North, Drainage Services Department (CE/MN, DSD):

- no objection to the application from the public drainage viewpoint;
- the submitted drainage proposal is considered acceptable;
- should the application be approved, condition should be included to request the applicant to implement the accepted drainage proposal for the Site to ensure that it will not cause adverse drainage impact on the adjacent areas, and the implemented drainage facilities at the Site shall be maintained at all times during the planning approval period;
- the Site is in the vicinity of the existing Ng Tung River to the north of the Site. Should the application be approved, the applicant shall be required to place all the proposed works at least 3m away from the top of the bank of Ng Tung River. All the proposed works in the vicinity of Ng Tung River should not create any adverse drainage impacts, both during and after construction;
- the Site is in an area where public sewerage connection is available; and
- her advisory comments are at **Appendix V**.

3. Environment

Comments of the Director of Environmental Protection (DEP):

- despite the use of heavy vehicles near residential buildings within 100m of the site boundary, he understands that the applied use will be covered, and the loading/unloading spaces are located at the west of the Site to maximise the distance to sensitive receivers. He has no objection to the application from the environmental planning perspective;
- no environmental complaint against the Site was received in the past three years; and
- his advisory comments are at **Appendix V**.

4. Fire Safety

Comments of the Director of Fire Services (D of FS):

- no objection in principle to the proposal subject to fire service installations (FSIs) and water supplies for firefighting being provided to his satisfaction;
- no objection to the FSIs proposal submitted by the applicant. The applicant should submit a full set of "Certificate of Fire Service Installation and Equipment" (FS 251) which should be incorporated all FSIs proposed in the accepted FSIs proposal for his further arrangement of FSIs acceptance inspection; and
- his advisory comments are at Appendix V.

5. **Building Matters**

Comments of the Chief Building Surveyor/New Territories West, Buildings Department (CBS/NTW, BD):

- no objection to the application; and
- it is noted that four number of temporary structures are proposed in the application. Before any new building works (including containers/open sheds as temporary buildings, demolition and land filling, etc.) are to be carried out on the Site, prior approval and consent of the Building Authority should be obtained, otherwise they are unauthorized building works (UBW) under the Building Ordinance (BO). An Authorized Person should be appointed as the co-ordinator for the proposed building works in accordance with the BO.

6. Other Departments

The following government departments have no objection to/no comments on the application:

- (a) Commissioner for Transport (C for T);
- (b) Project Manager (North), Civil Engineering and Development Department (PM(N), CEDD);
- (c) Chief Engineer/Construction, Water Supplies Department (CE/C, WSD);
- (d) Chief Highway Engineer/New Territories East, Highways Department (CHE/NTE, HyD); and
- (e) District Officer (North), Home Affairs Department (DO(N), HAD)

Recommended Advisory Clauses

- (a) prior planning permission should have been obtained before commencing the applied use at the application site (the Site);
- (b) to resolve any land issue relating to the applied use with the concerned owner(s) of the Site;
- (c) should the applicant fails to comply with the approval conditions again resulting in the revocation of the planning permission, sympathetic consideration may not be given to any further application;
- (d) to note the comments of the District Lands Officer/North, Lands Department (DLO/N, LandsD) that:
 - (i) Lot Nos. 456 RP, 459, 460, 461, 462 and 2229 RP in D.D. 83 in the Site are either held under the Block Government Lease or New Grant for agriculture purpose only and no structure shall be erected on the lots. No right of access via Government land (GL) is granted to the Site;
 - (ii) the unauthorised structures as mentioned in paragraph (d) (iii) below had been stated in the previously approved planning application (No. A/NE-TKL/708), however, no rectification had been carried out as demanded;
 - (iii) the following irregularity covered by the planning application has been detected by his office:

unauthorised structures within the said private lots covered by the planning application

there are unauthorised structures on the private lots. The lot owners should immediately rectify the lease breaches and his office reserves the rights to take necessary lease enforcement action against the breaches without further notice. LandsD has reservation on the planning application since there are unauthorised structures on Lot No. 456 RP in D.D. 83 which are already subject to lease enforcement actions according to case priority. The lot owner should rectify the lease breaches as demanded by LandsD;

(iv) the following irregularity not covered by the planning application has been detected by his office:

unlawful occupation of GL not covered by the planning application

the GL adjoining the Site has been fenced off and illegally occupied with unauthorised structure without permission. The GL being illegally occupied is not included in the application. Any occupation of GL without Government's prior approval is an offence under Cap. 28. The lot owners/applicant should immediately cease the illegal occupation of GL and remove the unauthorised structure. His office reserves the rights to take necessary land control action against the illegal occupation of GL without further notice; and

(v) the lot owners/applicant shall remove the unauthorised structure and cease the illegal occupation of the GL not covered by the subject planning application immediately; and subject to the approval of the Town Planning Board to the planning application which shall

have reflected the rectification as aforesaid required, apply to his office for Short Term Waiver (STW) to permit the structures erected/to be erected. The application for STW will be considered by the Government in its capacity as a landlord and there is no guarantee that it will be approved. The STW, if approved, will be on whole lot basis and subject to such terms and conditions including certification for structural safety of the unauthorised structures, the payment of back-dated waiver fee from the first date the unauthorised structures were erected and administrative fee as considered appropriate to be imposed by LandsD. In addition, LandsD reserves the right to take enforcement action against the lot owners/applicant for any breach of the lease conditions, including the breaches already in existence or to be detected at any point of time in future and land control action for any unlawful occupation of GL. Besides, given the applied use is temporary in nature, only erection of temporary structure(s) will be considered;


- (e) to note the comments of the Commissioner for Transport (C for T) that the vehicular access between the Site and Sha Tau Kok Road is not managed by the Transport Department (TD) and the applicant should seek comments from the responsible party;
- (f) to note the comments of the Chief Highway Engineer/New Territories East, Highways Department (CHE/NTE, HyD) that:
 - (i) the proposed access arrangement of the Site should be commented and approved by TD;
 - (ii) adequate drainage measures shall be provided to prevent surface water running from the Site to the nearby public roads and drains; and
 - (iii) the applicant should be reminded that HyD is not/shall not be responsible for the maintenance of any access connecting the Site and Sha Tau Kok Road Lung Yuek Tau;
- (g) to note the comments of the Chief Town Planner/Urban Design and Landscape, Planning Department (CTP/UD&L, PlanD) that the approval of the application does not imply approval of tree works, such as pruning, transplanting and felling. The applicant is reminded to seek approval for any proposed tree works from relevant authority prior to commencement of the works;
- (h) to note the comments of the Chief Engineer/Mainland North, Drainage Services Department (CE/MN, DSD) that:
 - (i) the Site is in the vicinity of the existing Ng Tung River to the north of the Site. The applicant shall be required to place all the proposed works at least 3m away from the top of the bank of Ng Tung River. All the proposed works in the vicinity of Ng Tung River should not create any adverse drainage impacts, both during and after construction;
 - (ii) the Site is in an area where public sewerage connection is available. The Environmental Protection Department (EPD) should be consulted regarding the sewage treatment/disposal facilities for the applied use;
 - (iii) the applicant's attention is drawn to the following general comments/requirements:
 - the existing manhole SCH1011400 and SCH1011402 to which the applicant proposed to discharge the storm water from the Site are maintained by her office. The applicant shall submit a duly completed "Helping Business Programme Form" (HBP1) with a cross cheque covering the technical audit fee and a plan showing the details of the proposed connection works to her office for formal application for the

required connection. Upon her acceptance of the connection application, the applicant shall carry out the proposed connection works in accordance with DSD Standard Drawings at the resources of the applicant;

- the applicant is required to construct and maintain the proposed drainage works properly and rectify the drainage systems if they are found to be inadequate or ineffective during operation. The applicant shall also be liable for and shall indemnify claims and demands arising out of damage or nuisance caused by a failure of the systems. For works undertaken outside the lot boundary, prior consent and agreement from DLO/N, LandsD and/or relevant private lot owners should be sought;
- the applicant is reminded that all existing flow paths as well as the run-off falling onto and passing though the Site should be intercepted and disposed of via proper discharge points. The applicant shall also ensure that no works, including any site formation works, shall be carried out as may adversely interfere with the free flow condition of the existing drain, channels and watercourse on or in the vicinity of the Site at any time during or after the works;
- the applicant shall take all precautionary measures to prevent any disturbance, damage and pollution from the applied use to any parts of the existing drainage facilities in the vicinity of the lots. In the event of any damage to the existing drainage facilities, the applicant shall be held responsible for the cost of all necessary repair works, compensation and any other consequences arising there from:
- the applicant shall allow all time free access for the Government and its agent to conduct site inspection on his completed drainage works, if necessary; and
- the applicant should also be advised that the limited desk-top checking by Government on the drainage proposal covers only the fundamental aspects of the drainage design which will by no means relieve his obligations to ensure that (i) the proposed drainage works will not cause any adverse drainage or environmental impacts on the vicinity; and (ii) the proposed drainage works and the downstream drainage systems have the adequate capacity and are in good conditions to receive the flows collected from his lot and all upstream catchments;
- (i) to note the comments of the Director of Environmental Protection (DEP) that:
 - (i) the applicant should follow relevant mitigation measures and requirements in "Code of Practice on Handling the Environmental Aspects of Temporary Uses and Open Storage Sites" and to meet the statutory requirements under relevant pollution control ordinances; and
 - (ii) the applicant should provide adequate supporting infrastructures/facilities for proper collection, treatment and disposal of waste/wastewater generated from the applied use. If septic tank and soakaway will be used in case of unavailability of public sewer, its design and construction shall follow the requirements of EPD's Practice Note for Professional Person (ProPECC) PN 1/23 "Drainage Plans subject to Comment by the Environmental Protection Department" including percolation test and are duly certified by Authorized Person;

- (j) to note the comments of the Director of Fire Services (D of FS) that:
 - (i) the applicant should submit a full set of "Certificate of Fire Service Installation and Equipment" (FS 251) which should be incorporated all FSIs proposed in the accepted FSIs proposal for his further arrangement of FSIs acceptance inspection; and
 - (ii) the applicant is reminded that if the proposed structures are required to comply with the Buildings Ordinance (BO) (Cap. 123), detailed fire service requirements will be formulated upon receipt of formal submission of general building plans;
- (k) to note the comment of the Project Manager (North), Civil Engineering and Development Department (PM(N), CEDD) that the applied use is located within the proposed New Territories North (NTN) New Town under the Planning and Engineering (P&E) Study for NTN New Town and Man Kam To. The preliminary development proposal for NTN New Town was released in December 2024. While the implementation programme of NTN New Town is being formulated under the P&E Study, the site formation works will likely commence soon after the completion of detailed design in next stage. Subject to the land use planning in the P&E Study, the applied use may need to be vacated for the site formation works;
- (l) to note the comments of the Chief Building Surveyor/New Territories West, Buildings Department (CBS/NTW, BD) that:
 - (i) it is noted that four temporary structures are proposed in the application. Before any new building works (including containers/open sheds as temporary buildings, demolition and land filling, etc.) are to be carried out on the Site, prior approval and consent of the building Authority (BA) should be obtained, otherwise they are unauthorized building works (UBW) under the BO. An Authorized Person should be appointed as the co-ordinator for the proposed building works in accordance with the BO; and
 - (ii) the applicant's attention is drawn to the following points:
 - the Site shall be provided with means of obtaining access thereto from a street and emergency vehicular access in accordance with Regulations 5 and 41D of the Building (Planning) Regulations (B(P)R) respectively;
 - the Site does not abut on a specified street of not less than 4.5m wide and its permitted development intensity shall be determined under Regulation 19(3) of the B(P)R at building plan submission stage;
 - if the existing structures (not being a New Territories Exempted House) is/are erected on leased land without the approval of the BA, they are UBW under the BO and should not be designated for any applied use under the planning application;
 - for UBW erected on leased land, enforcement action may be taken by BD to effect their removal in accordance with the prevailing enforcement policy against UBW as and when necessary. The granting of any planning approval should not be construed as an acceptance of any existing building works or UBW on the Site under the BO;
 - any temporary shelters or converted containers for office, storage, washroom or other uses are considered as temporary buildings are subject to the control of Part VII of the B(P)R;

- the proposed structures with excessive high headroom (i.e. 14m height) should be justified; and
- detailed checking under the BO will be carried out at building plan submission stage; and
- (m) to note the comments of the Chief Engineer/Construction, Water Supplies Department (CE/C, WSD) that:
 - (i) existing water mains inside the Site as shown on the plan (**Attachment**) may be affected. The applicant is required to either divert or protect the water mains found on site;
 - (ii) if diversion is required, existing water mains inside the site areas are needed to be diverted outside the boundary of the Site to lie in GL. A strip of land of minimum 1.5 m in width should be provided for the diversion of existing water mains. The cost of diversion of existing water mains upon request will have to be borne by the applicant and the applicant shall submit all the relevant proposal to the WSD for consideration and agreement before the works commence; and
 - (iii) if the diversion is not required, the following conditions shall apply:
 - existing water mains are affected as indicated on the site plan and no development which requires resiting of water mains will be allowed;
 - details of site formation works shall be submitted to the Director of Water Supplies (DWS) for approval prior to commencement of works;
 - no structures shall be built or materials stored within 1.5m from the centre line(s) of water main(s) shown on the plan. Free access shall be made available at all times for staff of the DWS or their contractor to carry out construction, inspection, operation, maintenance and repair works;
 - no trees or shrubs with penetrating roots may be planted within the Water Works Reserve or in the vicinity of the water main(s) shown on the plan. No change of existing site condition may be undertaken within the aforesaid area without the prior agreement of the DWS. Rigid root barriers may be required if the clear distance between the proposed tree and the pipe is 2.5m or less, and the barrier must extend below the invert level of the pipe;
 - no planting or obstruction of any kind except turfing shall be permitted within the space of 1.5m around the cover of any valve or within a distance of 1m from any hydrant outlet; and
 - tree planting may be prohibited in the event that the DWS considers that there is any likelihood of damage being caused to water mains.

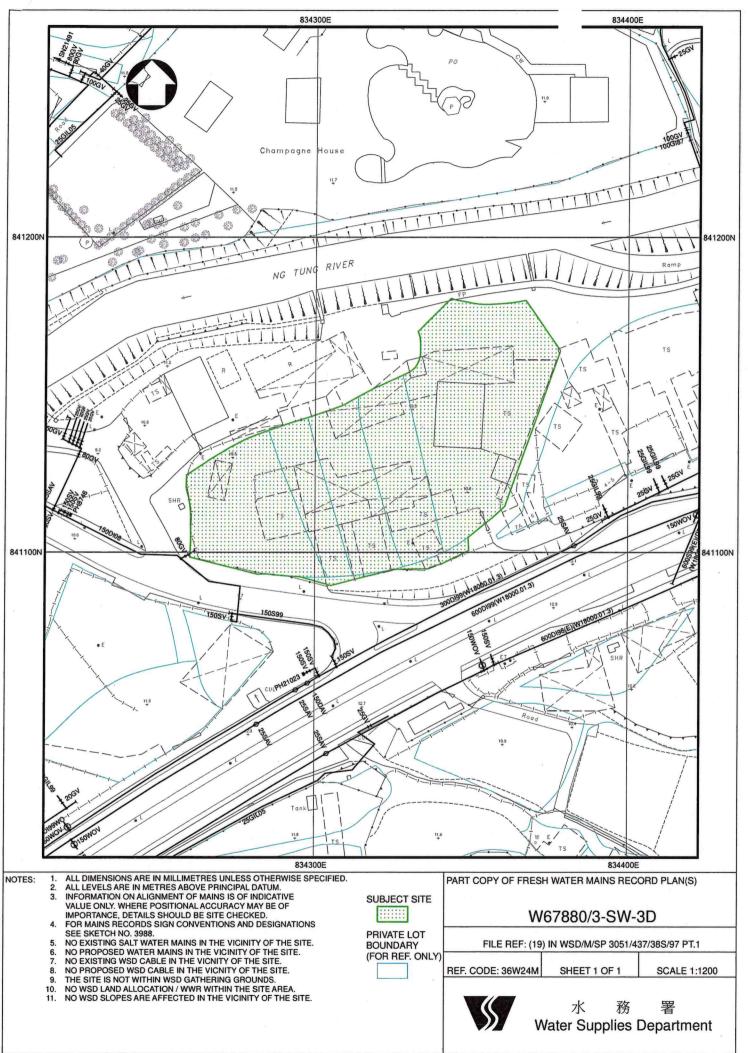

致城市規劃委員會秘書:

專人送遞或郵遞:香港北角渣蕔道 333 號北角政府合署 15 樓

傳真:2877 0245 或 2522 8426

電郵: tpbpd@pland.gov.hk

To: Secretary, Town Planning Board

By hand or post: 15/F, North Point Government Offices, 333 Java Road, North Point, Hong Kong

By Fax: 2877 0245 or 2522 8426 By e-mail: tpbpd@pland.gov.hk

有關的規劃申請編號 The application no. to which the comment relates A/NE-TKL/773

A/NE-1 KL///3

意見詳情 (如有需要,請另頁說明)

Details of the Comment (use separate sheet if necessary)

「提意見人」姓名/名稱 Name of person/company making this comment

簽署 Signature

日期 Date <u>wr4.9.5</u>

96%

2

致城市規劃委員會秘書:

專人送遞或郵遞:香港北角渣華道 333 號北角政府合署 15 樓

傳真: 2877 0245 或 2522 8426

電郵: tpbpd@pland.gov.hk

To: Secretary, Town Planning Board

By hand or post: 15/F, North Point Government Offices, 333 Java Road, North Point, Hong Kong

By Fax: 2877 0245 or 2522 8426 By e-mail: tpbpd@pland.gov.hk

有關的規劃申請編號 The application no. to which the comment relates A/NE-TKL/773

意見詳情(如有需要,請另頁說明)

Comment No. 3-5

致城市規劃委員會秘書:

專人送遞或郵遞:香港北角渣華道 333 號北角政府合署 15 樓

傳真:2877 0245 或 2522 8426

電郵: tpbpd@pland.gov.hk

To: Secretary, Town Planning Board

By hand or post: 15/F, North Point Government Offices, 333 Java Road, North Point, Hong Kong

By Fax: 2877 0245 or 2522 8426 By e-mail: tpbpd@pland.gov.hk

有關的規劃申請編號 The application no. to which the comment relates A/NE-TKL/773

满有洲	自有 對	\$ \$2P	 		······································	<u></u>	
<u> </u>	<u> </u>	<u> </u>					
			 	 	·		
(property P + 1	·		 				
		.,,,	 				
			 	•			





香港新界粉嶺區鄉事委員會 Hong Kong Fanling District Rural Committee

P.2 - 4

敬啟者:

貴虔檔號: TPB/A/NE-TKL/773

新界粉模軍地丈量約份第83約地段第456號餘段、第459號、第460號、 第 461 號、第 462 號及第 2229 號餘段

> 臨時物流中心(為期3年) (申請編號: A-NE-TKL-773)

本會接獲該區居民 強烈反對 上述申請·原因是;

- 1) 開設物流中心,必會增加重型車輛 (例如 40 尺櫃等) 行駛沙頭角公路 邀能負荷到?
- 2) 現時經常塞車的沙頭角公路已超出負荷,增多重型車輛行駛更造成路 面地陷,影響行車安全及行人安全。

此致 規劃署沙田、大埔 及北區規劃導員

粉嶺區鄉事委員會首主席

(李國鳳)

2024年9月23日



香港新界粉嶺區鄉事委員會 Hong Kong Fanling District Rural Committee

f-3 - 4

敬啟者:

音處檔號: TPB/A/NE-TKL/773

新界粉裝軍地丈量約份第83約地段第456號餘段、第459號、第460號、 第461號、第482號及第2229號餘段 臨時物流中心(為期3年)

(申請編號: A-NE-TKL-773)

本會接獲該區居民 強烈反對 上述申請,原因是:

- 1) 開設物流中心,必會增加重型車輛 (例如 10 尺櫃等) 行駛沙頭角公路 還能負荷到?
- 2) 現時經常塞車的沙頭角公路已超出負荷,增多重型車輛行駛更造成路 面地陷,影響行車安全及行人安全。

此致 規劃署沙田、大埔 及北區規劃專員

粉嶺區鄉事委員會首副主席

(劉永安)

2024年9月23日



香港新界粉嶺區鄉事委員會 Hong Kong Fanling District Rural Committee

P4-4

敬啟者:

資農檔號 : TPB/A/NE-TKL/773

新界粉模單地丈量約份第83約地段第456號餘段、第459號、第460號、第461號、第462號及第2229號餘段

酶時物流中心(為期3年) (申請編號: A-NE-TKL-773)

本會接獲該區居民 強烈反對 上述申請,原因是:

- 開設物流中心,必會增加重型車輛(例如 40 尺櫃等)行駛沙頭角公路 選能負荷到?
- 2) 現時經常塞車的沙頭角公路已超出負荷,增多重型車輛行駛更造成路面地陷,影響行車安全及行人安全。

此致 規劃署沙田、大埔 及北區規劃專員

粉嶺區鄉事委員會副主席

(鄧志佳)

2024年9月3日

□Urgent	□Return receipt	□Expand Group	□Restricted	□Prevent Copy

From:

Sent:

2024-09-24 星期二 02:12:24

To: Subject: tpbpd/PLAND <tpbpd@pland.gov.hk>

A/NE-TKL/773 DD 83 Kwan Tei

A/NE-TKL/773

Lots 456 RP, 459, 460, 461, 462 and 2229 RP in D.D. 83, Kwan Tei, Fanling

Site area: About 6,300sq.m

Zoning: "Open Storage" and "Agriculture"

Applied use: Logistics Centre / 8 Vehicle Parking

Dear TPB Members,

Conditions of 708 have not been fulfilled. Solution, file a fresh application safe in the knowledge that it will be streamlined and rubber stamped.

The failure on the part of both govt depts and TPB members to give priority to the greater interests of the community and workers at the operation is appalling.

Mary Mulvihill