1 7 DEC 2024

This document is received on \_\_\_\_\_\_\_\_ The Town Planning Board will formally acknowledge the date of receipt of the application only upon receipt of all the required information and documents.



# APPLICATION FOR PERMISSION

# **UNDER SECTION 16 OF**

# THE TOWN PLANNING ORDINANCE

(CAP. 131)

根據《城市規劃條例》(第131章) 第16條號交的許可申請

Applicable to proposals not involving or not only involving: 適用於建議不涉及或不祇涉及:

- (i) Construction of "New Territories Exempted House(s)"; 興建「新界豁免管制屋宇」;
- (ii) Temporary use/development of land and/or building not exceeding 3 years in rural areas or Regulated Areas; and 位於鄉郊地區或受規管地區土地上及/或建築物內進行為期不超過三年的臨時用途/發展;及
- (iii) Renewal of permission for temporary use or development in rural areas or Regulated Areas 位於鄉郊地區或受規管地區的臨時用途或發展的許可續期

Applicant who would like to publish the <u>notice of application</u> in local newspapers to meet one of the Town Planning Board's requirements of taking reasonable steps to obtain consent of or give notification to the current land owner, please refer to the following link regarding publishing the notice in the designated newspapers: <a href="https://www.tpb.gov.hk/en/plan\_application/apply.html">https://www.tpb.gov.hk/en/plan\_application/apply.html</a>

申請人如欲在本地報章刊登<u>申請通知</u>,以採取城市規劃委員會就取得現行土地擁有人的同意或通知現行土地擁有人所指定的其中一項合理步驟,請瀏覽以下網址有關在指定的報章刊登通知:https://www.tpb.gov.hk/tc/plan application/apply.html

### General Note and Annotation for the Form 填寫表格的一般指引及註解

- "Current land owner" means any person whose name is registered in the Land Registry as that of an owner of the land to which the application relates, as at 6 weeks before the application is made 「現行土地擁有人」指在提出申請前六星期,其姓名或名稱已在土地註冊處註冊為該申請所關乎的土地的擁有人的人
- & Please attach documentary proof 請夾附證明文件
- ^ Please insert number where appropriate 請在適當地方註明編號

Please fill "NA" for inapplicable item 請在不適用的項目填寫「不適用」

Please use separate sheets if the space provided is insufficient 如所提供的空間不足,請另頁說明

Please insert a 「ノ」 at the appropriate box 請在適當的方格内上加上「ノ」號

For Official Use Only 請勿填寫此欄	Application No. 申請編號	A/4L-KTN/1075
	Date Received 收到日期	1 7 DEC 2024

- 1. The completed form and supporting documents (if any) should be sent to the Secretary, Town Planning Board (the Board), 15/F, North Point Government Offices, 333 Java Road, North Point, Hong Kong. 申請人須把填妥的申請表格及其他支持申請的文件 (倘有),送交香港北角渣華道 333 號北角政府合署 15 樓城市規劃委員會(下稱「委員會」)秘書收。
- 2. Please read the "Guidance Notes" carefully before you fill in this form. The document can be downloaded from the Board's website at <a href="http://www.tpb.gov.hk/">http://www.tpb.gov.hk/</a>. It can also be obtained from the Secretariat of the Board at 15/F, North Point Government Offices, 333 Java Road, North Point, Hong Kong (Tel: 2231 4810 or 2231 4835), and the Planning Enquiry Counters of the Planning Department (Hotline: 2231 5000) (17/F, North Point Government Offices, 333 Java Road, North Point, Hong Kong and 14/F, Sha Tin Government Offices, I Sheung Wo Che Road, Sha Tin, New Territories). 請先細閱《申請須知》的資料單張,然後填寫此表格。該份文件可從委員會的網頁下載(網址: <a href="http://www.tpb.gov.hk/">http://www.tpb.gov.hk/</a>),亦可向委員會秘書處(香港北角渣華道 333 號北角政府合署 15 樓-電話:2231 4810 或 2231 4835)及規劃署的規劃資料查詢處(熱線:2231 5000) (香港北角渣華道 333 號北角政府合署 17 樓及新界沙田上禾輋路 1 號沙田政府合署 14 樓)索取。
- 3. This form can be downloaded from the Board's website, and obtained from the Secretariat of the Board and the Planning Enquiry Counters of the Planning Department. The form should be typed or completed in block letters. The processing of the application may be refused if the required information or the required copies are incomplete. 此表格可從委員會的網頁下載,亦可向委員會秘書處及規劃署的規劃資料查詢處索取。申請人須以打印方式或以正楷填寫表格。如果申請人所提交的資料或文件副本不齊全,委員會可拒絕處理有關申請。

1. Name of	Applicant 申請人姓名/名稱	= "
(☑Mr. 先生 / [	] Mrs. 夫人 /□Miss 小姐 /□Ms. 女士 /□Company 公司 /□Organisation 機構)	- 10 To 10 T
Tang Wing	Yat Tommy 鄧榮日	

2. Name of Authorised Agent (if applicable) 獲授權代理人姓名/名稱(如適用)

(□Mr. 先生 /□Mrs. 夫人 /□Miss 小姐 /□Ms. 女士 /□Company 公司 /□Organisation 機構)

NA 不適用

3.	Application Site 申請地點	
(a)	Full address / location / demarcation district and lot number (if applicable) 詳細地址/地點/丈量約份及地段號碼(如適用)	Lot 1142 (Part) in D.D. 109, Kam Tin, Yuen Long 新界元朗錦田丈量約份第109約地段第1142號(部分)
(b)	Site area and/or gross floor area involved 涉及的地盤面積及/或總樓面面積	☑Site area 地盤面積 921.8 sq.m 平方米☑About 約 ☑Gross floor area 總樓面面積 297 sq.m 平方米☑About 約
(c)	Area of Government land included (if any) 所包括的政府土地面積(倘有)	NA 不適用 sq.m 平方米 □About 約

(d)	Name and number of the statutory plan(s) 有關法定圖則的名稱及編號						
(e)	Land use zone(s) involved 涉及的土地用途地帶						
(f)	Current use(s) 現時用途	空置 Vacant  (If there are any Government, institution or community facilities, please illustrate on plan and specify the use and gross floor area) (如有任何政府、機構或社區設施,請在圖則上顯示,並註明用途及總樓面面積)					
4.	"Current Land Owner	" of Application Site 申請地點的「現行土地擁有人」					
The	applicant 申請人 -						
	is the sole "current land own 是唯一的「現行土地擁有力	er"#& (please proceed to Part 6 and attach documentary proof of ownership) #& (請繼續填寫第 6 部分,並夾附業權證明文件)。					
		ners'' <sup>#&amp;</sup> (please attach documentary proof of ownership). [人」 <sup>#&amp;</sup> (請夾附業權證明文件)。					
<b>~</b>	is not a "current land owner" <sup>#</sup> . 並不是「現行土地擁有人」 <sup>#</sup> 。						
	The application site is entirely on Government land (please proceed to Part 6). 申請地點完全位於政府土地上(請繼續填寫第 6 部分)。						
5.	Statement on Owner's Consent/Notification 就土地擁有人的同意/通知土地擁有人的陳述						
(a)							
(b)	The applicant 申請人 —						
	has obtained consent(s)	of "current land owner(s)".					
	已取得	名「現行土地擁有人」#的同意。					
	Details of consent of	current land owner(s)"# obtained 取得「現行土地擁有人」#同意的詳情					
	Land Owner(s) Re	Date of consent obtained (DD/MM/YYYY) 取得同意的日期 (日/月/年)					
	(Please use separate sheet	s if the space of any box above is insufficient. 如上列任何方格的空間不足,請另頁說明)					

	Details of the "current land owner(s)" notified 已獲通知「現行土地擁有人」"的詳細資料					
	La	. of 'Current nd Owner(s)' 現行土地擁 人」數目	Lot number/address of premises as shown in the record of the Land Registry where notification(s) has/have been given 根據土地註冊處記錄已發出通知的地段號碼/處所地址	Date of notification given (DD/MM/YYYY) 通知日期(日/月/年)		
	_					
	-					
	(Plea	ase use separate s	neets if the space of any box above is insufficient. 如上列任何方格的3	空間不足,請另頁說明)		
/	已採	印合理步驟以	e steps to obtain consent of or give notification to owner(s): 取得土地擁有人的同意或向該人發給通知。詳情如下:			
	Reas		Obtain Consent of Owner(s) 取得土地擁有人的同意所採取	parameter and the second		
	sent request for consent to the "current land owner(s)" on(DD/MM/YYYY) <sup>#&amp;</sup> 於(日/月/年)向每一名「現行土地擁有人」 <sup>#</sup> 郵遞要求同意書 <sup>&amp;</sup>					
	Reasonable Steps to Give Notification to Owner(s) 向土地擁有人發出通知所採取的合理步驟					
			ces in local newspapers on (DD/MM/YY (日/月/年)在指定報章就申請刊登一次通知&	YYY) <sup>&amp;</sup>		
	<b>V</b>		n a prominent position on or near application site/premises on 0/10/2024 (DD/MM/YYYY)&			
		於_16/10/2024-29	/10/2024 (日/月/年)在申請地點/申請處所或附近的顯明位置	星貼出關於該申請的通知		
	<b>V</b>	office(s) or run 於 16/10/2024	relevant owners' corporation(s)/owners' committee(s)/mutual aid ral committee on 16/10/2024 (DD/MM/YYYY)& (日/月/年)把通知寄往相關的業主立案法團/業主導切鄉事委員會&	6. 17 - 1		
	<u>Oth</u>	ers 其他				
		others (please 其他(請指明				
	-					

6.	Type(s)	of Application 申請類別
	Type (i) 第(i)類	Change of use within existing building or part thereof 更改現有建築物或其部分內的用途
<b>V</b>	Type (ii)	Diversion of stream / excavation of land / filling of land / filling of pond as required under Notes of Statutory Plan(s)
	第(ii)類	根據法定圖則《註釋》內所要求的河道改道/挖土/填土/填塘工程
	Type (iii) 第(iii)類	Public utility installation / Utility installation for private project 公用事業設施裝置/私人發展計劃的公用設施裝置
	Type (iv) 第(iv)類	Minor relaxation of stated development restriction(s) as provided under Notes of Statutory Plan(s) 略為放寬於法定圖則《註釋》內列明的發展限制
~	Type (v) 第(v)類	Use / development other than (i) to (iii) above 上述的(i)至(iii)項以外的用途/發展
註 1	: 可在多於 2: For Develop	t more than one「✓」. 一個方格內加上「✓」號 oment involving columbarium use, please complete the table in the Appendix. 及靈灰安置所用途,請填妥於附件的表格。

(i)	For Type (i) application	on 供第(i	類申請			
	otal floor area nvolved 步及的總樓面面積	-			sq.m 平方米	
u	roposed se(s)/development 疑議用途/發展	(If there are any Government, institution or community facilities, please illustrate on plan and s the use and gross floor area) (如有任何政府、機構或社區設施,請在圖則上顯示,並註明用途及總樓面面積)		- 12		
	Number of storeys involved 步及層數			Number of units invo 涉及單位數目	olved	
		Domestic p	art 住用部分		sq.m 平方米	□About 約
	roposed floor area 疑議樓面面積	Non-domes	tic part 非住用語	郛分	sq.m 平方米	□About 約
		Total 總計			sq.m 平方米	□About 約
(e) P	Proposed uses of different	Floor(s) 樓層	Current us	se(s) 現時用途	Proposed (	use(s) 擬議用途
fl 7	loors (if applicable) 下同樓層的擬議用途(如適					
(H	刊) Please use separate sheets if the pace provided is insufficient)					
	如所提供的空間不足,請另真說 月)					

(ii) For Type (ii) applica	ation 供第(ii)類申讀
	□ Diversion of stream 河道改道
	□ Filling of pond 填塘 Area of filling 填塘面積
(a) Operation involved 涉及工程	▼ Filling of land 填土 Area of filling 填土面積 921.8 sq.m 平方米 □ About 約 Depth of filling 填土厚度 0.2-0.3 m 米 □ About 約
	□ Excavation of land 挖土 Area of excavation 挖土面積
(b) Intended use/development 有意進行的用途/發展	Proposed Temporary Animal Boarding Establishment with Ancillary Facilities for a Period of 5 Years and Associated Filling of Land 擬議臨時動物寄養所連附屬設施(為期5年)及相關填土工程
(iii) For Type (iii) applie	cation 供管(iii)類申譜
(iii) 101 1 ypc (iii) applica	□ Public utility installation 公用事業設施裝置
	□ Utility installation for private project 私人發展計劃的公用設施裝置
	Please specify the type and number of utility to be provided as well as the dimensions of each building/structure, where appropriate 請註明有關裝置的性質及數量,包括每座建築物/構築物(倘有)的長度、高度和闊度
· · · · · · · · · · · · · · · · · · ·	Name/type of installation 裝置名稱/種類  Number of provision 數量  Dimension of each installation /building/structure (m) (LxWxH) 每個裝置/建築物/構築物的尺寸 (米) (長 x 闊 x 高)
(a) Nature and scale 性質及規模	
	L

$(iv)$ $\underline{F}$	or Type (iv) applicat	ton 供募(w)類中讀			
1	(a) Please specify the proposed minor relaxation of stated development restriction(s) and <u>also fill in the proposed use/development and development particulars in part (v) below</u> — 請列明擬議略為放寬的發展限制 <u>並填妥於第(v)部分的擬議用途/發展及發展細節</u> —				
	Plot ratio restriction 地積比率限制	From 由 to 至			
	Gross floor area restrict 總樓面面積限制	ion From 由sq. m 平方米 to 至sq. m 平方米	<b>(</b>		
	Site coverage restriction 上蓋面積限制	From 由			
	Building height restrict 建築物高度限制	ion From 由m 米 to 至m 米	From 由 m 米 to 至 m 米		
		From 由 mPD 米 (主水平基準上) to 至			
		mPD 米 (主水平基準上)			
		From 由 storeys 層 to 至 store	/s 層		
	Non-building area restr 非建築用地限制	iction From 由m to 至m	From 由 m to 至 m		
	□ Others (please specify) 其他(請註明)				
200777555455					
(v) <u>F</u>	For Type (v) applicati	ion 供第(v)類申讀			
Proposed Temporary Animal Boarding Establishment with Ancillary  (a) Proposed     use(s)/development     擬議用途/發展     擬議臨時動物寄養所連附屬設施(為期5年)及相關填土工程					
		(Please illustrate the details of the proposal on a layout plan 請用平面圖說明建議	洋情) ————————————————————————————————————		
(b) <u>De</u>	velopment Schedule 發展				
Pro	oposed gross floor area (C		☑About 約		
Pro	posed plot ratio 擬議地種		☑About 約		
Pro	posed site coverage 擬議	上蓋面積 32.2 %	☑About 約		
	pposed no. of blocks 擬議	<u>坐</u> 數			
Pro	oposed no. of storeys of ea	ach block 每座建築物的擬議層數 1 storeys 層			
		□ include 包括storeys of basem □ exclude 不包括storeys of base			
Pro	Proposed building height of each block 每座建築物的擬議高度				

☐ Domestic par	住用部分				
GFA 總	婁面面積		sq. m 平方米	□About 約	
number of Units 單位數目					
	unit size 單位平均面	積	sq. m 平方米	□About 約	
	d number of residents				
✓ Non-domestic	part 非住用部分		GFA 總樓面面	積	
	ace 食肆		sq. m 平方米	□About 約	
□ hotel 酒				□About 約	
			(please specify the number of rooms	22-11-24	
			請註明房間數目)		
✓ office 辦	4八字		72 sq. m 平方米	□About 約	
		女气类		□About 約	
snop and	l services 商店及服剂	分	sq. m 平方米	LIADOUL #1	
Governm	nent, institution or co	mmunity facilities	(please specify the use(s) and	concerned land	
		initiality facilities	area(s)/GFA(s) 請註明用途及有關的		
以灯、1	機構或社區設施			沙心田田竹具/ 総	
			樓面面積)		
✓ other(s)	甘州		(please specify the use(s) and	concerned land	
v other(s)	大匠		area(s)/GFA(s) 請註明用途及有關的地面面積/總		
			樓面面積)		
			(安山田) Animal Boarding Establishment: Abo	out 225 m <sup>2</sup>	
☐ Open space ⟨	<b></b> 木憩用地		(please specify land area(s) 請註明均	也面面積)	
private of	ppen space 私人休憩	用地	sq. m 平方米 🛚 Not le	ess than 不少於	
public o	pen space 公眾休憩	<b></b> 用地	sq. m 平方米 口 Not le	ess than 不少於	
(c) Use(s) of differ	ent floors (if applicat	ole) 各樓層的用途 (如適)	用)		
[Block number]	[Floor(s)]		[Proposed use(s)]		
[座數]	[層數]		[擬議用途]		
U-1-3/1	UE XXI				
(d) Proposed use(s)	of uncovered area (	L if any) 露天地方(倘有)	的擬議用途		
			e, Animal Outdoor Activities Area		
				•••••	

7. Anticipated Completion Time of the Development Proposal 擬議發展計劃的預計完成時間					
擬議發展計劃預期完成的年份及 (Separate anticipated completion Government, institution or comm	Anticipated completion time (in month and year) of the development proposal (by phase (if any)) (e.g. June 2023) 擬議發展計劃預期完成的年份及月份 (分期 (倘有)) (例: 2023 年 6 月) (Separate anticipated completion times (in month and year) should be provided for the proposed public open space and Government, institution or community facilities (if any)) (申請人須就擬議的公眾休憩用地及政府、機構或社區設施(倘有)提供個別擬議完成的年份及月份)				
June 2026					
8. Vehicular Access Arra 擬議發展計劃的行	0		the Development Proposal	ı	
Any vehicular access to the site/subject building?	Yes 是	~	There is an existing access. (please indicate the street na appropriate) 有一條現有車路。(請註明車路名稱(如適用)) Chi Ho Road, turn to local track.		
是否有車路通往地盤/有關建築物?			There is a proposed access. (please illustrate on plan and specif有一條擬議車路。(請在圖則顯示,並註明車路的闊度)		
	No否			12	
Any provision of parking space for the proposed use(s)? 是否有為擬議用途提供停車位?	Yes 是		(Please specify type(s) and number(s) and illustrate on plan) 請註明種類及數目並於圖則上顯示) Private Car Parking Spaces 私家車車位 Motorcycle Parking Spaces 電單車車位 Light Goods Vehicle Parking Spaces 輕型貨車泊車位 Medium Goods Vehicle Parking Spaces 中型貨車泊車位 Heavy Goods Vehicle Parking Spaces 重型貨車泊車位 Others (Please Specify) 其他 (請列明)	3	
	No 否				
Any provision of loading/unloading space for the proposed use(s)? 是否有為擬議用途提供上落客貨車位?	Yes 是	$\Sigma$	(Please specify type(s) and number(s) and illustrate on plan) 請註明種類及數目並於圖則上顯示) Taxi Spaces 的士車位 Coach Spaces 旅遊巴車位 Light Goods Vehicle Spaces 輕型貨車車位 Medium Goods Vehicle Spaces 中型貨車車位 Heavy Goods Vehicle Spaces 重型貨車車位 Others (Please Specify) 其他 (請列明)	2	
	No 否				

lopment Proposal 擬議發展計劃的影響
eparate sheets to indicate the proposed measures to minimise possible adverse impacts or give ot providing such measures.  司可盡量減少可能出現不良影響的措施,否則請提供理據/理由。
es 是 Please provide details 請提供詳情
□ Diversion of stream 河道改道 □ Filling of pond 填塘 Area of filling 填塘面積 sq.m 平方米□About 約 Depth of filling 填塘深度 m 米□About 約 □ Filling of land 填土 Area of filling 填土面積 sq.m 平方米□About 約 Depth of filling 填土直積 sq.m 平方米□About 約 □ Excavation of land 挖土 Area of excavation 挖土面積 sq.m 平方米□About 約 Depth of excavation 挖土面積 sq.m 平方米□About 約 Depth of excavation 挖土面積 sq.m 平方米□About 約
menvironment 對環境 mutaffic 對交通 mutaffic 對交通 muster supply 對供水 muster supply 對於 muster supply mus

10. Justifications 理由
The applicant is invited to provide justifications in support of the application. Use separate sheets if necessary. 現請申請人提供申請理由及支持其申請的資料。如有需要,請另頁說明。
Please refer to the Justification Document.

11. Decl	aration 聲明						
	I hereby declare that the particulars given in this application are correct and true to the best of my knowledge and belief. 本人謹此聲明,本人就這宗申請提交的資料,據本人所知及所信,均屬真實無誤。						
to the Boar	ant a permission to the Board to copy all the materi d's website for browsing and downloading by the 身本人就此申請所提交的所有資料複製及/或上讀	als submitted in this application and/or to upload such materials public free-of-charge at the Board's discretion. 本人現准許委載至委員會網站,供公眾免費瀏覽或下載。					
Signature							
	鄧榮日	NA 不適用					
	Name in Block Letters 姓名(請以正楷填寫)	Position (if applicable) 職位 (如適用)					
Professiona 專業資格	□ Qualification(s) □ Member 會員 / □ Fell □ HKIP 香港規劃師學 □ HKIS 香港測量師學 □ HKILA 香港園境師學 □ RPP 註冊專業規劃師 Others 其他	會 / □ HKIA 香港建築師學會 / 會 / □ HKIE 香港工程師學會 /					
on behalf o 代表		nd Chop (if applicable) 機構名稱及蓋章(如適用)					
Date 日期	22/11/2024	(DD/MM/YYYY 日/月/年)					

#### Remark 備註

The materials submitted in this application and the Board's decision on the application would be disclosed to the public. Such materials would also be uploaded to the Board's website for browsing and free downloading by the public where the Board considers appropriate.

委員會會向公眾披露申請人所遞交的申請資料和委員會對申請所作的決定。在委員會認為合適的情況下,有關申請資料亦會上載至委員會網頁供公眾免費瀏覽及下載。

#### Warning 警告

Any person who knowingly or wilfully makes any statement or furnish any information in connection with this application, which is false in any material particular, shall be liable to an offence under the Crimes Ordinance. 任何人在明知或故意的情況下,就這宗申請提出在任何要項上是虛假的陳述或資料,即屬違反《刑事罪行條例》。

#### Statement on Personal Data 個人資料的聲明

1. The personal data submitted to the Board in this application will be used by the Secretary of the Board and Government departments for the following purposes:

委員會就這宗申請所收到的個人資料會交給委員會秘書及政府部門,以根據《城市規劃條例》及相關的城市規劃委員會規劃指引的規定作以下用途:

- (a) the processing of this application which includes making available the name of the applicant for public inspection when making available this application for public inspection; and 處理這宗申請,包括公布這宗申請供公眾查閱,同時公布申請人的姓名供公眾查閱;以及
- (b) facilitating communication between the applicant and the Secretary of the Board/Government departments. 方便申請人與委員會秘書及政府部門之間進行聯絡。
- 2. The personal data provided by the applicant in this application may also be disclosed to other persons for the purposes mentioned in paragraph 1 above. 申請人就這宗申請提供的個人資料,或亦會向其他人士披露,以作上述第 1 段提及的用途。
- 3. An applicant has a right of access and correction with respect to his/her personal data as provided under the Personal Data (Privacy) Ordinance (Cap. 486). Request for personal data access and correction should be addressed to the Secretary of the Board at 15/F, North Point Government Offices, 333 Java Road, North Point, Hong Kong. 根據《個人資料(私隱)條例》(第 486 章)的規定,申請人有權查閱及更正其個人資料。如欲查閱及更正個人資料,應向委員會秘書提出有關要求,其地址為香港北角渣華道 333 號北角政府合署 15 樓。

For Developments involving Columbarium Use, please also complete the following:如發展涉及靈灰安置所用途,請另外填妥以下資料:
Ash interment capacity 骨灰安放容量®
Maximum number of sets of ashes that may be interred in the niches 在龕位內最多可安放骨灰的數量  Maximum number of sets of ashes that may be interred other than in niches 在非龕位的範圍內最多可安放骨灰的數量
Total number of niches 龕位總數
Total number of single niches  單人龕位總數  ———————————————————————————————————
Number of single niches (sold and occupied)  單人龕位數目 (已售並佔用)  Number of single niches (sold but unoccupied)  單人龕位數目 (已售但未佔用)  Number of single niches (residual for sale)  單人龕位數目 (待售)
Total number of double niches 雙人龕位總數
Number of double niches (sold and fully occupied) 雙人龕位數目(已售並全部佔用)  Number of double niches (sold and partially occupied) 雙人龕位數目(已售並部分佔用)  Number of double niches (sold but unoccupied) 雙人龕位數目(已售但未佔用)  Number of double niches (residual for sale) 雙人龕位數目(待售)
Total no. of niches other than single or double niches (please specify type) 除單人及雙人龕位外的其他龕位總數 (請列明類別)
Number. of niches (sold and fully occupied)
Proposed operating hours 擬議營運時間
<ul> <li>② Ash interment capacity in relation to a columbarium means – 就靈灰安置所而言,骨灰安放容量指:</li> <li>- the maximum number of containers of ashes that may be interred in each niche in the columbarium; 每個龕位內可安放的骨灰容器的最高數目;</li> <li>- the maximum number of sets of ashes that may be interred other than in niches in any area in the columbarium; and 在該靈灰安置所並非龕位的範圍內,總共最多可安放多少份骨灰;以及</li> <li>- the total number of sets of ashes that may be interred in the columbarium.</li> <li>- 在該骨灰安置所內,總共最多可安放多少份骨灰。</li> </ul>

Gist of Applica	Gist of Application 申請摘要							
(Please provide details in both English and Chinese <u>as far as possible</u> . This part will be circulated to relevant consultees, uploaded to the Town Planning Board's Website for browsing and free downloading by the public and available at the Planning Enquiry Counters of the Planning Department for general information.) (請盡量以英文及中文填寫。此部分將會發送予相關諮詢人士、上載至城市規劃委員會網頁供公眾免費瀏覽及下載及於規劃署規劃資料查詢處供一般參閱。)								
Application No. 申請編號	(For Of	ficial Use Only) (請勿	7填寫此欄)					
Location/address								
位置/地址	]	Lot 1142 (Part) in D.I	D. 109, Kam Tin,	Yue	n Long		a.	
	3	新界元朗錦田丈量然	1份第109約地段	第11	42號(部分)			
Site area 地盤面積					921.8	sq. m 平方米		
	(include	es Government land	of包括政府土	地	NA 不適用	sq. m 平方米	← □ About 約)	
Plan	錦	田北分區計劃大綱	]核准圖編號 S/	YL-	KTN/11		,	
圖則	2000000	PPROVED KAM TIN	NORTH OUTLI	NE	ZONING PLAT	N	- 11 - 12	
Zoning	NO. S/YL-KTN/11							
地帶	"	「農業」 Agriculture"						
Applied use/ development 申請用途/發展	Fa	oposed Temporary A cilities for a Period o 議臨時動物寄養所認	f 5 Years and Ass	ocia	ted Filling of L	and		
i) Gross floor are			sq.m	平	方米	Plot Ra	tio 地積比率	
and/or plot rat 總樓面面積及 地積比率		Domestic 住用	NA 不適用		About 約 Not more than 不多於	NA 不適用	□About 約 □Not more than 不多於	
		Non-domestic 非住用	297		About 約 Not more than 不多於	0.32	☑About 約 □Not more than 不多於	
		Domestic 住用	NA 不证	通用				
		Non-domestic 非住用	2					
		Composite 綜合用途	NA 不通	用				

(iii)	Building height/No. of storeys 建築物高度/層數	Domestic 住用	NA 不適用	m 米 □ (Not more than 不多於)
			NA 不適用	mPD 米(主水平基準上) □ (Not more than 不多於)
			NA 不適用	Storeys(s) 層 □ (Not more than 不多於)
-				(□Include 包括/□ Exclude 不包括 □ Carport 停車間 □ Basement 地庫 □ Refuge Floor 防火層 □ Podium 平台)
		Non-domestic 非住用	4	m 米 ☑ (Not more than 不多於)
			NA 不適用	mPD 米(主水平基準上)□ (Not more than 不多於)
			1	Storeys(s) 層 (Not more than 不多於)
				(□Include 包括/□ Exclude 不包括 □ Carport 停車間 □ Basement 地庫 □ Refuge Floor 防火層 □ Podium 平台)
		Composite 綜合用途	NA 不適用	m 米□ (Not more than 不多於)
			NA 不適用	mPD 米(主水平基準上)□ (Not more than 不多於)
			NA 不適用	Storeys(s) 層 (Not more than 不多於)
				(□Include 包括/□ Exclude 不包括 □ Carport 停車間 □ Basement 地庫 □ Refuge Floor 防火層 □ Podium 平台)
(iv)	Site coverage 上蓋面積		32.2	% ☑ About 約
(v)	No. of units 單位數目		NA 不適用	
(vi)	Open space 休憩用地	Private 私人	NA 不適用	sq.m 平方米 □ Not less than 不少於
		Public 公眾	NA 不適用	sq.m 平方米 🗆 Not less than 不少於


(vii)	No. of parking spaces and loading /	Total no. of vehicle parking spaces 停車位總數	3
	unloading spaces 停車位及上落客貨 車位數目	Private Car Parking Spaces 私家車車位 Motorcycle Parking Spaces 電單車車位 Light Goods Vehicle Parking Spaces 輕型貨車泊車位 Medium Goods Vehicle Parking Spaces 中型貨車泊車位 Heavy Goods Vehicle Parking Spaces 重型貨車泊車位 Others (Please Specify) 其他 (請列明)	PC: 3
		Total no. of vehicle loading/unloading bays/lay-bys 上落客貨車位/停車處總數	2
		Taxi Spaces 的士車位 Coach Spaces 旅遊巴車位 Light Goods Vehicle Spaces 輕型貨車車位 Medium Goods Vehicle Spaces 中型貨車位 Heavy Goods Vehicle Spaces 重型貨車車位 Others (Please Specify) 其他 (請列明)	LGV:2

Submitted Plans, Drawings and Documents 提交的圖則、繪圖及文件		
The state of the s	<u>Chinese</u> 中文	English 英文
Plans and Drawings 圖則及繪圖		
Master layout plan(s)/Layout plan(s) 總綱發展藍圖/布局設計圖		$\checkmark$
Block plan(s) 樓宇位置圖		
Floor plan(s) 樓宇平面圖		
Sectional plan(s) 截視圖		
Elevation(s) 立視圖		
Photomontage(s) showing the proposed development 顯示擬議發展的合成照片		
Master landscape plan(s)/Landscape plan(s) 園境設計總圖/園境設計圖		
Others (please specify) 其他(請註明)		$\checkmark$
Location Plan, Existing Vehicular Access, Paved Area		
Reports 報告書		
Planning Statement/Justifications 規劃綱領/理據	<b>✓</b>	
Environmental assessment (noise, air and/or water pollutions)		
環境評估(噪音、空氣及/或水的污染)		
Traffic impact assessment (on vehicles) 就車輛的交通影響評估		
Traffic impact assessment (on pedestrians) 就行人的交通影響評估		
Visual impact assessment 視覺影響評估		
Landscape impact assessment 景觀影響評估		
Tree Survey 樹木調査		
Geotechnical impact assessment 土力影響評估		
Drainage impact assessment 排水影響評估		
Sewerage impact assessment 排污影響評估		
Risk Assessment 風險評估		
Others (please specify) 其他(請註明)		
Note: May insert more than one「レ」. 註:可在多於一個方格內加上「レ」號		

### 申請理由

根據城市規劃條例第 16 條作出規劃許可申請 擬在新界元朗錦田丈量約份第 109 約地段第 1142 號(部分) 作為期五年的臨時動物寄養所連附屬設施及相關填土工程之用途

- ▶ 申請地點的面積約為 921.8 平方米,根據錦田北分區計劃大綱核准圖編號 S/YL-KTN/11,申請地點現時被規劃作「農業」地帶。
- 本擬議發展為臨時性質,因此不會影響申請地點長遠待規劃意向。根據租賃文件,該用地可作 農業用,在未首先獲得批准的情況下,該地段不允許用於其他土地用途。因此,"動物寄養 所"開發申請仍然符合租約。
- ▶ 擬議申請的動物寄養所在同一個「農業」地帶,城市規劃委員會曾批准相類似的動物寄養所,申請包括: A/YL-KTN/954 (2023 年 10 月 13 日獲批)。因此希望城市規劃委員會對本申請作出相同的對待。
- ▶ 申請地段將設有2個擬議建築物,包括1個動物寄養所及1個附屬辦公室。
- 擬議用途的營業時間為星期一至星期日包括公眾假期上午八時至下午六時。在營業時間外,寄養所內會有寵物(即從下午六時至上午八時)。
- ▶ 申請地點會採用混凝土作平整物料,厚度不超過0.2米,興建構築物上蓋範圍亦會採用混凝土 作平整物料,總厚度不超過0.3米,申請期限結束後會將混凝土打碎並運走。
- 申請用途的用途、形式及佈局與周遭環境並沒有不協調,亦會顧及自然特色。
- 當場地發展後,附帶條件的美化環境建議能加強申請地點及周圍的綠化效果,使整體視野變得 美觀更令人舒服。渠務建議計劃及舒緩環境措施,也能令附近地區受惠,有效地加強該地區及 附近範圍的環境保護,並能減少水浸可能。
- 根據以上各點,誠意懇求城市規劃委員會寬大批准新界元朗錦田丈量約份第 109 約地段第 1142 號(部分)作為期五年的臨時動物寄養所連附屬設施及相關填土工程的用途。

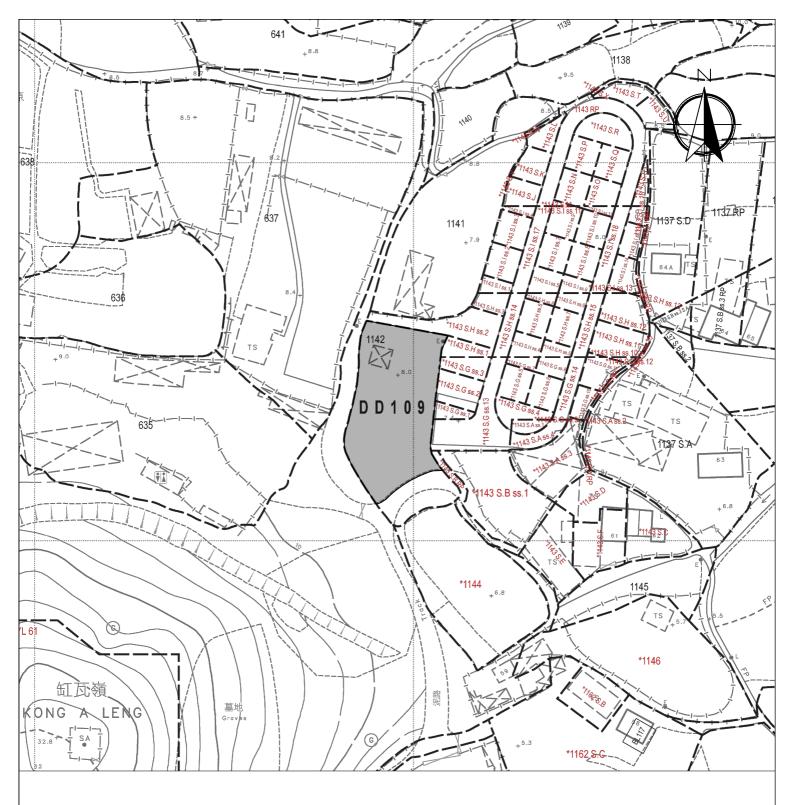

Legend:

Application Site 申請範圍

Appendix 1

Location: DD 109 Lot 1142 (Part)

OZP: S/YL-KTN/11 District: Kam Tin North Zoning: Agriculture

Date: 20 November 2024

Location 位置圖

擬議臨時動物寄養所連附屬設施 (為期5年)及相關填土工程

Proposed Temporary Animal Boarding Establishment with Ancillary Facilities For a Period of 5 Years and Associated Filling of Land **SCALE** 


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For Identification Only

	Proposed Structures Details							
	Structures Gross Floor Area (GFA) Height (Not Exceeding) St							
Α	Animal Boarding Establishment	About 225 m <sup>2</sup>	4m	1 only				
В	Ancillary Office	About 72 m <sup>2</sup>	4m	1 only				
	Total	About 297 m <sup>2</sup>						
	Private Car Parking Space	Unit(s): 3						
	LGV L/UL Space	Unit(s): 2						





Legend:

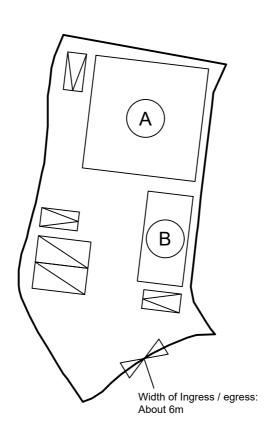Proposed Structures

Private Car Parking Space

□ LGV L/UL Space

Animal Boarding Establishment

(B) Ancillary Office

Total Area: 921.8 m<sup>2</sup> (About)

Covered Area: 297 m<sup>2</sup> (About)

Uncovered Area: 624.8 m<sup>2</sup> (About)

Non-Domestic GFA: 297 m<sup>2</sup> (About)

Nos. of Proposed Structures: 2

#### Appendix 2

Location: DD 109 Lot 1142 (Part)

OZP: S/YL-KTN/11 District: Kam Tin North Zoning: Agriculture

Date: 15 October 2024

# Proposed Layout Plan

擬議佈局平面圖

擬議臨時動物寄養所連附屬設施 (為期5年)及相關填土工程

Proposed Temporary Animal Boarding Establishment with Ancillary Facilities For a Period of 5 Years and Associated Filling of


Land


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Location: DD 109 Lot 1142 (Part)

OZP: S/YL-KTN/11 District: Kam Tin North Zoning: Agriculture

Date: 22 November 2024

Paved Area 平整位置圖

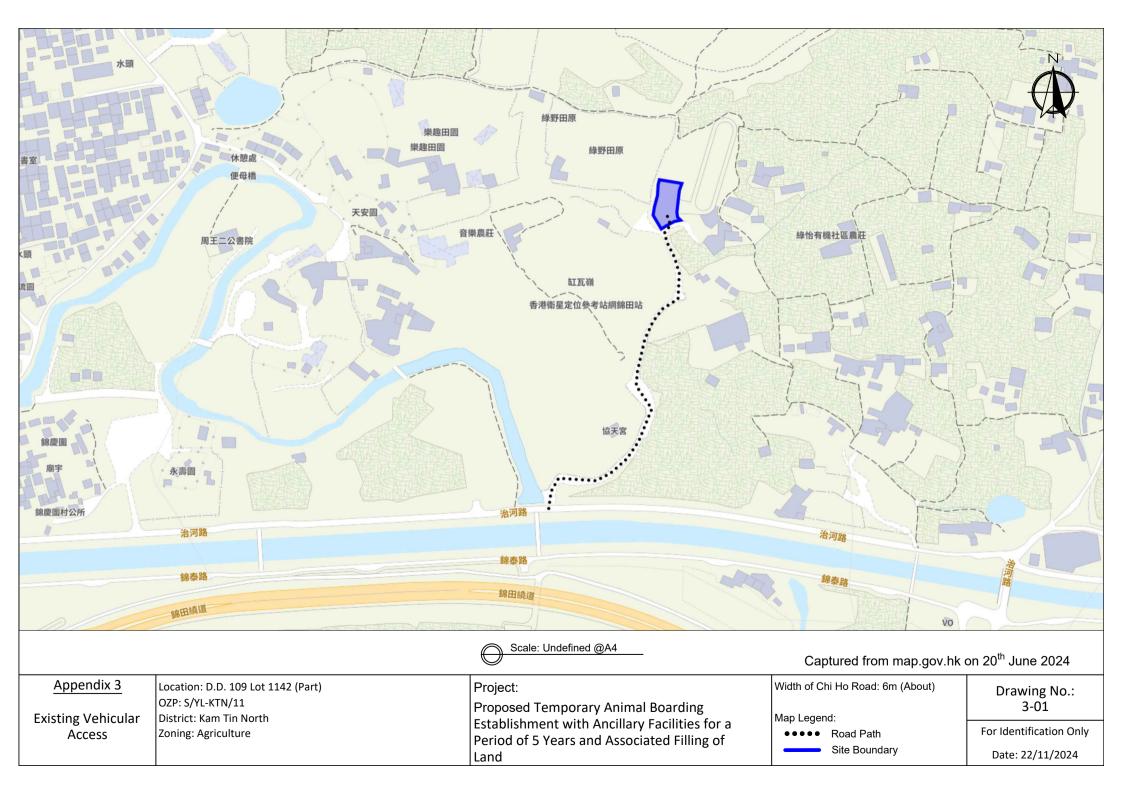擬議臨時動物寄養所連附屬設施 (為期5年)及相關填土工程

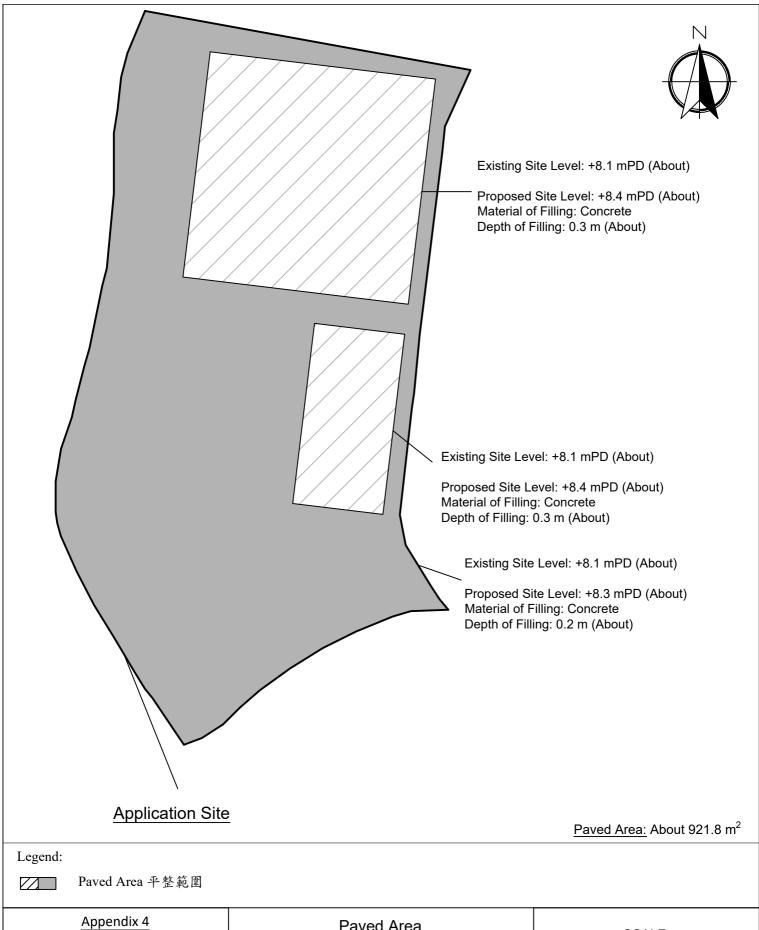Proposed Temporary Animal Boarding Establishment with Ancillary Facilities For a Period of 5 Years and Associated Filling of Land SCALE

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For Identification Only

# Appendix Ia of RNTPC Paper No. A/YL-KTN/1075A

Subject: (Update 2) A/YL-KTN/1075 - Further Information Thank you for the phone call. Please see the attachment section for the further information. If you have any question regarding to the application, please do not hesitate to contact Mr. Tang on or email to phone AYL-KTN 1075 20241227.pdf Yours Sincerely, Mr. Tang

2024年12月27日星期五 11:37

tpbpd/PLAND

寄件日期:

收件者:

城市規劃委員會:

### 有關城市規劃委員會對 A/YL-KTN/1075 的查詢

收悉 貴委員會對 A/YL-KTN/1075 申請的查詢,現以書面回覆。

本寄養所屬於個人營運,暫未計畫與義工團隊合作。申請計劃暫時收容 流浪狗,不會收取任何費用,因此未有計畫向有關署方申請動物寄養所牌照。

當收到有流浪狗的資訊,會安排員工或聯絡義工前往接手,之後送往寄 養所,本申請亦會與寵物店聯絡,當有物資有多時,可向寄養所捐贈,例如接 近最佳食用日期的狗糧,暫未計畫收受捐款。

污水方面,本申請計劃建造符合環境保護署所定下的 ProPECC PN 5/93 指引的化糞池來收集寄養所內的污水。化糞池及滲水井的距離會遠離水池及河道至少 15 米,由於申請地點附近的水池及溪流/河道不是用作飲用用途,此距離亦符合環境保護署所定下的 ProPECC PN 5/93 指引,有關化糞池及滲水井不會連接雨水渠,務求對附近的污染降至零污染,確保附近的水源及土地不會被此申請用途污染。

寄養所佈局平面圖方面,請參考 Appendix 2。

此外,場內的狗隻戶外活動範圍會以矮身圍欄圍起,以防止車輛進入。

本申請最多容納不超過 26 隻狗隻。

本申請計劃使用隔音及隔熱的鋁板作為寄養所的牆身及頂部,鋁板與鋁板之間有聚氨酯,下圖為參考圖:



此外,寄養所計劃安裝 24 小時通風系統及冷風機,例如抽氣扇等,為寵物提供良好的居住空間。

由於寄養所計劃使用隔音及隔熱的鋁板作牆身及頂部,現場亦以「鋅鐵 皮」物料圍起申請地點,有效降低外來刺激刺激動物。

由於本申請在營業時間外(即從下午六時至上午八時)會有動物過夜,本人 計劃安排約 1-2 個員工在場內過夜,以便處理突發事情。日間會有 3-4 員工, 並會安排義工輔助。


為了方便上落寵物及寵物糧食等物品和向員工及外來使用人士提供便利 駕車到本申請地點,現申請二個客貨車上落貨位置。此申請也包括 1 個員工及 2 個外來使用人士(即有透過電話通知員工的客人)的停車位,共 3 個泊車 位。由於本人計劃要求前往本寄養所的人士需要透過電話通知寄養所的員工, 並不接受散客(即未有透過電話通知員工的客人),可以控制使用人次。因 此,3 個車位已足夠此申請運作,包括職員及外來人士(即有透過電話通知員 工的客人)的需求。


在非營業時間,寵物不會到戶外,只留在寄養所內,以免影響周遭。在 營業時間中,動物會到戶外空間,動物數量會因應員工人數調整,但同一時間 不會多過6隻動物到戶外。到戶外時會使用輔助工具減少來自動物的嘈音,例 如狗口罩等。 本申請不會使用哨子及不需要使用任何擴音設備進行廣播,以免為附近 環境產生不良影響。

希望此附加文件能釋除 貴委員會的查詢,並支持本申請。

	Proposed Structures Details							
	Structures Gross Floor Area (GFA) Height (Not Exceeding) Store							
Α	Animal Boarding Establishment	About 225 m <sup>2</sup>	4m	1 only				
В	Ancillary Office	About 72 m <sup>2</sup>	4m	1 only				
	Total	About 297 m <sup>2</sup>						
	Private Car Parking Space	Unit(s): 3						
	LGV L/UL Space	Unit(s): 2						



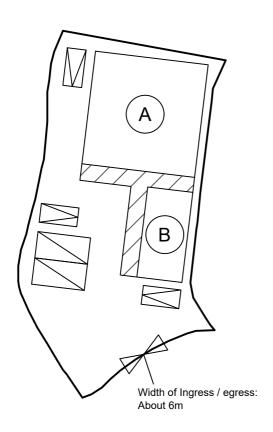

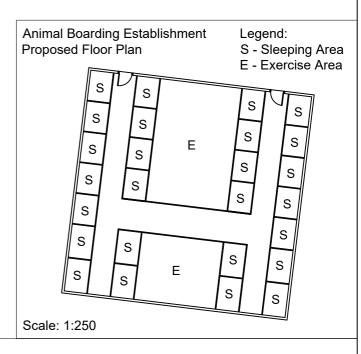

Legend:

Ingress/egress (Width: About 6m)  $\bowtie$ 

0 **Proposed Structures** 

**Private Car Parking Space**  $\geq$ 

LGV L/UL Space

ZZZDog Outdoor Activity Area **Animal Boarding Establishment** 

**Ancillary Office** 

Total Area: 921.8 m<sup>2</sup> (About)

Covered Area: 297 m<sup>2</sup> (About)

Uncovered Area: 624.8 m<sup>2</sup> (About)

Non-Domestic GFA: 297 m<sup>2</sup> (About)

Nos. of Proposed Structures: 2

#### Appendix 2

Location: DD 109 Lot 1142 (Part)

OZP: S/YL-KTN/11 District: Kam Tin North Zoning: Agriculture

Date: 24 December 2024

## Proposed Layout Plan

擬議佈局平面圖

擬議臨時動物寄養所連附屬設施 (為期5年)及相關填土工程

**Proposed Temporary Animal Boarding Establishment with Ancillary Facilities** For a Period of 5 Years and Associated Filling of

Land

For Identification Only

**SCALE** 

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# Appendix Ib of RNTPC Paper No. A/YL-KTN/1075A

寄件者:

寄件日期: 2025年04月11日星期五 17:07

收件者: tpbpd/PLAND

副本: David Chi Chiu CHENG/PLAND

主旨: Re: S. 16 Planning Application no. A/YL-KTN/1075 - Departmental Comments

附件: AYL-KTN 1075 FI 20254011.pdf

類別: Internet Email

#### Town Planning Board,

I would like to supersede the email that was sent on 14:56 11th April 2025 with this email and attachment. Please see the attachment for the further inforation on the captioned Application. Please contact Mr. Tang via email if you have any question regarding to the captioned application.

Yours Faithfully, Mr. Tang 城市規劃委員會:

### 有關城市規劃委員會對 A/YL-KTN/1075 的查詢

收悉 貴委員會對 A/YL-KTN/1075 申請的查詢,現以書面回覆。

本寄養所屬於個人營運,暫未計畫與義工團隊合作。申請計劃暫時收容 流浪狗,不會收取任何費用,因此未有計畫向有關署方申請動物寄養所牌照。

當收到有流浪狗的資訊,會安排員工或聯絡義工前往接手,之後送往寄 養所,本申請亦會與寵物店聯絡,當有物資有多時,可向寄養所捐贈,例如接 近最佳食用日期的狗糧,暫未計畫收受捐款。

污水方面,本申請計劃建造符合環境保護署所定下的 ProPECC PN 5/93 指引的化糞池來收集寄養所內的污水。化糞池及滲水井的距離會遠離水池及河道至少 15 米,由於申請地點附近的水池及溪流/河道不是用作飲用用途,此距離亦符合環境保護署所定下的 ProPECC PN 5/93 指引,有關化糞池及滲水井不會連接雨水渠,務求對附近的污染降至零污染,確保附近的水源及土地不會被此申請用途污染。

寄養所佈局平面圖方面,請參考 Appendix 2。

此外,場內的狗隻戶外活動範圍會以矮身圍欄圍起,以防止車輛進入。

本申請最多容納不超過 26 隻狗隻。

本申請計劃使用隔音及隔熱的鋁板作為寄養所的牆身及頂部,鋁板與鋁板之間有聚氨酯,下圖為參考圖:



此外,寄養所計劃安裝 24 小時通風系統及冷風機,例如抽氣扇等,為寵物提供良好的居住空間。

由於寄養所計劃使用隔音及隔熱的鋁板作牆身及頂部,現場亦以「鋅鐵 皮」物料圍起申請地點,有效降低外來刺激刺激動物。

由於本申請在營業時間外(即從下午六時至上午八時)會有動物過夜,本人 計劃安排約 1-2 個員工在場內過夜,以便處理突發事情。日間會有 3-4 員工, 並會安排義工輔助。

為了方便上落寵物及寵物糧食等物品和向員工及外來使用人士提供便利 駕車到本申請地點,現申請兩個客貨車上落貨位置。此申請也包括 1 個員工及 2 個外來使用人士(即有透過電話通知員工的客人)的停車位,共 3 個泊車 位。由於本人計劃要求前往本寄養所的人士需要透過電話通知寄養所的員工, 並不接受散客(即未有透過電話通知員工的客人),可以控制使用人次。因 此,3 個車位已足夠此申請運作,包括職員及外來人士(即有透過電話通知員 工的客人)的需求。

在非營業時間,寵物不會到戶外,只留在寄養所內,以免影響周遭。在 營業時間中,動物會到戶外空間,動物數量會因應員工人數調整,但同一時間 不會多過6隻動物到戶外。到戶外時會使用輔助工具減少來自動物的嘈音,例 如狗口罩等。 本申請不會使用哨子及不需要使用任何擴音設備進行廣播,以免為附近 環境產生不良影響。

希望此附加文件能釋除 貴委員會的查詢,並支持本申請。

城市規劃委員會:

## 有關城市規劃委員會對 A/YL-KTN/1075 的意見回覆

收悉 貴委員會對 A/YL-KTN/1075 申請的意見,現以書面回覆。

放置物料方面,為了準備平整及興建臨時構築物,現場放置了少量建築物料,當規劃申請成功後便會進行工程。如萬一未能獲批,亦會盡快清理及還原。

雖然申請地點坐落於「農業」地帶,附近有農田、空置土地、臨時建築物及樹群,但亦有大量坐落於同一個「農業」地帶的土地已進行發展,例如申請地點的東、南及西面,不少地點已使用混凝土及瀝青碎石平整,並用在與農業外的用途。此外,申請地點的附近有不少建築物散佈在四周,本申請興建構築物的高度亦興鄰近的建築物相近,因此不會大型改變附近的景觀,亦興附近的景觀特點相約。

希望此附加文件能釋除貴 委員會的隱憂,並支持本申請。

地政總署及城市規劃委員會:

#### 有關地政總署對 A/YL-KTN/1075 的查詢

收悉 貴署對 A/YL-KTN/1075 申請的意見,現以書面回覆。

收悉 貴署根據丈量約份第 109 約地段第 1142 號的現場違例建築物,並知悉 貴署的密切關注。當申請獲批會向 貴署短期豁免書,並會遵從 貴署所批出短期豁免書內例明的條款。我們已知觸犯上述條例的嚴重性,並會盡快糾正及申請短期豁免書。申請範圍內亦只會興建臨時建築物,符合 貴署要求。

希望此附加文件能釋除 貴署的隱憂,並支持本申請。

園境組及城市規劃委員會:

#### 有關園境組對 A/YL-KTN/1075 的查詢

收悉 貴組對 A/YL-KTN/1075 申請的意見,現以書面回覆。

申請地點的平整範圍,如果使用沙或泥土作平整物料,則未能提供用混凝土的好處。用混凝土平整後能提供乾淨的環境給使用者清潔,也避免當使用者離開時帶走泥土,防止發生水土流失的情況。

此外,經平整後的地方可以把有關構築物繫穩及鞏固,方便設計及建設渠道,並提供了空間給車輛轉動及停泊,避免車輛因濕滑的泥土而未能移動。

再者,本申請設有戶外活動空間,以混凝土平整有效阻止害蟲爬到狗隻 身上,並防止狗隻興狗隻之間的傳播。

由於本申請範圍比較細小,平整的範圍及大小已經營運所需最小。

申請結束後亦會將鋪地的物料打碎並運走,回復適宜農業的用途,不會為該地造成長遠影響。

希望此附加文件能釋除 貴組的隱憂,並支持本申請。

運輸署及城市規劃委員會:

### 有關對運輸署 A/YL-KTN/1075 的查詢

收悉 貴署對 A/YL-KTN/1075 申請的意見,現以書面回覆。

出入本申請地點主要使用治河路,該道路為一條雙線雙程的道路。 預計本申請地點的車流為以下:

時段	私家車		輕型貨車		中型貨車		重型貨車		進出
	進	出	進	出	進	出	進	出	總和
早上時段 (7:00-11:59)	3	0	2	0	0	0	0	0	5
下午時段 (12:00-	0	3	0	2	0	0	0	0	5
23:59)									
凌晨時段 (0:00-06:59)	0	0	0	0	0	0	0	0	0

治河路的設計容量為每小時可容納 800 輛車輛使用,根據上述統計數字,治河路的使用數字低於設計容量,因此仍可容納本申請新增的車流量。

申請地點有道路連接,前往本申請地點途經治河路,再轉到郊區小徑前 行大約 100 米到達申請地點。治河路沿途道路約有 6 米闊。並設有避車處,私 家車及客貨車有足夠的位置通過及進行調遣的動作。申請地點的出入口約 6 米 闊。連接道路相片請參考文件末端。

連接本申請地點的郊區小徑為私人道路,本人已獲得有關地段的擁有人 及其持分者同意使用相關地段作出入通道,此通道亦會用作緊急用途。

在申請地點內有一個直徑超過 14 米的圓形空間,足夠讓車輛進行調遣的動作,進入本申請地點的車輛不會在公用道路上讓車輛等候進入本申請地點,停泊在公用道路及以倒後形式進出本申請地點。參考文件末端的 Appendix 2。

本人明白及了解連接申請地點的道路不是由 貴署管理。


希望此附加文件能釋除 貴署的隱憂,並支持本申請。


由治河路連接申請地點的路口相片:



	Proposed Structures Details							
	Structures Gross Floor Area (GFA) Height (Not Exceeding) Store							
Α	Animal Boarding Establishment	About 225 m <sup>2</sup>	4m	1 only				
В	Ancillary Office	About 72 m <sup>2</sup>	4m	1 only				
	Total	About 297 m <sup>2</sup>						
	Private Car Parking Space	Unit(s): 3						
	LGV L/UL Space	Unit(s): 2						



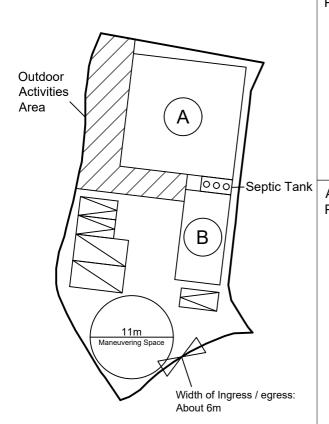

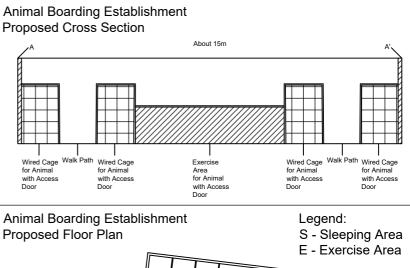

Legend:

Proposed Structures

Private Car Parking Space

□ LGV L/UL Space

Dog Outdoor Activity Area

Animal Boarding Establishment

(B) Ancillary Office

Total Area: 921.8 m<sup>2</sup> (About)

Covered Area: 297 m<sup>2</sup> (About)

Uncovered Area: 624.8 m<sup>2</sup> (About)

Non-Domestic GFA: 297 m<sup>2</sup> (About)

Nos. of Proposed Structures: 2

Outdoor Activities Area: 142 m<sup>2</sup> (About)

Appendix 2

Location: DD 109 Lot 1142 (Part)

OZP: S/YL-KTN/11 District: Kam Tin North Zoning: Agriculture

Date: 11 April 2025

Proposed Layout Plan

擬議佈局平面圖

擬議臨時動物寄養所連附屬設施及相關填土工程(為期5年)


Proposed Temporary Animal Boarding Establishment with Ancillary Facilities and Associated Filling of Land For a Period of 5 Years

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For Identification Only



For a Period of 5 Years

Date: 11 April 2025

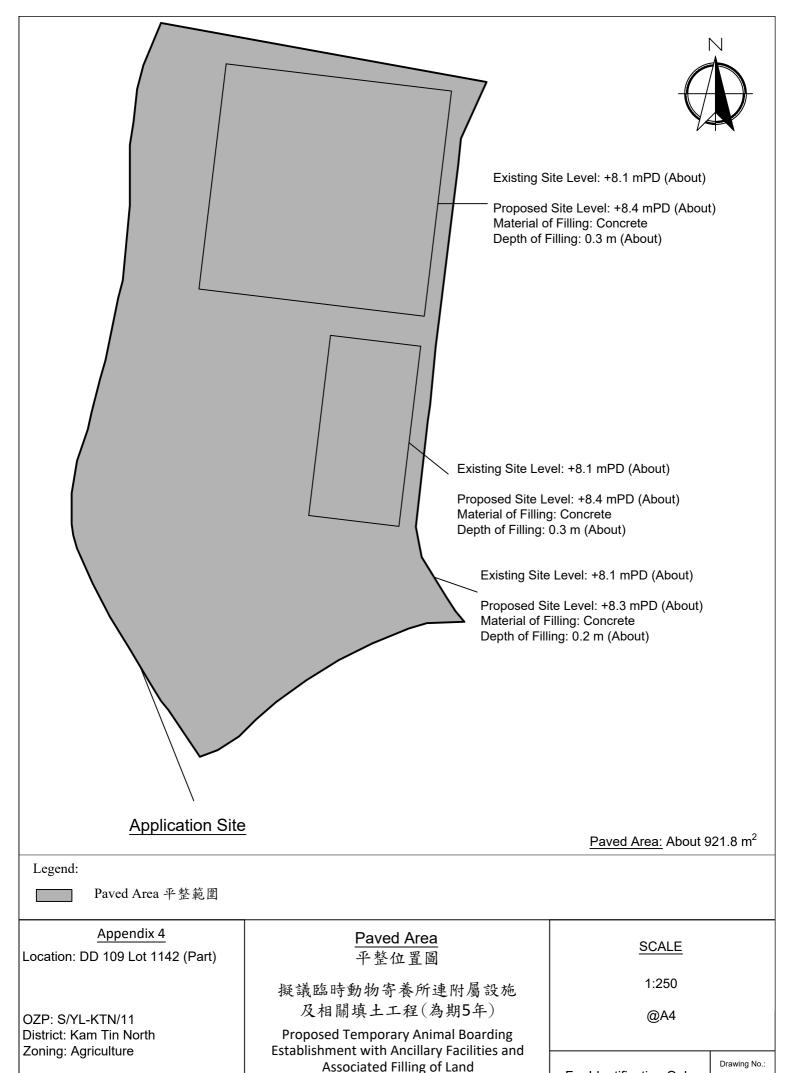
For Identification Only

Drawing No.:

4-01

	Proposed Structures Details										
	<u>Structures</u>	Gross Floor Area (GFA)	Height (Not Exceeding)	Storey							
Α	Animal Boarding Establishment	About 225 m <sup>2</sup>	4m	1 only							
В	Ancillary Office	About 72 m <sup>2</sup>	4m	1 only							
	Total	About 297 m <sup>2</sup>									
	Private Car Parking Space	Unit(s): 3		·							
	LGV L/UL Space	Unit(s): 2									



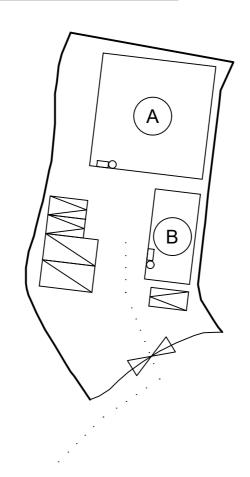

\*All FSI (includes installation/maintenance/modification/repair work) will be completed by RFSIC.

For Emergency Vehicular Access, Please see Appendix 6.1

\*All the enclosed structures are provided with access for emergency vehicles to reach within 30m travel distance from the structures.

# Legend:

O 5 kg Portable Carbon Dioxide Type Fire Extinguisher (2 in Total)

Emergency Lighting (BS 5266-1:2016, BS EN 1838:2013 and the FSD Circular Letter No. 4/2021) (2 in Total)

Emergency Vehicular Access

Animal Boarding Establishment

Private Car Parking Space

(B) Ancillary Office

□ LGV L/UL Space

			ix	

Location: DD 109 Lot 1142 (Part)

App. No.: A/YL-KTN/1075

OZP: S/YL-KTN/11 District: Kam Tin North Zoning: Agriculture

Date: 11 April 2025

# Proposed Fire Service Installation Plan

擬議消防設備安裝計劃圖

擬議臨時動物寄養所連附屬設施 及相關填土工程(為期5年)

Proposed Temporary Animal Boarding Establishment with Ancillary Facilities and Associated Filling of Land

For a Period of 5 Years

# **SCALE**


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For Identification Only

Drawing No.:

6-01



渠務署及城市規劃委員會:
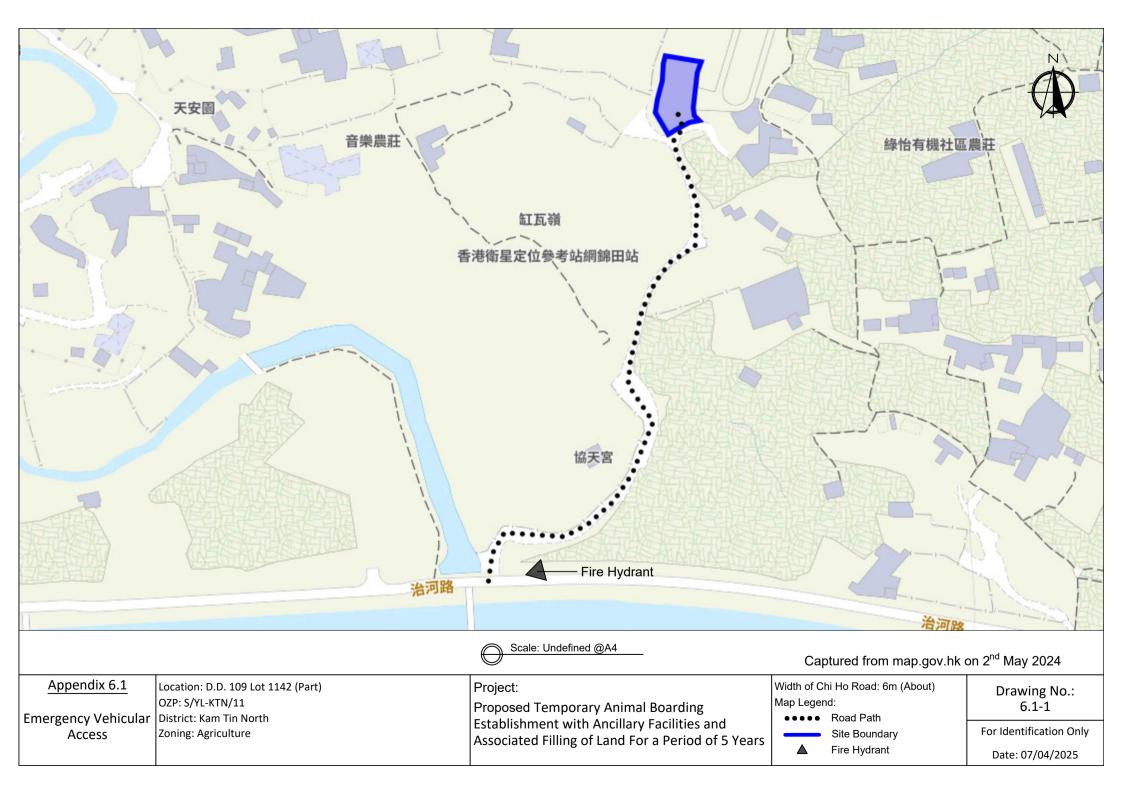
# A/YL-KTN/1075 的渠務報告詳細

申請地點範圍有約 921.8 平方米,位於錦田北的鄉郊範圍。目前為露天空間。

申請地點附近有臨時建築物及草地。現有水平為約+8.0 mPD。

有一條溪流位於申請地點的西南面,並計劃將場內水流引導到該溪流。

申請範圍的東北及西面水平比申請地點高,有機會有水流從這兩個方向 流入。申請範圍北面約 61 米外有一條由民政事務處管理的渠道,因此沒有流 水從其他方向流入申請地點。

申請地點的擬議佈局平面圖請參考 Appendix 2。

申請地點範圍有約 921.8 平方米,全部將以混凝土作表面,在申請地點外有約 6,771 平方米的流水流入申請範圍,大多為草地及建築物。集水區一共有約 7,693 平方米。

擬議發展	
申請地點範圍 (約 m²),全部已以混	921.8
凝土平整	
申請地點外集水區	
申請地點外東北及西面集水區 (約	6,771
m <sup>2</sup> ),大多為草地及建築物,本報告	
將以約15%混凝土及瀝青作評估,詳	
細請參考 Appendix 5.2-1。	

根據 STORMWATER DRAINAGE MANUAL (SDM) - Table 10 - Recommended Design Return Periods based on Flood Levels

Intensively Used Agricultural Land	2-5 years
Village Drainage including Internal Drainage	10 years
System under a Polder Scheme	
Main Rural Catchment Drainage Channels	50 years
Urban Drainage Trunk Systems	200 years
Urban Drainage Branch Systems	50 years

本報告將使用 Main Rural Catchment Drainage Channels, 1 in 50 years return period 作評估。

 Intensity-Duration-Frequency Relationship - The Recommended Intensity-Duration-Frequency relationship is used to estimate the intensity of rainfall. It can be expressed by the following algebraic equation.

$$i = \frac{a}{(t_d + b)^c}$$

The site is located within the HKO Headquarters Rainfall Zone. Therefore, for 50 years return period, the following values are adopted. (The latest figures are provided in Corrigendum No.1 2024 Stormwater Drainage Manual)

2. The peak runoff is calculated by the Rational Method.

$$Q_p = 0.278 \ C \ i \ A$$

where 
$$V = peak runoff in m^3/s$$

C = runoff coefficient (dimensionless)

i = rainfall intensity in mm/hr

A = catchment area in km<sup>2</sup>

3. According to Section 7.5.2(b) of the Stormwater Drainage Manual (SDM), Fifth Edition January 2018

Surface Characteristics	Runoff coefficient, C
Asphalt	0.70-0.95
Concrete	0.80-0.95
Brick	0.70-0.85
Grassland (heavy soil)	
Flat	0.13-0.25
Steep	0.25-0.35
Grassland (sandy soil)	
Flat	0.05-0.15
Steep	0.15-0.20

The run-off coefficient (C) of surface runoff area taken as follows:

- Concrete Area C = 0.95

- Grassland (heavy soil) C = 0.25

4. Manning's Equation is used for calculation of velocity of flow inside the channels. It can be expressed by the following algebraic equation.

$$V = \frac{R^{1/6}}{n} \sqrt{RS_f}$$

where V = Velocity of the pipe flow (m/s)

S<sub>f</sub> = Hydraulic gradient

n = manning's coefficient

R = Hydraulic radius (m)

5. Colebrook-White Equation is used for calculation of velocity of flow inside the pipes. It can be expressed by the following algebraic equation.

$$\bar{V} = -\sqrt{8gDs} \, ||| \log \left( \frac{k_s}{3.7D} + \frac{2.51v}{D\sqrt{2gDs}} \right)$$

where V = Velocity of the pipe flow (m/s)

g = gravitational acceleration (m/s²)

S = Hydraulic gradient (energy loss per unit length due to

K<sub>s</sub> = hydraulic pipeline roughness value (m)

v = kinematics viscosity of fluid (m<sup>2</sup>/s)

D = internal pipe diameter (m)

申請範圍主要平坦,並緩緩斜向西南面,渠道設計請參考 Appendix 5。

渠道容量計算請參考 Appendix - Calculation。

根據本報告,本臨時發展不會對附近的渠道有重大影響。

# Check The Capacity of Existing Natural Stream (For details, please refer to A1, A2 and A3.)

Manning Equation is used in hydraulic design and analysis. The cross-sectional mean velocity is given in the following expression:

$$V = \frac{R^{1/6}}{n} \sqrt{RS_f}$$

Where

R = hydraulic (m)


N = Manning coefficient (s/m1/3), refer Table 13 of SDM

Sf = friction gradient (dimensionless)

Using Manning's Equation

$$V = R^{2/3} * S_f^{0.5} / n$$

For assessment purpose, assume width and depth of the existing natural stream is 1m.

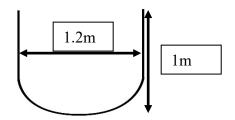

Where R = A/P = 0.333 m A = 1 
$$m^2$$
  
P = 3 m  
n = 0.05 s/m<sup>1/3</sup> (Table 13 of Stormwater Drainage Manual)

$$S_f = 0.03$$


Therefor V = 
$$0.333^{2/3}*0.03^{0.5}/0.05$$
  
=  $1.66$  m/sec


Maximum Capacity (Qmax)

$$= 1.66 \text{ m}^3/\text{sec}$$


\*Allowed 10% for siltation.


The Existing Natural Stream has enough capacity.

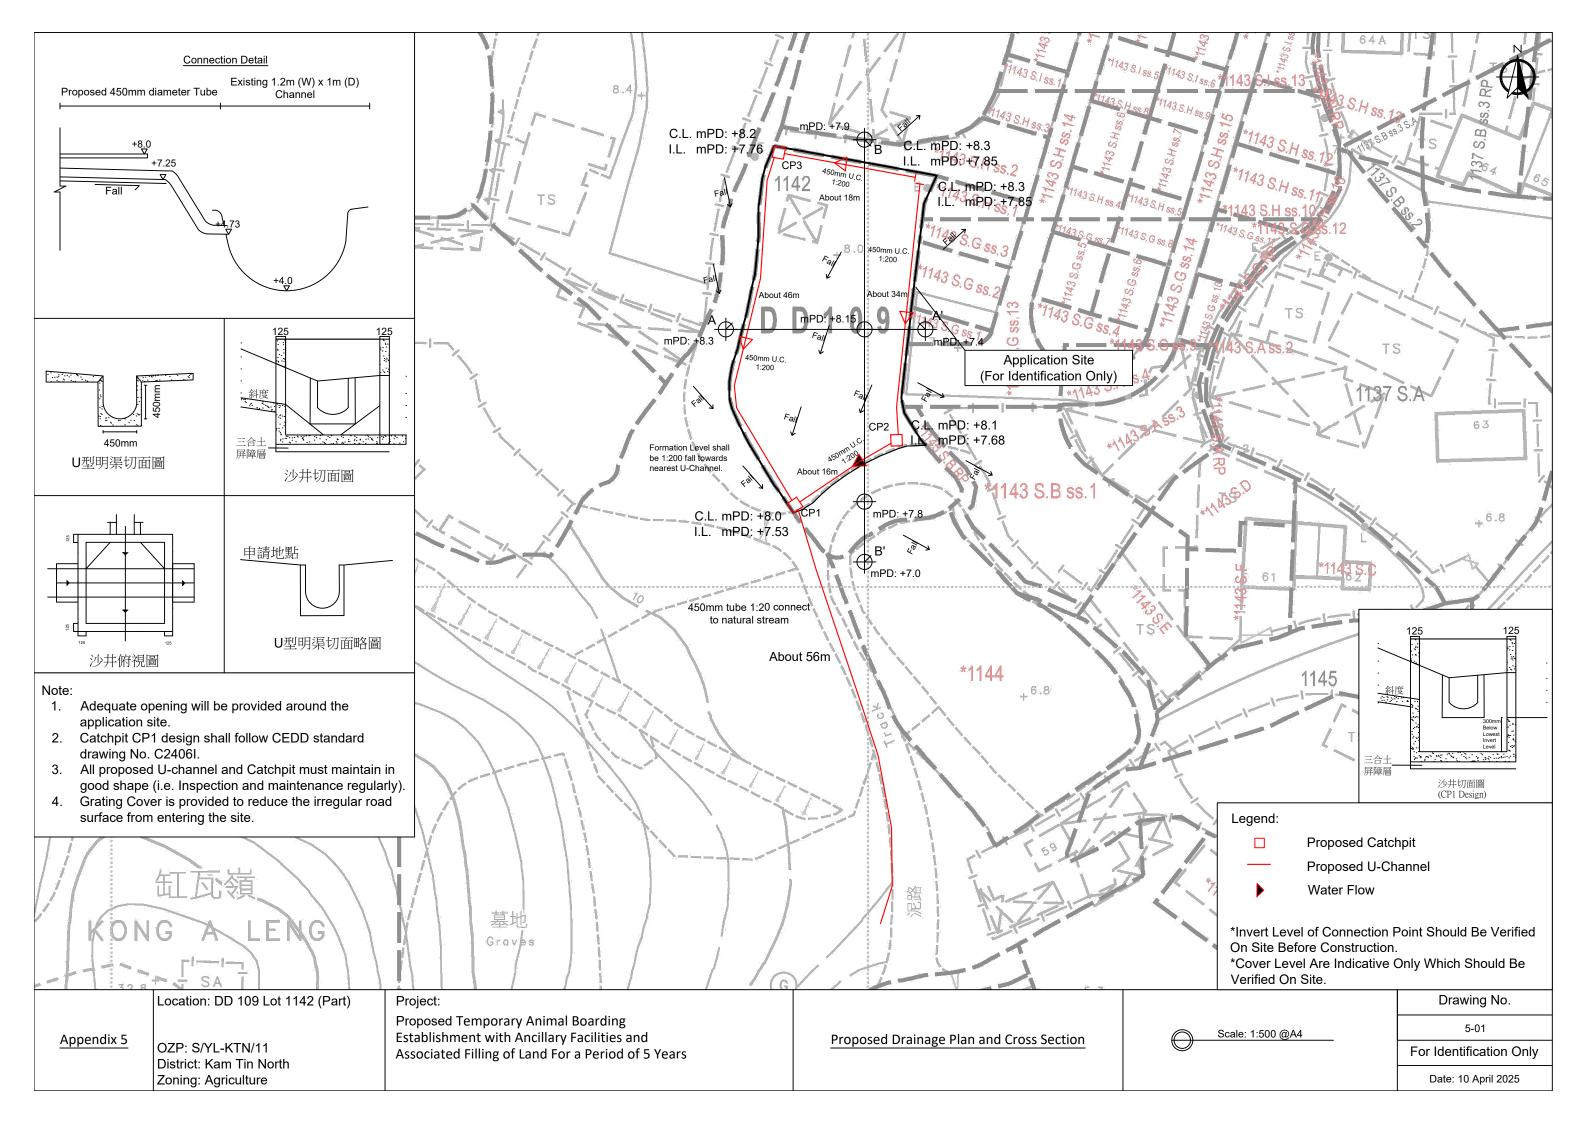


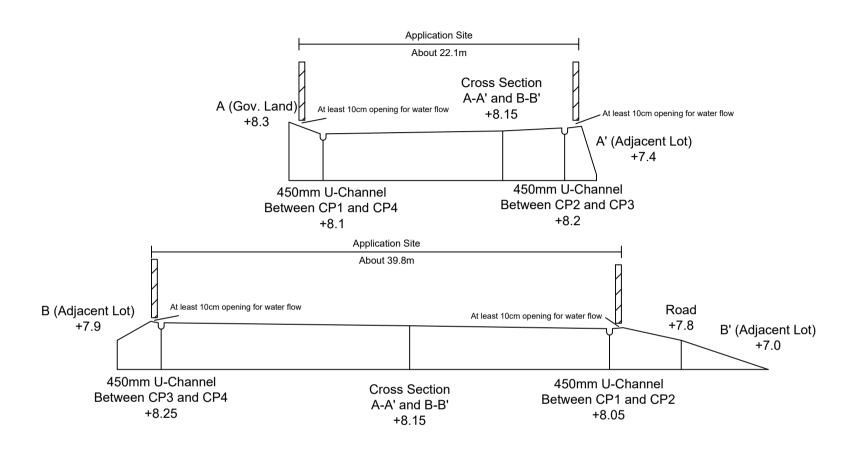



Appendix 5.1	Location: D.D. 109 Lot 1142	Project: Proposed Temporary Animal Boarding	Drawing No.:	
Cross Section	OZP: S/YL-KTN/11	Establishment with Ancillary Facilities and Associated Filling of Land For a Period of 5 Years	5.1-1	
A-A' B-B'	District: Kam Tin North Zoning: Agriculture		For Identification Only	
			Date: 10/04/2025	

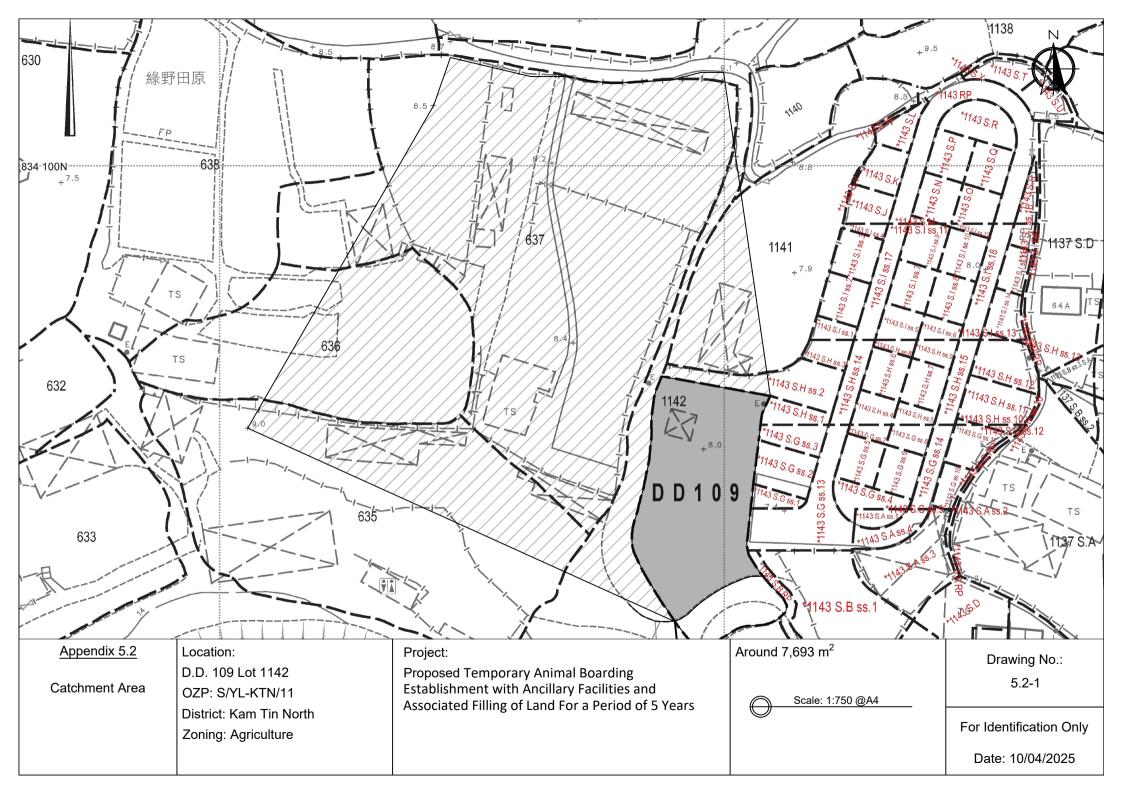

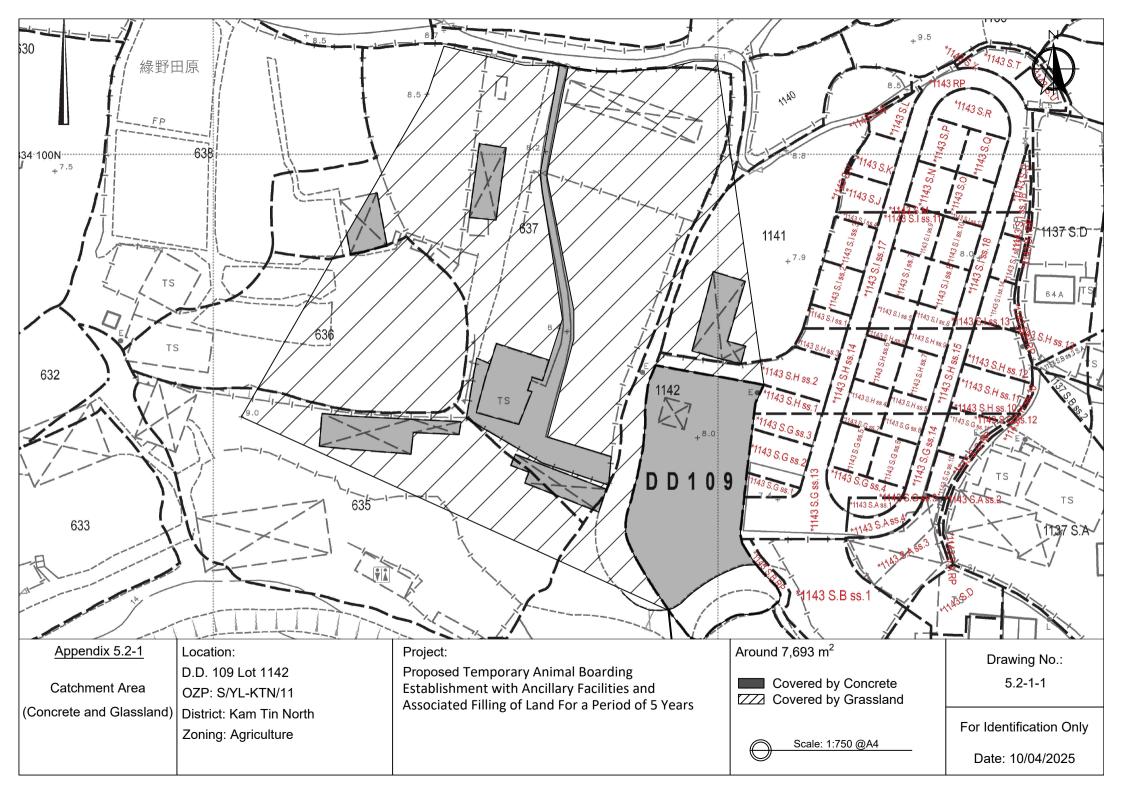

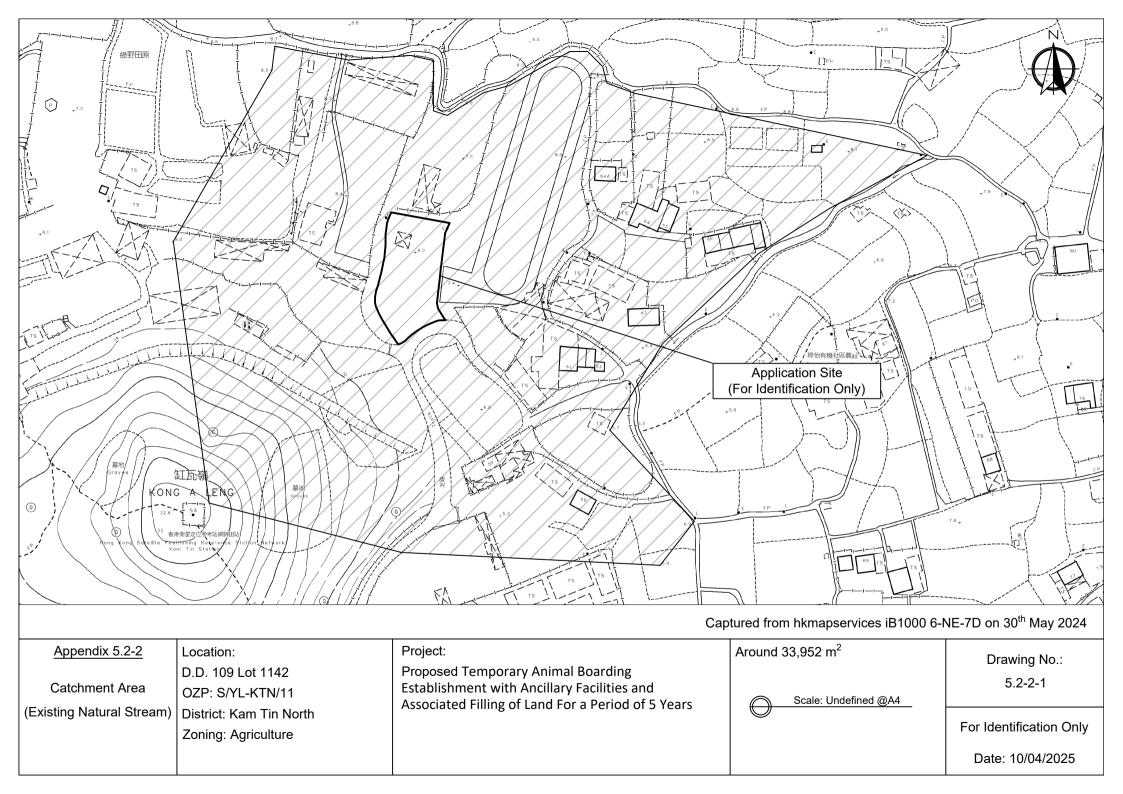

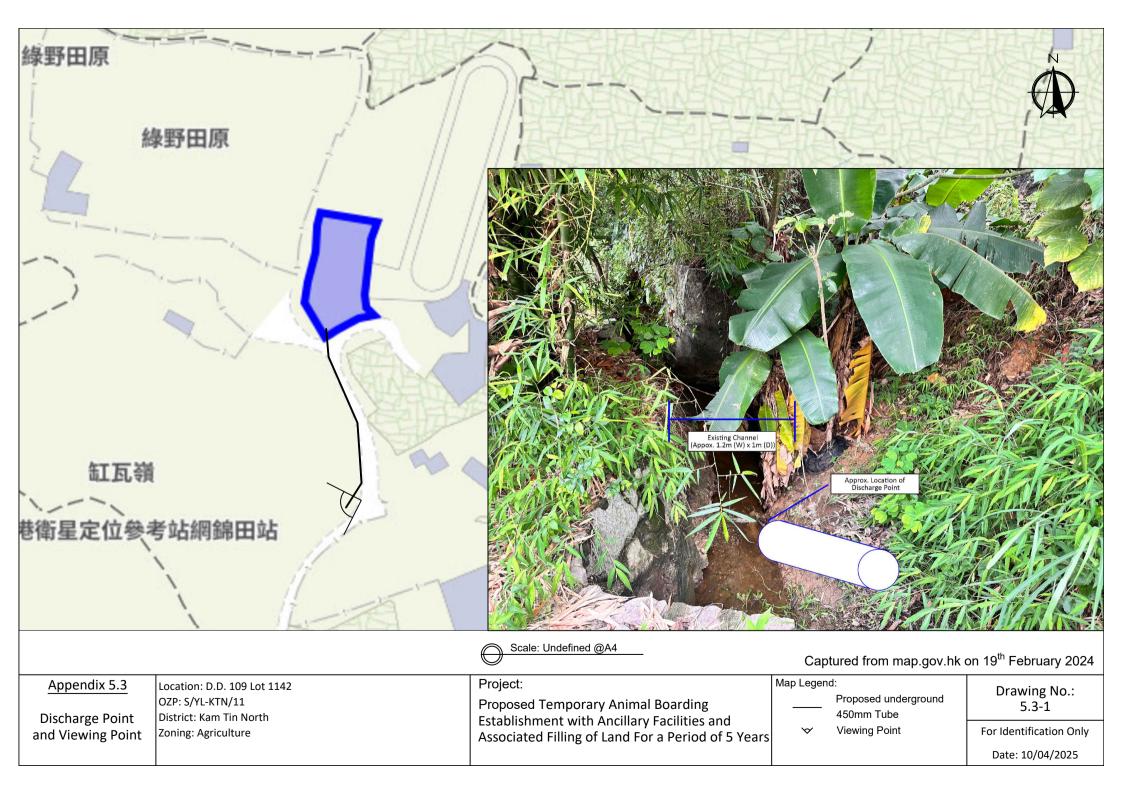

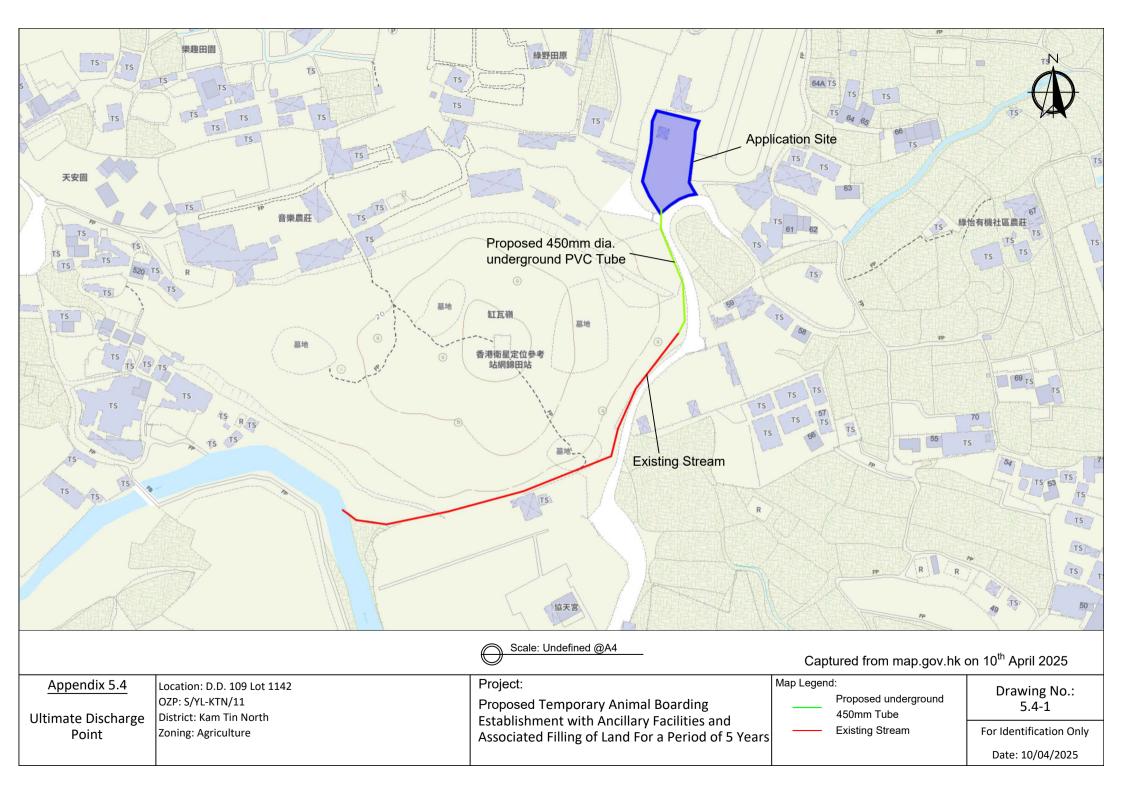

Capacity Flows Estimation for Propose Catchments and Drainage System with 50 Year Return Period

# Note:

Runoff is calculated in accordance with DSD's "Stormwater Drainage Manual – Planning, Design and Management" (SDM), fifth edition, January 2018.

Equation used: 
$$t_c = \frac{0.14465L}{H^{0.2}A^{0.1}}$$

$$i = \frac{a}{(t_d + b)}$$

$$i = \frac{a}{(t_d + b)^c}$$
  $Q_p = 0.278 C i A$   $V = \frac{R^{1/6}}{n} \sqrt{RS_f}$ 

$$V = \frac{R^{1/6}}{n} \sqrt{RS_f}$$

# A1. Calculation of the runoff of Existing Drainage System (For Concrete)

Surface Type	Catchment Area (A), m <sup>2</sup>	Catchment Area (A), km²	Average slope (H), m/100m	Flow path length (L), m	Time of Concentration (t <sub>c</sub> ), min	a (50 year return period)	b (50 year return period)	c (50 year return period)	Runoff intensity  (i) mm/hr (due  to climate  change, will  include 11.1%  increase)	Runoff coefficient (C)	C×A	Peak runoff (Q <sub>p</sub> ), m <sup>3</sup> /s
50% Concrete + 50% Grassland (Heavy soil) with flat surface	33,952/2=16976	0.016976	1.76	182	11.085	505.5	3.29	0.355	218	0.95	0.0161272	1.34

1.34

Total

# A2. Calculation of the runoff of Existing Drainage System (For Grassland)

Surface Type	Catchment Area (A), m²	Catchment Area (A), km²	Average slope (H), m/100m	Flow path length (L), m	Time of Concentration (t <sub>c</sub> ), min	a (50 year return period)	b (50 year return period)	c (50 year return period)	Runoff intensity (i) mm/hr (due to climate change, will include 11.1% increase)	Runoff coefficient (C)	CxA	Peak runoff (Q <sub>p</sub> ), m <sup>3</sup> /s
50% Concrete + 50%												
Grassland (Heavy soil)	33,952/2=16976	0.016976	1.76	182	11.085	505.5	3.29	0.355	218	0.35	0.0161272	0.36
with flat surface												

### A3. Adequacy Check for Existing Drainage System

Channel Type	Width, m	Depth, m	Slope	Length, m	Manning's Roughness Coefficient	Cross Section Area, m2	Wetted Perimeter, m	Hydraulic radius, m	Mean Velocity, m/s	Capacity flow, m3/s	Catchment Served, km <sup>2</sup>	Runoff, m3/s	% of capacity	Sufficient Capacity (Y/N)
Concrete Channel	1.2	1	0.03	140	0.05	1	3	0.333	1.66	1.66	0.033952	1.23	74%	Υ

<sup>\*</sup>Allowed 10% for siltation. For assessment purpose, assume width and depth of the existing natural stream is 1m.

<sup>\*</sup> Detail please refer to DSD report.

Outside Catchment Area	=	$1,015.6 \text{ m}^2$	(About)	C:	0.95 (Covered with Concrete)
	=	$5755.2 \text{ m}^2$	(About)	C:	0.25 (Covered with Grassland (heavy soil)
	=	$6,770.8 \text{ m}^2$	(About)		
The Application Site	=	$921.8 \text{ m}^2$	(About)	C:	0.95 (Covered with Concrete)

# Calculation of Desgin Runoff of the Proposed Development, For the design of drains inside the site, For Concrete

 $Q_p = 0.278C I A$ 

$$A = 1,015.6 + 921.8 m2$$
  
= 1,937.4  $m2$   
= 0.0019374  $km2$ 

$$t = 0.14465L/H^{0.2}A^{0.1}$$

$$= 0.14465*120/0.58^{0.2}*1937.4^{0.1}$$

$$= 9.080 min$$

$$i = 1.111*a/(t+b)^{c}$$
  
= 1.111\*505.5/(7.911+3.29)<sup>0.355</sup>  
= 229.95472

Q = 0.278\*0.95\*230\*1937.4/1000000= 0.1176603 m<sup>3</sup>/sec = 7060 lit/min (50 years return period, Table 3a, Corrigendum 2024, SDM) and

(11.1% increase due to climate change)

Outside Catchment Area	=	$1,015.6 \text{ m}^2$	(About)	C:	0.95 (Covered with Concrete)
	=	$5755.2 \text{ m}^2$	(About)	C:	0.25 (Covered with Grassland (heavy soil)
	=	$6,770.8 \text{ m}^2$	(About)		
The Application Site	=	$921.8 \text{ m}^2$	(About)	C:	0.95 (Covered with Concrete)

# Calculation of Desgin Runoff of the Proposed Development, For the design of drains inside the site, For Grassland (heavy soil)

 $Q_p = 0.278C I A$ 

A = 5,755.2  $m^2$ = 0.0057552  $km^2$ 

 $t = 0.14465L/H^{0.2}A^{0.1}$   $= 0.14465*120/0.58^{0.2}*5755.2^{0.1}$  = 8.143 min

 $i = 1.111*a/(t+b)^{c}$  (50 years return period, Table 3a, = 1.111\*505.5/(8.143+3.29)<sup>0.355</sup> Corrigendum 2024, SDM) and

(11.1% increase due to climate change)

= 236.47344

Q = 0.278\*0.25\*236\*5755.2/1000000= 0.0945862 m<sup>3</sup>/sec = 5675 lit/min

Total Rainfall lit/min = 7060 + 5675 lit/min = 12735 lit/min

Provide 450UC (1:200) has enough capacity to accomend the runoff of the proposed development

Slopes

Guidelines

on Hydraulic Design of U-shaped and


Half-round Channels on

GEO

**Technical** 

**Guidance Note** 

# Figure 1 - Chart for the rapid design of U-shaped and half-round channels up to 600 mm

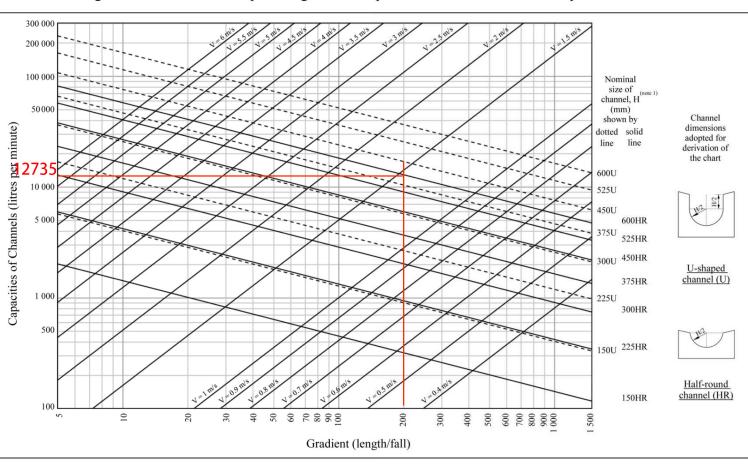

Note:

(1) Refer to the latest CEDD Standard Drawings for the details of U-shaped (U) and half-round (HR) channels.

Check 450mm dia. Pipes by Colebrook-White Equation

By Colebrook White Equation

$$V = -\sqrt{(8gDs)} \log \left( \frac{k_s}{3.7D} + \frac{2.51v}{D\sqrt{(2gDs)}} \right)$$

where:

V = mean velocity (m/s)

g = gravitational acceleration (m/s<sup>2</sup>)

D = internal pipe diameter (m)

k<sub>s</sub> = hydraulic pipeline roughness (m) (Table 14, from DSD SDM 2018, concrete pipe)

v = kinematic viscosity of fluid (m<sup>2</sup>/s) (Transitional flow and water at 15 degree celcius)

s = hydraulic gradient (energy loss per unit length due to friction)

 $g = 9.81 m/s^2$ 

D = 0.45 m

 $k_s = 0.00015 \text{ m}$ 

 $v = 1.14E-06 \text{ m/s}^2$ 

s = 0.01

Therefore, design V of pipe capacit = 2.34902 m/s

Q = 0.8VA (0.8 factor for sedimentation)

 $= 0.339709 \text{ m}^3/\text{s}$ 

= 20382.53 lit/min

> 12735 lit/min

Provide 450UC (1:200) has enough capacity to accomend the runoff of the proposed development

Concrete	=	16,976.0 m <sup>2</sup>	(About)	C:	0.95 (Covered with Concrete)
Grassland (heavy soil)	=	16,976.0 m <sup>2</sup>	(About)	C:	0.35 (Covered with Grassland (heavy soil)

Calculation of Runoff of the Existing Drainage System, For the existing drainage system, For Concrete

 $Q_p = 0.278C I A$ 

A = 16,976.0  $m^2$ = 0.0169760  $km^2$ 

 $t = 0.14465L/H^{0.2}A^{0.1}$ 

=  $0.14465*182/1.76^{0.2}*16976^{0.1}$ = 11.085 min

 $i = 1.111*a/(t+b)^{c}$ 

 $= 1.111*505.5/(11.085+3.29)^{0.355}$ 

= 218.01609

Q = 0.278\*0.95\*218\*16976/1000000

= 0.9774449 m<sup>3</sup>/sec = 58647 lit/min (50 years return period, Table 3a,


Corrigendum 2024, SDM) and


(11.1% increase due to climate change)

Concrete	=	16,976.0 m <sup>2</sup>	(About)	C:	0.95 (Covered with Concrete)
Grassland (heavy soil)	=	16,976.0 m <sup>2</sup>	(About)	C:	0.35 (Covered with Grassland (heavy soil)
Calculation of Runoff of the Existing drainage of the Existing drainage of the Existing drainage of the Existence of the Exis			•		
	$Q_p =$	0.278C I A			
		16,976.0 0.0169760	m <sup>2</sup> km	2	
		0.14465L/H <sup>0.2</sup> A <sup>0</sup> 0.14465*182/1.7 11.085		1	
	=	1.111*a/(t+b) <sup>c</sup> 1.111*505.5/(11 218.01609	.085+3.29) <sup>0.355</sup>		(50 years return period, Table 3a, Corrigendum 2024, SDM) and (11.1% increase due to climate change
	=	0.278*0.25*218 0.2572224 15433	*16976/100000 m <sup>3</sup> / lit/1	sec	
Total Rainfall m <sup>3</sup> /sec		0.977449 + 1.234671	0.257222 m <sup>3</sup> /m <sup>3</sup> /		

	Proposed Structures Details								
	<u>Structures</u>	Gross Floor Area (GFA)	Height (Not Exceeding)	Storey					
Α	Animal Boarding Establishment	About 225 m <sup>2</sup>	4m	1 only					
В	Ancillary Office	About 72 m <sup>2</sup>	4m	1 only					
	Total	About 297 m <sup>2</sup>							
	Private Car Parking Space	Unit(s): 3							
	LGV L/UL Space	Unit(s): 2							



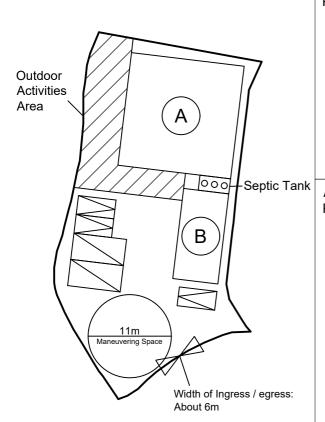

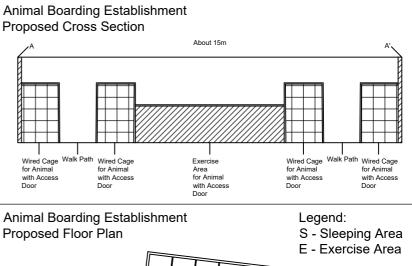

S

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Ε

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### Legend:

Proposed Structures

Private Car Parking Space

□ LGV L/UL Space

Dog Outdoor Activity Area

Animal Boarding Establishment

Scale: 1:250

(B) Ancillary Office

Total Area: 921.8 m<sup>2</sup> (About)

Covered Area: 297 m<sup>2</sup> (About)

Uncovered Area: 624.8 m<sup>2</sup> (About)

Non-Domestic GFA: 297 m<sup>2</sup> (About)

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Nos. of Proposed Structures: 2

Outdoor Activities Area: 142 m<sup>2</sup> (About)

#### Appendix 2

Location: DD 109 Lot 1142 (Part)

OZP: S/YL-KTN/11 District: Kam Tin North Zoning: Agriculture

Date: 11 April 2025

# Proposed Layout Plan

擬議佈局平面圖


擬議臨時動物寄養所連附屬設施及相關填土工程(為期5年)

Proposed Temporary Animal Boarding Establishment with Ancillary Facilities and Associated Filling of Land For a Period of 5 Years

For Identification Only

Drawing No.:

SCALE 1:500 @A4

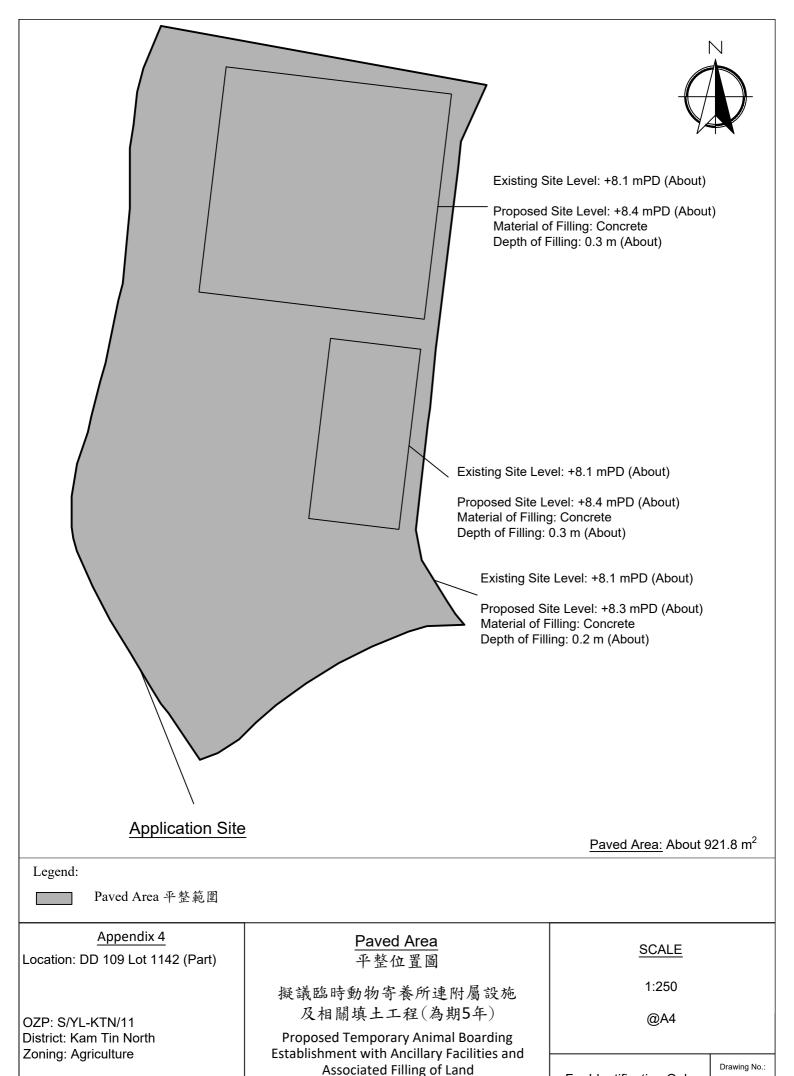



For a Period of 5 Years

Date: 11 April 2025

For Identification Only

4-01

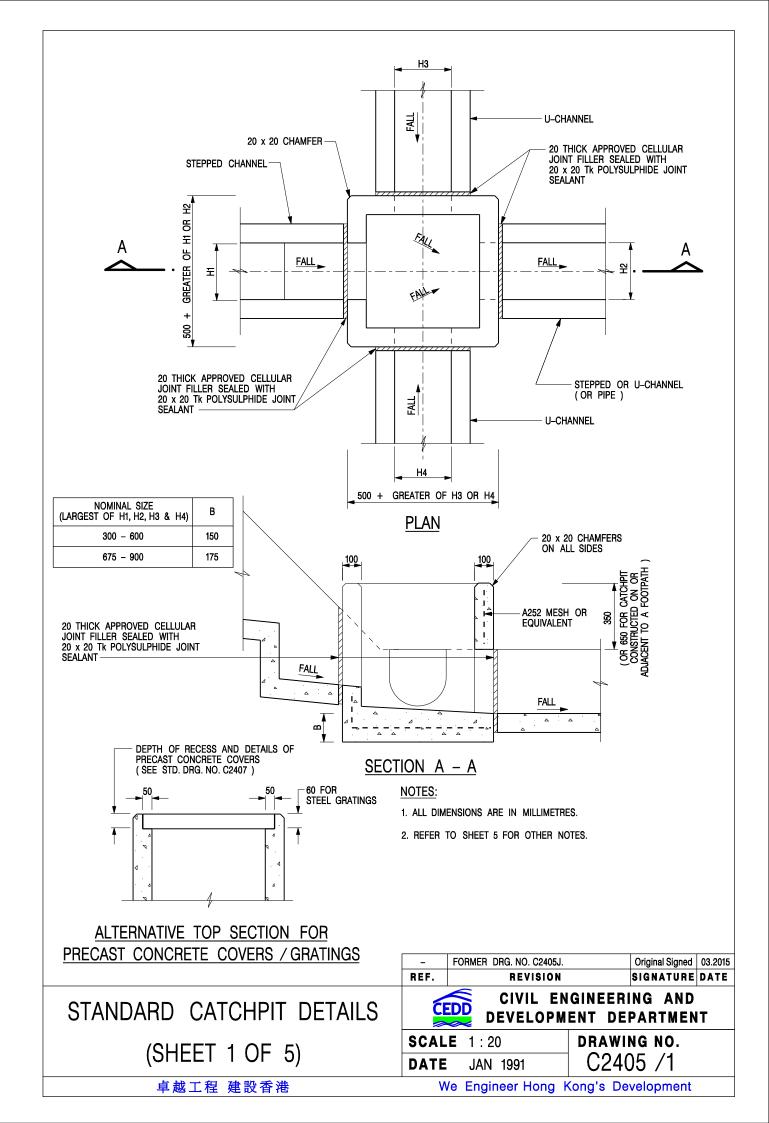

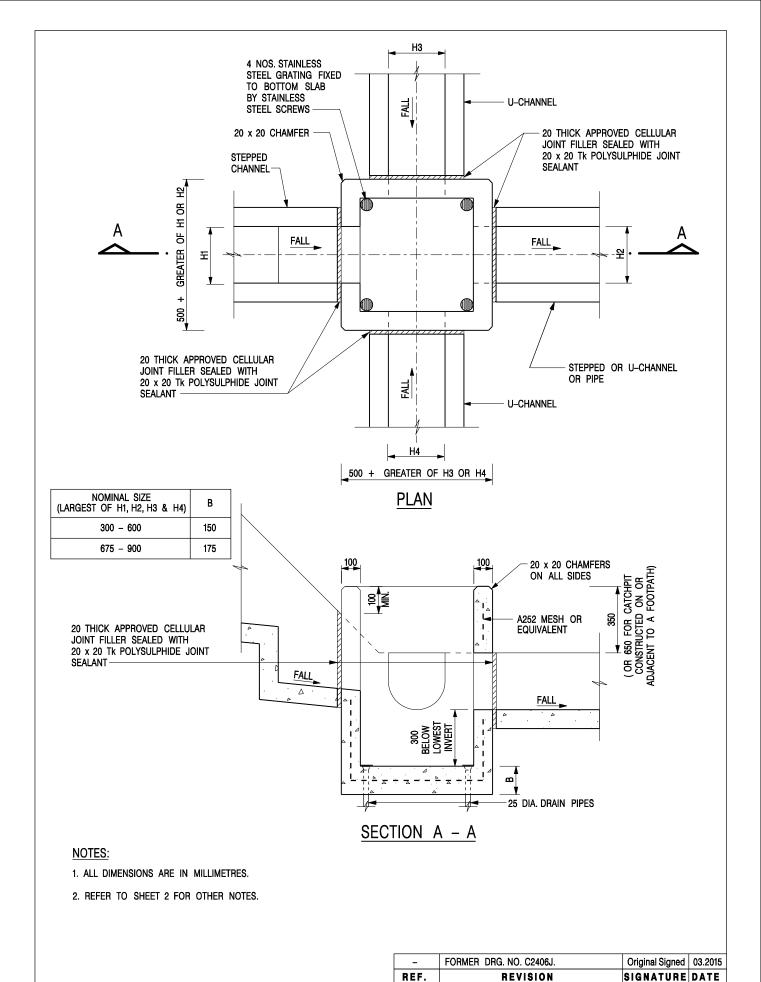

CATCHPIT WITH TRAP (SHEET 1 OF 2)

CIVIL ENGINEERING AND DEVELOPMENT DEPARTMENT


SCALE 1:20

DATE JAN 1991

C2406 /1

卓越工程 建設香港

We Engineer Hong Kong's Development

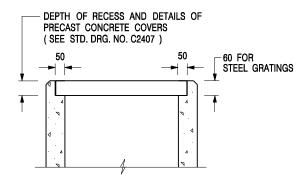

# ALTERNATIVE TOP SECTION FOR PRECAST CONCRETE COVERS / GRATINGS

#### NOTES:

- 1. ALL DIMENSIONS ARE IN MILLIMETRES.
- 2. ALL CONCRETE SHALL BE GRADE 20 /20.
- 3. CONCRETE SURFACE FINISH SHALL BE CLASS U2 OR F2 AS APPROPRIATE.
- 4. FOR DETAILS OF JOINT, REFER TO STD. DRG. NO. C2413.
- 5. CONCRETE TO BE COLOURED AS SPECIFIED.
- 6. UNLESS REQUESTED BY THE MAINTENANCE PARTY AND AS DIRECTED BY THE ENGINEER, CATCHPIT WITH TRAP IS NORMALLY NOT PREFERRED
- 7. UPON THE REQUEST FROM MAINTENANCE PARTY, DRAIN PIPES AT CATCHPIT BASE CAN BE USED BUT THIS IS FOR CATCHPITS LOCATED AT SLOPE TOE ONLY AND AS DIRECTED BY THE ENGINEER.
- 8. FOR CATCHPITS CONSTRUCTED ON OR ADJACENT TO A FOOTPATH, STEEL GRATINGS (SEE DETAIL 'A' ON STD. DRG. NO. C2405 /2 ) OR CONCRETE COVERS (SEE STD. DRG. NO. C2407 ) SHALL BE PROVIDED AS DIRECTED BY THE ENGINEER.
- 9. IF INSTRUCTED BY THE ENGINEER, HANDRAILING (SEE DETAIL 'J' ON STD. DRG. NO. C2405 /5; EXCEPT ON THE UPSLOPE SIDE ) IN LIEU OF STEEL GRATINGS OR CONCRETE COVERS CAN BE ACCEPTED AS AN ALTERNATIVE SAFETY MEASURE FOR CATCHPITS NOT ON A FOOTPATH NOR ADJACENT TO IT. TOP OF THE HANDRAILING SHALL BE 1 000 mm MIN. MEASURED FROM THE ADJACENT GROUND LEVEL.
- 10. MINIMUM INTERNAL CATCHPIT WIDTH SHALL BE 1 000 mm FOR CATCHPITS WITH A HEIGHT EXCEEDING 1 000 mm MEASURED FROM THE INVERT LEVEL TO THE ADJACENT GROUND LEVEL. AND, STEP IRONS (SEE DSD STD. DRG. NO. DS1043 ) AT 300 c/c STAGGERED SHALL BE PROVIDED. THICKNESS OF CATCHPIT WALL FOR INSTALLATION OF STEP IRONS SHALL BE INCREASED TO 150 mm.
- 11. FOR RETROFITTING AN EXISTING CATCHPIT WITH STEEL GRATING, SEE DETAIL 'G' ON STD. DRG. NO. C2405 /4.
- 12. SUBJECT TO THE APPROVAL OF THE ENGINEER, OTHER MATERIALS CAN ALSO BE USED AS COVERS / GRATINGS.

REF.	REVISION	SIGNATURE	DATE
-	FORMER DRG. NO. C2406J.	Original Signed	03.2015
Α	MINOR AMENDMENT.	Original Signed	04.2016

CATCHPIT WITH TRAP (SHEET 2 OF 2)

卓越工程 建設香港



# CIVIL ENGINEERING AND **DEVELOPMENT DEPARTMENT**

DRAWING NO. **SCALE** 1:20 **DATE** JAN 1991

C2406 /2A

We Engineer Hong Kong's Development

Table 3a – Storm Constants for Different Return Periods of HKO Headquarters

Return Period T (years)	2	5	10	20	50	100	200	500	1000
a	446.1	470.5	485.0	496.0	505.5	508.6	508.8	504.6	498.7
b	3.38	3.11	3.11	3.17	3.29	3.38	3.46	3.53	3.55
С	0.463	0.419	0.397	0.377	0.355	0.338	0.322	0.302	0.286

Table 3d – Storm Constants for Different Return Periods of North District Area

Return Period T (years)	2	5	10	20	50	100	200
a	439.1	448.1	454.9	462.3	474.6	486.6	501.4
b	4.10	3.67	3.44	3.21	2.90	2.67	2.45
С	0.484	0.437	0.412	0.392	0.371	0.358	0.348

Table 13 - Values of n to be used with the Manning equation

Source: Brater, E.F. & King, H.W. (1976)

Surface	Best	Good	Fair	Bad
Uncoated cast-iron pipe	0.012	0.013	0.014	0.015
Coated cast-iron pipe	0.011	0.012*	0.013*	
Commercial wrought-iron pipe, black	0.012	0.013	0.014	0.015
Commercial wrought-iron pipe, galvanized	0.013	0.014	0.015	0.017
Smooth brass and glass pipe	0.009	0.010	0.011	0.013
Smooth lockbar and welded "OD" pipe	0.010	0.011*	0.013*	
Riveted and spiral steel pipe	0.013	0.015*	0.017*	
Vitrified sewer pipe	0.010	0.013*	0.015	0.017
Common clay drainage tile	0.011	0.012*	0.014*	0.017
Glazed brickwork	0.011	0.012	0.013*	0.015
Brick in cement mortar; brick sewers	0.012	0.013	0.015*	0.017
Neat cement surfaces	0.010	0.011	0.012	0.013
Cement mortar surfaces	0.011	0.012	0.013*	0.015
Concrete pipe	0.012	0.013	0.015*	0.016
Wood stave pipe	0.010	0.011	0.012	0.013
Plank flumes - Planed	0.010	0.012*	0.013	0.014
- Unplaned	0.011	0.013*	0.014	0.015
- With battens	0.012	0.015*	0.016	
Concrete-lined channels	0.012	0.014*	0.016*	0.018
Cement-rubble surface	0.017	0.020	0.025	0.030
Dry-rubble surface	0.025	0.030	0.033	0.035
Dressed-ashlar surface	0.013	0.014	0.015	0.017
Semicircular metal flumes, smooth	0.011	0.012	0.013	0.015
Semicircular metal flumes, corrugated	0.0225	0.025	0.0275	0.030
Canals and ditches				
1. Earth, straight and uniform	0.017	0.020	0.0225*	0.025
2. Rock cuts, smooth and uniform	0.025	0.030	0.033*	0.035
3. Rock cuts, jagged and irregular	0.035	0.040	0.045	
4. Winding sluggish canals	0.0225	0.025*	0.0275	0.030
5. Dredged-earth channels	0.025	0.0275*	0.030	0.033
6. Canals with rough stony beds, weeds on earth banks	0.025	0.030	0.035*	0.040
7. Earth bottom, rubble sides	0.028	0.030*	0.033*	0.035
Natural-stream channels				
1. Clean, straight bank, full stage, no rifts or deep pools	0.025	0.0275	0.030	0.033
2. Same as (1) but some weeds and stones	0.030	0.033	0.035	0.040
3. Winding some pools and shoals, clean	0.033	0.035	0.040	0.045
4. Same as (3), lower stages, more ineffective slope and sections	0.040	0.045	0.050	0.055

Table 13 (Cont'd)

Surface	Best	Good	Fair	Bad
5. Same as (3) some weeds and stones	0.035	0.040	0.045	0.050
6. Same as (4) stony sections	0.045	0.050	0.055	0.060
7. Sluggish river reach, rather weedy or with very deep pools	0.050	0.060	0.070	0.080
8. Very weedy reaches	0.075	0.100	0.125	0.150

Notes: \*Values commonly used for design.

# Similar s.16 Applications within the Same "AGR" Zone on the OZP in the Vicinity of the Application Site in the Past Five Years

# **Approved Applications**

	Application No.	Use/Development	Date of Consideration
1.	A/YL-KTN/713	Proposed Temporary Animal Boarding	6.11.2020
		Establishment for a Period of Three Years	[revoked on 6.5.2022]
2.	A/YL-KTN/723	Proposed Temporary Animal Boarding	23.10.2020
		Establishment for a Period of Three Years	[revoked on 23.10.2021]
		and Filling of Land	
3.	A/YL-KTN/724	Temporary Animal Boarding	23.10.2020
		Establishment with Ancillary Facilities for	[revoked on 23.3.2023]
		a Period of Three Years	
4.	A/YL-KTN/743	Proposed Temporary Animal Boarding	22.1.2021
		Establishment with Ancillary Office for a	[revoked on 22.4.2023]
		Period of Three Years	
5.	A/YL-KTN/756	Proposed Temporary Animal Boarding	16.4.2021
		Establishment for a Period of Three Years	[revoked on 16.7.2022]
_		and Filling of Land	100001
6.	A/YL-KTN/778	Proposed Temporary Animal Boarding	13.8.2021
		Establishment for a Period of Five Years	[revoked on 13.11.2021]
7	A /X/I - I/TD I /000	and Filling of Land	22.0.2022
7.	A/YL-KTN/822	Temporary Animal Boarding	23.9.2022
		Establishment (Dog Training Ground)	[revoked on 23.9.2023]
		with Ancillary Facilities for a Period of	
8.	A/YL-KTN/856	Three Years and Filling of Land Proposed Temporary Animal Boarding	23.9.2022
0.	A/1L-K1N/030	Establishment for a Period of Five Years	[revoked on 23.12.2023]
		and Filling of Land	[1evoked oii 23.12.2023]
9.	A/YL-KTN/861	Temporary Animal Boarding	11.11.2022
<i>)</i> .	71/ 112 IXII (001	Establishment for a Period of Five Years	[revoked on 11.11.2024]
		and Filling of Land	
10.	A/YL-KTN/881	Temporary Animal Boarding	17.2.2023
		Establishment with Ancillary Facilities for	[revoked on 17.2.2024]
		a Period of Five Years and Filling of Land	L
11.	A/YL-KTN/885	Proposed Temporary Animal Boarding	3.3.2023
		Establishment with Ancillary Facilities for	
		a Period of Five Years and Filling of Land	
12.	A/YL-KTN/889	Proposed Temporary Animal Boarding	17.3.2023
		Establishment with Ancillary Facilities for	[revoked on 17.6.2024]
		a Period of Five Years and Filling of Land	
13.	A/YL-KTN/903	Proposed Temporary Animal Boarding	19.5.2023
		Establishment with Ancillary Facilities for	[revoked on 19.5.2024]
		a Period of Five Years and Filling of Land	

	Application No.	Use/Development	Date of Consideration
14.	A/YL-KTN/908	Proposed Temporary Animal Boarding	9.6.2023
		Establishment with Ancillary Facilities for	[revoked on 9.12.2023]
		a Period of Five Years and Filling of Land	
15.	A/YL-KTN/910	Temporary Animal Boarding	11.9.2023
		Establishment with Ancillary Facilities for	
		a Period of Five Years and Filling of Land	
16.	A/YL-KTN/914	Proposed Temporary Animal Boarding	23.6.2023
		Establishment with Ancillary Facilities for	[revoked on 23.9.2024]
		a Period of Five Years and Filling of Land	
17.	A/YL-KTN/916	Temporary Animal Boarding	23.6.2023
		Establishment (Dog Training Ground)	[revoked on 23.3.2024]
		with Ancillary Facilities for a Period of	
		Five Years and Filling of Land	
18.	A/YL-KTN/921	Proposed Temporary Animal Boarding	28.7.2023
		Establishment with Ancillary Facilities for	[revoked on 28.10.2024]
		a Period of Five Years and Filling of Land	
19.	A/YL-KTN/954	Proposed Temporary Animal Boarding	13.10.2023
		Establishment for a Period of Five Years	
•		and Filling of Land	22.12.222
20.	A/YL-KTN/968	Proposed Temporary Animal Boarding	22.12.2023
		Establishment for a Period of Five Years	
21	A /N/I 1/TNI/000	and Filling of Land	5.7.2024
21.	A/YL-KTN/998	Temporary Animal Boarding	5.7.2024
		Establishment with Ancillary Facilities for	
22.	A/YL-KTN/1099	a Period of Five Years and Filling of Land Proposed Temporary Animal Boarding	2.5.2025
22.	A/ 1 L-1\ 11\ 1099	Establishment with Ancillary Facilities	2.3.2023
		and Associated Filling of Land for a	
		Period of Five Years	
		1 chod of tive i cars	

### **Government Departments' General Comments**

# 1. Land Administration

Comments of the District Lands Officer/Yuen Long, Lands Department (LandsD):

- no adverse comment on the application;
- the application site (the Site) comprises Old Schedule Agricultural Lot No. 1142 (Part) in D.D. 109 held under the Block Government Lease which contains the restriction that no structures are allowed to be erected without the prior approval of the Government;
- there is/are unauthorized structure(s) on the private lot(s). The lot owner(s) should immediately rectify/regularise the lease breaches and his office reserves the right to take necessary lease enforcement action against the breaches without further notice; and
- if the application is approved, the lot owner(s) shall apply to his office for a Short Term Waiver (STW) to permit the structure(s) erected within the private lot(s). The application(s) for STW will be considered by the Government in its capacity as a landlord and there is no guarantee that it will be approved. The STW, if approved, will be subject to such terms and conditions including the payment of waiver fee and administrative fee as considered appropriate by LandsD. Besides, given the proposed use is temporary in nature, only erection of temporary structure(s) will be considered

#### 2. Traffic

Comments of the Commissioner for Transport:

- no adverse comment on the application from traffic engineering perspective; and
- advisory comments are at **Appendix IV**.

Comments of the Chief Highway Engineer/New Territories West, Highways Department:

- no in-principle objection to the application from highways maintenance point of view; and
- advisory comments are at **Appendix IV**.

# 3. Drainage

Comments of the Chief Engineer/Mainland North, Drainage Services Department:

• no in-principle objection to the application from public drainage point of view;

- should the application be approved, conditions should be stipulated requiring the submission of a revised drainage proposal and the implementation and maintenance of the revised drainage proposal for the development to the satisfaction of the Director of Drainage Services or of the Town Planning Board; and
- advisory comments are at Appendix IV.

# 4. Environment

Comments of the Director of Environmental Protection:

- no objection to the application from environmental planning perspective;
- based on the information provided, the proposed use would not involve use of heavy vehicle and dusty operation. There are residential structures within 100m from the boundary of the Site;
- there was no environmental complaint received against the Site in the past three years; and
- advisory comments are at **Appendix IV**.

### 5. <u>Fire Safety</u>

Comments of the Director of Fire Services:

- no in-principle objection to the application subject to fire service installations being provided to his satisfaction; and
- advisory comments are at Appendix IV.

#### 6. Landscape Aspect

Comments of the Chief Town Planner/Urban Design and Landscape, Planning Department:

- no adverse comment on the application from landscape planning perspective;
- based on the aerial photos of 2023, the Site is located in a rural inland plains landscape character comprising farmland, temporary structures, open storage and scattered tree groups. The Site is proposed to be fully hard-paved with two structures. The proposed use is not incompatible with surrounding landscape character; and
- according to the site photos of 2024, the Site is fenced-off. No significant landscape resources are observed within the Site. Significant adverse impact on existing landscape resources is not anticipated.

# 7. Agriculture and Nature Conservation

Comments of Director of Agriculture, Fisheries and Conservation:

- no strong view against the application from agricultural perspective. The Site is zoned "Agriculture". Agricultural infrastructures such as road access and water source are available in the area. The Site can be rehabilitated for agricultural activities such as open-field cultivation, greenhouses, plant nurseries, etc., though whether there will be agricultural activities on a specific site will hinge on a lot of factors;
- the Site does not associate with any licence granted by his department, nor have they received any application regarding the Site;
- no comment on the application from nature conservation perspective; and
- advisory comments are at Appendix IV.

### 8. Building Matters

Comments of the Chief Building Surveyor/New Territories West, Buildings Department:

- no objection to the application;
- there is no record of approval granted by the Building Authority for the existing structure at the Site; and
- advisory comments are at **Appendix IV**.

# 9. <u>District Officer's Comments</u>

Comments of the District Officer (Yuen Long), Home Affairs Department:

• his office has not received any local's comment on the application and he has no particular comment on the application.

#### 10. Other Departments

The following government departments have no objection to/no comment on the application and their advisory comments, if any, are at **Appendix IV**:

- Project Manager (West), Civil Engineering and Development Department;
- Chief Engineer/Construction, Water Supplies Department; and
- Director of Electrical and Mechanical Services.

#### **Recommended Advisory Clauses**

- (a) failure to reinstate the application site (the Site) as required under the relevant approval condition upon expiry of the planning permission might constitute an unauthorized development under the Town Planning Ordinance and be subject to enforcement and prosecution actions;
- (b) prior planning permission should have been obtained before commencing the proposed use at the Site;
- (c) the permission is given to the development and structures under application. It does not condone any other development and structures which currently occur on the Site but not covered by the application. Immediate action should be taken to discontinue such development and remove such structures not covered by the permission;
- (d) to resolve any land issues relating to the proposed use with the concerned owner(s) and/or occupants;
- (e) to note the comments of the District Lands Officer/Yuen Long, Lands Department (LandsD) that:
  - there is/are unauthorized structure(s) on the private lot(s). The lot owner(s) should immediately rectify/regularise the lease breaches and his office reserves the right to take necessary lease enforcement action against the breaches without further notice; and
  - the lot owner(s) shall apply to his office for a Short Term Waiver (STW) to permit the structure(s) erected within the private lot(s). The application(s) for STW will be considered by the Government in its capacity as a landlord and there is no guarantee that it will be approved. The STW, if approved, will be subject to such terms and conditions including the payment of waiver fee and administrative fee as considered appropriate by LandsD. Besides, given the proposed use is temporary in nature, only erection of temporary structure(s) will be considered;
- (f) to note the comments of the Commissioner for Transport that:
  - the Site is connected to the public road network via a section of a local access road which is not managed by the Transport Department. The land status of the local access road should be checked with LandsD. Moreover, the management and maintenance responsibilities of the local access road should be clarified with the relevant lands and maintenance authorities accordingly. Sufficient manoeuvring space shall be provided within the Site. No vehicle is allowed to queue back to or reverse onto/from public road at any time during the planning approval period;
- (g) to note the comments of the Chief Highway Engineer/New Territories West, Highways Department (HyD) that:
  - HyD shall not be responsible for the maintenance of proposed access connecting the Site and Chi Ho Road; and
  - adequate drainage measures shall be provided to prevent surface water running from

the Site to the nearby public roads or drains;

- (h) to note the comments of the Director of Environmental Protection that:
  - the applicant is advised to:
    - i. ensure all dogs will be kept inside the enclosed animal boarding establishment on the Site between 6:00 p.m. and 8:00 a.m.;
    - ii. ensure no public announcement system, whistle blowing or any form of audio amplification system is allowed to be used on the Site;
    - iii. ensure the animal boarding establishment be enclosed with soundproofing materials with the provision of 24-hour mechanical ventilation and air-conditioning system;
    - iv. ensure dog masks will be used for dogs allowed for outdoor activities to minimise the potential nuisance on surrounding sensitive uses;
    - v. follow the revised 'Code of Practice on Handling the Environmental Aspects of Temporary Uses and Open Storage Sites';
    - vi. follow the relevant guidelines and requirements in relevant Professional Persons Environmental Consultative Committee Practice Notes (ProPECCPNs), in particular the ProPECC PN 1/23 'Drainage Plans subject to Comment by the Environmental Protection Department';
    - vii. provide adequate supporting infrastructure/facilities for proper collection, treatment and disposal of waste/wastewater generated from the proposed use; and
    - viii. meet the statutory requirements under relevant environmental legislation;
- (i) to note the comments of the Chief Engineer/Mainland North, Drainage Services Department that:
  - there are detailed comments on the drainage proposal:
    - i. Drawing No. 5-01 the final discharge point should be indicated on layout plan;
    - ii. site formation/land filling works will be carried out under this application. The overland flow from the adjacent lands should not be affected;
    - iii. the existing drainage facilities, to which the stormwater from the proposed use at the Site would discharge, are not maintained by his office. The applicant should identify the owner of the existing drainage facilities to which the proposed connection will be made. The applicant shall demonstrate that the proposed drainage construction/improvement/modification works and the operation of the drainage can be practicably implemented;
    - iv. the applicant should check and ensure the hydraulic capacity of the existing drainage facilities would not be adversely affected by the proposed use. The applicant should provide site photos along the existing stream showing the existing condition and existence of the existing drainage facilities which will

receive the discharge from the Site;

- v. the proposed use should neither obstruct overland flow nor adversely affect existing natural streams, village drains, ditches and the adjacent areas, etc.; and
- vi. the applicant shall resolve any conflict/disagreement with relevant lot owner(s) and seek LandsD's permission for laying new drains/channels and/or modifying/upgrading existing ones in other private lots or on Government Land (where required) outside the Site;
- (j) to note the comments of the Director of Fire Services that:
  - the applicant is advised to submit relevant layout plans incorporated with the revised fire service installations (FSIs) to his department for approval. The applicant is also advised on the following points:
    - i. the layout plans should be drawn to scale and depicted with dimensions and nature of occupancy; and
    - ii. the location of proposed FSIs to be installed should be clearly marked on the layout plans;
  - based on the submitted FSIs proposal, he has the following comments:
    - i. the separation distance between each structure shall be clearly indicated on plan; and
    - ii. in relation to (i.) above, structures on the same site are regarded as adjoining structures if they are less than 1.8m apart. Additional FSIs (i.e. sprinkler system, modified hose reel system and fire alarm system) shall be provided if the total floor area exceeds 230m<sup>2</sup>;
  - if the proposed structures are required to comply with the Buildings Ordinance (BO) (Cap. 123), detailed fire services requirements will be formulated upon receipt of formal submission of general building plans;
- (k) to note the comments of the Director of Agriculture, Fisheries and Conservation Department that:
  - under Cap. 139I Public Health (Animals) (Boarding Establishment) Regulations (the Regulations), any person who provides food and accommodation for animals in return for a fee paid by the owner must apply for a Boarding Establishment Licence from his department. The applicant should also be reminded that the establishment and ancillary facilities which is licensed under the Regulations must always fulfill the criteria listed in the Regulations; and
  - the dogs kept by the applicant should also be properly licensed as in accordance with Cap. 421 Rabies Ordinance and the applicant should observe Cap. 169 Prevention of Cruelty to Animals Ordinance at all times;
- (l) to note the comments of the Chief Building Surveyor/New Territories West, Buildings Department (BD) that:
- it is noted that two structures are proposed in the application. Before any new A/YL-KTN/1075A

building works (including containers/open sheds as temporary buildings, demolition and land filling, etc.) are to be carried out on the Site, prior approval and consent of the Building Authority (BA) should be obtained, otherwise they are unauthorized building works (UBW) under the BO. An Authorized Person should be appointed as the co-ordinator for the proposed building works in accordance with the BO;

- the Site shall be provided with means of obtaining access thereto from a street and emergency vehicular access in accordance with Regulation 5 and 41D of the Building (Planning) Regulations (B(P)R) respectively;
- the Site does not abut on a specified street of not less than 4.5m wide and its permitted development intensity shall be determined under Regulation 19(3) of the B(P)R at building plan submission stage;
- if the existing structures are erected on leased land without the approval of the BA, they are UBW under the BO and should not be designated for any proposed use under the captioned application;
- for UBW erected on leased land, enforcement action may be taken by BD to effect their removal in accordance with the prevailing enforcement policy against UBW as and when necessary. The granting of any planning approval should not be construed as an acceptance of any existing building works or UBW on the Site under the BO;
- if the proposed use under application is subject to issue of a license, the applicant should be reminded that any existing structures on the Site intended to be used for such purposes are required to comply with the building safety and other relevant requirements as may be imposed by the licensing authority;
- any temporary shelters or converted containers for office, storage, washroom or other uses are considered as temporary buildings are subject to the control of Part VII of the B(P)R; and
- detailed checking under the BO will be carried out at building plan submission stage.

□Urgent □Return receipt □Expand Group □Restricted □Prevent Copy

From:

Sent:

2025-01-13 星期一 02:54:56

To:

tpbpd/PLAND <tpbpd@pland.gov.hk>

Subject:

A/YL-KTN/1075 DD 109 Kong A Leng ABE

A/YL-KTN/1075

Lot 1142 in D.D. 109, Kong A Leng, Kam Tin

Site area: About 921.8sq.m

Zoning: "Agriculture"

Applied use: Animal Boarding Establishment / 5 Vehicle Parking / Filling of Land / 5 Years

Dear TPB Members.

1030 withdrawn and back with the usual backdoor listing approach to gaining approval, any approval that allows filling of land.

If TPB members approve this FAKE application then they are guilty of ignoring the obvious intention to use the site for brownfield operations.

Moreover, strong objections to 5 Year Term.

SINCE WHEN WERE THE GUIDELINES AMENDED TO ALLOW 5 YEARS FOR ABE?

Has the applicant approached AFCD with an application for the requisite licences?

Fake applications must be rejected if there is to be an integrity to the process.

Mary Mulvihill

From:

To: tpbpd <tpbpd@pland.gov.hk>

Date: Monday, 14 October 2024 2:33 AM HKT Subject: Re: A/YL-KTN/1030 DD 109 Kong A Leng

Dear TPB Members,

If your own guidelines have any legitimacy then there is no justification to approve this application as the location is very clearly Cat. 3

TPB PG-No. 13G (Revised April 2023)

TOWN PLANNING BOARD GUIDELINES FOR APPLICATION FOR OPEN STORAGE AND PORT BACK-UP USES UNDER SECTION 16 OF THE TOWN PLANNING **ORDINANCE** 

Category 3 areas are those outside the Category 1, 2 and 4 areas. Within these areas, "existing" and approved open storage and port back-up uses are to be contained and further proliferation of such uses is not acceptable

Mary Mulvihill

### From:

To: tpbpd <tpbpd@pland.gov.hk>

Date: Monday, 5 August 2024 2:37 AM HKT Subject: A/YL-KTN/1030 DD 109 Kong A Leng

A/YL-KTN/1030

Lot 1142 in D.D. 109, Kong A Leng, Kam Tin

Site area: About 921.8sq.m

Zoning: "Agriculture"

Applied use: Warehouse / 4 Vehicle Parking / Filling of Land

Dear TPB Members,

999 withdrawn, back with a smaller footprint.

Previous objections relevant and upheld.

Mary Mulvihill

### From:

To: tpbpd <tpbpd@pland.gov.hk>

Date: Monday, 1 April 2024 5:21 AM HKT Subject: A/YL-KTN/999 DD 109 Kong A Leng

A/YL-KTN/999

Lot 1142 in D.D. 109, Kong A Leng, Kam Tin

Site area: About 1,100sq.m

Zoning: "Agriculture"

Applied use: Warehouse / 5 Vehicle Parking / Filling of Land

Urgent □Return receipt □Expand Group □Restricted □Prevent Copy
Dear TPB Members,
Strong Objections. This is an area with extensive agricultural activity, organic farms and outlets supplying restaurants that cater to the growing demand for home grown produce.
With no previous history of approvals, there is no justification in approving this application.
Mary Mulvihill

⊐Urgent	□Return receipt	□Expand Group	□Restricted	□Prevent Copy		2_	
From: Sent:	<del></del>	2025	5-01-13 星期 <del>-</del>	— 19:53:41	-		

tpbpd/PLAND <tpbpd@pland.gov.hk>

Subject: Attachment:

To:

250113 s16 KTN 1075.pdf

KFBG's comments on four planning applications

Dear Sir/ Madam,

Attached please see our comments regarding four applications. There are four pdf files attached to this email. If you cannot see/ download/ open these files, please notify us through email.

Please do not disclose our email address.

Thank You and Best Regards,

Ecological Advisory Programme
Kadoorie Farm and Botanic Garden

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### 嘉道理農場暨植物園公司 Kadoorie Farm & Botanic Garden Corporation

The Secretary,
Town Planning Board,
15/F, North Point Government Offices,
333, Java Road, North Point,
Hong Kong.
(Email: tpbpd@pland.gov.hk)

13th January, 2025.

By email only

Dear Sir/ Madam,

## Proposed Temporary Animal Boarding Establishment with Ancillary Facilities for a Period of 5 Years and Associated Filling of Land (A/YL-KTN/1075)

- 1. We refer to the captioned.
- 2. Regarding Animal Boarding Establishment, we urge the Board to read a newspaper article (at 1).
- 3. We urge the Board to reject this application as we consider the proposed use is not in line with the planning intention of the Agriculture zone.
- 4. Thank you for your attention.

Ecological Advisory Programme
Kadoorie Farm and Botanic Garden

<sup>&#</sup>x27; <a href="https://news.mingpao.com/pns/港間/article/20240702/s00002/1719858304310/本研-5 年批 60 狗場用地-半</a> 不符實-疑作跳板-至少 15 幅兩年內申棕地作業

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From:	
Sent:	2025-05-14 星期三 15:04:23
То:	tpbpd/PLAND <tpbpd@pland.gov.hk></tpbpd@pland.gov.hk>
Subject:	KFBG's comments on two planning applications
Attachment:	250514 s16 KTN 1075.pdf

□Urgent □Return receipt □Expand Group □Restricted □Prevent Copy

Dear Sir/ Madam,

Attached please see our comments regarding two applications. There are two pdf files attached to this email. If you cannot see/ download/ open these files, please notify us through email.

Please do not disclose our email address.

Thank You and Best Regards,

Ecological Advisory Programme
Kadoorie Farm and Botanic Garden

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## 嘉道理農場暨植物園公司 Kadoorie Farm & Botanic Garden Corporation

The Secretary,
Town Planning Board,
15/F, North Point Government Offices,
333, Java Road, North Point,
Hong Kong.
(Email: tpbpd@pland.gov.hk)

14th May, 2025.

By email only

Dear Sir/ Madam,

# Proposed Temporary Animal Boarding Establishment with Ancillary Facilities for a Period of 5 Years and Associated Filling of Land (A/YL-KTN/1075)

- 1. We refer to the captioned.
- 2. Regarding Animal Boarding Establishment, we urge the Board to read a newspaper article (at 1).
- 3. We urge the Board to reject this application as we consider the proposed use is not in line with the planning intention of the Agriculture zone.
- 4. Thank you for your attention.

Ecological Advisory Programme Kadoorie Farm and Botanic Garden

<sup>&</sup>lt;sup>1</sup> https://news.mingpao.com/pns/港閏/article/20240702/s00002/1719858304310/本研-5 年批 60 狗場用地-半 不符實-疑作跳板-至少 15 幅兩年內申棕地作業

				□D
⊔Urgent	⊔Return receipt	□Expand Group	⊔Restricted	⊔Prevent Copy

From:

Sent:

2025-05-15 星期四 03:40:29

To:

tpbpd/PLAND <tpbpd@pland.gov.hk>

Subject:

Re: A/YL-KTN/1075 DD 109 Kong A Leng ABE

Dear TPB Members,

Applicant states that it will provide animal rescue services.

And of course you also believe in Father Xmas and the Tooth Fairy?

Time for some adults in the room.

In view of the initial application for brownfield both PlanD and members have a duty to consider the plausibility of the proposed service.

Mary Mulvihill.

From:

To: tpbpd <tpbpd@pland.gov.hk>

Date: Monday, 13 January 2025 2:54 AM HKT

Subject: A/YL-KTN/1075 DD 109 Kong A Leng ABE

A/YL-KTN/1075

Lot 1142 in D.D. 109, Kong A Leng, Kam Tin

Site area: About 921.8sq.m

Zoning: "Agriculture"

Applied use: Animal Boarding Establishment / 5 Vehicle Parking / Filling of Land / 5 Years

Dear TPB Members.

1030 withdrawn and back with the usual backdoor listing approach to gaining approval, any approval that allows filling of land.

If TPB members approve this FAKE application then they are guilty of ignoring the obvious intention to use the site for brownfield operations.

Moreover, strong objections to 5 Year Term.

SINCE WHEN WERE THE GUIDELINES AMENDED TO ALLOW 5 YEARS FOR ABE?

Has the applicant approached AFCD with an application for the requisite licences?

Fake applications must be rejected if there is to be an integrity to the process.

### Mary Mulvihill

From:

To: tpbpd <tpbpd@pland.gov.hk>

Date: Monday, 14 October 2024 2:33 AM HKT Subject: Re: A/YL-KTN/1030 DD 109 Kong A Leng

Dear TPB Members,

If your own guidelines have any legitimacy then there is no justification to approve this application as the location is very clearly Cat. 3

TPB PG-No. 13G (Revised April 2023)

TOWN PLANNING BOARD GUIDELINES FOR APPLICATION FOR OPEN STORAGE AND PORT BACK-UP USES UNDER SECTION 16 OF THE TOWN PLANNING ORDINANCE

Category 3 areas are those outside the Category 1, 2 and 4 areas. Within these areas, "existing" and approved open storage and port back-up uses are to be contained and further proliferation of such uses is not acceptable

Mary Mulvihill

From

To: tpbpd <tpbpd@pland.gov.hk>

Date: Monday, 5 August 2024 2:37 AM HKT Subject: A/YL-KTN/1030 DD 109 Kong A Leng

A/YL-KTN/1030

Lot 1142 in D.D. 109, Kong A Leng, Kam Tin

Site area: About 921.8sq.m

Zoning: "Agriculture"

Applied use: Warehouse / 4 Vehicle Parking / Filling of Land

Dear TPB Members,

999 withdrawn, back with a smaller footprint.

Previous objections relevant and upheld.

Mary Mulvihill

From:

To: tpbpd <tpbpd@pland.gov.hk>

Date: Monday, 1 April 2024 5:21 AM HKT Subject: A/YL-KTN/999 DD 109 Kong A Leng

A/YL-KTN/999

Lot 1142 in D.D. 109, Kong A Leng, Kam Tin

Site area: About 1,100sq.m

Zoning: "Agriculture"

Applied use: Warehouse / 5 Vehicle Parking / Filling of Land

Dear TPB Members,

Strong Objections. This is an area with extensive agricultural activity, organic farms and outlets supplying restaurants that cater to the growing demand for home grown produce.

With no previous history of approvals, there is no justification in approving this application.

Mary Mulvihill