2025年8月25日

此文件在 收到。城市規劃委員會 只會在收到所有必要的資料及文件後才正式確認收到 申請的目期。

This document is received on The Town Planning Board will formally acknowledge the date of receipt of the application only upon receipt of all the required information and documents.



APPLICATION FOR PERMISSION UNDER SECTION 16 OF THE TOWN PLANNING ORDINANCE (CAP. 131)

根據《城市規劃條例》(第131章) 第16條遞交的許可申請

Applicable to Proposal Only Involving Temporary Use/Development of Land and/or Building Not Exceeding 3 Years in Rural Areas or Regulated Areas, or Renewal of Permission for such Temporary Use or Development*

適用於祇涉及位於鄉郊地區或受規管地區土地上及/或建築物內進行為期不超過三年的臨時用途/發展或該等臨時用途/發展的許可續期的建議*

*Form No. S16-I should be used for other Temporary Use/Development of Land and/or Building (e.g. temporary use/developments in the Urban Area) and Renewal of Permission for such Temporary Use or Development.

*其他土地上及/或建築物內的臨時用途/發展 (例如位於市區內的臨時用途或發展)及有關該等臨時用途/發展的許可續期,應使用表格第 S16-I 號。

Applicant who would like to publish the <u>notice of application</u> in local newspapers to meet one of the Town Planning Board's requirements of taking reasonable steps to obtain consent of or give notification to the current land owner, please refer to the following link regarding publishing the notice in the designated newspapers: https://www.tpb.gov.hk/en/plan application/apply.html

申請人如欲在本地報章刊登<u>申請通知</u>,以採取城市規劃委員會就取得現行土地擁有人的同意或通知現行土地擁有人所指定的其中一項合理步驟,請瀏覽以下網址有關在指定的報章刊登通知: https://www.tpb.gov.hk/tc/plan_application/apply.html

General Note and Annotation for the Form

填寫表格的一般指引及註解

- "Current land owner" means any person whose name is registered in the Land Registry as that of an owner of the land to which the application relates, as at 6 weeks before the application is made
 - 「現行土地擁有人」指在提出申請前六星期,其姓名或名稱已在土地註冊處註冊為該申請所關乎的土地的擁有人的人
- & Please attach documentary proof 請夾附證明文件
- ^ Please insert number where appropriate 請在適當地方註明編號

Please fill "NA" for inapplicable item 請在不適用的項目填寫「不適用」

Please use separate sheets if the space provided is insufficient 如所提供的空間不足,請另頁說明

Please insert a 「 v 」 at the appropriate box 請在適當的方格内上加上「 v 」 號

For Official Use Only 請勿填寫此欄	Application No. 申請編號	A/YL-PS/763	
	Date Received 收到日期	2025 -08- 2 5	

- 1. The completed form and supporting documents (if any) should be sent to the Secretary, Town Planning Board (the Board), 15/F, North Point Government Offices, 333 Java Road, North Point, Hong Kong. 申請人須把填妥的申請表格及其他支持申請的文件(倘有),送交香港北角渣華道 333 號北角政府合署 15 樓城市規劃委員會(下稱「委員會」)秘書收。
- 2. Please read the "Guidance Notes" carefully before you fill in this form. The document can be downloaded from the Board's website at http://www.tpb.gov.hk/. It can also be obtained from the Secretariat of the Board at 15/F, North Point Government Offices, 333 Java Road, North Point, Hong Kong (Tel: 2231 4810 or 2231 4835), and the Planning Enquiry Counters of the Planning Department (Hotline: 2231 5000) (17/F, North Point Government Offices, 333 Java Road, North Point, Hong Kong and 14/F, Sha Tin Government Offices, 1 Sheung Wo Che Road, Sha Tin, New Territories). 請先細閱《申請須知》的資料單張,然後填寫此表格。該份文件可從委員會的網頁下載(網址: http://www.tpb.gov.hk/),亦可向委員會秘書處 (香港北角渣華道 333 號北角政府合署 15 樓-電話: 2231 4810 或 2231 4835)及規劃署的規劃資料查詢處(熱線: 2231 5000) (香港北角渣華道 333 號北角政府合署 17 樓及新界沙田上禾鲞路 1 號沙田政府合署 14 樓)索取。
- 3. This form can be downloaded from the Board's website, and obtained from the Secretariat of the Board and the Planning Enquiry Counters of the Planning Department. The form should be typed or completed in block letters. The processing of the application may be refused if the required information or the required copies are incomplete. 此表格可從委員會的網頁下載,亦可向委員會秘書處及規劃署的規劃資料查詢處索取。申請人須以打印方式或以正楷填寫表格。如果申請人所提交的資料或文件副本不齊全,委員會可拒絕處理有關申請。

1. Name of Applicant 申請人姓名/名稱

(☑Mr. 先生/□Mrs. 夫人/□Miss 小姐/□Ms. 女士/□Company 公司/□Organisation 機構)

鄧炳輝 Tang Ping Fai

2. Name of Authorised Agent (if applicable) 獲授權代理人姓名/名稱(如適用)

(□Mr. 先生 /□Mrs. 夫人 /□Miss 小姐 /□Ms. 女士 / ☑ Company 公司 /□Organisation 機構)

Allgain Land Planning Limited 全堅土地規劃有限公司

3.	Application Site 申請地點	
(a)	Full address / location / demarcation district and lot number (if applicable) 詳細地址/地點/丈量約份及地段號碼(如適用)	新界元朗屏山丈量約份第122約地段第688號、第689號(部分)、第690號(部分)、第691號(部分)、第691號(部分)、第693號(部分)、第694號(部分)、第757號(部分)、第758號(部分)、第758號(部分)、第758號(部分)及第947號(部分) Lots 688,689(Part),690(Part),691(Part),692(Part),693(Part),695(Part),756(Part),757(Part),758(Part) and 947(Part) in D. D. 122, Ping Shan, Yuen Long, N. T
(b)	Site area and/or gross floor area involved 涉及的地盤面積及/或總樓面面積	□Site area 地盤面積 6500 sq.m 平方米□About 約 □Gross floor area 總樓面面積 sq.m 平方米□About 約
(c)	Area of Government land included (if any) 所包括的政府土地面積(倘有)	N/A sq.m 平方米 □About 約

(d)	Name and number of the related statutory plan(s) 有關法定圖則的名稱及編號 Approved Ping Shan Outline Zoning Plan No. S/YL-PS/20 屏山分區計劃大綱核准圖編號 S/YL-PS/20						
(e)	Comprehensive Development Area 涉及的土地用途地帶 「綜合發展區」						
(f)	Current use(s) 現時用途 (If there are any Government, institution or community facilities, please illustrate plan and specify the use and gross floor area) (如有任何政府、機構或社區設施,請在圖則上顯示,並註明用途及總樓面面积						
4.	"Current Land Owner	'of Application Site 申請地點的「現行土地擁有人」					
The	applicant 申請人 –						
		r ^{»#&} (please proceed to Part 6 and attach documentary proof of ownership). 」 ^{#&} (請繼續填寫第 6 部分,並夾附業權證明文件)。					
	is one of the "current land ow 是其中一名「現行土地擁有	ners" ^{# &} (please attach documentary proof of ownership). 人」 ^{# &} (請來附業權證明文件)。					
\triangleleft	is not a "current land owner" 並不是「現行土地擁有人」						
	The application site is entirely on Government land (please proceed to Part 6). 申請地點完全位於政府土地上(請繼續填寫第 6 部分)。						
5.	5. Statement on Owner's Consent/Notification 就土地擁有人的同意/通知土地擁有人的陳述						
(a)	involves a total of	the Land Registry as at					
(b)	The applicant 申請人 —						
	has obtained consent(s)	of "current land owner(s)".					
	已取得	名「現行土地擁有人」#的同意。					
	Details of consent of "	current land owner(s)" # obtained 取得「現行土地擁有人」 #同意的詳情					
	No. of 'Current Land Owner(s)' 「現行土地擁有人」數目 Lot number/address of premises as shown in the record of the Land (DD/MM/YYYY) 取得同意的日期 (日/月/年)						
	(Plagga usa samanata alagata	if the space of any box above is insufficient. 如上列任何方格的空間不足,請另頁說明)					
I	(1 lease use separate silects	n the space of any box above is insumicient. XLLYTEN 万伦的全间个定,胡芳县就明)					

		rent land	owner(s)" # notified	已獲通知「現行	土地擁有人」#	
La	o. of 'Current and Owner(s)' 現行土地擁 人」數目	Land Re	ber/address of prem gistry where notifica 也註冊處記錄已發出	ation(s) has/have be	en given	Date of notification given (DD/MM/YYYY) 通知日期(日/月/年)
(Ple	ase use separate sl	heets if the	space of any box abov	ye is insufficient. 如	上列任何方格的多	5間不足,請另頁說明)
			obtain consent of or 推有人的同意或向			
Rea	sonable Steps to	Obtain C	Consent of Owner(s)	取得土地擁有人	的同意所採取的	的合理步驟
			to the "current land (日/月/年)向每一名			(DD/MM/YYYY) ^{#&} 司意書 ^{&}
Rea	sonable Steps to	Give No	tification to Owner(s	i) 向土地擁有人	發出通知所採用	双的合理步驟
			al newspapers on (日/月/年)在指定報			YY) ^{&}
			nent position on or r (DD/MM/YYYY)&	near application site	e/premises on	
	於_ 28/07/2	2025	(日/月/年)在申請地	點/申請處所或阿	付近的顯明位置	貼出關於該申請的通
\checkmark	sent notice to roffice(s) or rur	al commi	ttee on	(DD/M	M/YYYY)&	committee(s)/manager 員會/互助委員會或
	處,或有關的					
Oth	ers 其他					
	others (please 其他(請指明					
						

6. Type(s) of Applicatio	n 申請類別					
(A) Temporary Use/Development of Land and/or Building Not Exceeding 3 Years in Rural Areas or Regulated Areas 位於鄉郊地區或受規管地區土地上及/或建築物內進行為期不超過三年的臨時用途/發展 (For Renewal of Permission for Temporary Use or Development in Rural Areas or Regulated Areas, please proceed to Part (B)) (如屬位於鄉郊地區或受規管地區臨時用途/發展的規劃許可續期,請填寫(B)部分)						
(a) Proposed use(s)/development 擬議用途/發展 臨時公眾停車場(私家車、中型貨車及旅遊巴士) Temporary Public Vehicle Park for Private Cars, Medium Goods Vehicles and Coaches						
(b) Effective period of permission applied for 申請的許可有效期	year(s) 年 □ month(s) 個月	oosal on a layout plan) (請用平面圖說明擬議詳情) 3				
(c) Development Schedule 發展						
Proposed uncovered land area	a 擬議露天土地而積	6500 sq.m ☑About 約				
Proposed covered land area 扬		0				
	s/structures 擬議建築物/構築物數					
		0				
Proposed domestic floor area		sq.m □About 約				
Proposed non-domestic floor area 嫌讓非任用樓面面積sq.m ☑Ab						
Proposed gross floor area 擬議總樓面面積 sq.m ☑About 約						
		if applicable) 建築物/構築物的擬議高度及不同樓層 s insufficient) (如以下空間不足,請另頁說明)				
	spaces by types 不同種類停車位的	擬議數目				
Private Car Parking Spaces 私家		10				
Motorcycle Parking Spaces 電單 Light Goods Vehicle Parking Spa		0				
Medium Goods Vehicle Parking		28				
Heavy Goods Vehicle Parking Sp		0				
Others (Please Specify) 其他 (訂		22個旅遊巴停車位				
Proposed number of loading/unlo	pading spaces 上落客貨車位的擬議	數目				
Taxi Spaces 的土車位		0				
Coach Spaces 旅遊巴車位		<u>0</u>				
Light Goods Vehicle Spaces 輕型	NI V PORM IN DOCUMENT	<u>0</u>				
remain on the remaining the second	Medium Goods Vehicle Spaces 中型貨車車位 0					
Heavy Goods Vehicle Spaces 重型貨車車位 0 Others (Please Specify) 其他 (請列明) 0						
omors (rieuse speemy) Alle (a)	a / 1.2.1)	<u>y</u>				

Proposed operating hours 擬議營運時間 私家車和旅遊車停車場:星期一至星期日上午七時至晚上九時,包括星期日以外的公眾假期;						
.中.西	中型貨車停車場:在星期一至星期六早上七時至晚上六時。					
(d)	Any vehicular acce the site/subject build 是否有車路通往地 有關建築物?	ing?	 ✓ There is an existing access. (please indicate the street name, where appropriate) 有一條現有車路。(請註明車路名稱(如適用)) 由朗屏路經一條鄉村道路進入 □ There is a proposed access. (please illustrate on plan and specify the width) 有一條擬議車路。(請在圖則顯示,並註明車路的闊度) 			
		No 否				
(e)	(If necessary, please	use separate shee for not providin	議發展計劃的影響 its to indicate the proposed measures to minimise possible adverse impacts or give g such measures. 如需要的話,請另頁註明可盡量減少可能出現不良影響的			
(i)	Does the development proposal involve alteration of existing building? 擬議發展計劃是否包括現有建築物的改動?		Please provide details 請提供詳情			
(ii)	Does the development proposal involve the operation on the right? 擬議發展是否涉及右列的工程?	(Please indicate on site plan the boundary of concerned land/pond(s), and particulars of stream diversion, the extent of filling of land/pond(s) and/or excavation of land) 請用地盤平面圖顯示有關土地/池塘界線,以及河道改道、填塘、填土及/或挖土的細節及/或範圍) Diversion of stream 河道改道 Filling of pond 填塘 Area of filling 填塘面積			
(iii)	Would the development proposal cause any adverse impacts? 擬議發展計劃會否造成不良影響?	Landscape Imp Tree Felling Visual Impact	至 Yes 會 No 不會 N			

dian 請計 幹主 (B) Renewal of Permission	se state measure(s) to minimise the impact(s). For tree felling, please state the number, eter at breast height and species of the affected trees (if possible) 明盡量減少影響的措施。如涉及砍伐樹木,請說明受影響樹木的數目、及胸高度的樹徑及品種(倘可) for Temporary Use or Development in Rural Areas or Regulated Areas 地區臨時用途/發展的許可續期
(a) Application number to whe the permission relates 與許可有關的申請編號	A//
(b) Date of approval 獲批給許可的日期	(DD 日/MM 月/YYYY 年)
(c) Date of expiry 許可屆滿日期	(DD 日/MM 月/YYYY 年)
(d) Approved use/development 已批給許可的用途/發展	
(e) Approval conditions 附帶條件	□ The permission does not have any approval condition 許可並沒有任何附帶條件 □ Applicant has complied with all the approval conditions 申請人已履行全部附帶條件 □ Applicant has not yet complied with the following approval condition(s): 申請人仍未履行下列附帶條件: □ Reason(s) for non-compliance: 仍未履行的原因: □ (Please use separate sheets if the space above is insufficient) (如以上空間不足,請另頁說明)
(f) Renewal period sought 要求的續期期間	□ year(s) 年 □ month(s) 個月

7.	Justifications 理由
The 現謂	applicant is invited to provide justifications in support of the application. Use separate sheets if necessary. 背申請人提供申請理由及支持其申請的資料。如有需要,請另頁說明)。
	請參考附件的申請摘要。
	·
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••••	

8. Declaration 聲明					
I hereby declare that the particulars given in this application are 本人謹此聲明,本人就這宗申請提交的資料,據本人所知					
I hereby grant a permission to the Board to copy all the materials submitted in this application and/or to upload such materials to the Board's website for browsing and downloading by the public free-of-charge at the Board's discretion. 本人現准許委員會酌情將本人就此申請析提交的所有資料複製及/或上載至委員會網站,供公眾免費瀏覽或下載。					
Signature 簽署	□ Applicant 申請人 / ☑ Authorised Agent 獲授權代理人				
Ms Hermose Chong	Manager				
Name in Block Letters 姓名(請以正楷填寫)	Position (if applicable) 職位(如適用)				
Professional Qualification(s) 專業資格 HKIP 香港規劃師學會 / HKIA 香港建築師學會 / HKIE 香港工程師學會 / HKIE 香港工程師學會 / HKIUD 香港城市設計學會 / HKIUD 香港城市設計學會 / RPP 註冊專業規劃師 Others 其他					
on behalf of Allgain Land Planning Limited					
	d Chop (if applicable) 機構名稱及蓋章(如適用)				
Date 日期 15/08/2025	. (DD/MM/YYYY 日/月/年)				

Remark 備註

The materials submitted in this application and the Board's decision on the application would be disclosed to the public. Such materials would also be uploaded to the Board's website for browsing and free downloading by the public where the Board considers appropriate.

委員會會向公眾披露申請人所遞交的申請資料和委員會對申請所作的決定。在委員會認為合適的情況下,有關申請 資料亦會上載至委員會網頁供公眾免費瀏覽及下載。

Warning 警告

Any person who knowingly or wilfully makes any statement or furnish any information in connection with this application, which is false in any material particular, shall be liable to an offence under the Crimes Ordinance. 任何人在明知或故意的情況下,就這宗申請提出在任何要項上是虛假的陳述或資料,即屬違反《刑事罪行條例》。

Statement on Personal Data 個人資料的聲明

1. The personal data submitted to the Board in this application will be used by the Secretary of the Board and Government departments for the following purposes: 委員會就這宗申請所收到的個人資料會交給委員會秘書及政府部門,以根據《城市規劃條例》及相關的城市規

劃委員會規劃指引的規定作以下用途:

(a) the processing of this application which includes making available the name of the applicant for public inspection when making available this application for public inspection; and 處理這宗申請,包括公布這宗申請供公眾查閱,同時公布申請人的姓名供公眾查閱;以及

(b) facilitating communication between the applicant and the Secretary of the Board/Government departments.

方便申請人與委員會秘書及政府部門之間進行聯絡。

- 2. The personal data provided by the applicant in this application may also be disclosed to other persons for the purposes mentioned in paragraph 1 above. 申請人就這宗申請提供的個人資料,或亦會向其他人士披露,以作上述第1段提及的用途。
- 3. An applicant has a right of access and correction with respect to his/her personal data as provided under the Personal Data (Privacy) Ordinance (Cap. 486). Request for personal data access and correction should be addressed to the Secretary of the Board at 15/F, North Point Government Offices, 333 Java Road, North Point, Hong Kong. 根據《個人資料(私隱)條例》(第 486 章)的規定,申請人有權查閱及更正其個人資料。如欲查閱及更正個人資料,應向委員會秘書提出有關要求,其地址為香港北角渣華道 333 號北角政府合署 15 樓。

Gist	of	App	lication	申	請摘要

(Please provide details in both English and Chinese as far as possible. This part will be circulated to relevant consultees, uploaded to the Town Planning Board's Website for browsing and free downloading by the public and available at the Planning Enquiry Counters of the Planning Department for general information.)

(請盡量以英文及中文填寫。此部分將會發送予相關諮詢人士、上載至城市規劃委員會網頁供公眾免費瀏覽及下載及於規劃署規劃資料查詢處供一般參閱。)

「製火水水」百水	到
Application No. 申請編號	(For Official Use Only) (請勿填寫此欄)
Location/address 位置/地址	新界元朗屏山丈量約份第122約地段第688號、第689號(部分)、第690號(部分)、第691號(部分) 第692號(部分)、第693號(部分)、第694號(部分)、第695號(部分)、第756號(部分)、 第757號(部分)、第758號(部分) 及第947號(部分) Lots 688,689(Part),690(Part),691(Part),692(Part),693(Part),694(Part),695(Part), 756(Part),757(Part),758(Part) and 947(Part) in D. D. 122, Ping Shan, Yuen Long, N. T
Site area	6,500 sq. m 平方米 ☑ About 約
地盤面積	0,500
	(includes Government land of包括政府土地 0 sq. m 平方米 □ About 約)
Plan 圖則	Approved Ping Shan Outline Zoning Plan No. S/YL-PS/20 屏山分區計劃大綱核准圖編號 S/YL-PS/20
Zoning 地帶	Comprehensive Development Area 「綜合發展區」
Type of Application 申請類別	▼ Temporary Use/Development in Rural Areas or Regulated Areas for a Period of 位於鄉郊地區或受規管地區的臨時用途/發展為期 ▼ Year(s) 年
*	□ Renewal of Planning Approval for Temporary Use/Development in Rural Areas or Regulated Areas for a Period of 位於鄉郊地區或受規管地區臨時用途/發展的規劃許可續期為期
	□ Year(s) 年 □ Month(s) 月
Applied use/ development 申請用途/發展	臨時公眾停車場(私家車、中型貨車及旅遊巴士) (為期3年) Temporary Public Vehicle Park for Private Cars, Medium Goods Vehicles and Coaches for a Period of 3 Years

(i) Gross floor area and/or plot ratio			sq.m 平方米		Plot Ratio 地積比率	
	總樓面面積及/或 地積比率	Domestic 住用	0	□ About 約 □ Not more than 不多於	0	□About 約 □Not more than 不多於
	1,	Non-domestic 非住用	0	□ About 約 □ Not more than 不多於	0	□About 約 □Not more than 不多於
(ii)	No. of blocks 幢數	Domestic 住用		0		
		Non-domestic 非住用		0		
(iii)	Building height/No. of storeys 建築物高度/層數	Domestic 住用		0	□ (Not	m 米 more than 不多於)
			-	0	□ (Not	Storeys(s) 層 more than 不多於)
		Non-domestic 非住用		0	□ (Not	m 米 more than 不多於)
				0	□ (Not	Storeys(s) 層 more than 不多於)
(iv)	Site coverage 上蓋面積				%	□ About 約
(v)	No. of parking spaces and loading / unloading spaces 停車位及上落客貨車位數目	Medium Goods V	ng Spaces 私 ng Spaces 電. icle Parking S rehicle Parking hicle Parking S pecify) 其他(家車車位 單車車位 paces 輕型貨車泊車 g Spaces 中型貨車泊 Spaces 重型貨車泊車	車位	60 10 00 28 0 22
		Total no. of vehicle loading/unloading bays/lay-bys 上落客貨車位/停車處總數 Taxi Spaces 的士車位 Coach Spaces 旅遊巴車位 Light Goods Vehicle Spaces 輕型貨車車位 Medium Goods Vehicle Spaces 中型貨車位 Heavy Goods Vehicle Spaces 重型貨車車位 Others (Please Specify) 其他 (請列明)			0 0 0 0 0	

Plans and Drawings 圖則及繪圖 Master layout plan(s) /Layout plan(s) 總綱發展藍圖 / 布局設計圖 Block plan(s) 樓字平面圖 Sectional plan(s) 截視圖 Elevation(s) 立視圖 Photomontage(s) showing the proposed development 顯示擬議發展的合成照片 Master landscape plan(s) /Landscape plan(s) 國境設計總圖 □ □ □ □ □ □ □ □ □ □ □ □ □ □ □ □ □ □	Submitted Plans, Drawings and Documents 提交的圖則、繪圖及文件		>
Master layout plan(s)/Layout plan(s) 總綱發展藍圖 / 布局設計圖			
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DEWELAYE HUDACI ASSESSIBENT ALL STEASESTAN	Sewerage impact assessment 排污影響評估		
Risk Assessment 風險評估			
Others (please specify) 其他(請註明)			
預計車輛進出流量報告		•	
Note: May insert more than one 「 v 」. 註:可在多於一個方格內加上「 v 」 號	Note: May insert more than one「V」. 註:可在多於一個方格內加上「V」號		

Note: The information in the Gist of Application above is provided by the applicant for easy reference of the general public. Under no circumstances will the Town Planning Board accept any liabilities for the use of the information nor any inaccuracies or discrepancies of the information provided. In case of doubt, reference should always be made to the submission of the applicant. 註: 上述申請摘要的資料是由申請人提供以方便市民大眾參考。對於所載資料在使用上的問題及文義上的歧異,城市規劃委員

會概不負責。若有任何疑問,應查閱申請人提交的文件。

申請摘要

- 1. 申請地點的面積約為 6,500 平方米·根據屏山分區計劃大綱核准圖編號 S/YL-PS/20,申請地點現時被規劃為「綜合發展區」。
- 2. 申請地點現時涉及一個物流中心的規劃許可申請(A/YL-PS/687)·由於在限期內仍未能 獲渠務署的批准排水建議書·未能如期履行規劃許可附帶的規劃條件(消防的已完成)· 因此申請人重新提交本申請以要求城市規劃委員會批准為期三年的規劃許可。
- 3. 擬議申請用途為臨時公眾停車場,屬於「綜合發展區」地帶內第二欄的准許用途,按照城 規會條例,需向城規會作出申請,城規會視乎情況考慮,在有條件或無條件的情況下批出 為期不超過3年的規劃許可。
- 4. 申請用途的停車場主要停泊私家車、中型貨車及旅遊巴士,由於現時疫情已過,流浮山及 尖鼻咀本地旅遊團需求急升,旅遊巴士停車位需求相應增加,因此申請人希望能正規合法 申請停泊旅遊巴,減少旅遊巴違泊情況。
- 5. 申請人會把擬議申請地點用鐵板圍起,不會影響到附近的民居。
- 6. 擬議停車場的私家車和旅遊巴的營業時間為星期一至星期日上午七時至晚上九時·包括星期日以外的公眾假期;中型貨車停車場的營業時間在星期一至星期六早上七時至晚上六時· 不包括公眾假期。
- 7. 申請地點附近的元朗屏山區內的居民大多為勞動階層,並依靠運輸行業維生,附近一帶缺乏停車場,違泊的情況十分常見,嚴重影響區內交通運輸網絡。
- 8. 擬議發展只會作臨時公眾停車場停泊私家車、中型貨車及旅遊巴以滿足區內數萬名低收入的勞工階層對私家車及中型貨車位以及疫情過後的旅遊從業員司機對旅遊巴車位的殷切需求。為保持環境質素,申請地點內不會停泊上述種類以外的車輛;中型貨車為重量超過5.5 噸,但24 噸以下的貨車。

- 9. 申請用途不涉及汽車維修、汽車美容、洗車、拆卸及工場用途。
- 10.按規劃處記錄,在申請地點附近(同樣是「綜合發展區」規劃用途的地段),曾獲小組委員會批出多宗同屬停車場的申請個案 (A/YL-PS/377、A/YL-PS/633、A/YL-PS/637、A/YL-PS/660),也是為期3年與本申請相同性質的公眾停車場。
- 11.申請人明白每一宗申請都是個別獨立個案,並無必然關係,唯上述規劃許可申請和本申請用途類近,而該申請都能得到委員會有條件下批出,因此申請人懇請城市規劃委員考慮本申請時參考上述類近申請,申請人定會好好履行附帶條件。

根據以上各點,申請人誠意懇求城市規劃委員會寬大批准新界元朗屏山丈量約份第 122 約地段第 688 號、第 689 號(部分)、第 690 號(部分)、第 691 號(部分)、第 692 號(部分)、第 693 號(部分)、第 694 號(部分)、第 695 號(部分)、第 756 號(部分)、第 757 號(部分)、第 758 號(部分)及第 947 號(部分)作為期三年的臨時公眾停車場(私家車、中型貨車及旅遊巴士)。

預計車輛進出流量報告(私家車)

(星期一至星期日,包括公眾假期)

時間	進入(輛)	離開(輛)
7:00-8:00	1	0
8:00-9:00	1	0
9:00-10:00	0	1
10:00-11:00	0	1
11:00-12:00	2	0
12:00-13:00	1	1
13:00-14:00	1	2
14:00-15:00	0	0
15:00-16:00	1	0
16:00-17:00	1	1
17:00-18:00	0	0
18:00-19:00	1	1
19:00-20:00	0	1
20:00-21:00	1	2
合計(輛)	10	10

預計車輛進出流量報告(旅遊巴士)


(星期一至星期日,包括公眾假期)


時間	進入(輛)	離開(輛)
7:00-8:00	2	0
8:00-9:00	2	0
9:00-10:00	2	2
10:00-11:00	2	2
11:00-12:00	2	3
12:00-13:00	3	2
13:00-14:00	3	0
14:00-15:00	1	2
15:00-16:00	2	1
16:00-17:00	3	1
17:00-18:00	0	2
18:00-19:00	0	2
19:00-20:00	0	3
20:00-21:00	0	2
合計(輛)	22	22

預計車輛進出流量報告(中型貨車)


(星期一至星期六)

時間	進入(輛)	離開(輛)
7:00-8:00	2	2
8:00-9:00	2	0
9:00-10:00	2	2
10:00-11:00	2	3
11:00-12:00	3	2
12:00-13:00	5	1
13:00-14:00	2	4
14:00-15:00	1	2
15:00-16:00	2	4
16:00-17:00	4	4
17:00-18:00	3	4
合計(輛)	28	28

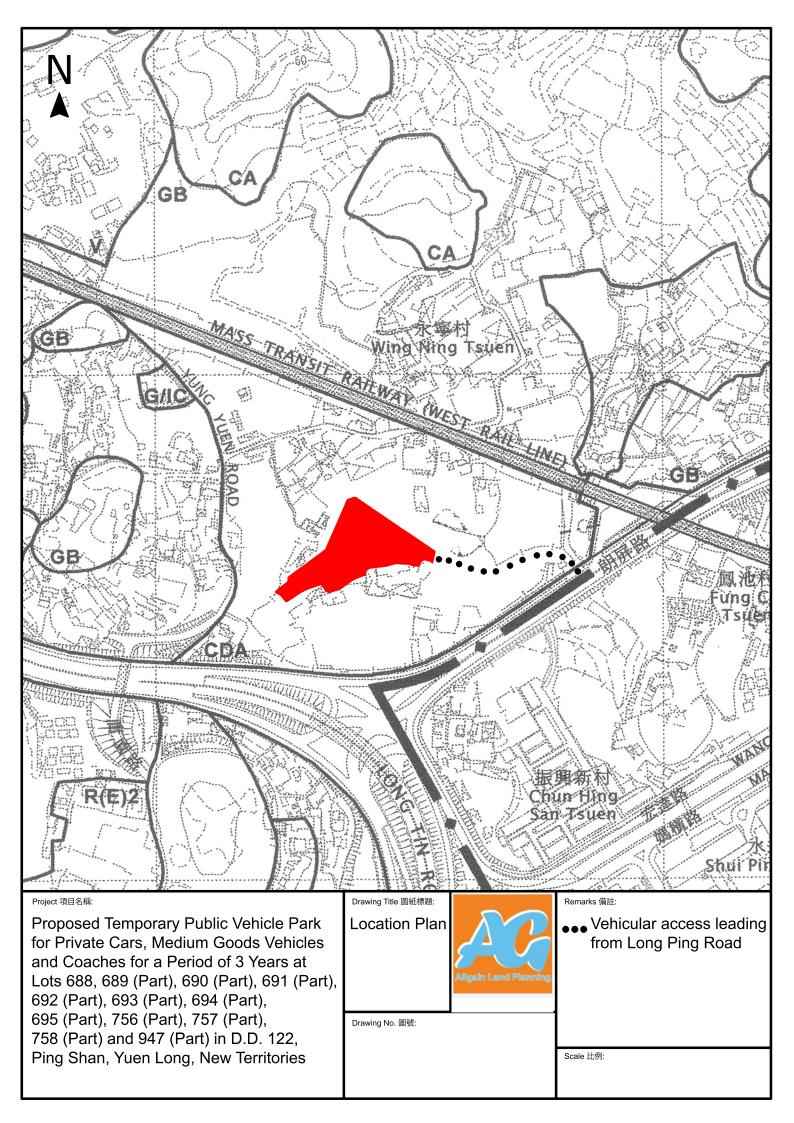

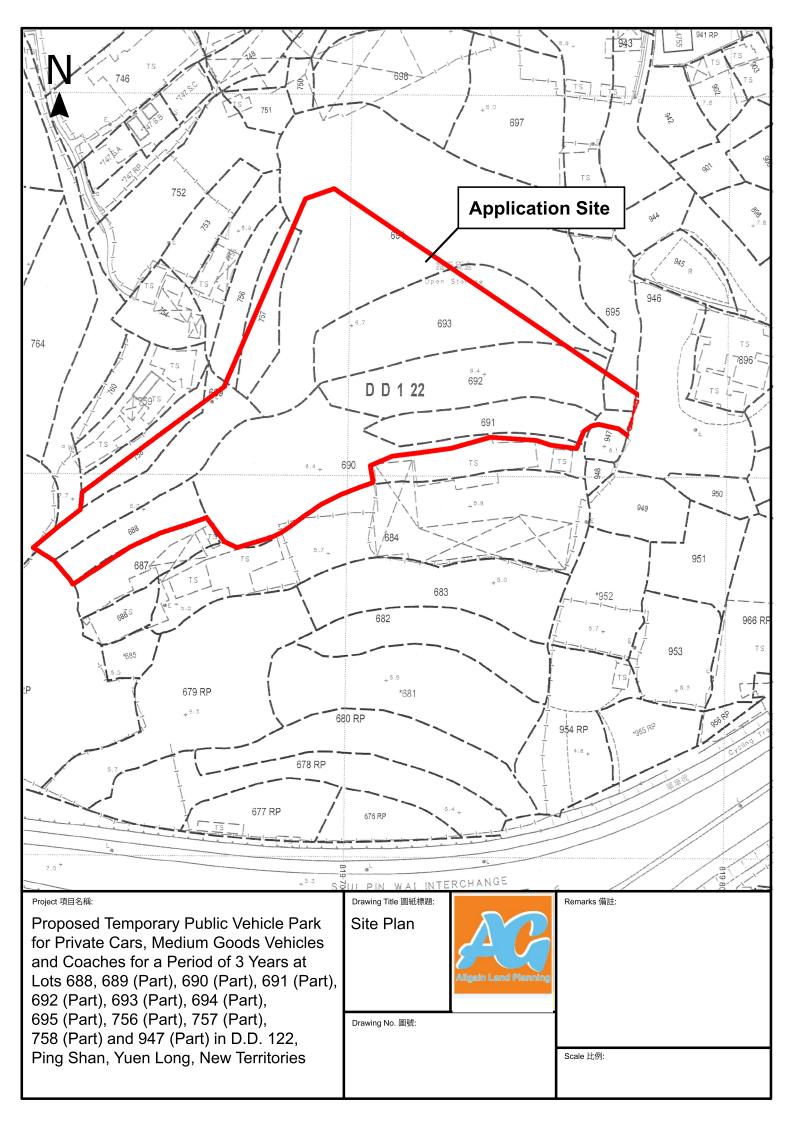



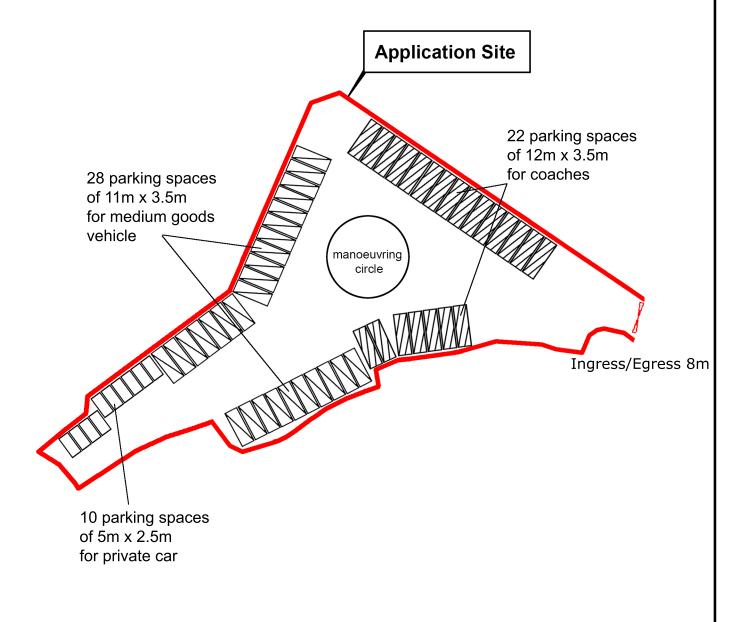

Project 項目名稱:

Proposed Temporary Public Vehicle Park for Private Cars, Medium Goods Vehicles and Coaches for a Period of 3 Years at Lots 688, 689 (Part), 690 (Part), 691 (Part), 692 (Part), 693 (Part), 694 (Part), 695 (Part), 756 (Part), 757 (Part), 758 (Part) and 947 (Part) in D.D. 122, Ping Shan, Yuen Long, New Territories

Drawing Title 圖紙標題: Layout Plan



Remarks 備註:

Medium Goods Vehicle

Coaches

Private Car

Drawing No. 圖號:

Scale 比例:

□Urgent □Return receipt □Expand Group □Restricted □Prevent Copy □Confidential

Max Yuet Lun WONG/PLAND

寄件者: tmylwdpo_pd/PLAND

寄件日期: 2025年10月09日星期四 11:24 **收件者**: Max Yuet Lun WONG/PLAND

副本: Wai Lap TANG/PLAND; Spencer Ka Tsun LEUNG/PLAND

主旨: 轉寄: A/YL-PS/763 : 排水建議書

附件: Temporary Drainage Proposal for A_YL-PS_763.pdf

From: tpbpd/PLAND < tpbpd@pland.gov.hk> Sent: Thursday, October 9, 2025 11:19 AM

To: tmylwdpo_pd/PLAND <tmylwdpo@pland.gov.hk> Cc: Kiff Kit Fu YIU/PLAND <kkfyiu@pland.gov.hk>

Subject: Fw: A/YL-PS/763 : 排水建議書

From: Chong Hermose <

Sent: Thursday, October 9, 2025 11:18 AM To: tpbpd/PLAND <pppd@pland.gov.hk>

Cc: Spencer Ka Tsun LEUNG/PLAND < sktleung@pland.gov.hk>

Subject: A/YL-PS/763: 排水建議書

城規會/規劃處:

現附上規劃申請: A/YL-PS/763 的排水建議書,請查收。

如有什麼問題,請隨時聯絡我,謝謝。

Ms Chong

TEMPORARY DRAINAGE PROPOSAL (FINAL)

APPLICATION SITE OF THE PROPOSED TEMPORARY PUBLIC VEHICLE PARK FOR PRIVATE CARS, MEDIUM GOODS VEHICLES AND COACHES FOR A PERIOD OF 3 YEARS AT LOTS 688, 689(PART), 690(PART), 691(PART), 692(PART), 693(PART), 694(PART), 695(PART), 756(PART), 757(PART), 758(PART) AND 947(PART) IN D.D. 122, PING SHAN, YUEN LONG, N.T.

【 For s16 Application No. : A/YL-PS/763 】

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1 Introduction

1.1 Background

1.1.1 This report presents the Drainage Proposal for supporting the Proposed Temporary Public Vehicle Park for Private Cars, Medium Goods Vehicles and Coaches for a Period of 3 Years at Lots 688, 689(Part), 690(Part), 691(Part), 692(Part), 693(Part), 694(Part), 695(Part), 756(Part), 757(Part), 758(Part) and 947(Part) in D.D. 122, Ping Shan, Yuen Long, N.T. For the site location plan, please refer to the **Appendix A**.

1.2 Objectives of the Report

- 1.2.1 This report shall be prepared to include the following:
 - Identify the potential drainage impact assessment from the proposed Application Site
 - recommend and implement all necessary measures to mitigate adverse drainage impacts arising from the application site

1.3 Report Structure

- 1.3.1 The report contains the following sections:
 - Section 1 on Introduction;
 - Section 2 on Development Proposal;
 - Section 3 on Assessment Criteria;
 - Section 4 on Potential Drainage Impact; and
 - Section 5 on Conclusion.

2 Development Proposal

2.1 Location of the Application Site

- 2.1.1 The application Site is located within the Ping Shan Ping Shan, New Territories, with an area of around $4,300~\text{m}^2$ and ground level varying between + 8.8mPD and + 7.4mPD. The layout plan is provided in **Appendix B.**
- 2.1.2 The applied use/development is the Proposed Temporary Public Vehicle Park for Private Cars, Medium Goods Vehicles and Coache for a Period of 3 Years.

3 Assessment Criteria

3.1 Design Return Periods

3.1.1 The drainage system in the Application site is to collect surface flows and convey to downstream village drain. The recommended design return periods based on the flood levels for the various drainage systems depend on the drainage system, land use, hazard to public safety and community expectations. The recommended design return period is reproduced in Table 3-1 below:

Table 3-1 Recommended Design Return Periods based on Flood Levels

DESCRIPTION	DESIGN RETURN PERIODS
Intensively Used Agricultural Land	2 – 5 Years
Village Drainage including internal Drainage System under a polder Scheme	10 Years
Main Rural Catchment Drainage Channels	50 Years
Urban Drainage Trunk System	200 Years
Urban Drainage Branch System	50 Years

- 3.1.2 As per Storm Drainage Manuel (SDM) Section 6.6.2 Urban Drainage Branch and Urban Drainage Trunk Systems "An 'Urban Drainage Branch System' is defined as a group or network of connecting drains collecting runoff from the urban area and conveying stormwater to a trunk drain, river or sea. For a simple definition, the largest pipe size or the equivalent diameter in case of a box culvert in a branch system will normally be less than 1.8m.
- 3.1.3 An 'Urban Drainage Trunk System' collects stormwater from branch drains and/or river inlets, and conveys the flow to outfalls in river or sea. Pipes with size or diameter equal to or larger than 1.8m are normally considered as trunk drains."
- 3.1.4 As per SDM, since the proposed U-channels are sized smaller than 1.8m, the drainage system would be defined as an urban drainage branch with recommended design return period of 50 years.
- 3.1.5 The 50 years design return period will be considered to ensure adequacy of the stormwater drainage system.

3.2 Calculation Methodology for Runoff

3.2.1 Peak instantaneous runoff values before and after the development were calculated based on the Rational Method and with recommended physical parameters including runoff coefficient (C) and storm constants for different return periods referred to the SDM, based on the following equation:

$$Q_p = 0.278 \text{ C i A}$$

 $\begin{array}{cccc} where & Q_p & = & Peak \ Runoff, \ m^3/s \\ C & = & Runoff \ Coefficient \\ i & = & Rainfall \ Intensity, \ mm/hr \end{array}$

 $A = Catchment Area, km^2$

- 3.2.2 The paved area of the application site will account for 4300 m². The runoff coefficient of 0.8 is assumed.
- 3.2.3 Based on the storm constants for 50-year return period recommended in the SDM, the appropriate rainfall intensities (i) are calculated as detailed in **Appendix D**

3.3 Calculation Methodology for Pipe Capacity Checking

- 3.3.1 Because the catchment areas are less than 1ha, U-channels are recommended to be constructed to collect the stormwater runoff within the site. The collected stormwater should finally be diverted to the proposed 450mm drainpipes via the proposed U-channel system.
- 3.3.2 For the worst-case scenario, bad condition of concrete pipe is assumed for the Manning's roughness coefficient (coefficient value is 0.015) for calculating capacities of concrete U-channel using Manning's Equation.
- 3.3.3 Manning's Equation for calculating the channel and pipe capacities is adopted.

4 Potential Drainage Impact

4.1 Existing Site Condition

- 4.1.1 The application Site is located within the Ping Shan, Yuen Long, New Territories, with an area of around 4,300 m² and ground level varying between + 7.4mPD and + 8.8mPD.
- 4.1.2 There is no specific drainage provision for the current site, the collected stormwater would be discharged as surface runoff and infiltration leading to the natural stream or river.
- 4.1.3 Apart from the application site with a projected area of 4,300m² is considered as part of the catchment. The adjacent site with 6,000m² is considered as external catchment area as the runoff would discharge from the adjacent site to the manhole CP2 of the application site.

4.2 Changes in Drainage Characteristics

- 4.2.1 The characteristics of the sub-catchment areas are remained unchanged due to the temporary development for the application site, which are paved area.
- 4.2.2 The application site is fully covered by concrete surface currently. This application does not propose adding any additional concrete area, the difference in surface runoff that can be attributed to this application is negligible. Since there are no changes in Drainage Characteristics, it is considered that the drainage discharge from the Application Site will not cause adverse impact to the entire downstream drainage system.

4.3 Potential Drainage Impact

- 4.3.1 The details of the proposed drainage works are illustrated in **Appendix C**.
- 4.3.2 To effectively convey stormwater away from the application site and minimize the potential impact to the drainage infrastructure of the village area, drainage works consists of U-channels, are proposed to convey the flow to the terminate catch pit.
- 4.3.3 The runoff from the Application site is collected by U-channels along the boundary and discharged to the terminate Catch pit, which is connected to the further downstream leading to the U-channel (by others) at the south of the application site, and eventually lead to the existing village river.
- 4.3.4 The 450mm U-channel receives stormwater from the surface and the upstream catchment. For Conservative, the critical scenario is considered for collecting all the flow leading to the 450mm

U-channel. The design calculation of the proposed drainage is provided in **Appendix D**. The design calculation is summarized in Table 4-1.

Table 4-1 Design calculation of the proposed drainage work

DRAINAGE	ESTIMATED FLOW	CAPACITY	RESERVE CAPACITY
SYSTEM	(M³/S)	(M³/S)	
450mm UC	0.395	0.427	7%

Note:

- [1] Rainfall increase due to climate change at the end of 21st century is considered according to stormwater drainage manual Table 28.
- [2] The reserve capacity is calculated by assuming that the 450mm U-channel reach its full capacity for conservative.
- 4.3.5 The design runoff arise from the proposed Application Site is to be discharged into the proposed 450mm u-channel with the runoff anticipated to be 0.395m³/s, which is within the drainage capacity of the proposed 450mm u-channel of 0.427 m³/s with gradient 1:70 with reserve capacity 7%.
- 4.3.6 All u-channels, catch pits will be constructed according to the CEDD's standard drawings, please refer to the **Appendix E.**

5 Construction Stage

5.1 Temporary Drainage Arrangements

- 5.1.1 Proper measures shall be taken to maintain the existing drainage characteristics of the catchment areas and to minimize drainage impacts associated with the construction works. The principal drainage impacts which are associated with construction of the works have been identified as follows:
 - (a) Erosion of ground materials;
 - (b) Sediment transportation to existing downstream drainage system; and
 - (c) Obstruction to drainage systems.
- 5.1.2 Regular inspections shall be carried out to ensure integrity of the works. These inspections shall cover works under construction as well as recently completed areas.
- 5.1.3 To ensure proper operation of the site drainage channels and desilting facilities, inspection of the perimeter drains shall be carried out on a weekly basis and the desilting facilities shall be cleaned on a daily basis.
- 5.1.4 If excavated materials are not possible to transport away the excavated material within the same day, the material should be covered by tarpaulin/impervious sheets. Stockpiles of construction materials (for examples aggregate, fill materials) of more than 50 m³ in an open area shall also be covered with tarpaulin or similar fabric during rainstorms.
- 5.1.5 All runoff discharged into the existing drainage system will be settled in a silt trap to ensure no sediment will be discharged into the channel. Silt traps will normally be provided along the site drainage immediately upstream of the proposed discharge point to the existing Site. The silt traps will be inspected daily and immediately after each rainstorm.
- 5.1.6 Liaison will be carried out with relevant parties regarding temporary drainage arrangements to ensure that the drainage system is functioning adequately.


6 Conclusions

6.1 Conclusion

- 6.1.1 Apart from the application site with a projected area of 4,300m² is considered as part of the catchment. The adjacent site with 6,000m² is considered as external catchment area as the runoff would discharge to the manhole CP2 of the application site.
- 6.1.2 U-channels are proposed to convey runoff from the application site for collection. The proposed U-channels are located along the site boundary which is subject to change to suit the building layout.
- 6.1.3 The assessment reviews and demonstrates the drainage pipe have the sufficient capacity to cater for the drainage flow from the Application Site.
- 6.1.4 Mitigation measures are proposed during the application site proposed Application Site and to ensure that the existing drainage system within the site will not be affected during the construction stage.

END OF TEXT


APPENDIX A SITE LAYOUT PLAN

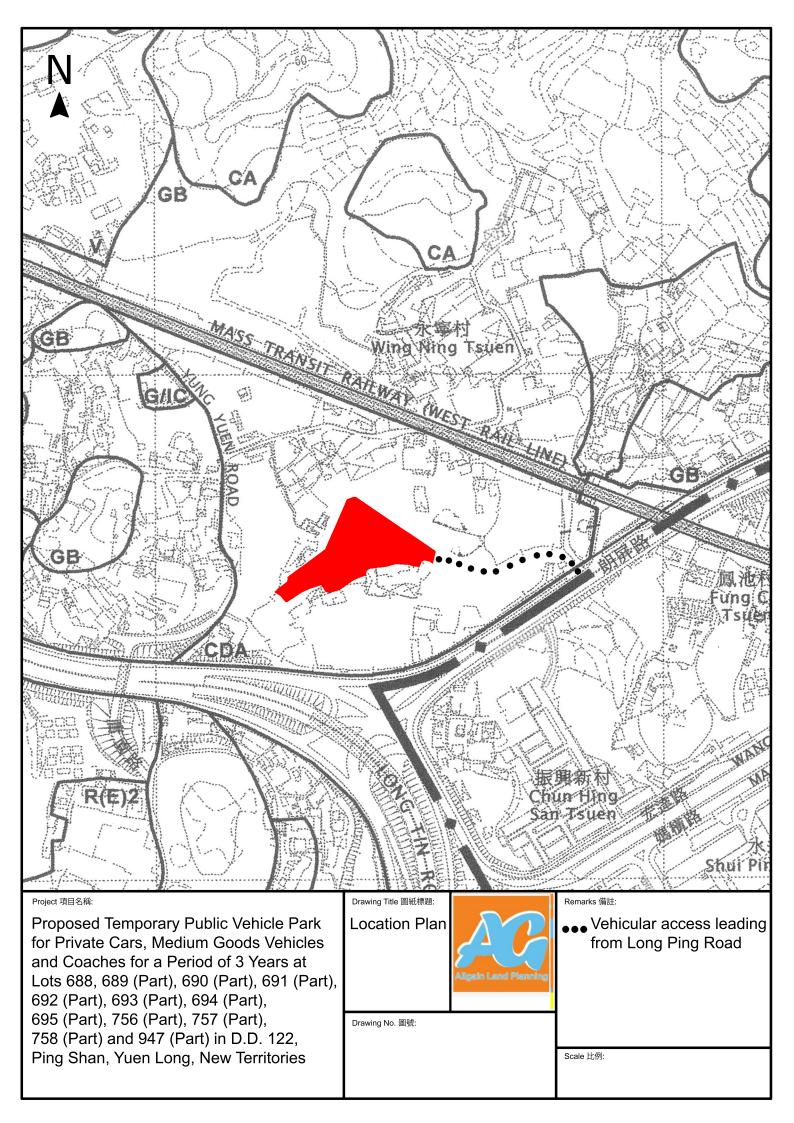

APPENDIX B

LAYOUT PLAN



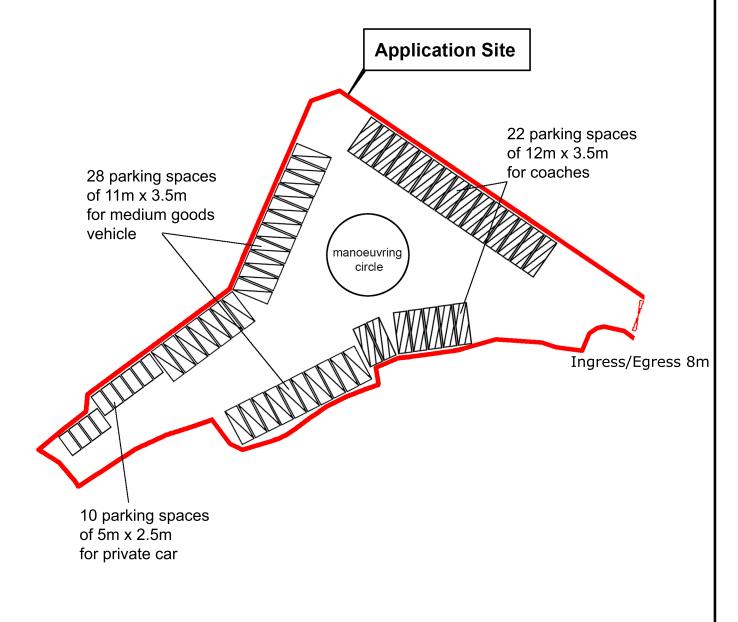

Project 項目名稱:

Proposed Temporary Public Vehicle Park for Private Cars, Medium Goods Vehicles and Coaches for a Period of 3 Years at Lots 688, 689 (Part), 690 (Part), 691 (Part), 692 (Part), 693 (Part), 694 (Part), 695 (Part), 756 (Part), 757 (Part), 758 (Part) and 947 (Part) in D.D. 122, Ping Shan, Yuen Long, New Territories

Drawing Title 圖紙標題: Layout Plan

Drawing No. 圖號:



Remarks 備註:


Medium Goods Vehicle

Coaches

Private Car

Scale 比例:

APPENDIX C
PROPOSED DRAINAGE PLAN

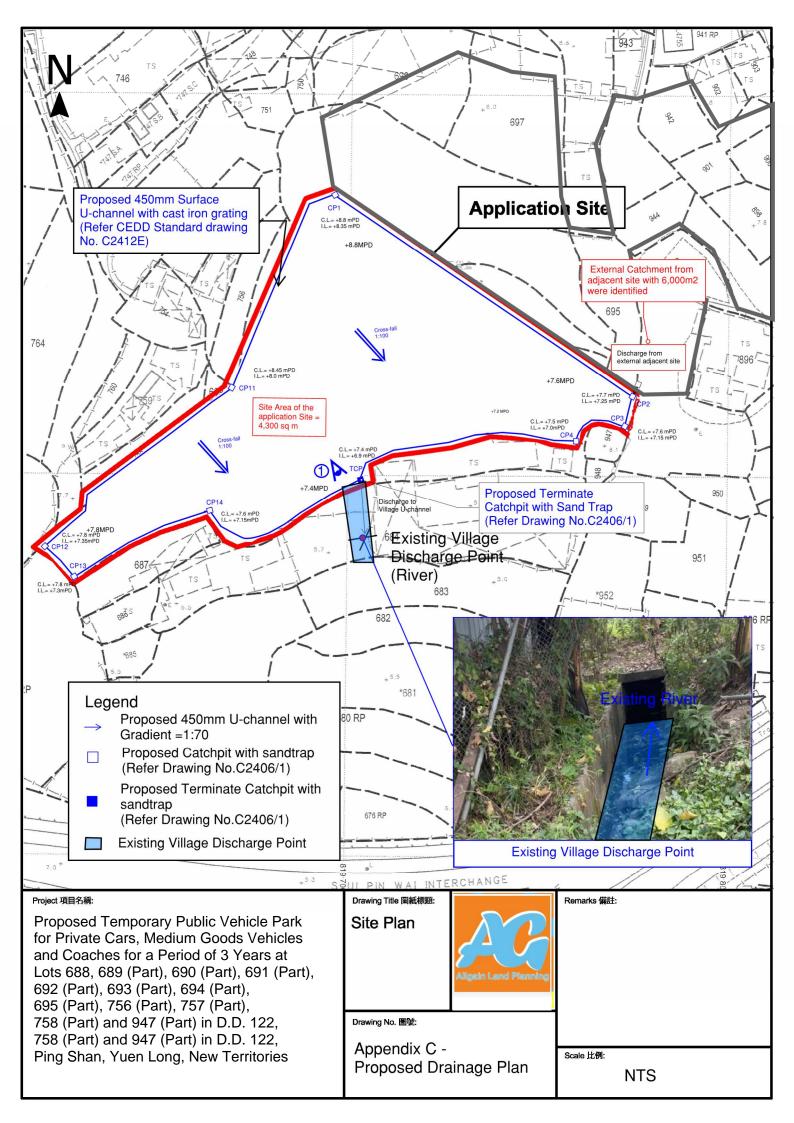

APPENDIX D

DESIGN CALCULATION OF THE PROPOSED DRAINAGE

Design Data

- 1. Design follows the Rational Method in accordance with Stormwater Drainage Manual 2018 (DSD)
- 2. Runoff coefficient for paved land is 0.8.
- 3. Design return period is 50 years.
- 4. For manning's equation coefficent n is 0.015.

Check for Hydraulic Capacity:

Catchment	K	Area (A)
Application Site	0.80	4300.0 m ²
adjacent site	0.80	6000.0 m ²
Total catchment area		8240.0 m ²

Runoff estimation
Average slope, H
Catchment area, A

Distance between summit and point under consideration, L

SDM 7.5.2 Time of concentration of natural catchment, t_o

Length of drain, L_j Velocity, V_j

SDM 7.5.2 Flow time, t_f

Time of concentration, t_c

SDM Table 3 Storm constants for 50-year return period:

SDM 4.3.2 Extreme mean intensity, i_{50yr}

GMS Fig 8.2 SDM 7.5.2 Design flow, Q

Manning's Eq.

450mm u-channel capacity

Diameter Cross-sectional area of 450mm U-channel Gradient

flow velocity

Design Capacity

Reserve capacity

= 0.5 /100m = 8240 m² = 0.14465 x L / (H^{0.2} x A) = 6 74 min

= 100 m $= 0.14465 \times \text{L} / (\text{H}^{0.2} \times \text{A}^{0.1})$ = 6.74 min. = 200 m = 2.363 m/s $= \Sigma (\text{L}_{j} / \text{V}_{j})$ = 1.411 min. $= t_{0} + t_{f}$ = 8.15 min.

a = 451.3 b = 2.46 c = 0.337 $= a / (t_d + b)^c$

= 172.48 mm/hr < 405.000 mm/hr = 0.278 i Σ K A

 $0.395 \text{ m}^3/\text{s}$

= 450 mm $= .0.1808 \text{ m}^2$ = 0.01 = 2.363 m/s


= $0.427 \text{ m}^3/\text{s}$ > $0.395 \text{ m}^3/\text{s}$ OK = 7%


For conservative, all the U-channel along the site boundary shall be 450mm.


APPENDIX E

TYPICAL STANDARD DRAWINGS OF U-CHANNEL AND CATCHPIT

(EXTRACTED FROM CEDD, FOR REFERNCE ONLY)

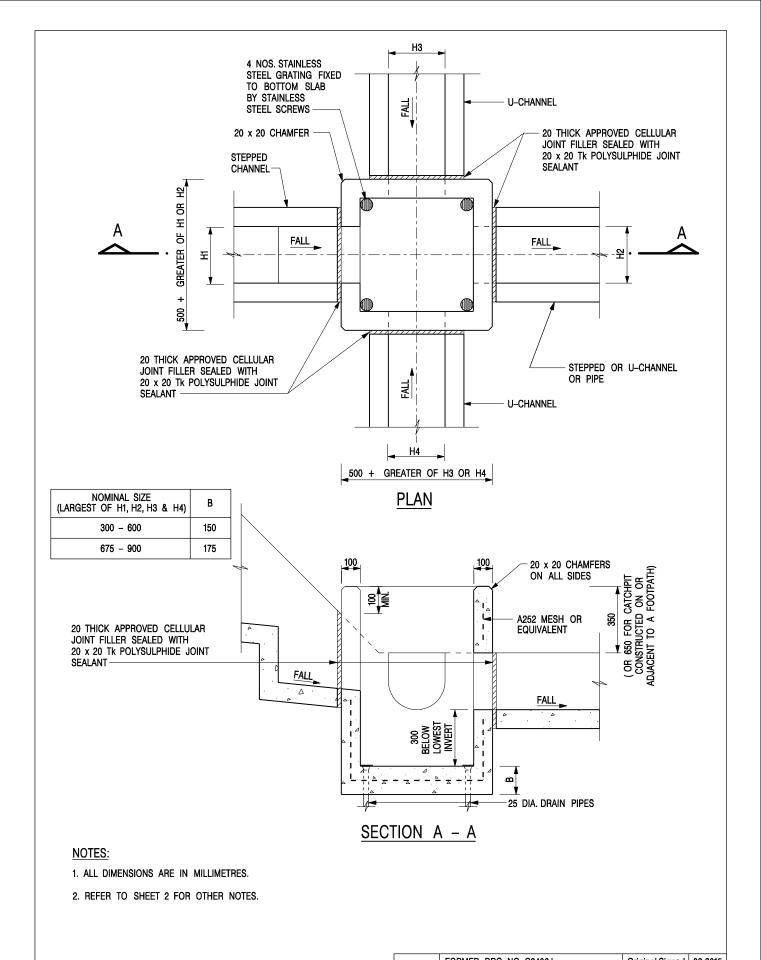

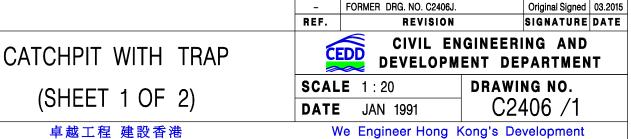

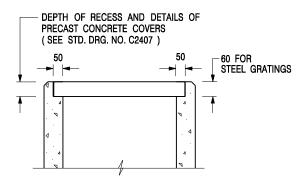

ALTERNATIVE TOP SECTION FOR PRECAST CONCRETE COVERS / GRATINGS

NOTES:

- 1. ALL DIMENSIONS ARE IN MILLIMETRES.
- 2. ALL CONCRETE SHALL BE GRADE 20 /20.
- 3. CONCRETE SURFACE FINISH SHALL BE CLASS U2 OR F2 AS APPROPRIATE.
- 4. FOR DETAILS OF JOINT, REFER TO STD. DRG. NO. C2413.
- 5. CONCRETE TO BE COLOURED AS SPECIFIED.
- UNLESS REQUESTED BY THE MAINTENANCE PARTY AND AS DIRECTED BY THE ENGINEER, CATCHPIT WITH TRAP IS NORMALLY NOT PREFERRED DUE TO PONDING PROBLEM.
- 7. UPON THE REQUEST FROM MAINTENANCE PARTY, DRAIN PIPES AT CATCHPIT BASE CAN BE USED BUT THIS IS FOR CATCHPITS LOCATED AT SLOPE TOE ONLY AND AS DIRECTED BY THE ENGINEER.
- FOR CATCHPITS CONSTRUCTED ON OR ADJACENT TO A FOOTPATH, STEEL GRATINGS (SEE DETAIL 'A' ON STD. DRG. NO. C2405 /2) OR CONCRETE COVERS (SEE STD. DRG. NO. C2407) SHALL BE PROVIDED AS DIRECTED BY THE ENGINEER.
- 9. IF INSTRUCTED BY THE ENGINEER, HANDRAILING (SEE DETAIL 'J' ON STD. DRG. NO. C2405 /5; EXCEPT ON THE UPSLOPE SIDE) IN LIEU OF STEEL GRATINGS OR CONCRETE COVERS CAN BE ACCEPTED AS AN ALTERNATIVE SAFETY MEASURE FOR CATCHPITS NOT ON A FOOTPATH NOR ADJACENT TO IT. TOP OF THE HANDRAILING SHALL BE 1 000 mm MIN. MEASURED FROM THE ADJACENT GROUND LEVEL.
- 10. MINIMUM INTERNAL CATCHPIT WIDTH SHALL BE 1 000 mm FOR CATCHPITS WITH A HEIGHT EXCEEDING 1 000 mm MEASURED FROM THE INVERT LEVEL TO THE ADJACENT GROUND LEVEL. AND, STEP IRONS (SEE DSD STD. DRG. NO. DS1043) AT 300 c/c STAGGERED SHALL BE PROVIDED. THICKNESS OF CATCHPIT WALL FOR INSTALLATION OF STEP IRONS SHALL BE INCREASED TO 150 mm.
- 11. FOR RETROFITTING AN EXISTING CATCHPIT WITH STEEL GRATING, SEE DETAIL 'G' ON STD. DRG. NO. C2405 /4.
- SUBJECT TO THE APPROVAL OF THE ENGINEER, OTHER MATERIALS CAN ALSO BE USED AS COVERS / GRATINGS.

Α	MINOR AMENDMENT.	Original Signed	04.2016
-	FORMER DRG. NO. C2406J.	Original Signed	03.2015
REF.	REVISION	SIGNATURE	DATE

CATCHPIT WITH TRAP (SHEET 2 OF 2)

卓越工程 建設香港




CIVIL ENGINEERING AND DEVELOPMENT DEPARTMENT

SCALE 1:20 **DATE** JAN 1991

DRAWING NO. C2406 /2A

We Engineer Hong Kong's Development

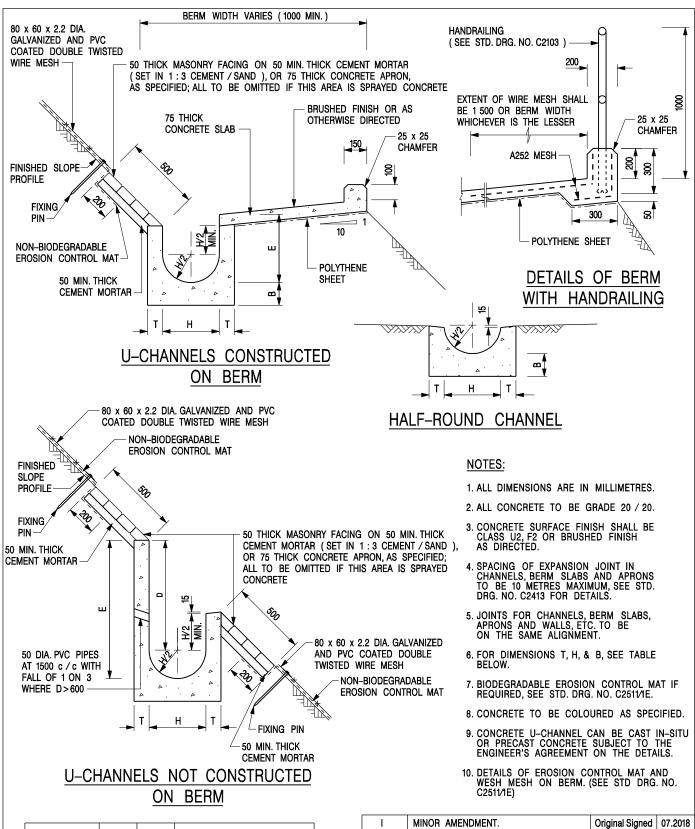

NOMINAL SIZE H	Т	В	REINFORCEMENT
300	80	100	A252 MESH PLACED CENTRALLY AND T=100
375 - 600	100	150	WHEN E>650
675 - 900	125	175	A252 MESH PLACED CENTRALLY

	ı	MINOR AMENDMENT.	Original Signed	07.2018
	Н	THICKNESS OF MASONRY FACING AMENDED.	Original Signed	01.2005
	G	MINOR AMENDMENT.	Original Signed	01.2004
	F	GENERAL REVISION.	Original Signed	12.2002
	E	DRAWING TITLE AMENDED.	Original Signed	11.2001
	D	MINOR AMENDMENT.	Original Signed	08.2001
	С	150 x 100 UPSTAND ADDED AT BERM.	Original Signed	6.99
	В	MINOR AMENDMENTS.	Original Signed	3.94
ı	REF.	REVISION	SIGNATURE	DATE

DETAILS OF HALF-ROUND AND U-CHANNELS (TYPE A -WITH MASONRY APRON)

卓越工程 建設香港




CIVIL ENGINEERING AND DEVELOPMENT DEPARTMENT


 SCALE
 1:25
 DRAWING NO.

 DATE
 JAN 1991
 C24091

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U-CHANNELS CONSTRUCTED ON BERM WITH NON-BIODEGRADABLE EROSION CONTROL MAT <u>J-CHANNELS NOT CONSTRUCTED ON BERM</u>
<u>WITH NON-BIODEGRADABLE</u>
EROSION CONTROL MAT

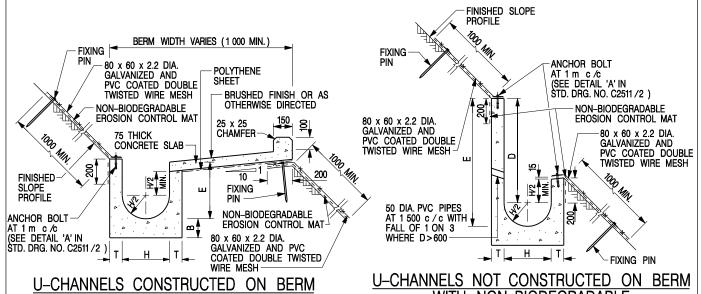

U-CHANNELS CONSTRUCTED ON BERM WITH BIODEGRADABLE EROSION CONTROL MAT

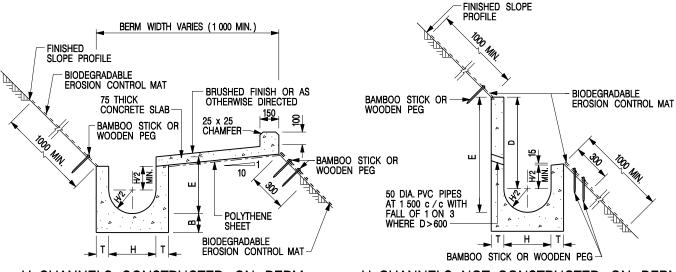U-CHANNELS NOT CONSTRUCTED ON BERM WITH BIODEGRADABLE EROSION CONTROL MAT

NOTES:

- 1. ALL DIMENSIONS ARE IN MILLIMETRES.
- 2. ALL CONCRETE TO BE GRADE 20 /20.
- 3. CONCRETE SURFACE FINISH SHALL BE CLASS U2, F2 OR BRUSHED FINISH AS DIRECTED.
- 4. SPACING OF EXPANSION JOINT IN CHANNELS, BERM SLABS AND APRONS TO BE 10 METRES MAXIMUM, SEE STD. DRG. NO. C2413 FOR DETAILS.
- 5. JOINTS FOR CHANNELS, BERM SLABS, APRONS AND WALLS, ETC. TO BE ON THE SAME ALIGNMENT.
- 6. FOR DIMENSIONS T, H, & B, SEE TABLE BELOW.
- FOR TYPICAL FIXING PIN DETAILS, SEE STD. DRG. NO. C2511/2.
- MINIMUM SIZE OF 25 x 50 x 300mm SHALL BE PROVIDED FOR WOODEN PEG.
- MINIMUM SIZE OF 10mm DIAMETER WITH 200mm LONG SHALL BE PROVIDED FOR BAMBOO STICK.
- 10. THE FIXING DETAILS OF NON-BIODEGRADABLE AND BIODEGRADABLE EROSION CONTROL MATS ON EXISTING BERM SHALL REFER TO STD. DRG. NO. C2511/1.

NOMINAL SIZE H	Т	В	REINFORCEMENT
300	80	100	A252 MESH PLACED CENTRALLY AND T=100
375 - 600	100	150	WHEN E>650
675 - 900	125	175	A252 MESH PLACED CENTRALLY

DETAILS OF HALF-ROUND AND U-CHANNELS (TYPE B - WITH EROSION CONTROL MAT APRON)

REF.	REVISION	SIGNATURE	DATE
A MINOR AMENDMENT.		Original Signed	10.92
В	MINOR AMENDMENT.	Original Signed	3.94
С	150 x 100 UPSTAND ADDED AT BERM.	Original Signed	6.99
D	MINOR AMENDMENT.	Original Signed	08.2001
E	GENERAL REVISION.	Original Signed	12.2002
F	MINOR AMENDMENT.	Original Signed	01.2004
G	DIMENSION TABLE AMENDED.	Original Signed	01.2005
Н	FIXING DETAILS OF BIODEGRADABLE EROSION CONTROL MAT ADDED.	Original Signed	12.2017
I	MINOR AMENDMENT.	Original Signed	07.2018



CIVIL ENGINEERING AND DEVELOPMENT DEPARTMENT

SCALE DIAGRAMMATIC


DATE JAN 1991


MINIOD AMENDMENT

DRAWING NO. C24101

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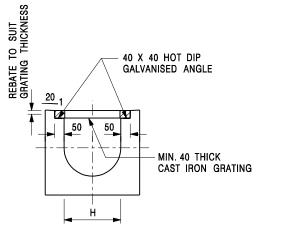



TYPICAL SECTION

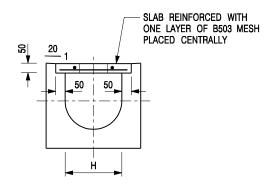PLAN OF SLAB

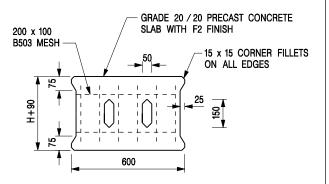U-CHANNELS WITH PRECAST CONCRETE SLABS

(UP TO H OF 525)



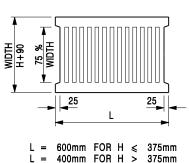

TYPICAL SECTION

CAST IRON GRATING

(DIMENSIONS ARE FOR GUIDANCE ONLY, CONTRACTOR MAY SUBMIT EQUIVALENT TYPE)

U-CHANNEL WITH CAST IRON GRATING

(UP TO H OF 525)

NOTES:

- 1. ALL DIMENSIONS ARE IN MILLIMETRES.
- 2. H=NOMINAL CHANNEL SIZE.
- 3. ALL CAST IRON FOR GRATINGS SHALL BE GRADE EN-GJL-150 COMPLYING WITH BS EN 1561.
- 4. FOR COVERED CHANNELS TO BE HANDED OVER TO HIGHWAYS DEPARTMENT FOR MAINTENANCE, THE GRATING DETAILS SHALL FOLLOW THOSE AS SHOWN ON HyD STD. DRG. NO. H3156.

REF.	REVISION	SIGNATURE	DATE
Α	CAST IRON GRATING AMENDED.	Original Signed	12.2002
В	NAME OF DEPARTMENT AMENDED.	Original Signed	01.2005
С	MINOR AMENDMENT. NOTE 3 ADDED.	Original Signed	12.2005
D	NOTE 4 ADDED.	Original Signed	06.2008
E	NOTES 3 & 4 AMENDED.	Original Signed	12.2014

COVER SLAB AND CAST IRON GRATING FOR CHANNELS



CIVIL ENGINEERING AND DEVELOPMENT DEPARTMENT

 SCALE 1:20
 DRAWING NO.

 DATE JAN 1991
 C2412E

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□Urgent □Return receipt □Expand Group □Restricted □Prevent Copy □Confidential

Max Yuet Lun WONG/PLAND

寄件者: Chong Hermose <

寄件日期: 2025年10月21日星期二 8:47

收件者: tpbpd/PLAND

副本: Max Yuet Lun WONG/PLAND; Emily Tsz Yan WONG/PLAND

主旨: A/YL-PS/763 : 回應部門意見

附件: A_YL-PS_763_回應部門意見.pdf; 附件1.pdf

類別: Internet Email

城規會/規劃處:

現附上規劃申請:A/YL-PS/763 的回應部門意見,請查收。


如有什麼問題,請隨時聯絡我,謝謝。


Ms Chong

Planning Application No. A/YL-PS/763

Table A: Responses to Departmental Comments

	Departmental Comments	Responses
	Transport Department	
(a)	(a) The applicant should indicate the width	請看附件 1。
	of the aisle, the site entrance and the	
	vehicular access leading to the subject site;	
(b)	The applicant should advise the access	現場工程已完工,包括平整和渠務工
	arrangement and trip generation/attraction	程。
	during construction period;	
(c)	The access connecting the subject site and	申請人知悉,並會自行和相關地主協
	Long Ping Road is not managed by	商。
	Transport Department. The land status of	
	the local access road should be clarified	
	with the Lands Department by the	
	applicant. Moreover, the management	
	and maintenance responsibilities of the	
	local access road should be clarified with	
	the relevant lands and maintenance	
	authorities accordingly; and	
(d)	The applicant should demonstrate with a	請看附件 1。
	layout plan with dimension and turning	
	table/swept path that sufficient space	
	would be allowed for manoeuvring inside	
	the proposed development.	

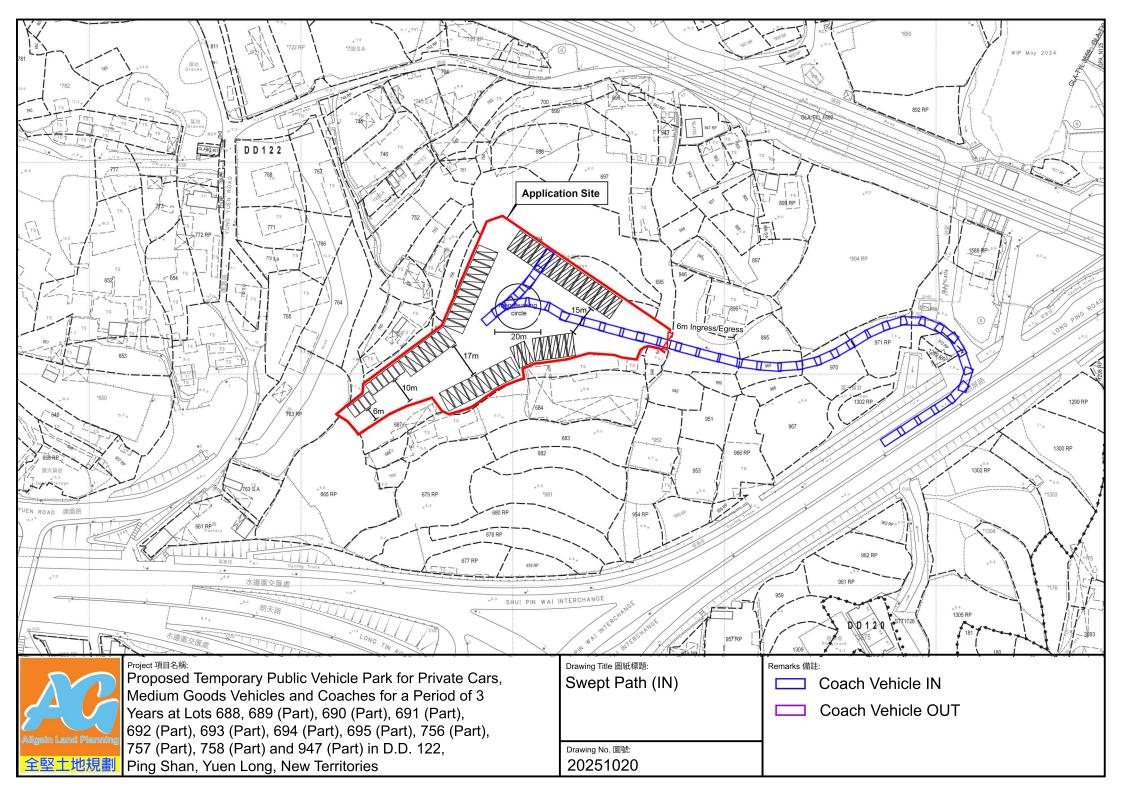

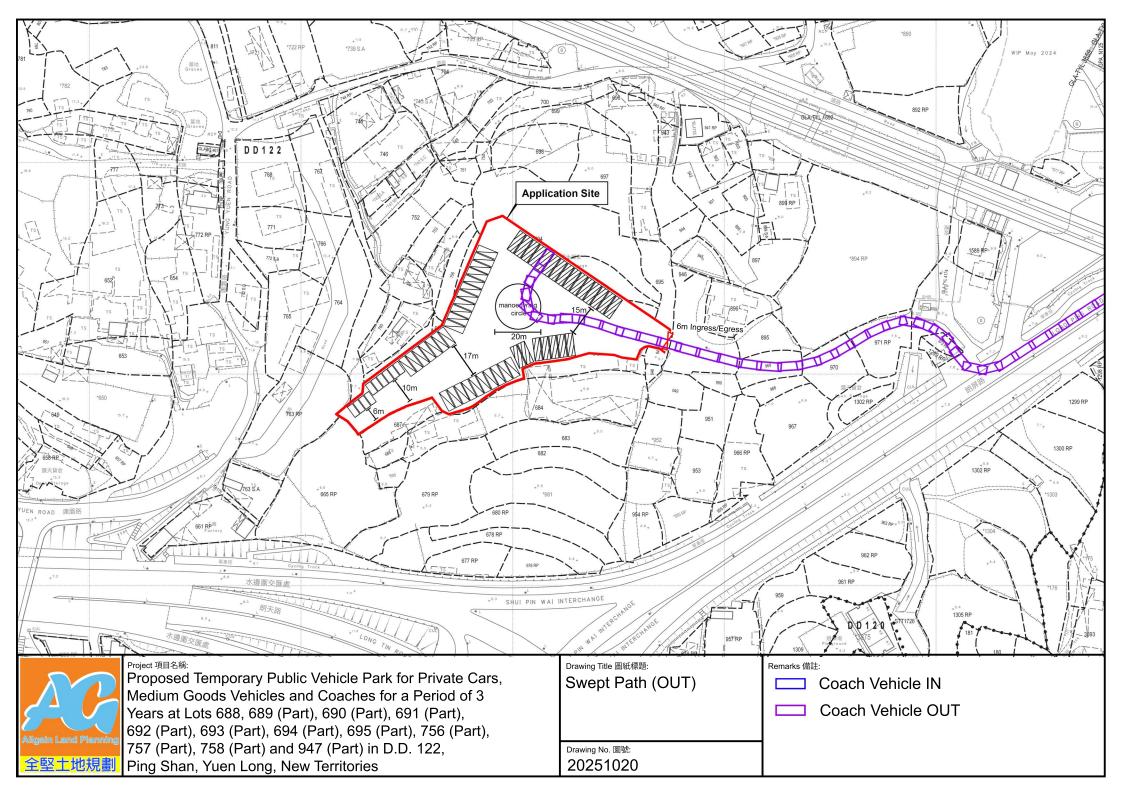

Previous Applications Covering the Site

Approved Applications

Application No.	<u>Development/Use</u>	Date of
		Consideration
A/YL-PS/662	Proposed Temporary Logistics Centre for a Period of 3 Years	29.7.2022
A/YL-PS/687	Temporary Public Vehicle Park for Private Cars, Medium Goods Vehicles and Coaches for a Period of 3 Years	14.7.2023 (Revoked on 14.1.2025)

Rejected Applications

Application	Zoning	Development/Use	Date of	Rejection
<u>No.</u>	(at the time of		Consideration	<u>Reasons</u>
	consideration)		.==	
A/YL-PS/33	"Undetermined"	Temporary Private Car/Rigid	17.7.1998	(1), (2) & (3)
	("U")	Lorry/Container Lorry Park and		
		Open Storage of Unregistered Car		
		for a Period of 4 Years		
A/YL-PS/79	"U"	Proposed Temporary Open Storage	14.7.2000	(4) & (5)
		of Construction Materials for a		
		Period of 3 Years		
A/YL-PS/82	"U"	Temporary Open Storage of	23.2.2001	(4) & (5)
		Construction Materials for a Period	(TPB)	
		of 3 Years	, ,	
A/YL-PS/85	"U"	Temporary Open Storage of	11.5.2001	(4) & (5)
		Construction Materials for a Period	(TPB)	
		of 3 Years		
A/YL-PS/113	"U"	Temporary Open Storage of	14.6.2002	(4) & (5)
		Building Materials and		
		Construction Machinery for a		
		Period of 3 Years		
A/YL-PS/182	"U"	Temporary Open Park of Left Hand	11.6.2004	(1), (4) & (6)
		Drive Private Cars and Light Goods		
		Vehicles for a Period of 3 Years		
A/YL-PS/233	"U"	Temporary Open Storage of	9.6.2006	(1) & (3)
		Construction Machinery and	(TPB)	
		Materials for a Period of 3 Years		
A/YL-PS/642	"CDA"	Proposed Residential Development	24.12.2021	(5) & (7)
		(Houses)		

Rejection Reasons

- (1) Undesirable precedent
- (2) Insufficient information to demonstrate no adverse traffic impact on the area
- (3) Insufficient information to demonstrate no adverse drainage impact on the area
- (4) Incompatible with the surrounding land uses
- (5) Insufficient information to demonstrate no adverse impacts on the surrounding
- (6) Not in line with the Town Planning Board Guidelines on "Open Storage and Port Back-up Uses"
- (7) Not in line with the Town Planning Board Guidelines on the implementation of "CDA" Zones

Similar Applications within the Same "CDA" zone in the past 5 Years

Approved Applications

Application No.	Zoning (at the time of consideration)	<u>Development/Use</u>	Date of Consideration
A/YL-PS/637	"CDA"	Renewal of Planning Approval for Temporary Public Vehicle Park (excluding container vehicle) for a Period of 3 Years	25.6.2021
A/YL-PS/660	"CDA"	Proposed Temporary Public Vehicle Park for Private Cars and Medium Goods Vehicles for a Period of 3 Years	29.7.2022 (Revoked on 29.1.2024)
A/YL-PS/708	"CDA"	Temporary Public Vehicle Park (Private Cars and Medium Goods Vehicles) for a Period of 3 Years	19.7.2024
A/YL-PS/716	"CDA"	Renewal of Planning Approval for Temporary Public Vehicle Park (excluding container vehicle) for a Period of 3 Years	7.6.2024

Government Departments' General Comments

1. Land Administration

Comments of the District Lands Officer/Yuen Long, Lands Department (DLO/YL, LandsD):

- no adverse comment on the application;
- the application site (the Site) comprises Old Schedule Agricultural Lots held under Block Government Lease which contains the restriction that no structure area allowed to be erected without prior approval of the Government; and
- it is noted that no structure is proposed at the Site.

2. Traffic

Comments of the Chief Highway Engineer/New Territories West, Highways Department (CHE/NTW, HyD):

No adverse comment on the application.

3. Drainage

Comments of the Chief Engineer/Mainland North, Drainage Services Department (CE/MN, DSD):

- no in-principle objection to the application from a drainage point of view;
- should the application be approved by the Board, a condition should be stipulated the approval letter requiring the applicant to submit a revised drainage proposal, and to maintain the proposed drainage facilities to the satisfaction of DSD; and
- regarding the submitted drainage proposal, the applicant should note his advisory comments at **Appendix V**.

4. **Building Matters**

Comments of the Chief Building Surveyor/New Territories West, Buildings Department (CBS/NTW, BD):

No objection to the application as there is no structure proposed in the application.

5. <u>District Officer's Comments</u>

Comments of the District Officer (Yuen Long), Home Affairs Department (DO(YL), HAD):

No feedback from locals was received.

6. Other Departments

The following departments has no comment on the application:

- Commissioner of Police (C of P);
- Director of Fire Services (D of FS);
- Director of Electrical and Mechanical Services (DEMS);
- Project Manager (West), Civil Engineering and Development Department (PM(W), CEDD); and
- Chief Engineer/Construction, Water Supplies Department (CE/C, WSD).

Recommended Advisory Clauses

- (a) to resolve any land issues relating to the development with the concerned owner(s) on site access arrangement;
- (b) to note the comments of the District Lands Officer/Yuen Long, Lands Department (DLO/YL, LandsD) that right-of-way to the application site (the Site) is not guaranteed;
- (c) to note the comments of the Commissioner of Transport (C for T) that:
 - (i) sufficient space within the Site should be provided for maneuvering of vehicles:
 - (ii) no vehicle is allowed to queue back to or reverse onto/from public road at any time during the planning approval period; and
 - (iii) the Site is connected to the public road network via a local access road which is not managed by her department. The land status of that local access road should be checked with LandsD. The management and maintenance responsibilities of that local access road should be clarified with the relevant lands and maintenance authorities accordingly;
- (d) to note the comments of the Chief Highway Engineer/New Territories West, Highways Department (CHE/NTW, HyD) that adequate drainage measures should be provided at the site access to prevent surface water flowing from the Site to the nearby public roads/drains. His department shall not be responsible for the maintenance of any access connecting the Site and Long Ping Road;
- (e) to note the comments of the Chief Engineer/Mainland North, Drainage Services Department (CE/MN, DSD) that the applicant is should revise the submitted drainage proposal as follows:
 - (i) paragraph 2.1.1, 3.2.2, 4.1.1, 4.1.3, 6.1.1, calculations and application form

 Please check and clarify the application site area should be 6,500 m² or
 4,300 m². The applicant should also update the calculations where necessary;
 - (ii) paragraph 3.2.2 and calculations Runoff coefficient of 0.8 is considered underestimated. Please adopted a higher value. The applicant should also update the calculations;
 - (iii) Table 4-1 The applicant should also provide the utilisation rate, which should be practically lower than 85%;
 - (iv) the applicant should provide a catchment area plan, including external catchment areas, for reference;
 - (v) the applicant should advise if any site formation/ land filling works to be carried out under this application. Please note that the overland flow from the adjacent lands should not be affected;
 - (vi) the applicant should check and ensure the hydraulic capacity of the existing drainage facilities would not be adversely affected by the development. The

applicant should submit calculation demonstrating the downstream drainage system receiving the discharge from the development has adequate spare capacity to accommodate the runoff. The applicant should advise the dimension of the existing downstream drainage system to be discharged at;

- (vii) the applicant should indicate clearly the full alignment of the discharge path from the Site all the way down to the ultimate discharge point (e.g. a well-established stream course/public drainage system);
- (viii) the existing drainage facilities, to which the stormwater of the development from the subject site would discharge, are not maintained by this office. The applicant should identify the owner of the existing drainage facilities to which the proposed connection will be made. Also, DSD noticed that the proposed drainage connection(s) to the surrounding/downstream area(s) will run through other private lot(s). The applicant shall demonstrate that the proposed drainage construction / improvement / modification works and the operation of the drainage can be practicably implemented;
- (ix) the applicant should indicate and advise what the discharge drainage facility is. The applicant should provide hydraulic calculations for the proposed discharging drainage facility demonstrating its capacity to cater for the surface runoff from the entire Site:
- (x) the applicant should clarify whether any walls or hoarding would be erected along the site boundary. Where walls or hoarding are erected/laid along the site boundary, adequate opening should be provided to intercept the existing overland flow passing through the Site;
- (xi) cross sections showing the existing and proposed ground levels of the Site with respect to the adjacent areas should be given;
- (xii) the development should neither obstruct overland flow nor adversely affect existing natural streams, village drains, ditches and the adjacent areas, etc.; and
- (xiii) the applicant shall resolve any conflict/disagreement with relevant lot owner(s) and seek LandsD's permission for laying new drains/channels and/or modifying/upgrading existing ones in other private lots or on Government land (where required) outside the Site;
- (f) to note the comments of the Director of Environmental Protection (DEP) that the applicant should follow the relevant mitigation measures and requirements in the latest 'Code of Practice on Handling Environmental Aspects of Temporary Uses and Open Storage Sites' issued by the Environmental Protection Department to minimise any potential environmental nuisances; and
- (g) to note the comments of the Chief Building Surveyor/New Territories West, Buildings Department (CBS/NTW, BD) that:
 - (i) the Site shall be provided with means of obtaining access thereto from a street and emergency vehicular access in accordance with Regulations 5 and 41D of the Building (Planning) Regulations [B(P)R] respectively;
 - (ii) the Site does not abut on a specified street of not less than 4.5m wide and its

- permitted development intensity shall be determined under Regulation 19(3) of the B(P)R at building plan submission stage;
- (iii) if the existing structure is erected on leased land without the approval of the BA, they are unauthorized building works (UBW) under the Buil;dings Ordinance (BO) and should not be designated for any proposed use under the captioned application;
- (iv) for UBW erected on leased land, enforcement action may be taken by the Buildings Department to effect their removal in accordance with the prevailing enforcement policy against UBW as and when necessary. The granting of any planning approval should not be construed as an acceptance of any existing building works or UBW on the Site under the BO;
- (vi) any temporary shelters or converted containers for office, storage, washroom or other uses are considered as temporary buildings are subject to the control of Part VII of the B(P)R; and
- (vii) detailed checking under the BO will be carried out at building plan submission stage.

□Urgent	□Return receipt	□Expand Group □Restricted □Prevent Copy □Confidential					
From: Sent:		2025-09-23 星期二 02:54:17					
To:	tpbpd/PLAND <tpbpd@pland.gov.hk></tpbpd@pland.gov.hk>						
Subject:		A/YL-PS/763 DD 122 Wing Ning Tsuen, Ping Shan CDA					

Dear TPB Members,

687 was approved 14 July 2023. Revoked 14 Jan 2025 for failure to fulfill Drainage conditions.

The current application does not provide any detail and assurance that this issue will be addressed and should be rejected.

Mary Mulvihill

From

To: tpbpd <tpbpd@pland.gov.hk>

Date: Monday, 19 June 2023 2:56 AM HKT

Subject: A/YL-PS/687 DD 122 Wing Ning Tsuen, Ping Shan CDA

Dear TPB Members,

Of course the 'logistics centre' was merely an excuse to get the first approval, conditions not fulfilled and back with the real operation:

Private Car Parking Spaces 10

Medium Goods Vehicle Parking Spaces 28

Coach Parking Spaces 22

This operation would have greater impact on local traffic than the 6 vehicles mentioned in 662. That the Applicant is Wing On Car Park should have been considered in the first place.

But then anyone familiar with the process knows that it is a game of smoke and mirrors.

Mary Mulvihill

From:

To: tpppq <tpppq@piang.gov.nk>

Date: Tuesday, 7 June 2022 2:52 AM CST

Subject: A/YL-PS/662 DD 122 Wing Ning Tsuen, Ping Shan CDA

A/YL-PS/662

Lots 688, 689 (Part), 690 (Part), 691 (Part), 692 (Part), 693 (Part), 694 (Part), 695 (Part), 756 (Part), 757 (Part), 758 (Part) and 947 (Part) in D.D. 122, Ping Shan

Site area: About 6,500sq.m

Zoning: "Comprehensive Development Area"

Applied use: Logistics Centre / 6 Vehicle Parking

□Urgent	☐Return receipt	□Expand Group	□Restricted	☐Prevent Copy	□Confidential

Dear TPB Members,

Under the new system of directing interested parties to the OZP website to find the history of approvals one has to waste hours clicking onto the many links to try and identify the correct predecessor.

The closest I can find in this instance is 617 that was withdrawn.

The objections to that are relevant and upheld.

Mary Mulvihill

From:

To: tpbpd <tpbpd@pland.gov.hk>

Date: Tuesday, 20 October 2020 3:25 AM CST

Subject: A/YL-PS/617 dd 122 Wing Ning Tsuen CDA

A/YL-PS/617

Lots 689 (Part), 690 (Part), 691 (Part), 692, 693, 694 (Part), 695 (Part), 697 (Part),

698 (Part), 946 (Part), 947 (Part) in D.D. 122, Wing Ning Tsuen, Ping Shan

Site area: About 9,400sq.m

Zoning: "Comprehensive Development Area"

Applied use: Open Storage of Construction Machinery / 2 Vehicle Parking

Dear TPB Members,

This site has been well and truly trashed. It is zoned CDA and therefore the intention is that it be part of a new community.

The public has been advised that plans are under way to redevelop Ping Shan. Members must inquire what is the intention for this area close to MTR.

There is no history of previous approval for the current operation so members are free to judge if the application intention will interfere with redevelopment plans.

Mary Mulvihill