

2025年 12月 8日

此文件在\_\_\_\_\_收到。城市規劃委員會  
只會在收到所有必要的資料及文件後才正式確認收到  
申請的日期。

- 8 DEC 2025

This document is received on \_\_\_\_\_  
The Town Planning Board will formally acknowledge  
the date of receipt of the application only upon receipt  
of all the required information and documents.

Form No. S16-III  
表格第 S16-III 號

**APPLICATION FOR PERMISSION  
UNDER SECTION 16 OF  
THE TOWN PLANNING ORDINANCE  
(CAP. 131)**

根據《城市規劃條例》(第131章)  
第16條遞交的許可申請

**Applicable to Proposal Only Involving Temporary Use/Development of Land  
and/or Building Not Exceeding 3 Years in Rural Areas or Regulated Areas,  
or Renewal of Permission for such Temporary Use or Development\***

**適用於祇涉及位於鄉郊地區或受規管地區土地上及/或建築物內進行  
為期不超過三年的臨時用途/發展或該等臨時用途/發展的許可續期的建議\***

\*Form No. S16-I should be used for other Temporary Use/Development of Land and/or Building (e.g. temporary use/developments in the Urban Area) and Renewal of Permission for such Temporary Use or Development.

\*其他土地上及/或建築物內的臨時用途/發展(例如位於市區內的臨時用途或發展)及有關該等臨時用途/發展的許可續期,應使用表格第S16-I號。

Applicant who would like to publish the notice of application in local newspapers to meet one of the Town Planning Board's requirements of taking reasonable steps to obtain consent of or give notification to the current land owner, please refer to the following link regarding publishing the notice in the designated newspapers:  
[https://www.tpb.gov.hk/en/plan\\_application/apply.html](https://www.tpb.gov.hk/en/plan_application/apply.html)

申請人如欲在本地報章刊登申請通知,以採取城市規劃委員會就取得現行土地擁有人的同意或通知現行土地擁有人所指定的其中一項合理步驟,請瀏覽以下網址有關在指定報章刊登通知:  
[https://www.tpb.gov.hk/te/plan\\_application/apply.html](https://www.tpb.gov.hk/te/plan_application/apply.html)

**General Note and Annotation for the Form**

**填寫表格的一般指引及註解**

\* "Current land owner" means any person whose name is registered in the Land Registry as that of an owner of the land to which the application relates, as at 6 weeks before the application is made

「現行土地擁有人」指在提出申請前六星期,其姓名或名稱已在土地註冊處註冊為該申請所關乎的土地的擁有人的人。

& Please attach documentary proof 請夾附證明文件

^ Please insert number where appropriate 請在適當地方註明編號

Please fill "NA" for inapplicable item 請在不適用的項目填寫「不適用」

Please use separate sheets if the space provided is insufficient 如所提供的空間不足,請另附說明

Please insert a "✓" at the appropriate box 請在適當的方格內加上「✓」號

2502666

24/11

By Hand

Form No. S16-III 表格第 S16-III 號

For Official Use Only 請勿填寫此欄	Application No. 申請編號	A/YL-LP/889
	Date Received 收表日期	- 8 DEC 2025 -

- The completed form and supporting documents (if any) should be sent to the Secretary, Town Planning Board (the Board), 15/F, North Point Government Offices, 333 Java Road, North Point, Hong Kong.  
申請人須把填妥的申請表格及其他支持申請的文件 (倘有), 送交香港北角渣華道 333 號北角政府合署 15 樓城市規劃委員會 (下稱「委員會」) 秘書處。
- Please read the "Guidance Notes" carefully before you fill in this form. The document can be downloaded from the Board's website at <http://www.info.gov.hk/tpb/>. It can also be obtained from the Secretariat of the Board at 15/F, North Point Government Offices, 333 Java Road, North Point, Hong Kong (Tel: 2231 4810 or 2231 4835), and the Planning Enquiry Counters of the Planning Department (Hotline: 2231 5000) (17/F, North Point Government Offices, 333 Java Road, North Point, Hong Kong and 14/F, Sha Tin Government Offices, 1 Sheung Wo Che Road, Sha Tin, New Territories).  
請先細閱《申請須知》的資料單張, 然後填寫此表格。該份文件可從委員會的網頁下載 (網址: <http://www.info.gov.hk/tpb/>)。亦可向委員會秘書處 (香港北角渣華道 333 號北角政府合署 15 樓 - 電話: 2231 4810 或 2231 4835) 及規劃署的規劃資料查詢處 (熱線: 2231 5000) (香港北角渣華道 333 號北角政府合署 17 樓及新界沙田上禾輦路 1 號沙田政府合署 14 樓) 索取。
- This form can be downloaded from the Board's website, and obtained from the Secretariat of the Board and the Planning Enquiry Counters of the Planning Department. The form should be typed or completed in block letters. The processing of the application may be refused if the required information or the required copies are incomplete.  
此表格可從委員會的網頁下載, 亦可向委員會秘書處及規劃署的規劃資料查詢處索取。申請人須以打印方式或以正楷填寫表格。如果申請人所提交的資料或文件副本不齊全, 委員會可拒絕處理有關申請。

### 1. Name of Applicant 申請人姓名/名稱

( Mr. 先生,  Ms. 夫人,  Miss 小姐,  Mrs. 女士,  Company 公司,  Organisation 機構)

KONG Chun Ying (江振英)

### 2. Name of Authorised Agent (if applicable) 獲授權代理人姓名/名稱 (如適用)

( Mr. 先生,  Ms. 夫人,  Mr. 先生,  Ms. 女士,  Company 公司,  Organisation 機構)

Metro Planning & Development Company Limited (都市規劃及發展顧問有限公司)

### 3. Application Site 申請地點

(a) Full address / location / demarcation district and lot number (if applicable)  
詳細地址 / 地點 / 坐落的地段 / 地段號碼 (如適用)

Lots 1684 (Part), 1685 (Part) & 1686 (Part) in D.D. 129, Lau Fau Shan, Yuen Long, N.T.

(b) Site area and/or gross floor area involved  
涉及的地盤面積及/或總樓面面積

Site area 地盤面積 ..... 1,048 ..... sq.m 平方米  About 約  
Not more than  
 Gross floor area 總樓面面積 ..... 420 ..... sq.m 平方米  About 約

(c) Area of Government land included (if any)  
所包括的政府土地面積 (倘有)

Nil ..... sq.m 平方米  About 約

(d) Name and number of the related statutory plan(s) 有關法定圖則的號碼及編號	Approved Lau Fau Shan & Tsim Bei Tsui Outline Zoning Plan No. S/YL-LFS/11
(c) Land use zone(s) involved 涉及的土地用途地帶	'Recreation' ('REC')
(f) Current use(s) 現時用途	Warehouse for storage  (If there are any Government, institution or community facilities, please illustrate on plan and specify the use and gross floor area) (如有任何政府、機構或社區設施，請在圖則上顯示，並註明用途及總樓面面積)

**4. "Current Land Owner" of Application Site 申請地點的「現行土地擁有人」**

The applicant 申請人 –

- is the sole "current land owner"<sup>106</sup> (please proceed to Part 6 and attach documentary proof of ownership).  
是唯一的「現行土地擁有人」<sup>106</sup> (請繼續填寫第 6 部分，並夾附業權證明文件)
- is one of the "current land owners"<sup>106</sup> (please attach documentary proof of ownership).  
是其中一名「現行土地擁有人」<sup>106</sup> (請夾附業權證明文件)
- is not a "current land owner"<sup>106</sup>.  
並不是「現行土地擁有人」<sup>106</sup>
- The application site is entirely on Government land (please proceed to Part 6).  
申請地點完全位於政府土地上 (請繼續填寫第 6 部分)

**5. Statement on Owner's Consent/Notification  
就土地擁有人的同意/通知土地擁有人的陳述**

(a) According to the record(s) of the Land Registry as at ..... (DD/MM/YYYY), this application involves a total of ..... "current land owner(s)"  
根據土地註冊處截至 ..... 年 ..... 月 ..... 日的記錄，這宗申請共牽涉 ..... 名「現行土地擁有人」<sup>107</sup>

(b) The applicant 申請人 –

- has obtained consent(s) of ..... "current land owner(s)"  
已取得 ..... 名「現行土地擁有人」<sup>107</sup> 的同意。

Details of consent of "current land owner(s)" obtained 取得「現行土地擁有人」 <sup>107</sup> 同意的詳情		
No. of "Current Land Owner(s)" 「現行土地擁有人」數目	Lot number/address of premises as shown in the record of the Land Registry where consent(s) has have been obtained 根據土地註冊處記錄已獲得同意地段號碼/處址/地帶	Date of consent obtained (DD/MM/YYYY) 取得同意的日期 (日/月/年)

(Please use separate sheets if the space of any box above is insufficient. 如上述任何表格的空間不足，請另頁說明)



<b>6. Type(s) of Application 申請類別</b>	
<b>(A) Temporary Use/Development of Land and/or Building Not Exceeding 3 Years in Rural Areas</b> 位於鄉郊地區土地上及/或建築物內進行為期不超過三年的臨時用途/發展 <b>(For Renewal of Permission for Temporary Use or Development in Rural Areas, please proceed to Part (B))</b> (如屬位於鄉郊地區臨時用途/發展的規劃許可續期, 請填寫(B)部分)	
(a) Proposed use(s)/development 擬議用途/發展	Temporary Warehouse (Excluding Dangerous Goods) for a Period of 3 Years  (Please illustrate the details of the proposal on a layout plan) (請於平面圖說明擬議詳情)
(b) Effective period of permission applied for 申請的許可有效期	<input checked="" type="checkbox"/> year(s) 年 ..... 3 <input type="checkbox"/> month(s) 個月 .....
(c) Development Schedule 發展細項表	
Proposed uncovered land area 擬議露天土地面積	628 ..... sq.m <input checked="" type="checkbox"/> About 約
Proposed covered land area 擬議有上蓋土地面積	420 ..... sq.m <input checked="" type="checkbox"/> About 約
Proposed number of buildings/structures 擬議建築物/構造物數目	2 .....
Proposed domestic floor area 擬議住用樓面面積	NA ..... sq.m <input checked="" type="checkbox"/> About 約
Proposed non-domestic floor area 擬議非住用樓面面積	Not more than 420 ..... sq.m <input type="checkbox"/> About 約
Proposed gross floor area 擬議總樓面面積	Not more than 420 ..... sq.m <input type="checkbox"/> About 約
Proposed height and use(s) of different floors of buildings/structures (if applicable) 建築物/構造物的擬議高度及不同樓層的擬議用途 (如適用) (Please use separate sheets if the space below is insufficient) (如以下空間不足, 請另頁說明)	
Structure 1 & 2. Warehouse (Not exceeding 6.5m, 1 storey) ..... ..... .....	
Proposed number of car parking spaces by types 不同種類停車位的擬議數目	
Private Car Parking Spaces 私家車車位	1 space of 5m x 2.5m
Motorecycle Parking Spaces 電單車車位	Nil
Light Goods Vehicle Parking Spaces 輕型貨車泊車位	Nil
Medium Goods Vehicle Parking Spaces 中型貨車泊車位	Nil
Heavy Goods Vehicle Parking Spaces 重型貨車泊車位	Nil
Others (Please Specify) 其他 (請列明)	NA
Proposed number of loading/unloading spaces 上落客貨車位的擬議數目	
Taxi Spaces 的士車位	Nil
Coach Spaces 旅遊巴士車位	Nil
Light Goods Vehicle Spaces 輕型貨車車位	1 space of 7m x 3.5m
Medium Goods Vehicle Spaces 中型貨車車位	Nil
Heavy Goods Vehicle Spaces 重型貨車車位	Nil
Others (Please Specify) 其他 (請列明)	NA

Proposed operating hours 擬議營業時間 9:00a.m. to 7:00p.m. from Mondays to Saturdays. No operation will be held on Sundays and public holidays.																															
(d) Any vehicular access to the site/subject building? 是否有車路通往地盤/有關建築物?	<p>Yes 是 <input checked="" type="checkbox"/> There is an existing access. (please indicate the street name, where appropriate) 有一條現有車路。(請註明車路名稱(如適用))</p> <p>Vehicular access leading from Deep Bay Road</p> <p>No 否 <input type="checkbox"/> There is a proposed access. (please illustrate on plan and specify the width) 有一條擬議車路。(請在圖則顯示,並註明車路的闊度)</p>																														
(e) Impacts of Development Proposal 擬議發展計劃的影響 (If necessary, please use separate sheets to indicate the proposed measures to minimise possible adverse impacts or give justifications/reasons for not providing such measures. 如需要的話,請另頁表示可盡量減少可能出現不良影響的措施,否則請提供理據理由。)																															
(i) Does the development proposal involve alteration of existing building? 擬議發展計劃是否包括現有建築物的改動?	<p>Yes 是 <input type="checkbox"/> Please provide details 請提供詳情</p> <p>No 否 <input checked="" type="checkbox"/></p>																														
(ii) Does the development proposal involve the operation on the right? 擬議發展是否涉及右列的工程?	<p>Yes 是 <input type="checkbox"/> Please indicate on site plan the boundary of concerned land/pond(s), and particulars of stream diversion, the extent of filling of land pond(s) and/or excavation of land 請在圖則上顯示有關土地/連理界線,以及河道改道、填塘、填土及/或挖土的細節及/或圖則</p> <p><input type="checkbox"/> Diversion of stream 河道改道</p> <p><input type="checkbox"/> Filling of pond 填塘 Area of filling 填塘面積 ..... sq.m 平方米 <input type="checkbox"/> About 約 Depth of filling 填塘深度 ..... m 米 <input type="checkbox"/> About 約</p> <p><input type="checkbox"/> Filling of land 填土 Area of filling 填土面積 ..... sq.m 平方米 <input type="checkbox"/> About 約 Depth of filling 填土厚度 ..... m 米 <input type="checkbox"/> About 約</p> <p><input type="checkbox"/> Excavation of land 挖土 Area of excavation 挖土面積 ..... sq.m 平方米 <input type="checkbox"/> About 約 Depth of excavation 挖土深度 ..... m 米 <input type="checkbox"/> About 約</p> <p>No 否 <input checked="" type="checkbox"/></p>																														
(iii) Would the development proposal cause any adverse impacts? 擬議發展計劃會否造成不良影響?	<table border="0"> <tr> <td>On environment 對環境</td> <td>Yes 會 <input type="checkbox"/></td> <td>No 不會 <input checked="" type="checkbox"/></td> </tr> <tr> <td>On traffic 對交通</td> <td>Yes 會 <input type="checkbox"/></td> <td>No 不會 <input checked="" type="checkbox"/></td> </tr> <tr> <td>On water supply 對供水</td> <td>Yes 會 <input type="checkbox"/></td> <td>No 不會 <input checked="" type="checkbox"/></td> </tr> <tr> <td>On drainage 對排水</td> <td>Yes 會 <input type="checkbox"/></td> <td>No 不會 <input checked="" type="checkbox"/></td> </tr> <tr> <td>On slopes 對斜坡</td> <td>Yes 會 <input type="checkbox"/></td> <td>No 不會 <input checked="" type="checkbox"/></td> </tr> <tr> <td>Affected by slopes 受斜坡影響</td> <td>Yes 會 <input type="checkbox"/></td> <td>No 不會 <input checked="" type="checkbox"/></td> </tr> <tr> <td>Landscape Impact 構成景觀影響</td> <td>Yes 會 <input type="checkbox"/></td> <td>No 不會 <input checked="" type="checkbox"/></td> </tr> <tr> <td>Tree Felling 砍伐樹木</td> <td>Yes 會 <input type="checkbox"/></td> <td>No 不會 <input checked="" type="checkbox"/></td> </tr> <tr> <td>Visual Impact 構成視覺影響</td> <td>Yes 會 <input type="checkbox"/></td> <td>No 不會 <input checked="" type="checkbox"/></td> </tr> <tr> <td>Others (Please Specify) 其他 (請列明)</td> <td>Yes 會 <input type="checkbox"/></td> <td>No 不會 <input checked="" type="checkbox"/></td> </tr> </table>	On environment 對環境	Yes 會 <input type="checkbox"/>	No 不會 <input checked="" type="checkbox"/>	On traffic 對交通	Yes 會 <input type="checkbox"/>	No 不會 <input checked="" type="checkbox"/>	On water supply 對供水	Yes 會 <input type="checkbox"/>	No 不會 <input checked="" type="checkbox"/>	On drainage 對排水	Yes 會 <input type="checkbox"/>	No 不會 <input checked="" type="checkbox"/>	On slopes 對斜坡	Yes 會 <input type="checkbox"/>	No 不會 <input checked="" type="checkbox"/>	Affected by slopes 受斜坡影響	Yes 會 <input type="checkbox"/>	No 不會 <input checked="" type="checkbox"/>	Landscape Impact 構成景觀影響	Yes 會 <input type="checkbox"/>	No 不會 <input checked="" type="checkbox"/>	Tree Felling 砍伐樹木	Yes 會 <input type="checkbox"/>	No 不會 <input checked="" type="checkbox"/>	Visual Impact 構成視覺影響	Yes 會 <input type="checkbox"/>	No 不會 <input checked="" type="checkbox"/>	Others (Please Specify) 其他 (請列明)	Yes 會 <input type="checkbox"/>	No 不會 <input checked="" type="checkbox"/>
On environment 對環境	Yes 會 <input type="checkbox"/>	No 不會 <input checked="" type="checkbox"/>																													
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Landscape Impact 構成景觀影響	Yes 會 <input type="checkbox"/>	No 不會 <input checked="" type="checkbox"/>																													
Tree Felling 砍伐樹木	Yes 會 <input type="checkbox"/>	No 不會 <input checked="" type="checkbox"/>																													
Visual Impact 構成視覺影響	Yes 會 <input type="checkbox"/>	No 不會 <input checked="" type="checkbox"/>																													
Others (Please Specify) 其他 (請列明)	Yes 會 <input type="checkbox"/>	No 不會 <input checked="" type="checkbox"/>																													

	<p>Please state measure(s) to minimise the impact(s). For tree felling, please state the number, diameter at breast height and species of the affected trees (if possible)</p> <p>請註明盡量減少影響的措施。如涉及砍伐樹木，請註明受影響樹木的數目、及胸高度的樹木種類(如適用)</p> <p>.....</p> <p>.....</p> <p>.....</p> <p>.....</p> <p>.....</p>
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**(B) Renewal of Permission for Temporary Use or Development in Rural Areas**  
 位於鄉郊地區臨時用途/發展的許可續期

(a) Application number to which the permission relates 與許可有關的申請編號	A/ _____ / _____
(b) Date of approval 獲批給許可的日期	..... (DD 日/MM 月/YYYY 年)
(c) Date of expiry 許可屆滿日期	..... (DD 日/MM 月/YYYY 年)
(d) Approved use/development 已批給許可的用途/發展	
(e) Approval conditions 附帶條件	<input type="checkbox"/> The permission does not have any approval condition 許可並沒有任何附帶條件 <input type="checkbox"/> Applicant has complied with all the approval conditions 申請人已遵守全部附帶條件 <input type="checkbox"/> Applicant has not yet complied with the following approval condition(s): 申請人仍未履行下列附帶條件： _____ _____ _____ _____ Reason(s) for non-compliance: 仍未遵守的原因： _____ _____ _____ _____ (Please use separate sheets if the space above is insufficient) (如以上空間不足，請另頁說明)
(f) Renewal period sought 要求的續期期間	<input type="checkbox"/> year(s) 年 ..... <input type="checkbox"/> month(s) 個月 .....

**7. Justifications 理由**

The applicant is invited to provide justifications in support of the application. Use separate sheets if necessary.  
現請申請人提供申請理由及支持其申請的資料。如有需要，請另紙說明。

1. The proposed development is a warehouse. It is intended to store non-dangerous goods such as tiles and packed food provision.

2. The scale of the development is small and similar to the approved planning permission No. A/YL-LFS/560 which was recently approved by Town Planning Board.

3. The proposed development does not involve fallen of trees

4. The proposed development is a temporary use for a period of 3 years which would not jeopardize the long term planning intention of the current zoning

5. The proposed development is not incompatible with the surrounding environment including warehouses to the immediate north which is approved by Town Planning Board.

6. Similar warehouses nearby such as A/YL-LFS/482 were granted with planning permission. Similar preferential treatment should be granted to the current application.

7. The proposed development would not be operated during sensitive hours (i.e. from 7:00p.m. to 9:00a.m.) next morning.

8. Minimal traffic impact.

9. No open storage and workshop activities will be carried out at the application site at all times.

10. Insignificant environmental and noise impacts because the applied use is housed within an enclosed structures and the static nature of the proposed development.

11. Insignificant drainage impact as proven in the submitted drainage proposal.

12. The application site is subject to a previous planning permission No. A/YL-LFS/442 approved for warehouse use. The applicant failed to comply with some of the approval conditions imposed to the last planning permission because there was a change of ownership of the application site so that there is uncertainty in investing to the site. In view of that the uncertainty was gone, the applicant would comply with the planning conditions to be imposed to the current application should Town Planning Board sees fit.

**8. Declaration 聲明**

I hereby declare that the particulars given in this application are correct and true to the best of my knowledge and belief.  
本人謹此聲明，本人就這宗申請提交的資料，據本人所知及所信，均屬真實無誤。

I hereby grant a permission to the Board to copy all the materials submitted in this application and/or to upload such materials to the Board's website for browsing and downloading by the public free-of-charge at the Board's discretion.  
本人現准許委員會酌情將本人就此申請所提交的所有資料複製及/或上載至委員會網站，供公眾免費瀏覽或下載。

Signature  
簽署

Patrick Tsui

Name in Block Letters  
姓名（請以正楷填寫）



Applicant 申請人 /  Authorised Agent 獲授權代理人

Consultant

Position (if applicable)  
職位（如適用）

Professional Qualification(s)  Member 會員 /  Fellow of 資深會員

專業資格

- HKIP 香港規劃師學會 /  HKIA 香港建築師學會 /  
 HKIS 香港測量師學會 /  HKIE 香港工程師學會 /  
 HKILA 香港園境師學會 /  HKIUD 香港城市設計學會  
 RPP 註冊專業規劃師  
 Others 其他 .....

on behalf of Metro Planning & Development Company Limited (都市規劃及發展顧問有限公司)  
代表

Company 公司 /  Organisation Name and Chop (if applicable) 機構名稱及蓋章（如適用）

Date 日期

24/11/2025

(DD/MM/YYYY 日/月/年)

**Remark 備註**

The materials submitted in this application and the Board's decision on the application would be disclosed to the public. Such materials would also be uploaded to the Board's website for browsing and free downloading by the public where the Board considers appropriate.

委員會會向公眾披露申請人所遞交的申請資料和委員會對申請所作的決定，在委員會認為合適的情況下，有關申請資料亦會上載至委員會網頁供公眾免費瀏覽及下載。

**Warning 警告**

Any person who knowingly or wilfully makes any statement or furnish any information in connection with this application, which is false in any material particular, shall be liable to an offence under the Crimes Ordinance.  
任何人在明知或故意的情況下，就這宗申請提出在任何要項上是虛假的陳述或資料，即屬違反《刑事罪行條例》。

**Statement on Personal Data 個人資料的聲明**

- The personal data submitted to the Board in this application will be used by the Secretary of the Board and Government departments for the following purposes:  
委員會就這宗申請所收到的個人資料會交給委員會秘書及政府部門，以根據《城市規劃條例》及相關的城市規劃委員會規劃指引的規定作以下用途：  
 (a) the processing of this application which includes making available the name of the applicant for public inspection when making available this application for public inspection and  
處理這宗申請，包括公布這宗申請供公眾查閱，同時公布申請人的姓名供公眾查閱；以及  
 (b) facilitating communication between the applicant and the Secretary of the Board/Government departments.  
方便申請人與委員會秘書及政府部門之間進行聯席。
- The personal data provided by the applicant in this application may also be disclosed to other persons for the purposes mentioned in paragraph 1 above.  
申請人就這宗申請提供的個人資料，或亦會向其他人士披露，以作上述第 1 段提及的用途。
- An applicant has a right of access and correction with respect to his/her personal data as provided under the Personal Data (Privacy) Ordinance (Cap. 486). Request for personal data access and correction should be addressed to the Secretary of the Board at 15/F, North Point Government Offices, 333 Java Road, North Point, Hong Kong.  
根據《個人資料(私隱)條例》(第 486 章)規定，申請人有權向有關政府部門查詢、索取、閱覽及更正個人資料，應向委員會秘書提出有關要求。其地址為香港北角海旁道 333 號北角政府綜合大樓。

<b>Gist of Application 申請摘要</b>	
<p>(Please provide details in both English and Chinese as far as possible. This part will be circulated to relevant consultees, uploaded to the Town Planning Board's Website for browsing and free downloading by the public and deposited at the Planning Enquiry Counters of the Planning Department for general information.)            (請盡量以英文及中文填寫。此資料將會與送予相關諮詢人士、上載至城市規劃委員會網頁供公眾免費瀏覽及下載及存放於規劃署規劃資料查詢處以供一般參閱。)</p>	
Application No. 申請編號	(For Official Use Only) (請勿填寫此欄)
Location/address 位置/地址	Lots 1684 (Part), 1685 (Part) & 1686 (Part) in D.D. 129, Lau Fau Shan, Yuen Long, N.T.
Site area 地盤面積	1,048 sq. m 平方米 <input checked="" type="checkbox"/> About 約 (includes Government land of 包括政府土地 Nil sq. m 平方米 <input type="checkbox"/> About 約)
Plan 圖則	Approved Lau Fau Shan & Tsim Bei Tsui Outline Zoning Plan No. S/YL-LFS/11
Zoning 地帶	"Recreation" ("RE")
Type of Application 申請類別	<input checked="" type="checkbox"/> Temporary Use/Development in Rural Areas for a Period of 位於鄉郊地區的臨時用途/發展為期 <input checked="" type="checkbox"/> Year(s) 年 3 <input type="checkbox"/> Month(s) 月 _____ <input type="checkbox"/> Renewal of Planning Approval for Temporary Use/Development in Rural Areas for a Period of 位於鄉郊地區臨時用途/發展的規劃許可續期為期 <input type="checkbox"/> Year(s) 年 _____ <input type="checkbox"/> Month(s) 月 _____
Applied use/ development 申請用途/發展	Temporary Warehouse (Excluding Dangerous Goods) for a Period of 3 Years

(i) Gross floor area and/or plot ratio 總樓面面積及／或地積比率		sq.m 平方米	Plot Ratio 地積比率
	Domestic 住用	NA <input type="checkbox"/> About 約 <input type="checkbox"/> Not more than 不多於	NA <input type="checkbox"/> About 約 <input type="checkbox"/> Not more than 不多於
	Non-domestic 非住用	420 <input type="checkbox"/> About 約 <input checked="" type="checkbox"/> Not more than 不多於	0.4 <input checked="" type="checkbox"/> About 約 <input type="checkbox"/> Not more than 不多於
(ii) No. of block 幢數	Domestic 住用	NA	
	Non-domestic 非住用	2	
(iii) Building height/No. of storeys 建築物高度／層數	Domestic 住用	NA	m 米 <input type="checkbox"/> (Not more than 不多於)
		NA	Storeys(s) 層 <input type="checkbox"/> (Not more than 不多於)
	Non-domestic 非住用	6.5	m 米 <input checked="" type="checkbox"/> (Not more than 不多於)
		1	Storeys(s) 層 <input type="checkbox"/> (Not more than 不多於)
(iv) Site coverage 上蓋面積	40.07%		<input checked="" type="checkbox"/> About 約
(v) No. of parking spaces and loading / unloading spaces 停車位及上落客貨 車位數目	Total no. of vehicle parking spaces 停車位總數		1
	Private Car Parking Spaces 私家車車位		1
Motorcycle Parking Spaces 電單車車位		0	
Light Goods Vehicle Parking Spaces 輕型貨車泊車位		0	
Medium Goods Vehicle Parking Spaces 中型貨車泊車位		0	
Heavy Goods Vehicle Parking Spaces 重型貨車泊車位		0	
Others (Please Specify) 其他 (請列明)			
NA			
Total no. of vehicle loading/unloading bays/lay-bys 上落客貨車位／停車處總數		1	
Taxi Spaces 的士車位		0	
Coach Spaces 旅遊巴車位		0	
Light Goods Vehicle Spaces 輕型貨車車位		1	
Medium Goods Vehicle Spaces 中型貨車位		0	
Heavy Goods Vehicle Spaces 重型貨車車位		0	
Others (Please Specify) 其他 (請列明)			
NA			

Submitted Plans, Drawings and Documents 提交的圖則、繪圖及文件		
	<u>Chinese</u> 中文	<u>English</u> 英文
<b><u>Plans and Drawings 圖則及繪圖</u></b>		
Master layout plan(s)/Layout plan(s) 總綱發展藍圖／布局設計圖	<input type="checkbox"/>	<input checked="" type="checkbox"/>
Block plan(s) 樓宇位置圖	<input type="checkbox"/>	<input type="checkbox"/>
Floor plan(s) 樓宇平面圖	<input type="checkbox"/>	<input type="checkbox"/>
Sectional plan(s) 截視圖	<input type="checkbox"/>	<input type="checkbox"/>
Elevation(s) 立視圖	<input type="checkbox"/>	<input type="checkbox"/>
Photomontage(s) showing the proposed development 顯示擬議發展的合成照片	<input type="checkbox"/>	<input type="checkbox"/>
Master landscape plan(s)/Landscape plan(s) 園境設計總圖／園境設計圖	<input type="checkbox"/>	<input type="checkbox"/>
Others (please specify) 其他（請註明）	<input type="checkbox"/>	<input checked="" type="checkbox"/>
<u>Proposed drainage plan, site plan and location plan</u>		
<u>Fire Services Installation Plan</u>		
<b><u>Reports 報告書</u></b>		
Planning Statement/Justifications 規劃綱領/理據	<input type="checkbox"/>	<input type="checkbox"/>
Environmental assessment (noise, air and/or water pollutions) 環境評估（噪音、空氣及／或水的污染）	<input type="checkbox"/>	<input type="checkbox"/>
Traffic impact assessment (on vehicles) 就車輛的交通影響評估	<input type="checkbox"/>	<input type="checkbox"/>
Traffic impact assessment (on pedestrians) 就行人的交通影響評估	<input type="checkbox"/>	<input type="checkbox"/>
Visual impact assessment 視覺影響評估	<input type="checkbox"/>	<input type="checkbox"/>
Landscape impact assessment 景觀影響評估	<input type="checkbox"/>	<input type="checkbox"/>
Tree Survey 樹木調查	<input type="checkbox"/>	<input type="checkbox"/>
Geotechnical impact assessment 土力影響評估	<input type="checkbox"/>	<input type="checkbox"/>
Drainage impact assessment 排水影響評估	<input type="checkbox"/>	<input type="checkbox"/>
Sewerage impact assessment 排污影響評估	<input type="checkbox"/>	<input type="checkbox"/>
Risk Assessment 風險評估	<input type="checkbox"/>	<input type="checkbox"/>
Others (please specify) 其他（請註明）	<input type="checkbox"/>	<input checked="" type="checkbox"/>
<u>Drainage proposal and estimated traffic generation</u>		
<hr/>		
Note: May insert more than one 「✓」. 註：可在多於一個方格內加上「✓」號		

Note: The information in the Gist of Application above is provided by the applicant for easy reference of the general public. Under no circumstances will the Town Planning Board accept any liabilities for the use of the information nor any inaccuracies or discrepancies of the information provided. In case of doubt, reference should always be made to the submission of the applicant.

註：上述申請摘要的資料是由申請人提供以方便市民大眾參考。對於所載資料在使用上的問題及文義上的歧異，城市規劃委員會概不負責。若有任何疑問，應查閱申請人提交的文件。

## Temporary Warehouse (Excluding Dangerous Goods) for a Period of 3 Years

at

**Lots 1684 (Part), 1685 (Part) & 1686 (Part) in D.D. 129, Lau Fau Shan, Yuen Long, N.T.**

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### Annex 1 Drainage Assessment

#### A. Site particulars

- 1.1.1 The site possesses an area of about 1,048m<sup>2</sup>. The surface of the site has been hard paved.
- 1.1.2 The application site will be occupied by a warehouse for storage of non-dangerous goods.

#### B. Level and gradient of the subject site & proposed surface channel

- 1.1.3 The subject site has been hard paved and occupied an area of approximately 1,048m<sup>2</sup>. It has a gradient sloping from north to south from about +14.8mPD to +14.0mPD.
- 1.1.4 In order to follow the topography of the application site, the proposed surface channel will be constructed following the gradient of the site. As demonstrated in the calculation in **Annex 1.3** hereunder, 450mm surface U-channel will be capable to drain surface runoff accrued at the subject site and the same passing through the site from adjacent area.

#### C. Catchment area of the proposed drainage provision at the subject site

- 1.1.5 With regard to the location of the existing drain and the topography surrounding the application site, the land to the south of the site is found higher than the application site. The land to the south, west and east of the site is found lower than the application site or about the same as the level of the application site (**Figure 4**). The land to the south is occupied by a warehouse approved by Town Planning Board (TPB Ref.: A/YL-LFS/457) of which drainage facilities has been provided.
- 1.1.6 As such, an external catchment is identified has been identified in **Figure 4**.

#### D. Particulars of the existing drainage facilities to accept the surface runoff collected at the application site

- 1.1.7 There is an existing natural drain to the north of the application site. The said existing drainage dissipates the surface runoff to Deep Bay.

## 1.2 Runoff Estimation & Proposed Drainage Facilities

### A. Proposed drainage facilities

- 1.2.1 Subject to the above calculations, it is determined that 450mm surface U-channel which is made of concrete along the site periphery is adequate to intercept storm water passing through and generated at the application site (**Figure 4**).
- 1.2.2 The collected surface runoff will be conveyed to existing open drain to the north of the site. (**Figure 4**)
- 1.2.3 All the proposed drainage facilities, including the section of surface channel proposed in between of the subject site to the open drain, will be provided and maintained at the applicant's own expense. Also, sand trap and U-channel will be cleaned at regular interval to avoid the accumulation of rubbish/debris which would affect the dissipation of storm water.
- 1.2.4 The provision of the proposed surface U-channel will follow the gradient of the application site. All the proposed drainage facilities will be constructed and maintained at the expense of the applicant.
- 1.2.5 All proposed works at the site periphery would not obstruct the flow of surface runoff from the adjacent areas, the provision of surface U-channel at site boundary is detailed hereunder:
  - (a) No leveling work will be carried at the site periphery. The level of the site periphery will be maintained during and after the works. As such, the works at the site periphery would not either alter or obstructed the flow of surface runoff from adjacent areas.
  - (b) 100mm openings will be provided at the toe of hoarding so as to allow unobstructed flow of surface runoff from adjacent area.
- 1.2.6 The applicant is conscientious in preparing this drainage proposal. Also, he is willing to provide necessary drainage facilities to minimize the drainage impact accrued by the proposed development. The acceptance of this drainage proposal will give positive recognition to the applicant's efforts.

### Annex 1.3 Drainage Calculation for the Proposed Provision of Drainage Facilities at Subject Site

#### 1. Runoff Estimation

1.1 Rational method is adopted for estimating the designed run-off

$$Q = k \times i \times A / 3,600$$

Assuming that:

- i. The area of the entire catchment is approximately 2,700m<sup>2</sup>; (**Figure 4**)
- ii. The catchment is predominant paved, it is assumed that the value of run-off co-efficient (k) is taken as 1.

$$\text{Difference in Land Datum} = 38.6\text{m} - 14.0\text{m} = 24.6\text{m}$$

$$L = 106\text{m}$$

$$\therefore \text{Average fall} = 24.6\text{m in } 106\text{m} \text{ or } 1\text{m in } 4.31\text{m}$$

According to the Brandsby-Williams Equation adopted from the “Stormwater Drainage Manual – Planning, Design and Management” published by the Drainage Services Department (DSD),

$$\text{Time of Concentration } (t_c) = 0.14465 [ L / (H^{0.2} \times A^{0.1}) ]$$

$$t_c = 0.14465 [ 106 / (23.21^{0.2} \times 2,700^{0.1}) ]$$

$$t_c = 3.71 \text{ minutes}$$

With reference to the Intensity-Duration-Frequency Curves provided in the abovementioned manual, the mean rainfall intensity (i) for 1 in 50 recurrent flooding period is found to be 300 mm/hr

$$\text{By Rational Method, } Q = 1 \times 300 \times 2,700 / 3,600$$

$$\therefore Q = 225 \text{ l/s} = 13,500 \text{ l/min}$$

In accordance with the Chart or the Rapid Design of Channels in “Geotechnical Manual for Slopes”, for an approximate gradient of about 1:50 and 1:160 along the site periphery of the site, 450mm surface U-channel is considered adequate to dissipate all the stormwater accrued by the application site and the adjacent land.

## Annex 2 Estimated Traffic Generation

- 2.1 The ingress/egress of the application site is abutting a local vehicular track leading to Deep Bay Road. (Figure 4)
- 2.2 Only 5.5 tonnes light goods vehicle is required to deliver non-dangerous goods to and from the application site.
- 2.3 The average and peak trip rates generated from and attracted to the site are shown below.


Type of vehicle	Average Traffic Generation Rate (pcu/hr)	Average Traffic Attraction Rate (pcu/hr)	Traffic Generation Rate at Peak Hours (pcu/hr)	Traffic Attraction Rate at Peak Hours (pcu/hr)
Light goods vehicle	0.3	0.3	0	0
Private car	0.2	0.2	1	1
Total	0.5	0.5	1	1

Note 1: The opening hour of the proposed development is restricted to 9:00 a.m. to 7:00 p.m. from Mondays to Saturdays. No operation will be held on Sundays and public holidays.


Note 2: The pcu of private car and light goods vehicle is taken as 1 and 1.5 respectively; and

Note 3: Morning peak is defined as 7:00a.m. to 9:00a.m. whereas afternoon peak is defined as 5:00p.m. to 7:00p.m.

- 2.4 In association with the proposed use, adequate space for manoeuvring and loading/unloading are available within the application site. By virtue of the fact that the application site is directly linked with Yuen Long Highway via Deep Bay Road and Lau Fau Shan Road and the traffic generated by the proposed development is insignificant, the proposed development being applied would not aggravate the traffic condition even though Deep Bay Road is not wide enough for 2 ways traffic. Similar warehouse has also been approved by Town Planning Board recently such as A/YL-LFS/560.

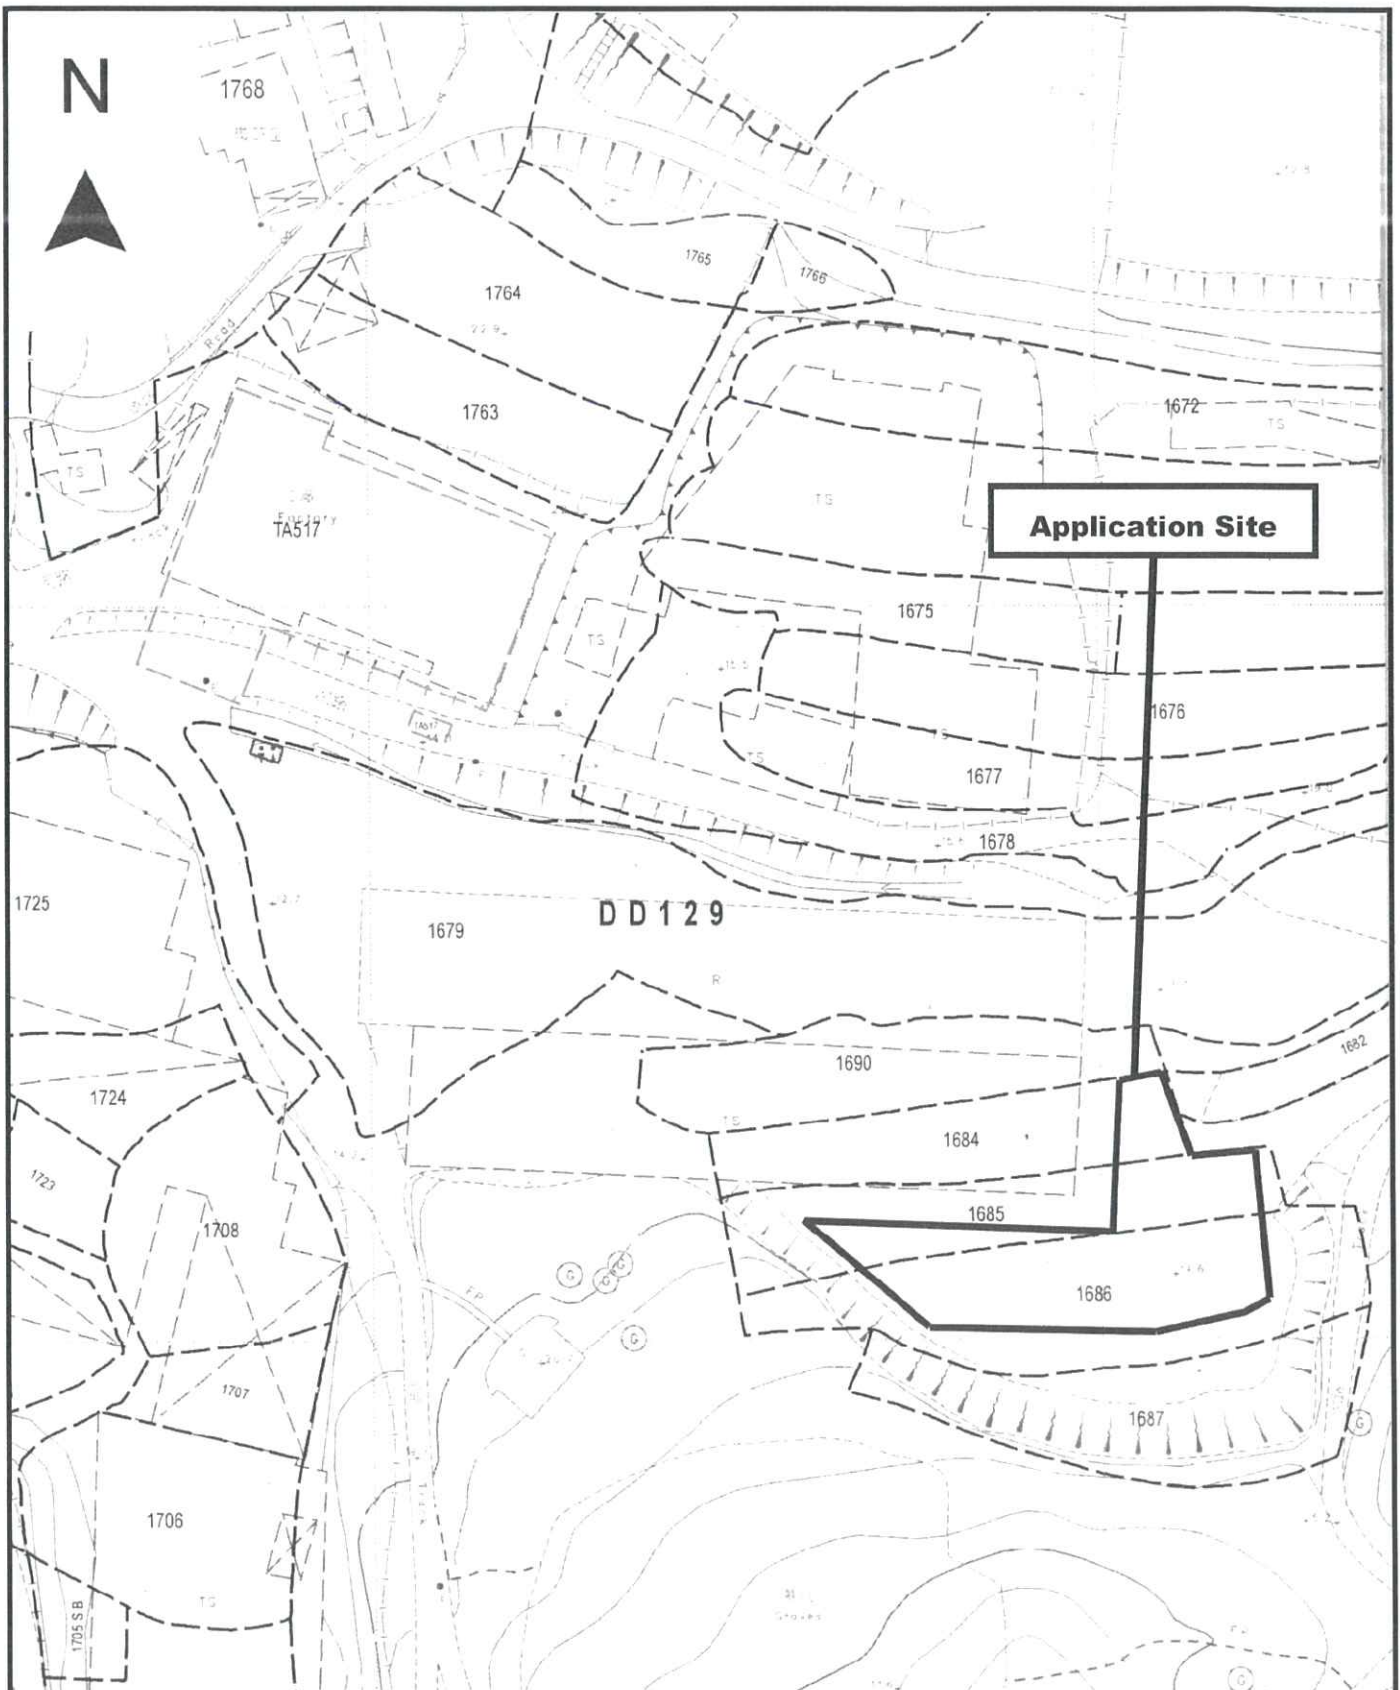

<p>Project 項目名稱:  <b>Temporary Warehouse (Excluding Dangerous Goods) for a Period of 3 Years at Lots 1684 (Part), 1685 (Part) &amp; 1686 (Part) in D.D. 129, Lau Fau Shan, Yuen Long, N.T.</b></p>	<p>Drawing Title 圖日:  <b>Application Site</b></p>	<p>Remarks 備註:</p>
	<p>Drawing No. 圖號:  <b>Figure 1</b></p>	<p>Scale 比例:  <b>1:1000</b></p>

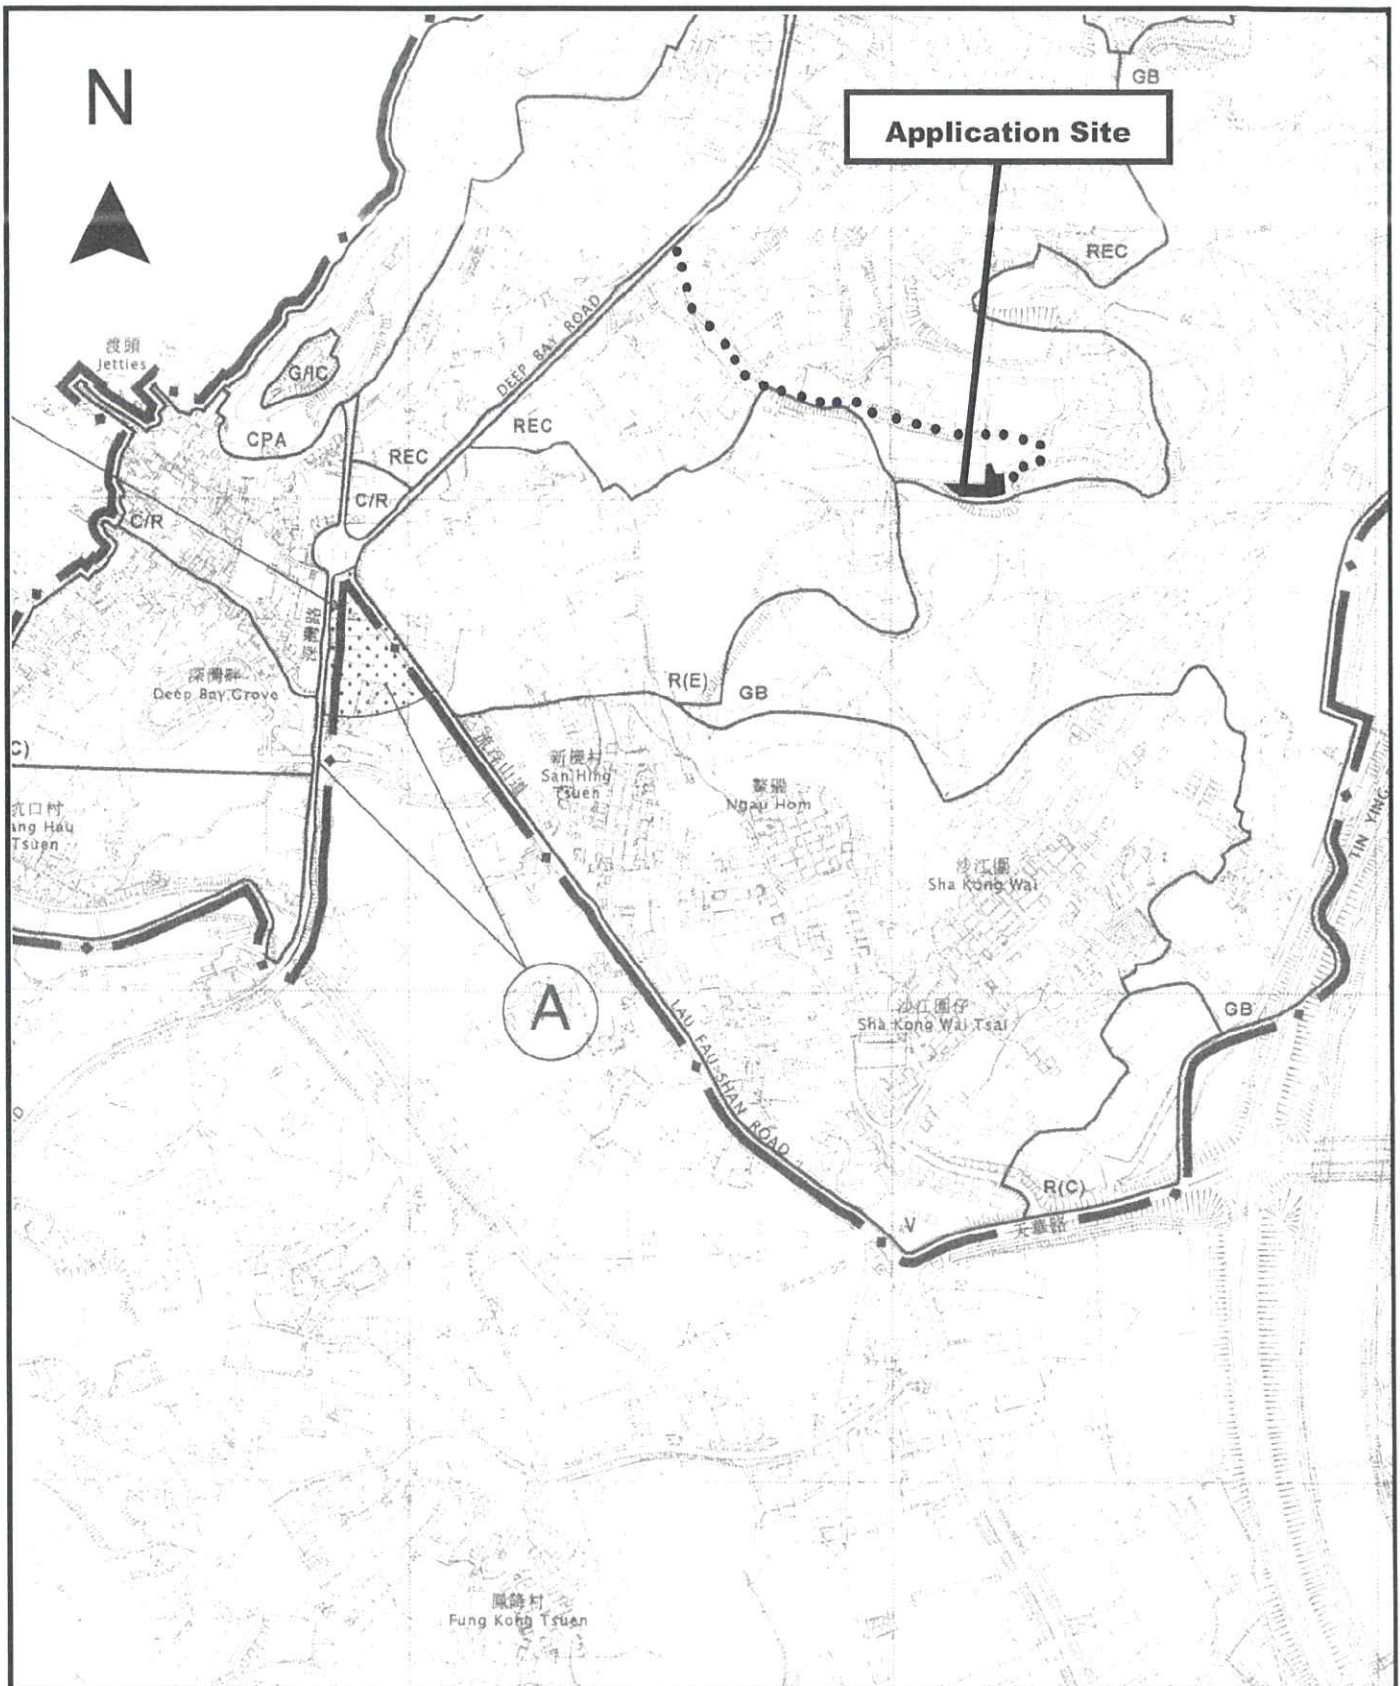

Project 項目名稱:

Temporary Warehouse (Excluding Dangerous Goods) for a Period of 3 Years at Lots 1684 (Part), 1685 (Part) & 1686 (Part) in D.D. 129, Lau Fau Shan, Yuen Long, N.T.

Drawing Title 圖目:

Location Plan

Remarks 備註:

••• Vehicular access leading from Deep Bay Road


Drawing No. 圖號:

Figure 2

Scale 比例:

1:7500

N

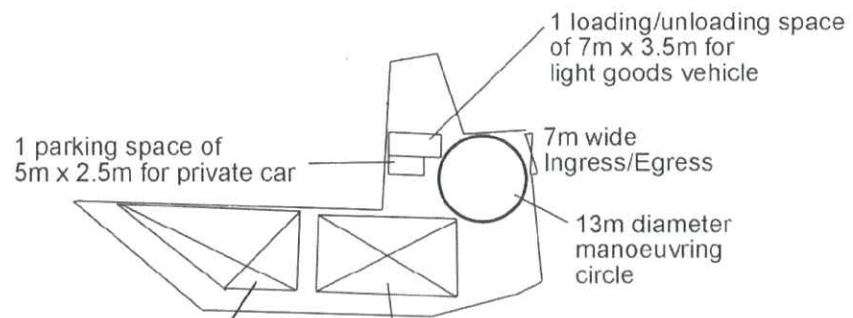

**Structure 1**  
Warehouse for storage of non-dangerous goods  
GFA: Not exceeding 210m<sup>2</sup>  
Height: Not exceeding 6.5m  
No. of storey: 1

**Structure 2**  
Warehouse for storage of non-dangerous goods  
GFA: Not exceeding 210m<sup>2</sup>  
Height: Not exceeding 6.5m  
No. of storey: 1

Project 項目名稱:

Temporary Warehouse (Excluding Dangerous Goods) for a Period of 3 Years at Lots 1684 (Part), 1685 (Part) & 1686 (Part) in D.D. 129, Lau Fau Shan, Yuen Long, N.T.

Drawing Title 圖日:

Proposed Layout Plan


Remarks 備註:

Drawing No. 圖號:

Figure 3

Scale 比例:

1:1000

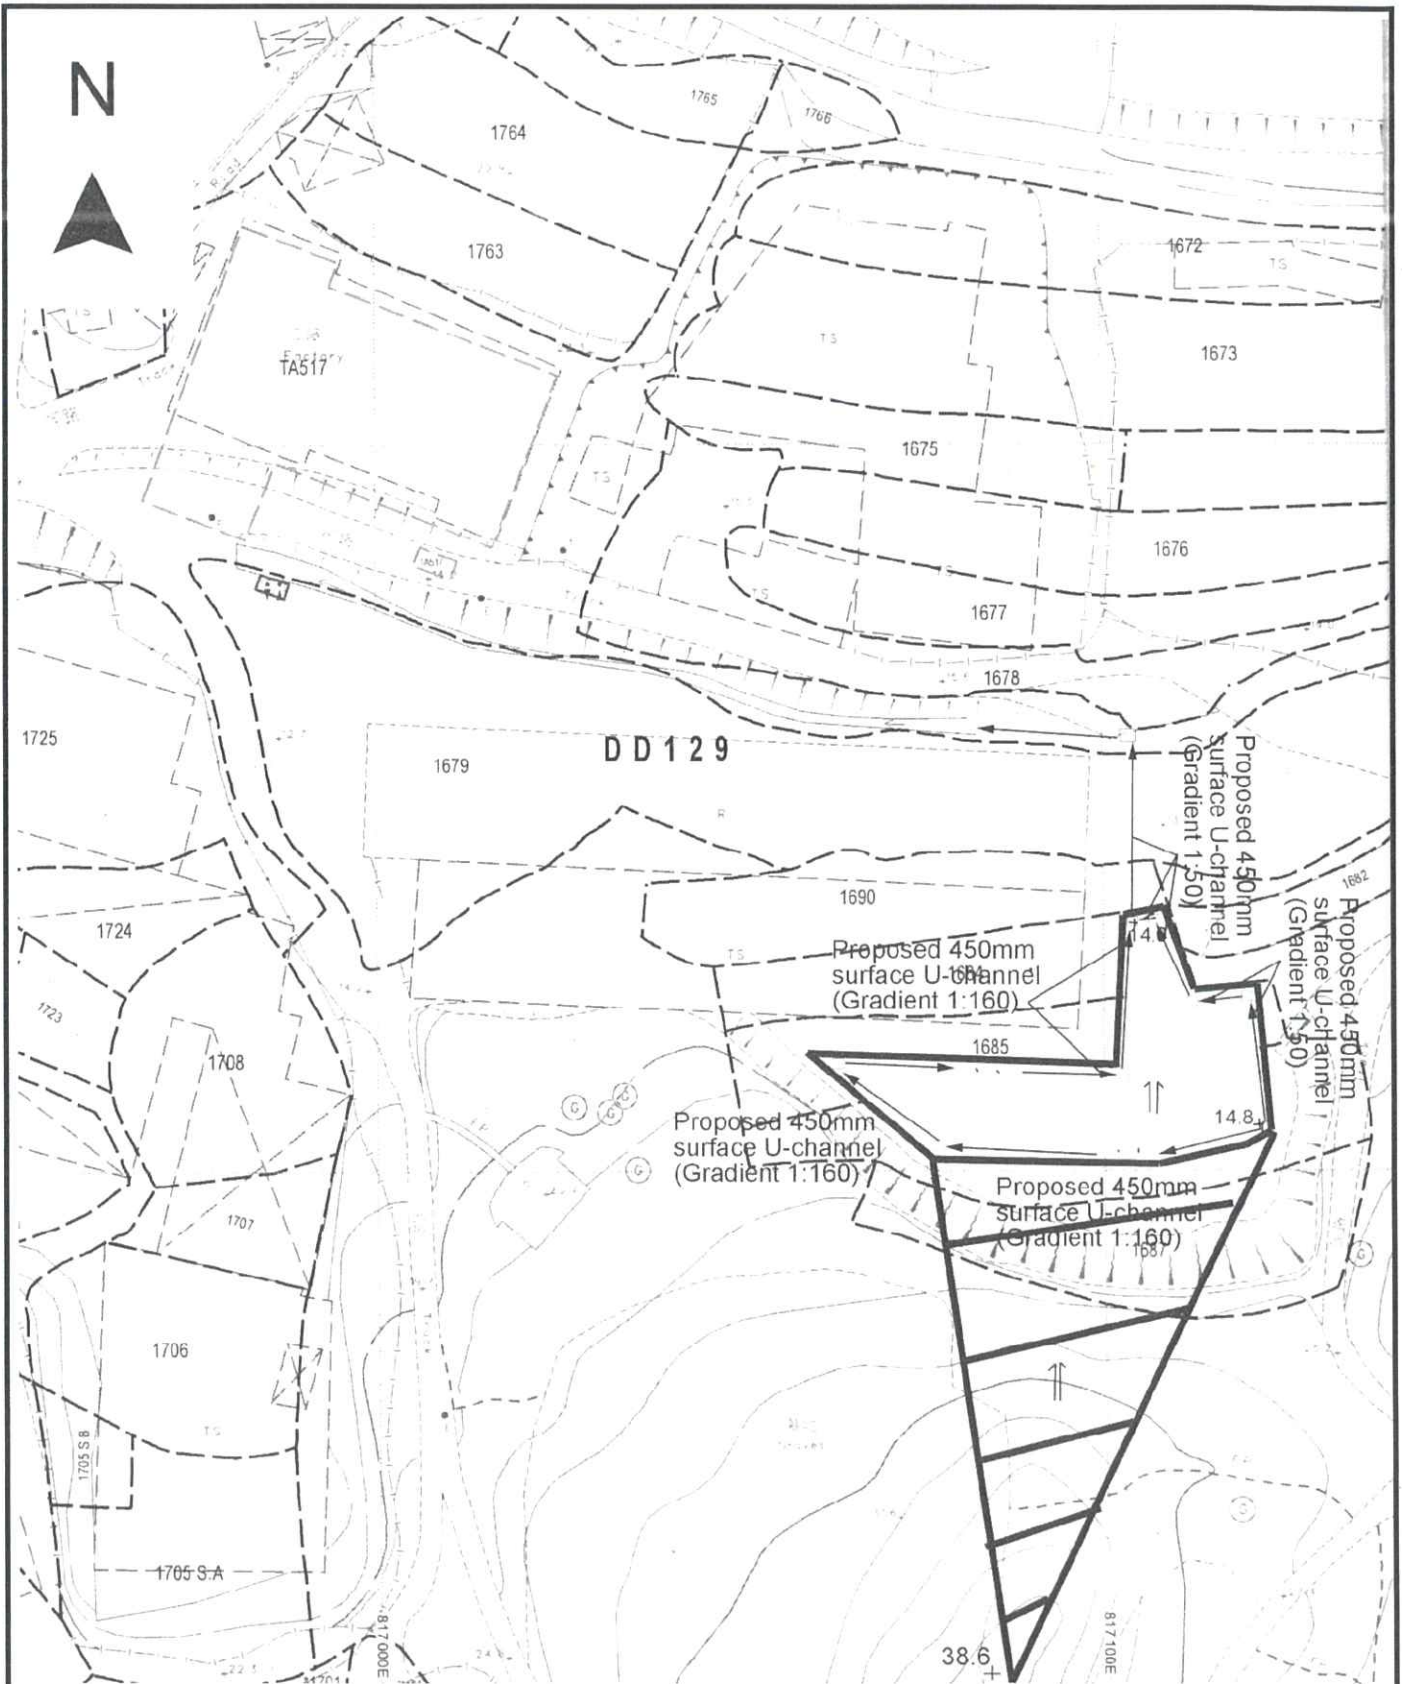

Project 項目名稱:

Temporary Warehouse (Excluding Dangerous Goods) for a Period of 3 Years at Lots 1684 (Part), 1685 (Part) & 1686 (Part) in D.D. 129, Lau Fau Shan, Yuen Long, N.T.

Drawing Title 圖日:

Proposed Drainage Plan

Drawing No. 圖號:

Figure 4


Remarks 備註:

- Proposed catchpit
- +14.0 Level (mPD)
- ← Flow of Surface Runoff
- ▨ External catchment

Scale 比例:

1:1000

N

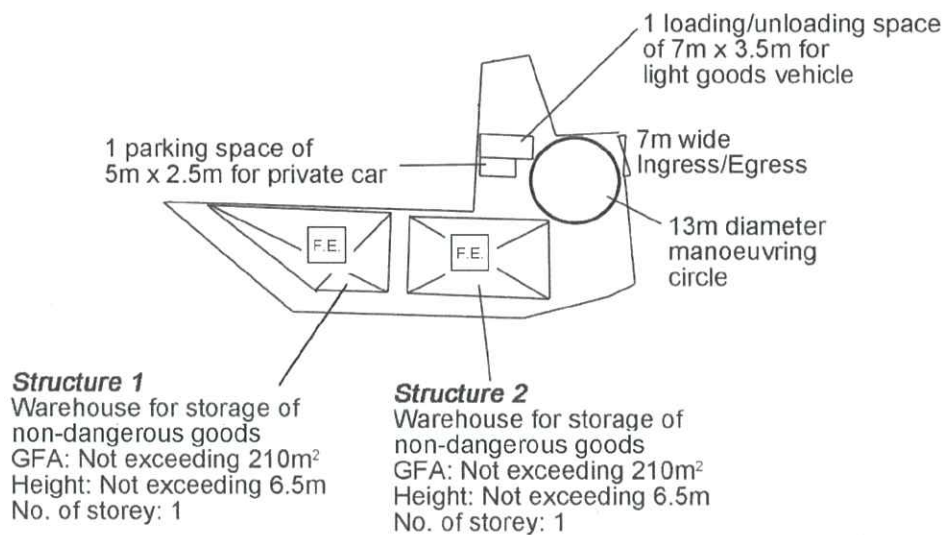

Project 項目名稱: Temporary Warehouse (Excluding Dangerous Goods) for a Period of 3 Years at Lots 1684 (Part), 1685 (Part) & 1686 (Part) in D.D. 129, Lau Fau Shan, Yuen Long, N.T.	Drawing Title 圖目: Proposed Fire Service Installations Plan	Remarks 備註: <input type="checkbox"/> 5kg carbon dioxide fire extinguisher
	Drawing No. 圖號: Figure 5	Scale 比例: 1:1000

Urgent Return receipt Expand Group Restricted Prevent Copy Confidential

**Christina Ki Na LEE/PLAND**

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寄件者: king king  
寄件日期: 2025年12月12日星期五 15:34  
收件者: tpbpd/PLAND  
副本: Christina Ki Na LEE/PLAND; Belva Yuen King TONG/PLAND  
主旨: A/YL-LFS/589  
附件: 組合 2.pdf

類別: Internet Email

Dear Sir,

We have updated the applied use in the attachment. Thank you.

Best Regards,

Patrick Tsui

<b>6. Type(s) of Application 申請類別</b>	
<b>(A) Temporary Use/Development of Land and/or Building Not Exceeding 3 Years in Rural Areas</b> 位於鄉郊地區土地上及/或建築物內進行為期不超過三年的臨時用途/發展 <b>(For Renewal of Permission for Temporary Use or Development in Rural Areas, please proceed to Part (B))</b> (如屬位於鄉郊地區臨時用途/發展的規劃許可續期，請填寫(B)部分)	
(a) Proposed use(s)/development 擬議用途/發展	Temporary Warehouse (Excluding Dangerous Goods Godown) for a Period of 3 Years  (Please illustrate the details of the proposal on a layout plan) (請用平面圖說明擬議詳情)
(b) Effective period of permission applied for 申請的許可有效期	<input checked="" type="checkbox"/> year(s) 年 ..... 3 ..... <input type="checkbox"/> month(s) 個月 .....
<b>(c) Development Schedule 發展細節表</b>	
Proposed uncovered land area 擬議露天土地面積	628 .....sq.m <input checked="" type="checkbox"/> About 約
Proposed covered land area 擬議有上蓋土地面積	420 .....sq.m <input checked="" type="checkbox"/> About 約
Proposed number of buildings/structures 擬議建築物/構築物數目	2 .....
Proposed domestic floor area 擬議住用樓面面積	NA .....sq.m <input checked="" type="checkbox"/> About 約
Proposed non-domestic floor area 擬議非住用樓面面積	Not more than 420 .....sq.m <input type="checkbox"/> About 約
Proposed gross floor area 擬議總樓面面積	Not more than 420 .....sq.m <input type="checkbox"/> About 約
Proposed height and use(s) of different floors of buildings/structures (if applicable) 建築物/構築物的擬議高度及不同樓層的擬議用途 (如適用) (Please use separate sheets if the space below is insufficient) (如以下空間不足，請另頁說明)	
Structure 1 & 2: Warehouse (Not exceeding 6.5m, 1 storey) ..... ..... .....	
Proposed number of car parking spaces by types 不同種類停車位的擬議數目	
Private Car Parking Spaces 私家車車位	1 space of 5m x 2.5m
Motorcycle Parking Spaces 電單車車位	Nil
Light Goods Vehicle Parking Spaces 輕型貨車泊車位	Nil
Medium Goods Vehicle Parking Spaces 中型貨車泊車位	Nil
Heavy Goods Vehicle Parking Spaces 重型貨車泊車位	Nil
Others (Please Specify) 其他 (請列明)	NA
Proposed number of loading/unloading spaces 上落客貨車位的擬議數目	
Taxi Spaces 的士車位	Nil
Coach Spaces 旅遊巴車位	Nil
Light Goods Vehicle Spaces 輕型貨車車位	1 space of 7m x 3.5m
Medium Goods Vehicle Spaces 中型貨車車位	Nil
Heavy Goods Vehicle Spaces 重型貨車車位	Nil
Others (Please Specify) 其他 (請列明)	NA

<b>Gist of Application 申請摘要</b>	
(Please provide details in both English and Chinese <u>as far as possible</u> . This part will be circulated to relevant consultees, uploaded to the Town Planning Board's Website for browsing and free downloading by the public and deposited at the Planning Enquiry Counters of the Planning Department for general information.) (請盡量以英文及中文填寫。此部分將會發送予相關諮詢人士、上載至城市規劃委員會網頁供公眾免費瀏覽及下載及存放於規劃署規劃資料查詢處以供一般參閱。)	
Application No. 申請編號	(For Official Use Only) (請勿填寫此欄)
Location/address 位置/地址	Lots 1684 (Part), 1685 (Part) & 1686 (Part) in D.D. 129, Lau Fau Shan, Yuen Long, N.T.
Site area 地盤面積	1,048 sq. m 平方米 <input checked="" type="checkbox"/> About 約 (includes Government land of 包括政府土地 Nil sq. m 平方米 <input type="checkbox"/> About 約)
Plan 圖則	Approved Lau Fau Shan & Tsim Bei Tsui Outline Zoning Plan No. S/YL-LFS/11
Zoning 地帶	'Recreation' ('REC')
Type of Application 申請類別	<input checked="" type="checkbox"/> Temporary Use/Development in Rural Areas for a Period of 位於鄉郊地區的臨時用途/發展為期 <input checked="" type="checkbox"/> Year(s) 年 <u>3</u> <input type="checkbox"/> Month(s) 月 _____ <input type="checkbox"/> Renewal of Planning Approval for Temporary Use/Development in Rural Areas for a Period of 位於鄉郊地區臨時用途/發展的規劃許可續期為期 <input type="checkbox"/> Year(s) 年 _____ <input type="checkbox"/> Month(s) 月 _____
Applied use/ development 申請用途/發展	Temporary Warehouse (Excluding Dangerous Goods Godown) for a Period of 3 Years

**Temporary Warehouse (Excluding Dangerous Goods Godown) for a Period of 3 Years**  
**at**  
**Lots 1684 (Part), 1685 (Part) & 1686 (Part) in D.D. 129, Lau Fau Shan, Yuen Long, N.T.**

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**Annex 1 Drainage Assessment**

A. Site particulars

- 1.1.1 The site possesses an area of about 1,048m<sup>2</sup>. The surface of the site has been hard paved.
- 1.1.2 The application site will be occupied by a warehouse for storage of non-dangerous goods.

B. Level and gradient of the subject site & proposed surface channel

- 1.1.3 The subject site has been hard paved and occupied an area of approximately 1,048m<sup>2</sup>. It has a gradient sloping from north to south from about +14.8mPD to +14.0mPD.
- 1.1.4 In order to follow the topography of the application site, the proposed surface channel will be constructed following the gradient of the site. As demonstrated in the calculation in **Annex 1.3** hereunder, 450mm surface U-channel will be capable to drain surface runoff accrued at the subject site and the same passing through the site from adjacent area.

C. Catchment area of the proposed drainage provision at the subject site

- 1.1.5 With regard to the location of the existing drain and the topography surrounding the application site, the land to the south of the site is found higher than the application site. The land to the south, west and east of the site is found lower than the application site or about the same as the level of the application site (**Figure 4**). The land to the south is occupied by a warehouse approved by Town Planning Board (TPB Ref.: A/YL-LFS/457) of which drainage facilities has been provided.
- 1.1.6 As such, an external catchment is identified has been identified in **Figure 4**.

D. Particulars of the existing drainage facilities to accept the surface runoff collected at the application site

- 1.1.7 There is an existing natural drain to the north of the application site. The said existing drainage dissipates the surface runoff to Deep Bay.

## 1.2 Runoff Estimation & Proposed Drainage Facilities

### A. Proposed drainage facilities

- 1.2.1 Subject to the above calculations, it is determined that 450mm surface U-channel which is made of concrete along the site periphery is adequate to intercept storm water passing through and generated at the application site (**Figure 4**).
- 1.2.2 The collected surface runoff will be conveyed to existing open drain to the north of the site. (**Figure 4**)
- 1.2.3 All the proposed drainage facilities, including the section of surface channel proposed in between of the subject site to the open drain, will be provided and maintained at the applicant's own expense. Also, sand trap and U-channel will be cleaned at regular interval to avoid the accumulation of rubbish/debris which would affect the dissipation of storm water.
- 1.2.4 The provision of the proposed surface U-channel will follow the gradient of the application site. All the proposed drainage facilities will be constructed and maintained at the expense of the applicant.
- 1.2.5 All proposed works at the site periphery would not obstruct the flow of surface runoff from the adjacent areas, the provision of surface U-channel at site boundary is detailed hereunder:
  - (a) No leveling work will be carried at the site periphery. The level of the site periphery will be maintained during and after the works. As such, the works at the site periphery would not either alter or obstructed the flow of surface runoff from adjacent areas.
  - (b) 100mm openings will be provided at the toe of hoarding so as to allow unobstructed flow of surface runoff from adjacent area.
- 1.2.6 The applicant is conscientious in preparing this drainage proposal. Also, he is willing to provide necessary drainage facilities to minimize the drainage impact accrued by the proposed development. The acceptance of this drainage proposal will give positive recognition to the applicant's efforts.

### Annex 1.3 Drainage Calculation for the Proposed Provision of Drainage Facilities at Subject Site

#### 1. Runoff Estimation

1.1 Rational method is adopted for estimating the designed run-off

$$Q = k \times i \times A / 3,600$$

Assuming that:

- i. The area of the entire catchment is approximately 2,700m<sup>2</sup>; (**Figure 4**)
- ii. The catchment is predominant paved, it is assumed that the value of run-off co-efficient (k) is taken as 1.

$$\text{Difference in Land Datum} = 38.6\text{m} - 14.0\text{m} = 24.6\text{m}$$

$$L = 106\text{m}$$

$$\therefore \text{Average fall} = 24.6\text{m in } 106\text{m} \text{ or } 1\text{m in } 4.31\text{m}$$

According to the Brandsby-Williams Equation adopted from the “Stormwater Drainage Manual – Planning, Design and Management” published by the Drainage Services Department (DSD),

$$\text{Time of Concentration } (t_c) = 0.14465 [ L / (H^{0.2} \times A^{0.1}) ]$$

$$t_c = 0.14465 [ 106 / (23.21^{0.2} \times 2,700^{0.1}) ]$$

$$t_c = 3.71 \text{ minutes}$$

With reference to the Intensity-Duration-Frequency Curves provided in the abovementioned manual, the mean rainfall intensity (i) for 1 in 50 recurrent flooding period is found to be 300 mm/hr

$$\text{By Rational Method, } Q = 1 \times 300 \times 2,700 / 3,600$$

$$\therefore Q = 225 \text{ l/s} = 13,500 \text{ l/min}$$

In accordance with the Chart or the Rapid Design of Channels in “Geotechnical Manual for Slopes”, for an approximate gradient of about 1:50 and 1:160 along the site periphery of the site, 450mm surface U-channel is considered adequate to dissipate all the stormwater accrued by the application site and the adjacent land.

## Annex 2 Estimated Traffic Generation

- 2.1 The ingress/egress of the application site is abutting a local vehicular track leading to Deep Bay Road. **(Figure 4)**
- 2.2 Only 5.5 tonnes light goods vehicle is required to deliver non-dangerous goods to and from the application site.
- 2.3 The average and peak trip rates generated from and attracted to the site are shown below.

Type of vehicle	Average Traffic Generation Rate (pcu/hr)	Average Traffic Attraction Rate (pcu/hr)	Traffic Generation Rate at <u>Peak Hours</u> (pcu/hr)	Traffic Attraction Rate at <u>Peak Hours</u> (pcu/hr)
Light goods vehicle	0.3	0.3	0	0
Private car	0.2	0.2	1	1
Total	0.5	0.5	1	1

Note 1: The opening hour of the proposed development is restricted to 9:00 a.m. to 7:00 p.m. from Mondays to Saturdays. No operation will be held on Sundays and public holidays.

Note 2: The pcu of private car and light goods vehicle is taken as 1 and 1.5 respectively; and

Note 3: Morning peak is defined as 7:00a.m. to 9:00a.m. whereas afternoon peak is defined as 5:00p.m. to 7:00p.m.

- 2.4 In association with the proposed use, adequate space for manoeuvring and loading/unloading are available within the application site. By virtue of the fact that the application site is directly linked with Yuen Long Highway via Deep Bay Road and Lau Fau Shan Road and the traffic generated by the proposed development is insignificant, the proposed development being applied would not aggravate the traffic condition even though Deep Bay Road is not wide enough for 2 ways traffic. Similar warehouse has also been approved by Town Planning Board recently such as A/YL-LFS/560.

Urgent Return receipt Expand Group Restricted Prevent Copy Confidential

**Christina Ki Na LEE/PLAND**

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寄件者: king king  
寄件日期: 2025年12月12日星期五 15:34  
收件者: tpbpd/PLAND  
副本: Christina Ki Na LEE/PLAND; Belva Yuen King TONG/PLAND  
主旨: A/YL-LFS/589  
附件: 組合 2.pdf  
  
類別: Internet Email

Dear Sir,

We have updated the applied use in the attachment. Thank you.

Best Regards,

Patrick Tsui

<b>6. Type(s) of Application 申請類別</b>	
<b>(A) Temporary Use/Development of Land and/or Building Not Exceeding 3 Years in Rural Areas</b> 位於鄉郊地區土地上及/或建築物內進行為期不超過三年的臨時用途/發展 <b>(For Renewal of Permission for Temporary Use or Development in Rural Areas, please proceed to Part (B))</b> (如屬位於鄉郊地區臨時用途/發展的規劃許可續期，請填寫(B)部分)	
(a) Proposed use(s)/development 擬議用途/發展	Temporary Warehouse (Excluding Dangerous Goods Godown) for a Period of 3 Years  (Please illustrate the details of the proposal on a layout plan) (請用平面圖說明擬議詳情)
(b) Effective period of permission applied for 申請的許可有效期	<input checked="" type="checkbox"/> year(s) 年 ..... 3 ..... <input type="checkbox"/> month(s) 個月 .....
<b>(c) Development Schedule 發展細節表</b>	
Proposed uncovered land area 擬議露天土地面積	628 .....sq.m <input checked="" type="checkbox"/> About 約
Proposed covered land area 擬議有上蓋土地面積	420 .....sq.m <input checked="" type="checkbox"/> About 約
Proposed number of buildings/structures 擬議建築物/構築物數目	2 .....
Proposed domestic floor area 擬議住用樓面面積	NA .....sq.m <input checked="" type="checkbox"/> About 約
Proposed non-domestic floor area 擬議非住用樓面面積	Not more than 420 .....sq.m <input type="checkbox"/> About 約
Proposed gross floor area 擬議總樓面面積	Not more than 420 .....sq.m <input type="checkbox"/> About 約
Proposed height and use(s) of different floors of buildings/structures (if applicable) 建築物/構築物的擬議高度及不同樓層的擬議用途 (如適用) (Please use separate sheets if the space below is insufficient) (如以下空間不足，請另頁說明) Structure 1 & 2: Warehouse (Not exceeding 6.5m, 1 storey) ..... ..... .....	
Proposed number of car parking spaces by types 不同種類停車位的擬議數目	
Private Car Parking Spaces 私家車車位	1 space of 5m x 2.5m
Motorcycle Parking Spaces 電單車車位	Nil
Light Goods Vehicle Parking Spaces 輕型貨車泊車位	Nil
Medium Goods Vehicle Parking Spaces 中型貨車泊車位	Nil
Heavy Goods Vehicle Parking Spaces 重型貨車泊車位	Nil
Others (Please Specify) 其他 (請列明)	NA
Proposed number of loading/unloading spaces 上落客貨車位的擬議數目	
Taxi Spaces 的士車位	Nil
Coach Spaces 旅遊巴車位	Nil
Light Goods Vehicle Spaces 輕型貨車車位	1 space of 7m x 3.5m
Medium Goods Vehicle Spaces 中型貨車車位	Nil
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## Gist of Application 申請摘要

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Plan 圖則	Approved Lau Fau Shan & Tsim Bei Tsui Outline Zoning Plan No. S/YL-LFS/11
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Applied use/ development 申請用途/發展	Temporary Warehouse (Excluding Dangerous Goods Godown) for a Period of 3 Years

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at  
Lots 1684 (Part), 1685 (Part) & 1686 (Part) in D.D. 129, Lau Fau Shan,  
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Total: 32 pages

Appendix Ib of RNTPC Paper  
No. A/YL-LFS/589

Date: 25 February 2026

TPB Ref.: A/YL-LFS/589

By Email

Town Planning Board  
15/F, North Point Government Offices  
333, Java Road  
North Point  
Hong Kong  
(Attn: The Secretary)

Dear Sir,

**Temporary Warehouse (Excluding Dangerous Goods Godown) for a  
Period of 3 Years at Lots 1684 (Part), 1685 (Part) & 1686 (Part) in  
D.D. 129, Lau Fau Shan, Yuen Long, N.T.**

We are glad to submit the GPRR for the consideration of CEDD.

Should you have any enquiries, please feel free to contact our Mr. Patrick Tsui at [REDACTED]  
[REDACTED] at your convenience.

Yours faithfully,



Patrick Tsui

c.c. Tuen Mun and Yuen Long West District Planning Office (Attn: Ms. Belva  
TONG) – By Email

**GEOTECHNICAL PLANNING REVIEW REPORT (GPRR)**

**FOR**

**TEMPORARY WAREHOUSES (EXCLUDING DANGEROUS  
GOODS) FOR A PERIOD OF 3 YEARS**

**AT**

**LOTS NOS. 1684 (PART), 1685 (PART) AND 1686 (PART)  
IN D.D. 129, LAU FAU SHAN, YUEN LONG, NEW TERRITORIES**

**ISSUE 1**

**FEBRUARY 2026**

## **CONTENTS**

- 1. INTRODUCTION**
- 2. PROPOSED DEVELOPMENT**
- 3. THE SITE**
- 4. PROPOSED WORKS**
- 5. CONCLUSION**

<b>APPENDIX A</b>	<b>SLOPE INFORMATION OBTAINED FROM SLOPE INFORMATION SYSTEM (SIS)</b>
<b>APPENDIX B</b>	<b>SLOPE INFORMATION OBTAINED FROM SLOPE MAINTENANCE RESPONSIBILITY INFORMATION SYSTEM (SMRIS)</b>
<b>APPENDIX C</b>	<b>GEOLOGICAL MAP</b>
<b>APPENDIX D</b>	<b>SITE LAYOUT PLAN AND SECTION</b>
<b>APPENDIX E</b>	<b>PROPOSED LAYOUT PLAN</b>

## **1. INTRODUCTION**

This is the geotechnical planning review report for the application for Lots 1684 (Part), 1685(Part) and 1686 (Part) in D.D. 129, Lau Fau Shan, Yuen Long, New Territories.

This report is to identify that the proposed development is geotechnical feasible and will not cause any instability to the adjoining lots and vice versa.

## **2. PROPOSED DEVELOPMENT**

This application is to erect the temporary warehouses (Excluding Dangerous Goods) for a period of 3 years.

### 3. THE SITE

#### 3.1 General

The site is located at the toe of Feature No. 2SW-C/C117. The level of the application site is about +14.60mPD. Another Feature 2SW-C/C111 is located at the crest of 2SW-C/C117, the site area is about 1048m<sup>2</sup>.

#### 3.2 Existing Geotechnical Feature

According to the information obtained from the Hong Kong Slope Safety (HKSS) website – Slope Information System (SIS), there are 2 registered features in the vicinity of the proposed development. A registered feature of 2SW-C/C117 located in the vicinity of the proposed application site and other feature 2SW-C/C111 is located at the crest of 2SW-C/C117. The layout plan and the feature information obtained from SIS is enclosed in Appendix A.

In accordance with the record obtained from Slope Maintenance Responsibility Information System (SMRIS) from the website of Lands Department, the maintenance responsibility of the feature is summarized as below:

#### **Maintenance Responsibility of features in the vicinity of the proposed development:**

Feature No.	Sub-division No.	Maintenance Party
2SW-C/C111	1	DD129 Lot 2812DRP
	2	DD129 Lot 1685
	3	DD129 Lot 1686
	4	DD129 Lot 1687
2SW-C/C117	1	DD129 Lot 2812DRP
	2	DD129 Lot 1684
	3	DD129 Lot 1685
	4	DD129 Lot 1686
	5	DD129 Lot 1687

The application site is located at toe of the sub-division No.2 to 4 of feature no. 2SW-C/C117 and sub-division No.2 to 3 of feature no. 2SW-C/C111 which maintained by DD129 Lot 1684, DD129 Lot 1685 and DD129 Lot 1686, the SMRIS report is enclosed in Appendix B.

#### Feature 2SW-C/C111

This feature is an U-shaped located at the crest of feature 2SW-C/C117. The feature is a vegetated cut slope with about 3.5m high and a gradient of 60°.

#### Feature 2SW-C/C117

This feature is also an U-shaped located at the south and east side of the proposed site. It consists of a vegetated cut slope with maximum 6.0m high and a gradient of 66°. This feature is about 170m long

### 3.3 Site Geology

Desk study is carried out for identification of the site geology and the following documents are viewed:

#### 3.3.1 1:20000 scale geological map

Based on the 1:20,000 scale map, “San Tin” Sheet 2, Solid and Superficial Geology, Series HGM20 published by the Geotechnical Engineering Office (Edition I – 1989), the site is underlain by fine-grained granite from Jurassic-Cretaceous of Mesozoic. The Geological Map is enclosed in Appendix C.

#### 3.3.2 Past Instability and Natural Terrain Hazards

There is no relevant past landslide and ENTLI record was found.

### 3.4 Adjoining Structures

A single storey temporary structure is located at northern side of the proposed development and the proposed development is located at the toe of Feature No. 2SW-C/C117. The layout plan and the sections are enclosed in Appendix D.

#### **4. PROPOSED WORKS**

The proposed planning application has 2 nos. of single storey structures which included 2 nos. of single storey of warehouse for storage of non-dangerous goods at the toe level of Feature No. 2SW-C/C117. No excavation lateral support, foundation and site formation works will be carried out. The proposed layout plan is enclosed in Appendix E.

## **5. CONCLUSION**

The proposed planning application involves the construction of single storey of warehouses only and they will be located at the toe of the geotechnical feature (2SW-C/C117) and no excavation lateral support, foundation and site formation works is proposed for the application site, it is therefore, the proposed facilities will not be affected by potential landslide debris and no additional loading and adverse effect will be imposed to the adjacent ground and the geotechnical feature. Hence, it is envisaged that the proposed planning application is geotechnical feasible.

**APPENDIX A**

**SLOPE INFORMATION OBTAINED FROM SLOPE INFORMATION  
SYSTEM (SIS)**



**BASIC INFORMATION**

Location: ABOVE OPEN STORAGE SITE, NEAR LAU FAU SHAN, YUEN LONG.  
 Date of Formation: post-1977  
 Date of Construction/ Modification: N/A  
 Approximate Coordinates: Easting : 817107 Northing : 836475

**CONSEQUENCE-TO-LIFE CATEGORY**

Facility at Crest: Undeveloped green belt  
 Distance of Facility from Crest (m): 0  
 Facility at Toe: Remote area or abandoned facilities  
 Distance of Facility from Toe (m): 2.5  
 Consequence-to-life Category: 3  
 Remarks: N/A

**SLOPE PART**

(1) Max. Height (m): 3.5 Length (m): 115 Average Angle (deg): 60

**WALL PART**

N/A

**MAINTENANCE RESPONSIBILITY**

Maintenance Type: Private Party: DD129 Lot2812DRP Agent: N/A  
 Maintenance Type: Private Party: DD129 Lot1685 Agent: N/A  
 Maintenance Type: Private Party: DD129 Lot1686 Agent: N/A  
 Maintenance Type: Private Party: DD129 Lot1687 Agent: N/A

**DETAILS OF SLOPE / RETAINING WALL**

Date of Inspection: 26-02-1998  
 Data Source: SIRST  
 Slope Part Drainage: N/A  
 Wall Part Drainage: N/A

**SLOPE PART**

Slope Part (1)  
 Surface Protection (%): Bare: 60 Vegetated: 40 Chunam: 0 Shotcrete: 0 Other Cover: 0  
 Material Description: Material type: Soil Geology: Decomposed granite  
 Berm: No. of Berms: N/A Min. Berm Width (m): N/A  
 Weepholes: Size (mm): N/A Spacing (m): N/A



**WALL PART**

N/A

**SERVICES**

N/A


PHOTO



2SW-C/C111

GENERAL VIEW

F9

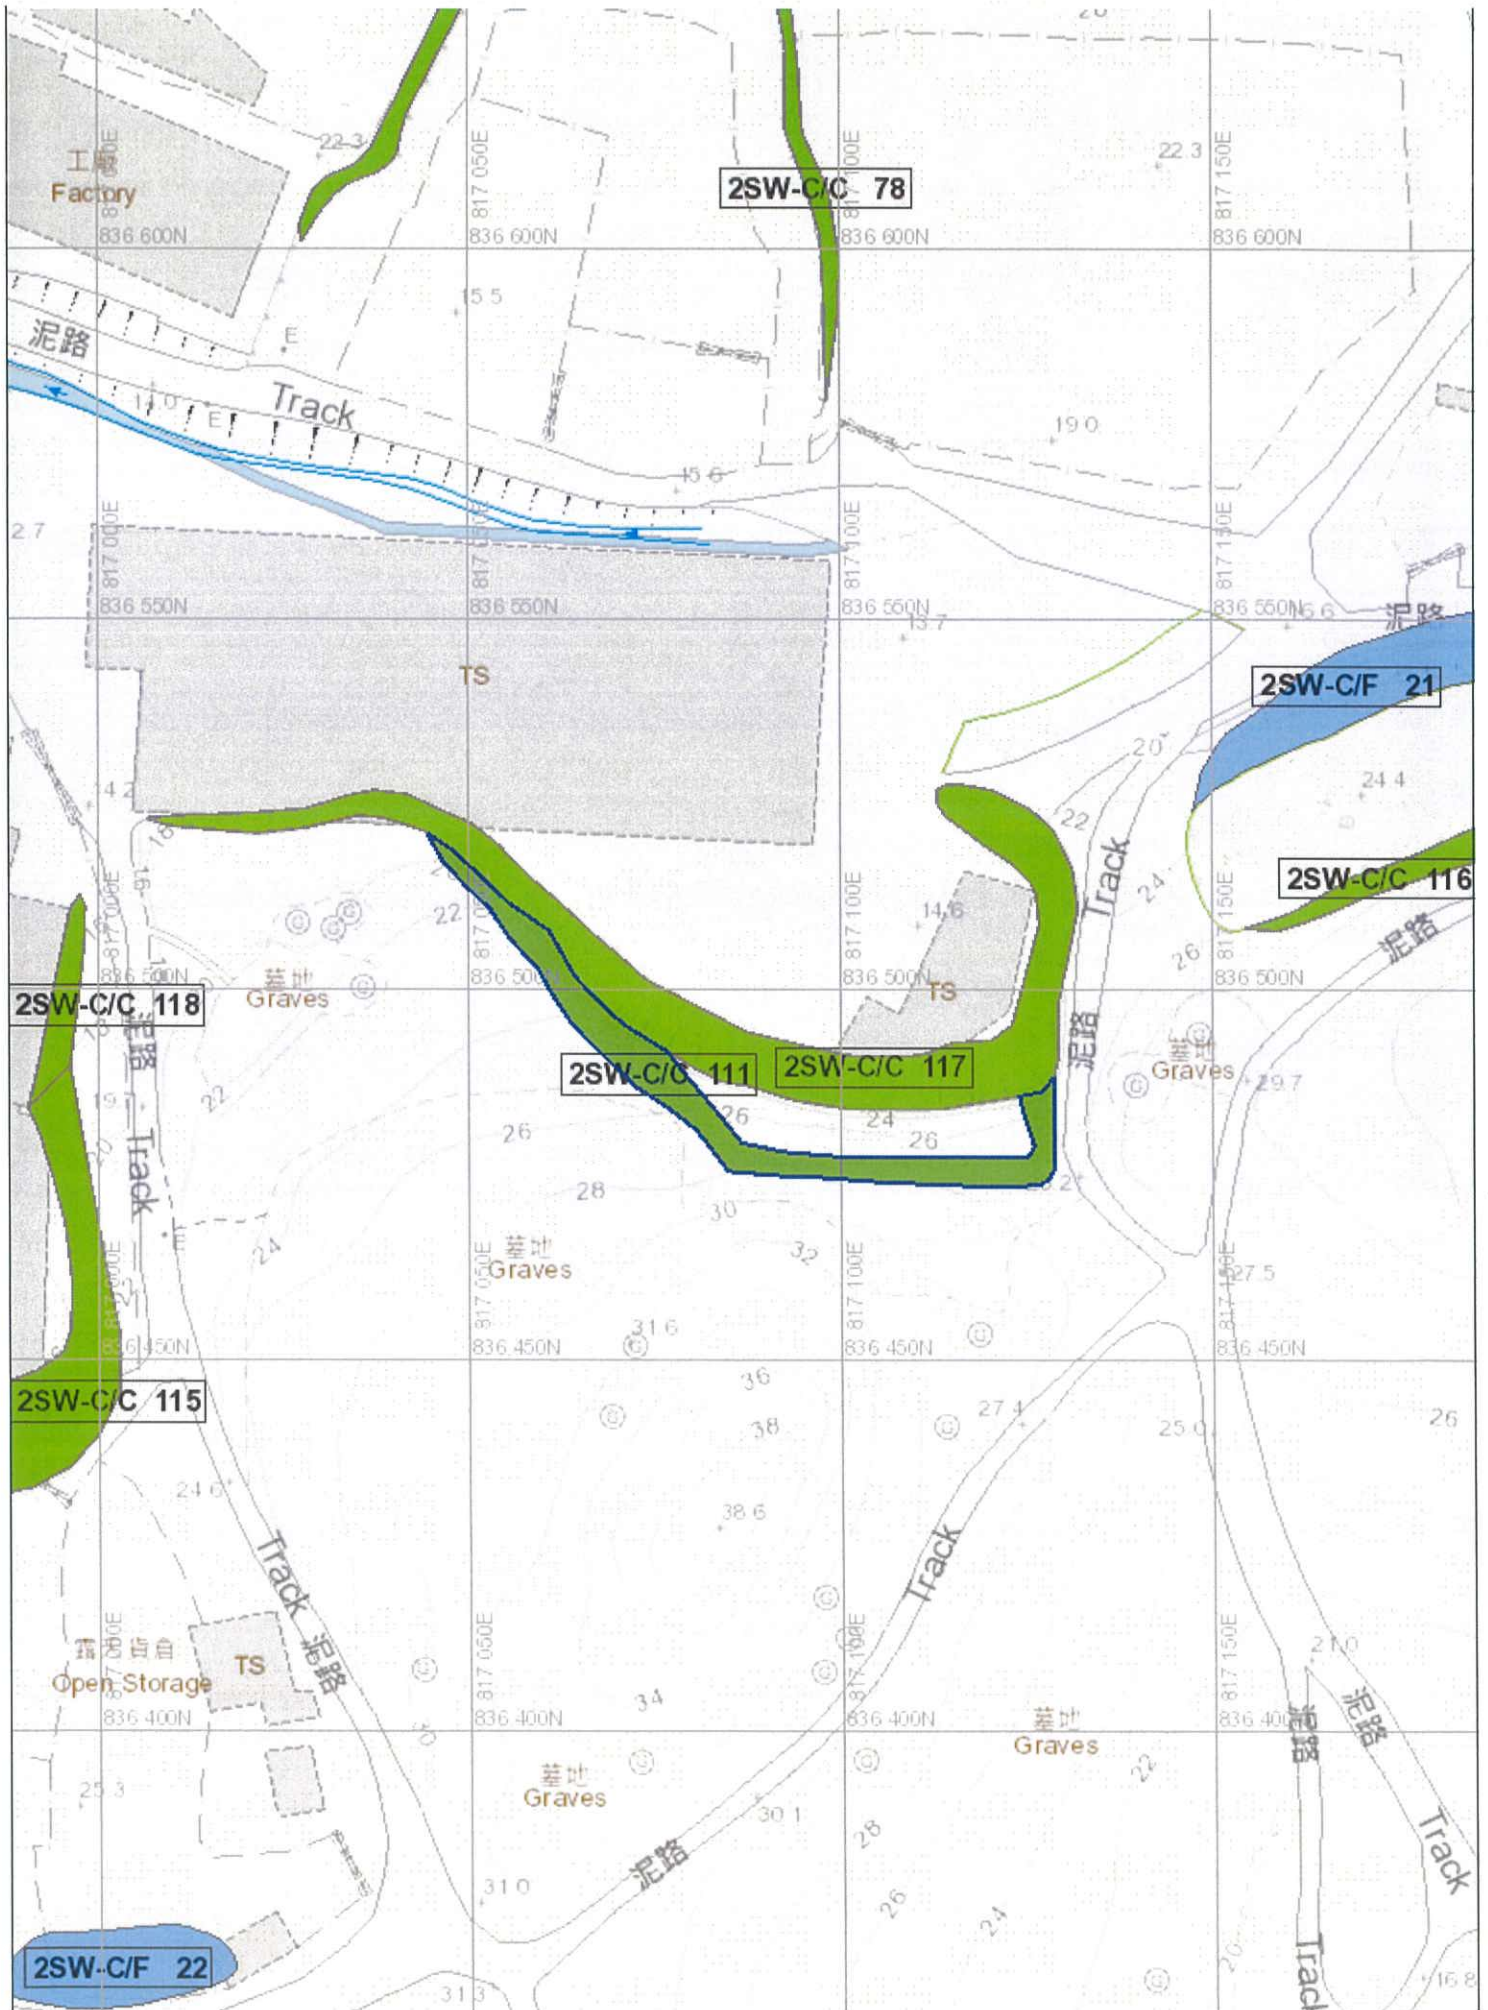



## BASIC INFORMATION

Location: AROUND PERIMETER OF DRILLTEC COMPANY YARD, NEAR LAU FAU SHAN, YUEN LONG  
 Date of Formation: pre-1977  
 Date of Construction/ Modification: N/A  
 Approximate Coordinates: Easting : 817095 Northing : 836487

## CONSEQUENCE-TO-LIFE CATEGORY

Facility at Crest: Undeveloped green belt  
 Distance of Facility from Crest (m): 0  
 Facility at Toe: Non-dangerous goods storage site  
 Distance of Facility from Toe (m): 0  
 Consequence-to-life Category: 3  
 Remarks: N/A

## SLOPE PART

(1) Max. Height (m): 6 Length (m): 170 Average Angle (deg): 66

## WALL PART

N/A

## MAINTENANCE RESPONSIBILITY

Maintenance Type: Private Party: DD129 Lot2812DRP Agent: N/A  
 Maintenance Type: Private Party: DD129 Lot1684 Agent: N/A  
 Maintenance Type: Private Party: DD129 Lot1685 Agent: N/A  
 Maintenance Type: Private Party: DD129 Lot1686 Agent: N/A  
 Maintenance Type: Private Party: DD129 Lot1687 Agent: N/A

## DETAILS OF SLOPE / RETAINING WALL

Date of Inspection: 26-02-1998  
 Data Source: SIRST  
 Slope Part Drainage: N/A  
 Wall Part Drainage: N/A

## SLOPE PART

Slope Part (1)  
 Surface Protection (%): Bare: 30 Vegetated: 70 Chunam: 0 Shotcrete: 0 Other Cover: 0  
 Material Description: Material type: Soil Geology: Decomposed granite  
 Berm: No. of Berms: N/A Min. Berm Width (m): N/A  
 Weepholes: Size (mm): N/A Spacing (m): N/A

**WALL PART**


N/A

**SERVICES**

N/A

**STAGE 1 STUDY REPORT**

Inspected On: 26-02-1998  
 Weather: Some Rain  
 District: MW

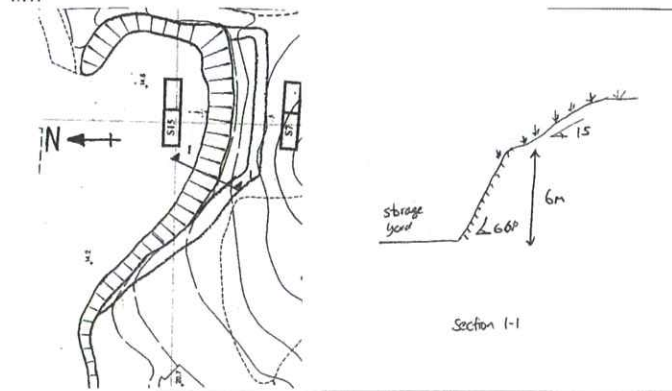

Section No: 1-1  
 Height (m): N/A  
 Type of Toe Facility: Non-dangerous goods storage site  
 Distance from Toe (m): 0  
 Type of Crest Facility: Undeveloped green belt  
 Distance from Crest (m): 0  
 Consequence Category: 3  
 Engineering Judgement: P  
 Section No: 2-2  
 Type of Toe Facility: N/A  
 Distance from Toe (m): 0  
 Type of Crest Facility: N/A  
 Distance from Crest (m): 0  
 Consequence Category: 3  
 Engineering Judgement: P  
 Sign of Seepage: Slope : No signs of seepage  
 Wall : N/A  
 Criterion A satisfied: N  
 Sign of Distress: Slope : Reasonable (near crest)  
 Wall : N/A  
 Criterion D satisfied: N  
 Non-routine maintenance required: N



Note: N/A  
Masonry wall / Masonry facing: N  
Note: N/A  
Consequence category (for critical section): 3  
Observations: N/A  
Emergency Action Required: N  
Action By: N/A

### ACTION TO INITIATE PREVENTIVE WORKS

Criterion A / Criterion D: N/A  
Action By: N/A  
Further Study: Y  
Action By: Mixed

### OTHER EXTERNAL ACTION

Check / repair Services: N  
Action By: N/A  
Non-routine Maintenance: N  
Action By: N/A

PHOTO



2SW-117

GENERAL VIEW

F10



**APPENDIX B**

**SLOPE INFORMATION OBTAINED FROM SLOPE MAINTENANCE  
RESPONSIBILITY INFORMATION SYSTEM (SMRIS)**

**Slope Maintenance Responsibility Report**

(2SW-C/C111)


**ESTATE MANAGEMENT SECTION  
LANDS DEPARTMENT**
**List of Slope Maintenance Responsibility Area(s)**

<b>1</b>	<b>2SW-C/C111</b>	<b>Sub-Division</b>	1
	<b>Location</b>	WITHIN LOT1684,LOT1685,LOT1686,LOT1687 AND LOT2812D IN DD129	
	<b>Responsible Lot/Party</b>	DD129 Lot2812DRP	<b>Maintenance Agent</b> Not Applicable
	<b>Remarks</b>	Slope information being reviewed.	
<b>2</b>	<b>2SW-C/C111</b>	<b>Sub-Division</b>	2
	<b>Location</b>	WITHIN LOT1684,LOT1685,LOT1686,LOT1687 AND LOT2812D IN DD129	
	<b>Responsible Lot/Party</b>	DD129 Lot1685	<b>Maintenance Agent</b> Not Applicable
	<b>Remarks</b>	Slope information being reviewed.	
<b>3</b>	<b>2SW-C/C111</b>	<b>Sub-Division</b>	3
	<b>Location</b>	WITHIN LOT1684,LOT1685,LOT1686,LOT1687 AND LOT2812D IN DD129	
	<b>Responsible Lot/Party</b>	DD129 Lot1686	<b>Maintenance Agent</b> Not Applicable
	<b>Remarks</b>	Slope information being reviewed.	
<b>4</b>	<b>2SW-C/C111</b>	<b>Sub-Division</b>	4
	<b>Location</b>	WITHIN LOT1684,LOT1685,LOT1686,LOT1687 AND LOT2812D IN DD129	
	<b>Responsible Lot/Party</b>	DD129 Lot1687	<b>Maintenance Agent</b> Not Applicable
	<b>Remarks</b>	Slope information being reviewed.	


- End of Report -

**Notes:**

- (i) The location plan in Annex is for identification purposes of slope(s) only.
- (ii) The slope(s) as listed in the Slope Maintenance Responsibility Report may not be shown on the location plan in Annex.

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Location Plan

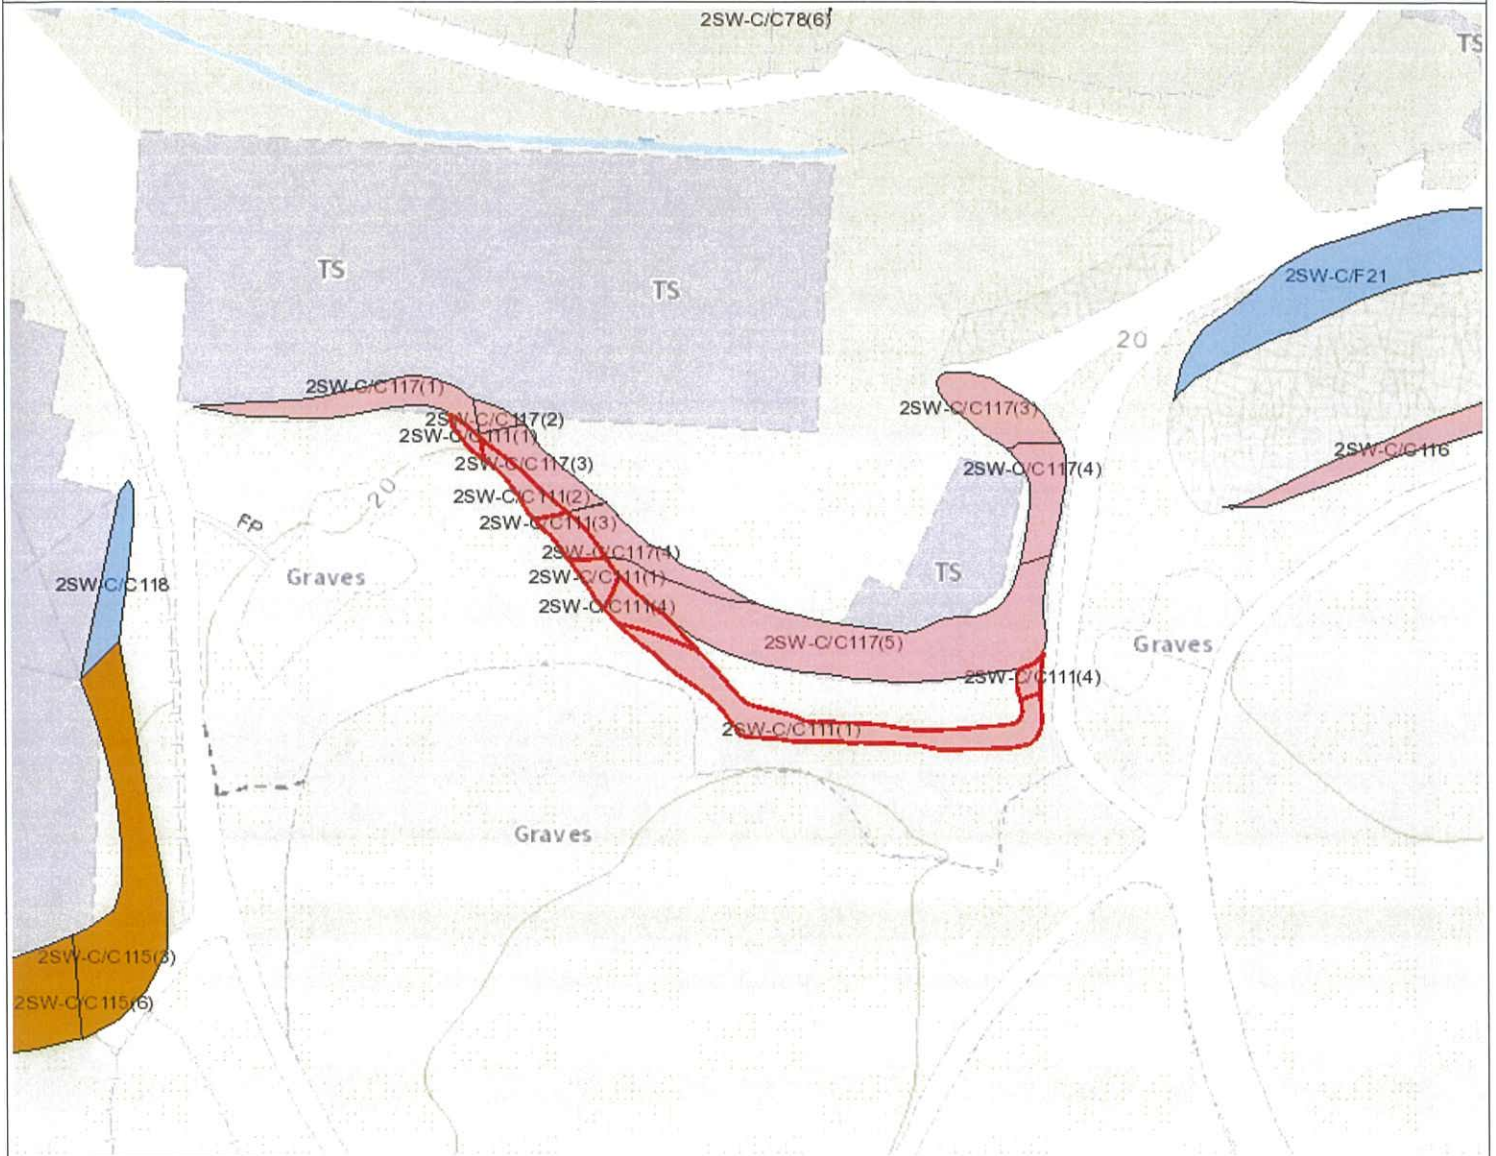

Legend

- Slope Area(s)
- Search Location
- Slope(s) Maintained by Government
- Slope(s) Maintained by Private Party/Parties
- Slope(s) Maintained by Government and Private Party/Parties



**ESTATE MANAGEMENT SECTION  
LANDS DEPARTMENT**

This Plan is **NOT TO SCALE** and intended for **IDENTIFICATION** only. All information shown on this plan **MUST** be verified by field survey.

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**Slope Maintenance Responsibility Report**

(2SW-C/C117)


**ESTATE MANAGEMENT SECTION  
LANDS DEPARTMENT**
**List of Slope Maintenance Responsibility Area(s)**

<b>1</b>	<b>2SW-C/C117</b>		<b>Sub-Division</b>	1
	<b>Location</b>	WITHIN LOT2812D, 1684, 1685, 1686, 1687 IN DD129		
	<b>Responsible Lot/Party</b>	DD129 Lot2812DRP	<b>Maintenance Agent</b>	Not Applicable
	<b>Remarks</b>	Slope information being reviewed.		
<b>2</b>	<b>2SW-C/C117</b>		<b>Sub-Division</b>	2
	<b>Location</b>	WITHIN LOT2812D, 1684, 1685, 1686, 1687 IN DD129		
	<b>Responsible Lot/Party</b>	DD129 Lot1684	<b>Maintenance Agent</b>	Not Applicable
	<b>Remarks</b>	Slope information being reviewed.		
<b>3</b>	<b>2SW-C/C117</b>		<b>Sub-Division</b>	3
	<b>Location</b>	WITHIN LOT2812D, 1684, 1685, 1686, 1687 IN DD129		
	<b>Responsible Lot/Party</b>	DD129 Lot1685	<b>Maintenance Agent</b>	Not Applicable
	<b>Remarks</b>	Slope information being reviewed.		
<b>4</b>	<b>2SW-C/C117</b>		<b>Sub-Division</b>	4
	<b>Location</b>	WITHIN LOT2812D, 1684, 1685, 1686, 1687 IN DD129		
	<b>Responsible Lot/Party</b>	DD129 Lot1686	<b>Maintenance Agent</b>	Not Applicable
	<b>Remarks</b>	Slope information being reviewed.		
<b>5</b>	<b>2SW-C/C117</b>		<b>Sub-Division</b>	5
	<b>Location</b>	WITHIN LOT2812D, 1684, 1685, 1686, 1687 IN DD129		
	<b>Responsible Lot/Party</b>	DD129 Lot1687	<b>Maintenance Agent</b>	Not Applicable
	<b>Remarks</b>	Slope information being reviewed.		


- End of Report -

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Location Plan



Legend

- Slope Area(s)
- Search Location
- Slope(s) Maintained by Government
- Slope(s) Maintained by Private Party/Parties
- Slope(s) Maintained by Government and Private Party/Parties

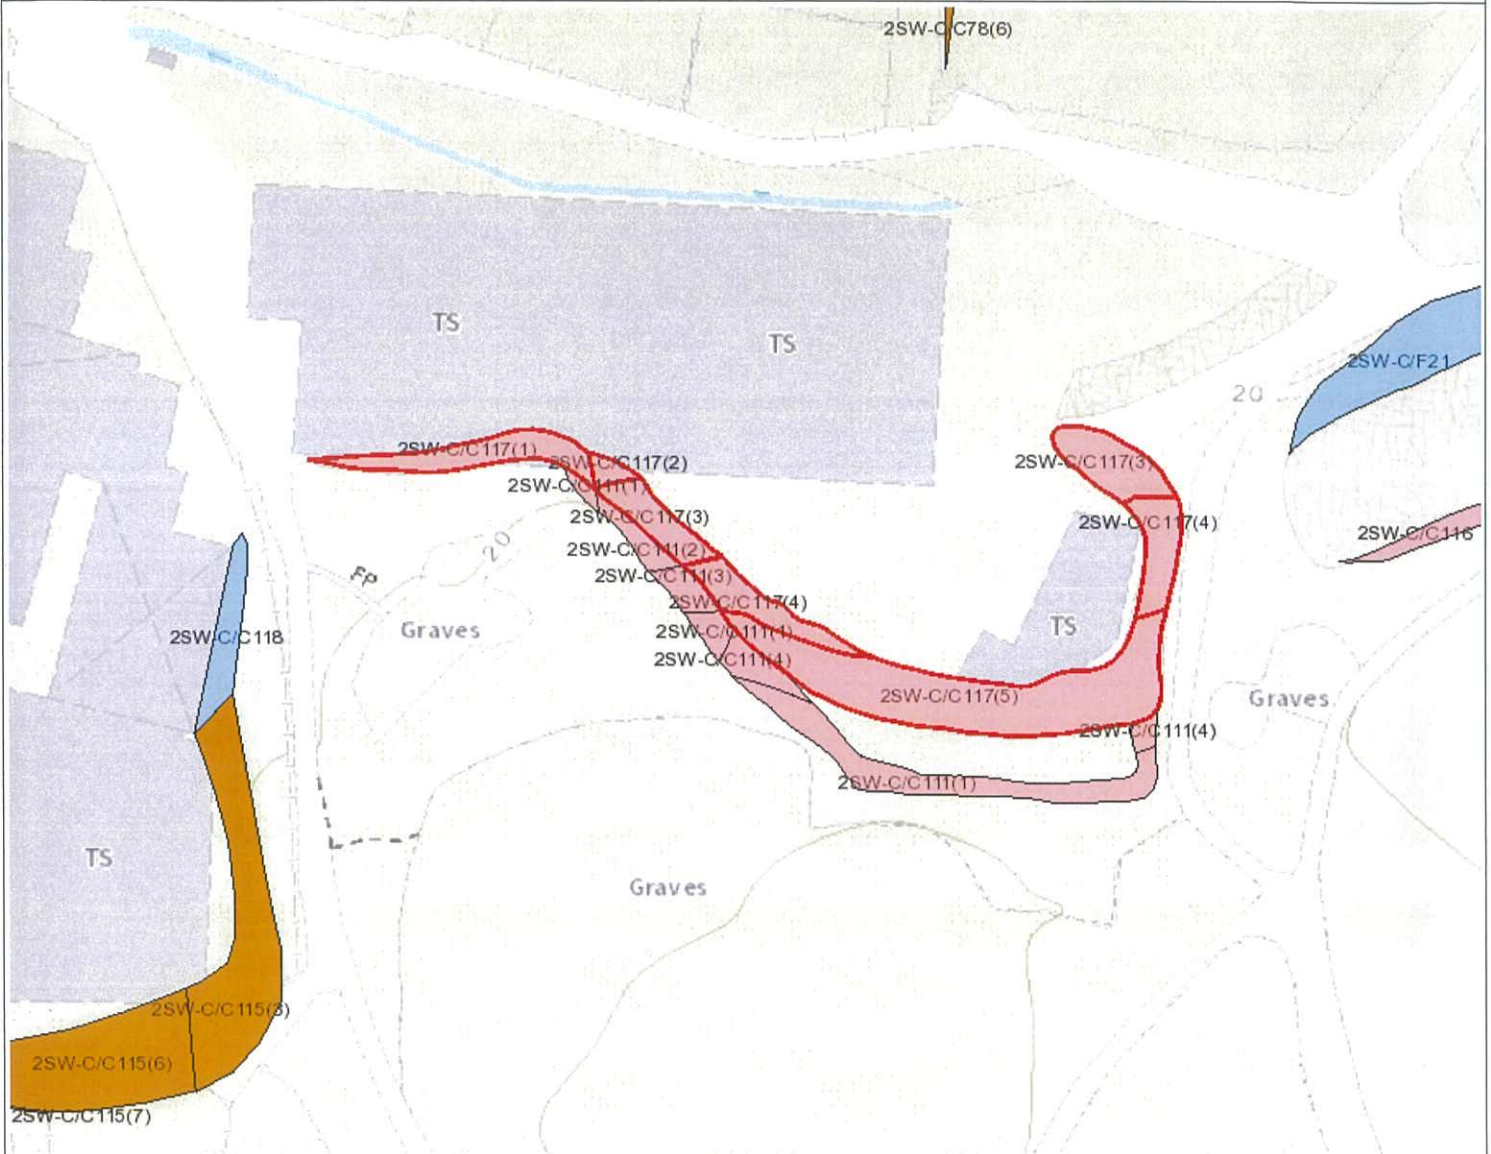

**ESTATE MANAGEMENT SECTION  
LANDS DEPARTMENT**

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**APPENDIX C**

**GEOLOGICAL MAP**

# SAN TIN 新田

## Sheet 2 編號

### SOLID AND SUPERFICIAL GEOLOGY 基岩和表土地質圖

Series HGM20 組別

Scale 1:20 000 比例

#### SUPERFICIAL DEPOSITS 表土沉積

		GENETIC CLASSIFICATION OR NAMED DIVISIONS	成因類型或地層名稱	主要物質成份	PRINCIPAL MATERIALS
全新統 HOLOCENE	抗口組 HANG HAU FORMATION	Fill; sanitary fill ( Qfs )	填土	填泥和廢物	Natural earth and waste
		Alluvium	沖積物	分選性真好至中等的粘土、粉砂、砂和礫石	Clay/silt, sand and gravel well-sorted to semi-sorted
		Estuarine deposits	河口灣沉積	粘土質粉砂或砂	Clayey silt or sand
		Beach deposits	海灘沉積	砂	Sand
		Raised beach deposits	高位海灘沉積	砂	Sand
		Qa			
		Qam			
		Qb			
		Qrb			
		QHH	主要為深灰色海相泥 ( 未分 )	未分	Undivided, mainly dark grey marine mud
		ms	海相砂, 部份粉砂質		Marine sand, part silty
更新-全新統 PLEISTOCENE AND HOLOCENE		Debris flow deposits	坡積、洪積物	未分選的砂、礫至漂礫、基質為粘土/粉砂	Unsorted sand, gravel, cobbles and boulders; clay/silt matrix
				Qd	
更新統 PLEISTOCENE	赤轆角組 CHE LAP KOK FORMATION	Terraced alluvium	階地沖積物	分選性真好至中等的礫質、砂質粘土/粉砂	Clay/silt, gravelly sandy well-sorted to semi-sorted
		Debris flow deposits	坡積、洪積物	未分選, 夾中礫和漂礫的礫質、粘土質粉砂/砂	Silt/sand, gravelly, clayey with cobbles and boulders; unsorted
				Qpa	
				Qpd	
		QCK	紅色、黃色和灰色的粘土、粉砂、砂和礫石 ( 未分 )	未分	Undivided; red, yellow and grey clay, silt, sand and gravel


#### ROCK GEOLOGY 基岩地質

##### SEDIMENTARY AND VOLCANIC ROCKS 沉積岩和火山岩

		NAMED ROCK DIVISIONS	地層單位名稱	主要岩石類型/特徵	PRINCIPAL ROCK TYPES/CHARACTERS	
上白堊統 UPPER CRETACEOUS		Kat O Formation	吉澳組	角礫岩夾礫岩和粗粒砂岩	Breccia with conglomerate and coarse-grained sandstone	
				KKO		
上侏羅統 UPPER JURASSIC	淡水灣群 REPULSE BAY VOLCANIC GROUP	Tai Mo Shan Formation, undivided	大帽山組 ( 未分 )	粗火山灰晶屑凝灰岩	Coarse ash crystal tuff	
				JTM		
				s	砂岩	
下石炭統 LOWER CARBONIFEROUS	新田群 SAN TIN GROUP	Lok Ma Chau Formation, undivided	落馬洲組 ( 未分 )	變質砂岩夾變質礫岩和千枚岩	Metasandstone with metaconglomerate and phyllite	
				Cts		
				Cmp	千枚岩, 變質粉砂岩夾變質砂岩和石墨片岩	Phyllite, metasiltstone with metasandstone and graphite schist
				CYL	大理岩	Marble
				Yuen Long Formation, undivided	元朗組 ( 未分 )	
				cg	變質礫岩	
				gt	石墨片岩	


##### MAJOR INTRUSIVE IGNEOUS ROCKS 主要侵入火成岩

白堊紀 CRETACEOUS	Megacrystic 具大斑晶的		gf	細粒花崗岩, 0.06 - 2 毫米	Fine-grained granite, 0.06-2mm

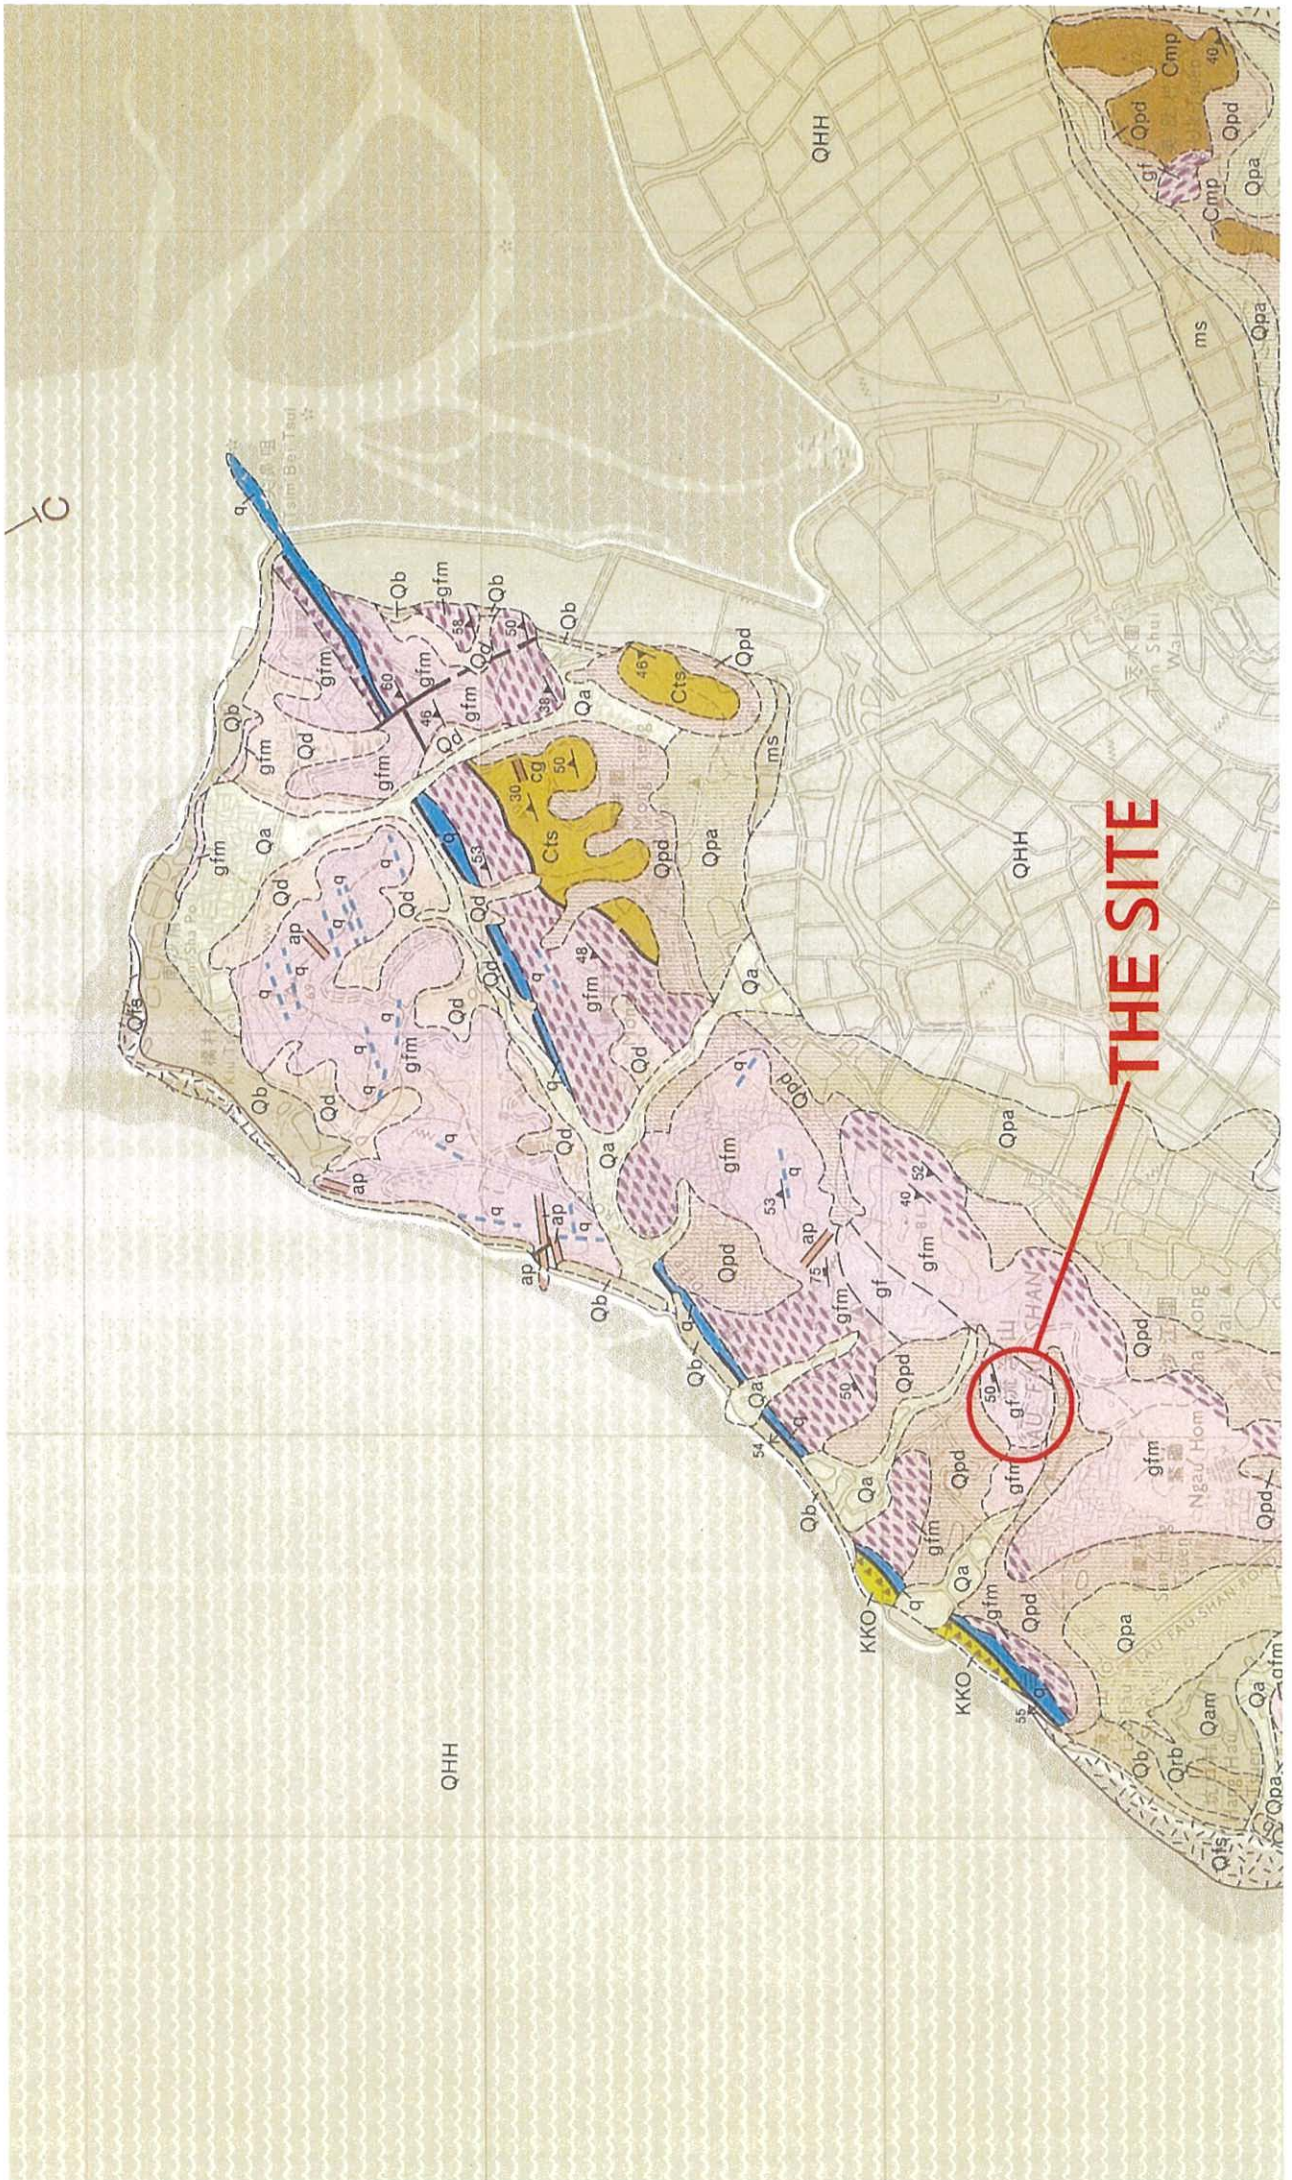


**APPENDIX D**

**SITE LAYOUT PLAN AND SECTION**

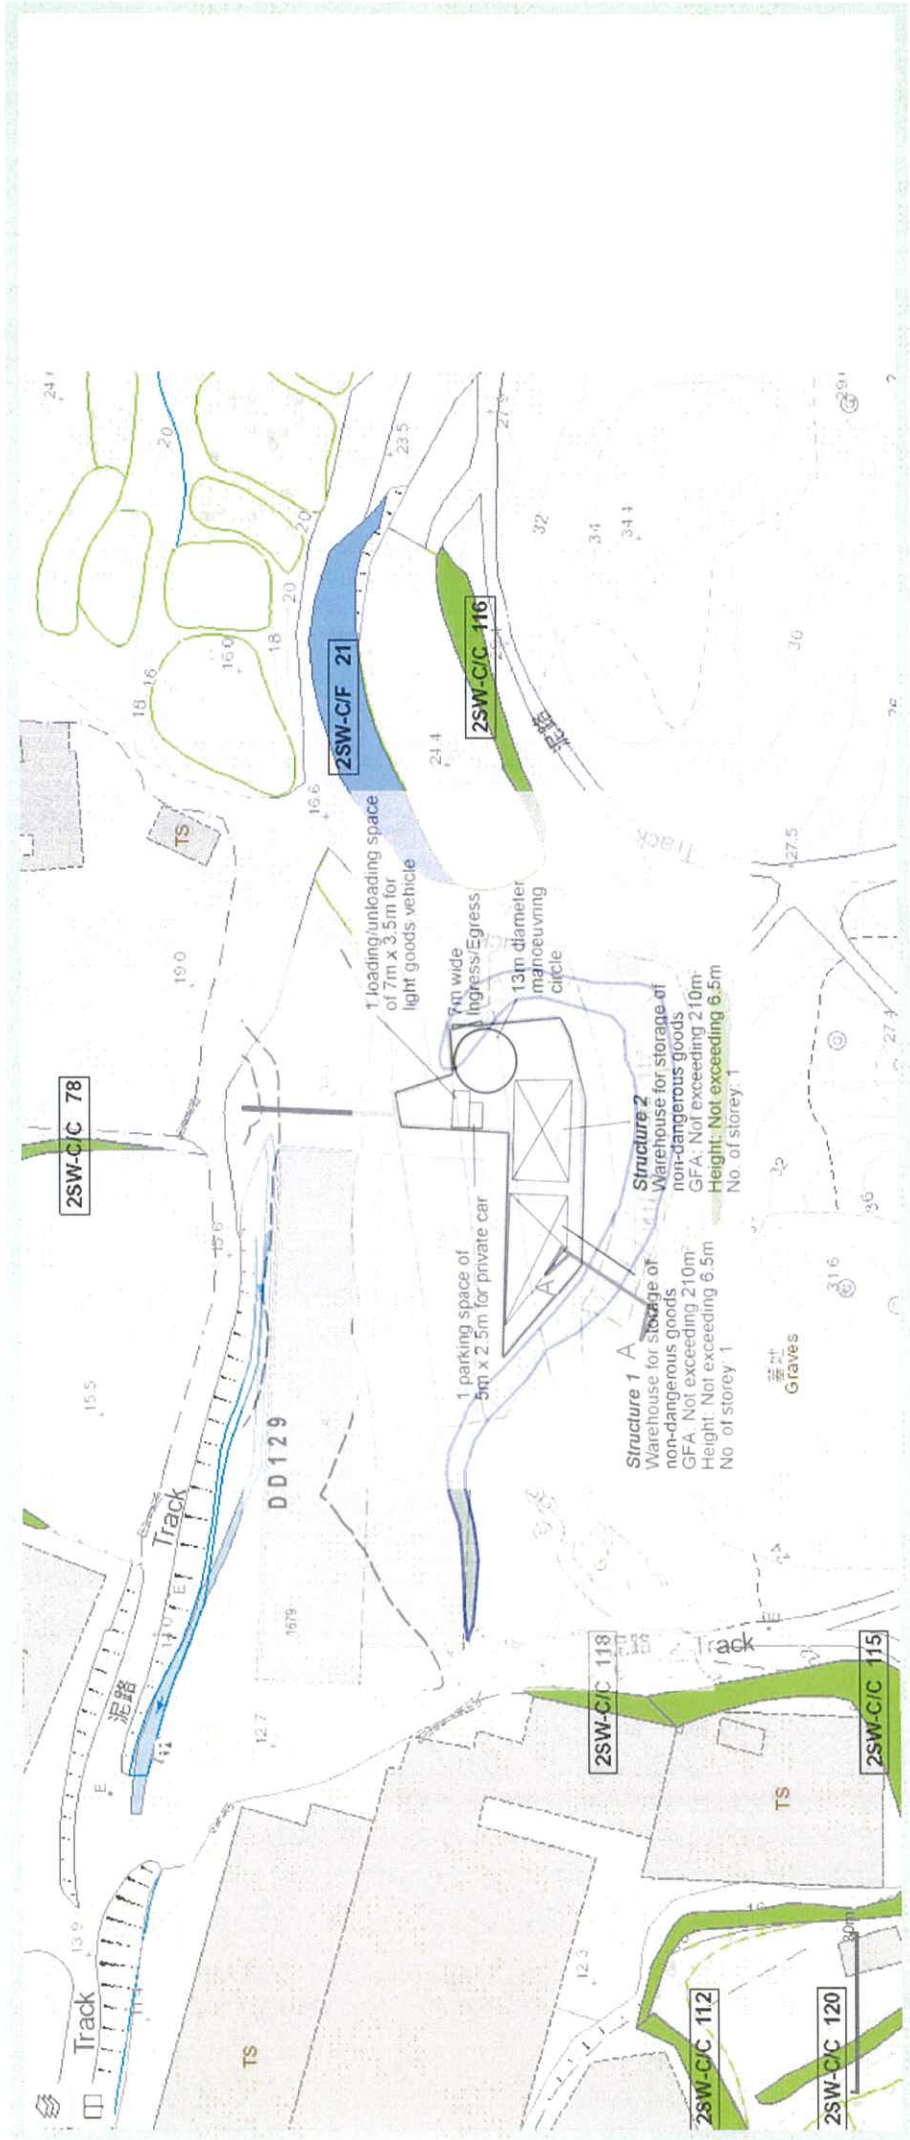

# SITE LAYOUT PLAN

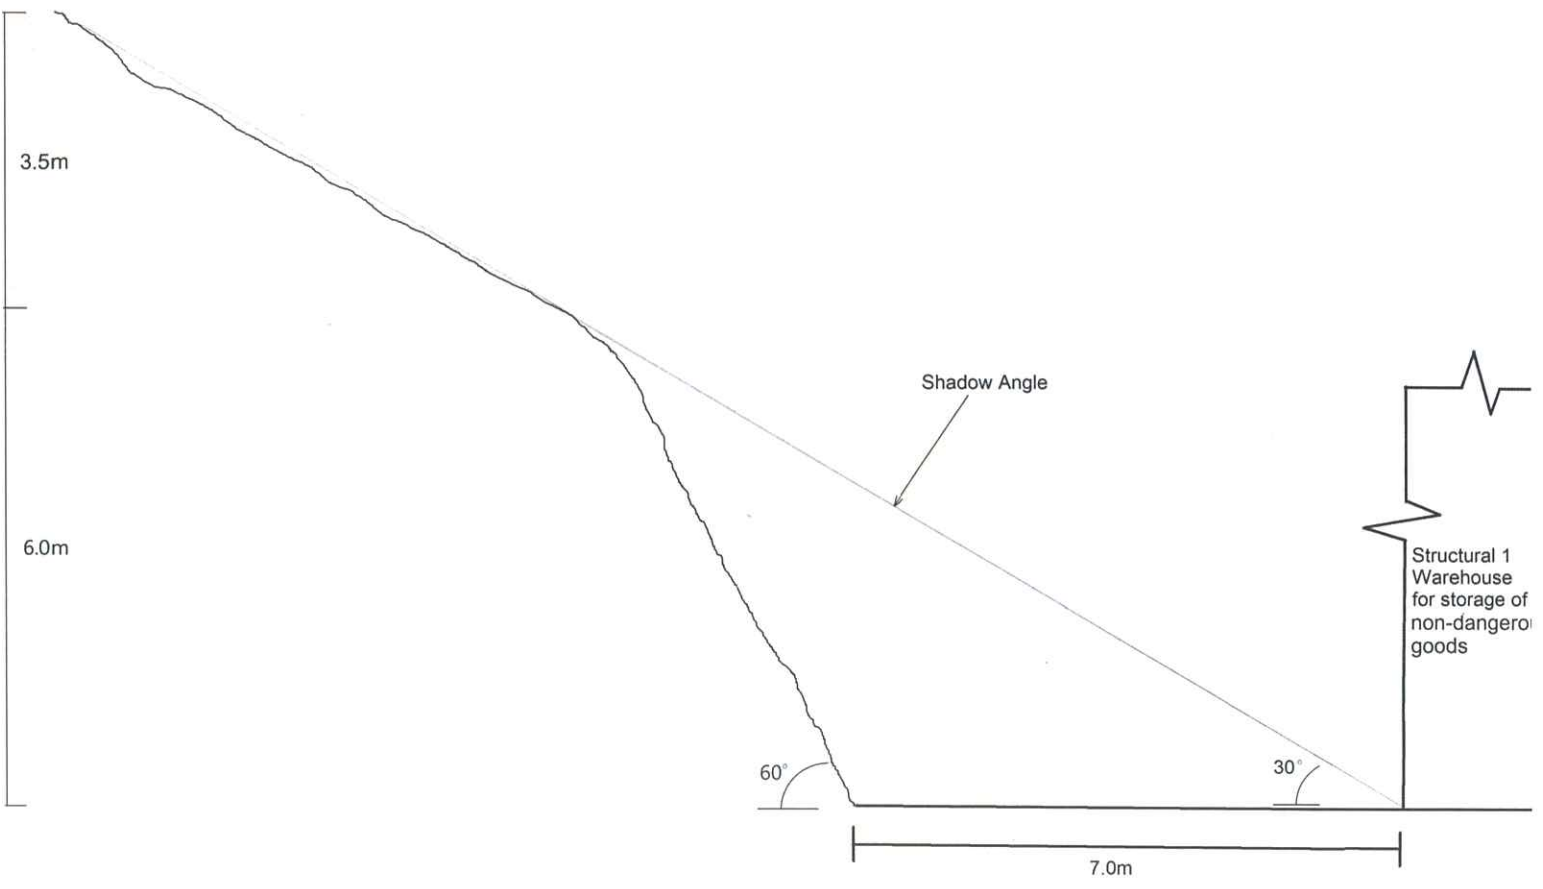


Section A-A

**APPENDIX E**

**PROPOSED LAYOUT PLAN**

N

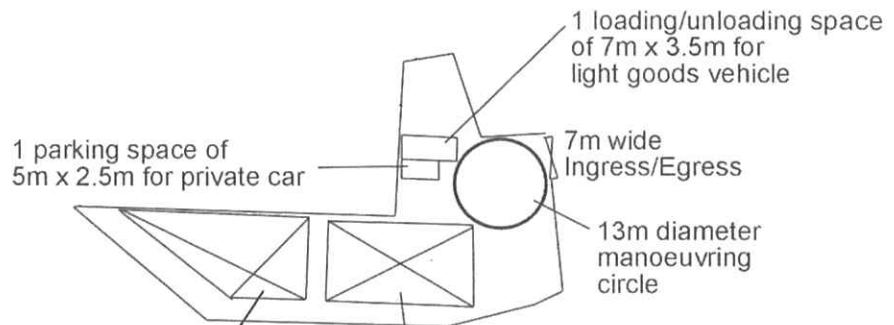

**Structure 1**  
Warehouse for storage of non-dangerous goods  
GFA: Not exceeding 210m<sup>2</sup>  
Height: Not exceeding 6.5m  
No. of storey: 1

**Structure 2**  
Warehouse for storage of non-dangerous goods  
GFA: Not exceeding 210m<sup>2</sup>  
Height: Not exceeding 6.5m  
No. of storey: 1

Project 項目名稱: Temporary Warehouse (Excluding Dangerous Goods) for a Period of 3 Years at Lots 1684 (Part), 1685 (Part) & 1686 (Part) in D.D. 129, Lau Fau Shan, Yuen Long, N.T.	Drawing Title 圖目: Proposed Layout Plan	Remarks 備註:
	Drawing No. 圖號:	Scale 比例: 1:1000

Previous s.16 Application covering the Application Site

Approved Application

	<u>Application No.</u>	<u>Proposed Use(s)/ Development(s)</u>	<u>Zoning(s)</u>	<u>Date of Consideration (RNTPC)</u>
1	A/YL-LFS/442	Proposed Temporary Warehouse for Storage of Construction Materials (3 years)	REC	11.11.2022 (Revoked on 11.8.2024)

Rejected Application

	<u>Application No.</u>	<u>Proposed Use</u>	<u>Zoning</u>	<u>Date of Consideration (RNTPC/TPB)</u>	<u>Rejection Reasons</u>
1	A/YL-LFS/99	Temporary Warehouse and Open Storage of Construction Materials (3 years)	REC	4.7.2003 (on Review)	(1), (2) & (3)

Rejection Reasons

1. Not in line with the planning intention.
2. Not in line with the TPB Guidelines No. 13.
3. Setting undesirable precedent.

**Similar s.16 Applications within the same “REC” Zone  
on the Lau Fau Shan and Tsim Bei Tsui Outline Zoning Plan in the past 5 years**

Approved Applications

	<u>Application No.</u>	<u>Proposed Use(s)/ Development(s)</u>	<u>Zoning(s)</u>	<u>Date of Consideration (RNTPC)</u>
1	A/YL-LFS/392	Temporary Warehouse for Storage of Plastic and Retail of Plastic Pellet (3 years)	REC	14.5.2021
2	A/YL-LFS/410	Proposed Temporary Warehouse for Storage of Hardware Accessories (3 years)	REC	29.10.2021 (Revoked on 29.7.2023)
3	A/YL-LFS/438	Proposed Temporary Warehouse for Storage of Vehicle Parts and Construction Materials (3 Years)	REC	9.9.2022 (Revoked on 9.6.2023)
4	A/YL-LFS/441	Proposed Temporary Warehouse for Storage of Building Materials (3 Years)	REC	23.9.2022

	<u>Application No.</u>	<u>Proposed Use(s)/ Development(s)</u>	<u>Zoning(s)</u>	<u>Date of Consideration (RNTPC)</u>
5	A/YL-LFS/445	Proposed Temporary Warehouse for Storage of Building Materials (3 Years)	REC	25.11.2022 (Revoked on 25.8.2023)
6	A/YL-LFS/449	Temporary Warehouse for Storage of Construction Materials and Engineering Machineries with Ancillary Workshop (3 Years)	REC	3.2.2023
7	A/YL-LFS/455	Proposed Temporary Warehouse for Storage of Building Materials (3 Years)	REC	17.3.2023
8	A/YL-LFS/457	Temporary Warehouse for Storage of Water Pumps and Motors (3 Years)	REC	31.3.2023
9	A/YL-LFS/469	Temporary Warehouse for Storage of Hardware Accessories (3 Years)	REC	23.6.2023 (Revoked on 23.12.2024)
10	A/YL-LFS/478	Proposed Temporary Warehouse for Storage of Vehicle Parts and Construction Materials (3 Years)	REC	11.8.2023 (Revoked on 11.2.2024)
11	A/YL-LFS/482	Temporary Warehouse for Storage of Hardware Accessories (3 Years)	REC	11.9.2023 (Revoked on 11.6.2025)
12	A/YL-LFS/490	Proposed Temporary Warehouse for Storage of Miscellaneous Goods (3 Years)	REC	27.10.2023 (Revoked on 27.10.2024)
13	A/YL-LFS/497	Proposed Temporary Warehouse for Storage of Construction Materials (3 Years)	REC	22.12.2023 (Revoked on 22.9.2025)
14	A/YL-LFS/498	Proposed Temporary Warehouse for Storage of Vehicle Parts and Construction Materials (3 Years)	REC	22.12.2023 (Revoked on 22.6.2025)
15	A/YL-LFS/510	Renewal of Planning Approval for Temporary Warehouse for Storage of Plastic and Retail of Plastic Pellet (3 Years)	REC	5.4.2024
16	A/YL-LFS/538	Proposed Temporary Warehouse for Storage of Hardware Accessories (3 Years)	REC	20.12.2024
17	A/YL-LFS/554	Proposed Temporary Warehouse for Storage of Vehicle Parts and Construction Materials (3 Years)	REC	5.9.2025
18	A/YL-LFS/557	Proposed Temporary Warehouse for Storage of Building Materials (3 Years)	REC	20.6.2025
19	A/YL-LFS/558	Proposed Temporary Warehouse (excluding Dangerous Goods Godown) with Ancillary Office (3 Years)	REC	4.7.2025

**Government Departments' General Comments**

**1. Land Administration**

Comments of the District Lands Officer/Yuen Long, Lands Department (DLO/YL, LandsD):

- (a) The Site comprises Old Schedule Agriculture Lots (OSALs) held under Block Government Lease which contains the restriction that no structures are allowed to be erected without the prior approval of the Government.
- (b) The following lots within the Site are covered by Short Term Waivers (STW):

Lot No. (D.D.129)	STW No.	Use
1684, 1685 & 1686	5735	Temporary Warehouse for Storage of Construction Materials and any ancillary uses as may be approved by DLO/YL

- (c) The applicant should note his advisory comments at **Appendix IV**.

**2. Traffic**

- (i) Comments of the Commissioner for Transport (C for T):

- (a) She has no adverse comment on the application from traffic engineering perspective.
- (b) The applicant should note her advisory comments at **Appendix IV**.

- (ii) Comments of the Chief Highway Engineer/New Territories West, Highways Department (CHE/NTW, HyD):

- (a) He has no objection on the application from highway maintenance perspective.
- (b) The applicant should note his advisory comments at **Appendix IV**.

**3. Environment**

Comments of the Director of Environmental Protection (DEP):

- (a) He has no objection to the application from environmental planning perspective since no heavy vehicle or dusty operation would be involved.
- (b) There is no substantiated environmental complaint pertaining to the application site (the Site) in the past three years.
- (c) The applicant should note his advisory comments at **Appendix IV**.

#### 4. Landscaping

Comments of the Chief Town Planner/Urban Design and Landscape, Planning Department (CTP/UD&L, PlanD):

- (a) She has no adverse comment on the application from the landscape planning perspective.
- (b) According to the aerial photo taken in December 2025, the Site is situated in area of rural coastal plain characterised by temporary structures and open storage to the north and tree clusters to the east and west of the Site. The Site is formed with temporary structures. As no distinctive landscape resources are observed within the Site, no significant adverse landscape impact arising from the applied use is anticipated.

#### 5. Drainage

Comments of the Chief Engineer/Mainland North, Drainage Services Department (CE/MN, DSD):

- (a) He has no objection in principle to the application from drainage point of view.
- (b) According to the applicant's submission, the existing drainage facilities which was implemented under the last previous application No. A/YL-LFS/442 will be maintained for the applied use. Should the Board consider that the application is acceptable from planning point of view, a condition should be stipulated requiring the applicant to maintain the existing drainage facilities and submit a condition record of the existing drainage facilities to the satisfaction of his department.
- (c) The applicant should note his advisory comments at **Appendix IV**.

#### 6. Fire Safety

Comments of the Director of Fire Services (D of FS):

- (a) He has no objection in principle to the proposal subject to fire service installations and water supplies for firefighting being provided to his satisfaction.
- (b) The applicant should note his advisory comments at **Appendix IV**.

#### 7. Building Matters

Comments of the Chief Building Surveyor/New Territories West, Buildings Department (CBS/NTW, BD):

- (a) As there is no record of approval granted by the Building Authority (BA) for the existing structures at the Site, he is not in a position to offer comments on its suitability for the use proposed in the application.
- (b) It is noted that two structures are proposed in the application. Before any new building works (including containers/open sheds as temporary buildings, demolition and land filling, etc.) are to be carried out on the Site, prior approval and consent of

the BA should be obtained, otherwise they are unauthorized building works (UBW) under the Buildings Ordinance (BO). An Authorized Person should be appointed as the co-ordinator for the proposed building works in accordance with the BO.

- (c) The applicant should note his advisory comments at **Appendix IV**.

#### **8. Project Interface**

Comments of the Project Manager (West), Civil Engineering and Development Department (PM(W), CEDD):

- (a) The Site falls within the study area of Lau Fau Shan Development under the consultancy Agreement No. CE 5/2024 (CE) "Developments at Lau Fau Shan, Tsim Bei Tsui and Pak Nai areas - Investigation", which is the Investigation Study and jointly commissioned by PlanD and CEDD. The implementation programme and land resumption/clearance programme of the Lau Fau Shan Development is currently being reviewed under the Investigation Study and subject to change.
- (b) If the planning application is granted, notwithstanding its validity period, the applicant should note his advisory comments at **Appendix IV**.

#### **9. District Officer's Comments**

Comments of the District Officer (Yuen Long), Home Affairs Department (DO(YL), HAD):

His office has not received any feedback from locals.

#### **10. Other Departments' Comments**

The following government departments have no objection to/no comment on the application:

- (a) Chief Engineer/Construction, Water Supplies Department (CE/C, WSD);
- (b) Chief Engineer/Land Works, Civil Engineering and Development Department (CE/LW, CEDD);
- (c) Head of Geotechnical Engineering Office, Civil Engineering and Development Department (H(GEO), CEDD);
- (d) Commissioner for Transport (C for T);
- (e) Director of Leisure and Cultural Services Department (DLCS); and
- (f) Director of Agriculture, Fisheries and Conservation (DAFC).

**Recommended Advisory Clauses**

- (a) prior planning permission should have been obtained before commencing the applied development at the application site (the Site);
- (b) to resolve any land issues relating to the development with the concerned owner(s) of the Site;
- (c) to note the comments of the District Lands Officer/Yuen Long, Lands Department (DLO/YL, LandsD) that the owner(s) shall apply to LandsD for STW(s) to permit the structure(s) erected or to be erected within the subject lots and apply for modification of STW(s) where appropriate. The application(s) for STW(s) and modification of STW(s) will be considered by the Government in its capacity as a landlord and there is no guarantee that it/they will be approved. The STW(s), if approved, will be subject to such terms and conditions including the payment of waiver fee, rent and administrative fee as considered appropriate by LandsD. Besides, given the proposed use is temporary in nature, only erection of temporary structure(s) will be considered;
- (d) to note the comments of the Commissioner for Transport (C for T) that sufficient manoeuvring space shall be provided within the Site. No vehicles are allowed to queue back to public roads or reverse onto/from public roads. The local track leading to the Site is not under Transport Department's purview. The applicant shall obtain consent of the owners/managing departments of the local track for using it as the vehicular access to the Site;
- (e) to note the comments of the Chief Highway Engineer/New Territories West, Highways Department (CHE/NTW, HyD) that the proposed vehicular access should be commented by the Transport Department (TD). The local access connecting to Deep Bay Road is not and will not be maintained by HyD and HyD will not take up the maintenance of the access road;
- (f) to note the comments of the Director of Environmental Protection (DEP) that:
  - (i) to follow the latest "Code of Practice on Handling the Environmental Aspects of Temporary Uses and Open Storage Sites";
  - (ii) to follow the relevant guidelines and requirements in relevant Professional Persons Environmental Consultative Committee Practice Notes (ProPECCPNs). If septic tank and soakaway system will be used in case of unavailability of public sewer, its design and construction shall follow the requirements of ProPECC PN 1/23 "Drainage Plans subject to Comment by the Environmental Protection Department" including completion of percolation test and certification by Authorized Person;
  - (iii) to provide adequate supporting infrastructure/facilities for proper collection, treatment and disposal of waste/wastewater generated from the proposed use; and
  - (iv) to meet the statutory requirements under relevant environmental legislation;
- (g) to note the comments of the Chief Engineer/Mainland North (CE/MN, DSD) that:
  - (i) to maintain the drainage facilities implemented under Application No. A/YL-LFS/442; and

- (ii) to submit records of the existing drainage facilities on site to the satisfaction of the Director of Drainage Services or of the Town Planning Board;
- (h) to note the comments of the Project Manager (West), Civil Engineering and Development Department (PM(W), CEDD) that the Site falls within the study area of Lau Fau Shan Development under the consultancy Agreement No. CE 5/2024 (CE) "Developments at Lau Fau Shan, Tsim Bei Tsui and Pak Nai Areas - Investigation", which is the Investigation Study and jointly commissioned by the Planning Department and CEDD. The implementation and land resumption/clearance programme of the Lau Fau Shan Development is currently being reviewed under the Investigation Study and subject to change. The applicant should be reminded that the Site may be resumed at any time during the planning approval period for potential development project and advised not to carry out any substantial works therein;
- (i) to note the comments of the Director of Fire Services (D of FS) that:
  - (i) in consideration of the design/nature of the application, FSIs are anticipated to be required. Therefore, the applicant is advised to submit relevant layout plans incorporated with the proposed FSIs to his Department for approval;
  - (ii) the layout plans should be drawn to scale and depicted with dimensions and nature of occupancy;
  - (iii) the location of where the proposed FSI to be installed should be clearly marked on the layout plans; and
  - (iv) if the proposed structures are required to comply with the Buildings Ordinance (BO) (Cap. 123), detailed fire service requirements will be formulated upon receipt of formal submission of general building plans; and
- (j) to note the comments of the Chief Building Surveyor/New Territories West, Buildings Department (CBS/NTW, BD) that:
  - (i) the Site shall be provided with means of obtaining access thereto from a street and emergency vehicular access in accordance with Regulations 5 and 41D of the Building (Planning) Regulations (B(P)R) respectively;
  - (ii) the Site does not abut on a specified street of not less than 4.5m wide and its permitted development intensity shall be determined under Regulation 19(3) of the B(P)R at the building plan submission stage;
  - (iii) if the existing structure is erected on leased land without the approval of the Buildings Authority (BA), they are unauthorized building works (UBW) under the BO and should not be designated for any proposed use under the application;
  - (iv) for UBW erected on leased land, enforcement action may be taken by BD to effect their removal in accordance with the prevailing enforcement policy against UBW as and when necessary. The granting of any planning approval should not be construed as an acceptance of any existing building works or UBW on the Site under the BO;
  - (v) any temporary shelters or converted containers for office, storage, washroom or other uses are considered as temporary buildings and are subject to the control of Part VII of the B(P)R; and

(vi) detailed checking under the BO will be carried out at building plan submission stage.

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**tpbpd/PLAND**

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寄件者: [REDACTED]  
寄件日期: 2026年03月26日星期四 2:53  
收件者: tpbpd/PLAND  
主旨: A/YL-LFS/589 DD 129 Lau Fau Shan Recreation  
類別: Internet Email

Dear TPB Members,

12. The application site is subject to a previous planning permission No. A/YL-LFS/442 approved for warehouse use. **The applicant failed to comply with some of the approval conditions** imposed to the last planning permission because there was a change of ownership of the application site so that there is uncertainty in investing to the site. In view of that the uncertainty was gone, the applicant would comply with the planning conditions to be imposed to the current application should Town Planning Board sees fit.

442 was approved on 11 Nov 2022 but the data provided on OZP link does not indicate that it was subsequently revoked.

Why not?

Did operations commence? In which case the applicant is resorting to an excuse for failing to fulfill conditions.

Members should question this.

Mary Mulvihill

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**From:** [REDACTED]  
**To:** tpbpd <tpbpd@pland.gov.hk>  
**Date:** Monday, 12 September 2022 3:23 AM HKT  
**Subject:** A/YL-LFS/442 DD 129 Lau Fau Shan Recreation

A/YL-LFS/442

Lots 1684 (Part), 1685 (Part) and 1686 (Part) in D.D. 129, Lau Fau Shan

Site area: About 1,048sq.m

Zoning: "Recreation"

Applied use: Warehouse for Storage of Construction Materials / 2 Vehicle Parking

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Dear TPB Members,

There is no history of previous approvals but the operation appears to be linked to that of 368 on the adjacent lots. PlanD should inform members of the history of failure to fulfill conditions at this site.

In view of the pledges to phase out browfield use and that there is no history of approved operations, members should reject this application in line with policy pledges.

Mary Mulvihill