This document is received on 1 FFB 2025. The Town Planning Board will formally acknowledge the date of receipt of the application only upon receipt of all the required information and documents.

<u>Form No. S16-III</u> 表格第 S16-III 號

APPLICATION FOR PERMISSION **UNDER SECTION 16 OF** THE TOWN PLANNING ORDINANCE (CAP. 131)

根據《城市規劃條例》(第131章) 第16條遞交的許可申請

Applicable to Proposal Only Involving Temporary Use/Development of Land and/or Building Not Exceeding 3 Years in Rural Areas or Regulated Areas, or Renewal of Permission for such Temporary Use or Development*

適用於祇涉及位於鄉郊地區或受規管地區土地上及/或建築物內進行 為期不超過三年的臨時用途/發展或該等臨時用途/發展的許可續期的建議*

*Form No. S16-I should be used for other Temporary Use/Development of Land and/or Building (e.g. temporary use/developments in the Urban Area) and Renewal of Permission for such Temporary Use or Development. *其他土地上及/或建築物內的臨時用途/發展(例如位於市區內的臨時用途或發展)及有關該等臨時用途/發

Applicant who would like to publish the notice of application in local newspapers to meet one of the Town Planning Board's requirements of taking reasonable steps to obtain consent of or give notification to the current land owner, please refer to the following link regarding publishing the notice in the designated newspapers: https://www.tpb.gov.hk/en/plan_application/apply.html

申請人如欲在本地報章刊登申請通知,以採取城市規劃委員會就取得現行土地擁有人的同意或通知現行 土地擁有人所指定的其中一項合理步驟,請瀏覽以下網址有關在指定的報章刊登通知: https://www.tpb.gov.hk/tc/plan_application/apply.html

General Note and Annotation for the Form 填寫表格的一般指引及註解

"Current land owner" means any person whose name is registered in the Land Registry as that of an owner of the land to which the application relates, as at 6 weeks before the application is made 「現行土地擁有人」指在提出申請前六星期,其姓名或名稱已在土地註冊處註冊為該申請所關乎的

土地的擁有人的人

- & Please attach documentary proof 請夾附證明文件
- ^ Please insert number where appropriate 請在適當地方註明編號

Please fill "NA" for inapplicable item 請在不適用的項目填寫「不適用」

Please use separate sheets if the space provided is insufficient 如所提供的空間不足,請另頁說明 Please insert a 「レ」 at the appropriate box 請在適當的方格內上加上「レ」號

2500180	23/1	(
For Official Use Only 請勿填寫此欄	Application No. 申請編號 Date Received 收到日期	1 1 FEB 2025

- The completed form and supporting documents (if any) should be sent to the Secretary, Town Planning Board (the Board), 1571, NOIMI Tollik Government Offices, 555 Java Koau, Noimi Folik, Fiolig Kolig. 申請人須把填妥的申請表格及其他支持申請的文件 (倘有),送交香港北角渣華道 333 號北角政府合署 15 樓城市規劃委員會(下稱「委員會」)秘書收。
- 2. Please read the "Guidance Notes" carefully before you fill in this form. The document can be downloaded from the Board's website at http://www.tpb.gov.hk/. It can also be obtained from the Secretariat of the Board at 15/F, North Point Government Offices, 333 Java Road, North Point, Hong Kong (Tel: 2231 4810 or 2231 4835), and the Planning Enquiry Counters of the Planning Department (Hotline: 2231 5000) (17/F, North Point Government Offices, 333 Java Road, North Point Hong Kong and 14/F. She Tin Government Offices, 1 Shaung Wo Che Road, She Tin New Territories) 上禾輋路 1 號沙田政府合署 14 樓)索取。
 - This form can be downloaded from the Board's website, and obtained from the Secretariat of the Board and the Planning Enquiry Counters of the Planning Department.

 The form should be typed or completed in block letters.

 The processing The form should be typed or completed in block letters. The processing of the application may be refused if the required information or the required copies are incomplete. 此表格可從委員會的網頁下載,亦可向委員會秘書處及規劃署的規劃資料查詢處索取。申請人須以打印方式或以正楷填寫表格。如果申請人所提交的資料或文件副本不齊全,委員會可拒絕處理有關申請。

Name of Applicant 申請人姓名/名稱 1.

(□Mr. 先生 /□Mrs. 夫人 /□Miss 小姐 /□Ms. 女士 / ☑ Company 公司 /□Organisation 機構)

Tak Shing Development Investment Limited 德承發展投資有限公司

Name of Authorised Agent (if applicable) 獲授權代理人姓名/名稱(如適用) 2.

(□Mr. 先生 /□Mrs. 夫人 /□Miss 小姐 /□Ms. 女士 / ☑ Company 公司 /□Organisation 機構)

R-riches Property Consultants Limited 盈卓物業顧問有限公司

3.	Application Site 申請地點	
(a)	Full address / location / demarcation district and lot number (if applicable) 詳細地址/地點/丈量約份及地段號碼(如適用)	Lots 2219 (Part) and 2220 (Part) in D.D. 92, Kwu Tung South, Sheung Shui, New Territories
(b)	Site area and/or gross floor area involved 涉及的地盤面積及/或總樓面面積	☑Site area 地盤面積 12,156 sq.m 平方米☑About 約 ☑Gross floor area 總樓面面積 17,228 sq.m 平方米☑About 約
(c)) Area of Government land included (if any) 所包括的政府土地面積(倘有)	N/A sq.m 平方米 口About 約

(d)	Name and number of the statutory plan(s) 有關法定圖則的名稱及		Draft Kwu Tung South Outline Zoning Plan No. S/NE-KTS/21			
(e)	Land use zone(s) involve 涉及的土地用途地帶	d 	"Recreation" ("REC")			
(f)	Current use(s) 現時用途		Vacant (If there are any Government, institution or community facilities, please il plan and specify the use and gross floor area)			
			D有任何政府、機構或社區設施,請在圖則上顯示,並註明用途及總樓面面積) ———————————————————————————————————			
4.	"Current Land Own	ner" of A	pplication Site 申請地點的「現行土地擁有人」			
The	applicant 申請人 —					
	is the sole "current land or 是唯一的「現行土地擁有	wner"#& (pl 与人」 ^{#&} (部	ease proceed to Part 6 and attach documentary proof of ownership). 青繼續填寫第 6 部分,並夾附業權證明文件)。			
	is one of the "current land 是其中一名「現行土地技	owners"#& 雍有人」 ^{#&}	(please attach documentary proof of ownership). (請夾附業權證明文件)。			
V	is not a "current land own 並不是「現行土地擁有)					
	The application site is entirely on Government land (please proceed to Part 6). 申請地點完全位於政府土地上(請繼續填寫第 6 部分)。					
5.	5. Statement on Owner's Consent/Notification					
			和土地擁有人的陳述			
(a)						
(b)	The applicant 申請人 -					
	• •	(s) of	"current land owner(s)".			
	已取得					
	Details of consent of "current land owner(s)" obtained 取得「現行土地擁有人」 #同意的詳情					
	「租行土地擁有	Registry wh	/address of premises as shown in the record of the Land pere consent(s) has/have been obtained E冊處記錄已獲得同意的地段號碼/處所地址	7)		

	(Please use separate sheets if the space of any box above is insufficient. 如上列任何方格的空間不足,請另頁說明)					

	Details of the "current land owner(s)" notified 已獲通知「現行土地擁有人」"的詳細資料						
	No. of 'Current Land Owner(s)' 「現行土地擁 有人」數目	Lot number/address of premises as snown in the record of the Land Registry where notification(s) has/have been given 根據土地計冊跨記錄已發出海如約地段跨運 / 房所地址	Date of notification given (DD/MM/YYYY) 通知日期(日/月/年)				
	-		<u>.</u>				
		sheets if the space of any box above is insufficient. 如上列任何方格的空向 ble steps to obtain consent of or give notification to owner(s):	間不足,請另頁說明)				
 ✓	已採取合理步驟以	以取得土地擁有人的同意或向該人發給通知。詳情如下:					
	Reasonable Steps to Obtain Consent of Owner(s) 取得土地擁有人的同意所採取的合理步驟						
	sent request for consent to the "current land owner(s)" on(DD/MM/YYYY) ^{#&} 於(日/月/年)向每一名「現行土地擁有人」"郵遞要求同意書 ^{&}						
	Reasonable Steps to Give Notification to Owner(s) 向土地擁有人發出通知所採取的合理步驟						
	-	in a prominent position on or near application site/premises on (DD/MM/YYYY)&					
	於	(日/月/年)在申請地點/申請處所或附近的顯明位置則	占出關於該申請的通知				
	office(s) or ru	☑ sent notice to relevant owners' corporation(s)/owners' committee(s)/mutual aid committee(s)/management office(s) or rural committee on09/01/2025(DD/MM/YYYY) ^{&} 於(日/月/年)把通知寄往相關的業主立案法團/業主委員會/互助委員會或管理					
	-	(日/月/年)把通知寄往相關的業主立案法團/業主委员 的鄉事委員會 ^{&}	員會/互助委員會或管				
	Others 其他						
	□ others (please specify) 其他(請指明)						
	•••						
	· · · · · · · · · · · · · · · · · · ·	····					

Proposed operating hours 擬議營運時間 09:00 to 19:00 from Monday to Saturday. No operation on Sunday and public holiday.						
Yes (d) Any vehicular access to the site/subject building? 是否有車路通往地盤/ 有關建築物?			 ☑ There is an existing access. (please indicate the street name, where appropriate) 有一條現有車路。(講註明車路名稱(如適用)) Accessible from Kam Tsin Road via a local access □ There is a proposed access. (please illustrate on plan and specify the width) 有一條擬議車路。(請在圖則顯示,並註明車路的闊度) 			
		No 否				
(e)	(If necessary, please u	se separate shee for not providin	證			
(ii)	Does the development proposal involve alteration of existing building? 擬議發展計劃是否包括現有建築物的改動? Does the development proposal involve the operation on the right? 擬議發展是否涉及右列的工程?	No 否 ☑ Yes 是 ☐ (Please provide details in in it is it is it is it. It is			
(iii)	Would the development proposal cause any adverse impacts? 擬議發展計劃會否造成不良影響?	Landscape Imp Tree Felling Visual Impact	交通 Yes 會 No 不會 ☑ Ily 對供水 Yes 會 No 不會 ☑ 對排水 Yes 會 No 不會 ☑ Ily 對供水 Yes 會 No 不會 ☑ Ily 對供水 Yes 會 No 不會 ☑ Ily 可以表面 Yes 會 No 不會 ☑ Ily 可以表面 Yes 會 Ily or 不會 ☑ Ily 可以表面 Yes 會 Ily or 不會 ☑			

Please state measure(s) to minimise the impact(s). For tree felling, please state the number, diameter at breast height and species of the affected trees (if possible) 請註明盡量減少影響的措施。如涉及砍伐樹木,請說明受影響樹木的數目、及胸高度的樹幹直徑及品種(倘可) (B) Renewal of Permission for Temporary Use or Development in Rural Areas or Regulated Areas 位於鄉郊地區或受規管地區臨時用途/發展的許可續期				
(a) Application number to the permission relates 與許可有關的申請編號	which	A//		
(b) Date of approval 獲批給許可的日期		(DD 日/MM 月/YYYY 年)		
(c) Date of expiry 許可屆滿日期		(DD 日/MM 月/YYYY 年)		
(d) Approved use/developmer 已批給許可的用途/發見				
(e) Approval conditions 附帶條件		□ The permission does not have any approval condition 許可並沒有任何附帶條件 □ Applicant has complied with all the approval conditions 申請人已履行全部附帶條件 □ Applicant has not yet complied with the following approval condition(s): 申請人仍未履行下列附帶條件: □ Reason(s) for non-compliance: 仍未履行的原因: □ (Please use separate sheets if the space above is insufficient) (如以上空間不足,請另頁說明)		
(f) Renewal period sought 要求的續期期間		□ year(s) 年 □ month(s) 個月		

7. Justifications 理由
The applicant is invited to provide justifications in support of the application. Use separate sheets if necessary. 現請申請人提供申請理由及支持其申請的資料。如有需要,請另頁說明)。
Please refer to the supplementary statement.

8. Declaration 聲明				
I hereby declare that the particulars given in this application are correct and true to the best of my knowledge and belief. 本人謹此聲明,本人就這宗申請提交的資料,據本人所知及所信,均屬真實無誤。				
I hereby grant a permission to the Board to copy all the materials submitted in this application and/or to upload such materials to the Board's website for browsing and downloading by the public free-of-charge at the Board's discretion. 本人現准許委員會酌情將本人就此申請所提交的所有資料複製及/或上載至委員會網站,供公眾免費瀏覽或下載。				
Signature □ Applicant 申請人 / ☑ Authorised Agent 獲授權代理人 簽署 Michael WONG				
Name in Block Letters Position (if applicable) 姓名(請以正楷填寫) 職位 (如適用)				
Professional Qualification(s) □ Member 會員 / □ Fellow of 資深會員 □ HKIP 香港規劃師學會 / □ HKIA 香港建築師學會 / □ HKIS 香港測量師學會 / □ HKIE 香港工程師學會 / □ HKILA 香港園境師學會 / □ HKIUD 香港城市設計學會 □ RPP 註冊專業規劃師 Others 其他				
on behalf of 代表 R-riches Property Consultants Limited				
Date 日期 22/01/2025 (DD/MM/YYYY 日/月/年)				
Remark 備註				
KOMark [用LL				

The materials submitted in this application and the Board's decision on the application would be disclosed to the public. Such materials would also be uploaded to the Board's website for browsing and free downloading by the public where the Board considers appropriate.

委員會會向公眾披露申請人所遞交的申請資料和委員會對申請所作的決定。在委員會認為合適的情況下,有關申請資料亦會上載至委員會網頁供公眾免費瀏覽及下載。

Warning 警告

Any person who knowingly or wilfully makes any statement or furnish any information in connection with this application, which is false in any material particular, shall be liable to an offence under the Crimes Ordinance. 任何人在明知或故意的情况下,就這宗申請提出在任何要項上是虛假的陳述或資料,即屬違反《刑事罪行條例》。

Statement on Personal Data 個人資料的聲明

- 1. The personal data submitted to the Board in this application will be used by the Secretary of the Board and Government departments for the following purposes:
 - 委員會就這宗申請所收到的個人資料會交給委員會秘書及政府部門,以根據《城市規劃條例》及相關的城市規劃委員會規劃指引的規定作以下用途:
 - (a) the processing of this application which includes making available the name of the applicant for public inspection when making available this application for public inspection; and 處理這宗申請,包括公布這宗申請供公眾查閱,同時公布申請人的姓名供公眾查閱;以及
 - (b) facilitating communication between the applicant and the Secretary of the Board/Government departments. 方便申請人與委員會秘書及政府部門之間進行聯絡。
- 2. The personal data provided by the applicant in this application may also be disclosed to other persons for the purposes mentioned in paragraph 1 above.
 - 申請人就這宗申請提供的個人資料,或亦會向其他人士披露,以作上述第1段提及的用途。
- 3. An applicant has a right of access and correction with respect to his/her personal data as provided under the Personal Data (Privacy) Ordinance (Cap. 486). Request for personal data access and correction should be addressed to the Secretary of the Board at 15/F, North Point Government Offices, 333 Java Road, North Point, Hong Kong. 根據《個人資料(私隱)條例》(第 486 章)的規定,申請人有權查閱及更正其個人資料。如欲查閱及更正個人資料,應向委員會秘書提出有關要求,其地址為香港北角渣華道 333 號北角政府合署 15 樓。

Gist of Application	申請摘要
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(Please provide details in both English and Chinese <u>as far as possible</u>. This part will be circulated to relevant consultees, uploaded to the Town Planning Board's Website for browsing and free downloading by the public and available at the Planning Enquiry Counters of the Planning Department for general information.)

(請<u>盡量以英文及中文填寫。此部分將會發送予相關諮詢人士、上載至城市規劃委員會網頁供公眾免費瀏覽及下載及於規劃署規劃資料查詢處供一般參閱。)</u>

1 4人人人人人人人人人人人人人人人人人人人人人人人人人人人人人人人人人人人人	即東州巨的姬宗 似多风。)					
Application No. 申請編號	(For Official Use Only) (請勿填寫此欄)					
Location/address 位置/地址	Lots 2219 (Part) and 2220 (Part) in D.D. 92, Kwu Tung South, Sheung Shui, New Territories					
Site area	12,156 sq. m 平方米 🛭 About 約					
地盤面積	(includes Government land of包括政府土地 N/A sq. m 平方米 □ About 約)					
Plan 圖則	Draft Kwu Tung South Outline Zoning Plan No. S/NE-KTS/21					
Zoning 地帶	"Recreation" ("REC")					
Type of Application 申請類別	☑ Temporary Use/Development in Rural Areas or Regulated Areas for a Period of 位於鄉郊地區或受規管地區的臨時用途/發展為期					
	☑ Year(s) 年3 □ Month(s) 月					
	□ Renewal of Planning Approval for Temporary Use/Development in Rural Areas or Regulated Areas for a Period of 位於鄉郊地區或受規管地區臨時用途/發展的規劃許可續期為期					
	□ Year(s) 年 □ Month(s) 月					
Applied use/ development 申請用途/發展	Proposed Temporary Warehouse (excluding Dangerous Goods Godown) with Ancillary Facilities for a Period of 3 Years					

(i)	Gross floor area		sq.r	n 平方米	Plot R	latio 地積比率
	and/or plot ratio 總樓面面積及/或 地積比率	Domestic 住用	N/A	□ About 約 □ Not more than 不多於	N/A	□About 約 □Not more than 不多於
		Non-domestic 非住用	17,228	☑ About 約 □ Not more than 不多於	1.4	☑About 約 □Not more than 不多於
(ii)	No. of blocks 幢數	Domestic 住用		N/A	A	,
		Non-domestic 非住用		1		
(iii)	Building height/No. of storeys 建築物高度/層數	Domestic 住用		N/A	□ (Not	m 米 more than 不多於)
				N/A	□ (Not	Storeys(s) 層 more than 不多於)
		Non-domestic 非住用		15 (about)	☐ (Not	m 米 more than 不多於)
				2	□ (Not	Storeys(s) 層 more than 不多於)
(iv)	Site coverage 上蓋面積			71	%	☑ About 約
(v)	No. of parking spaces and loading / unloading spaces 停車位及上落客貨車位數目	Medium Goods V Heavy Goods Ve Others (Please Sp	ng Spaces 私家ng Spaces 電罩icle Parking Sp Yehicle Parking Sp Vehicle Parking Sp Hicle Parking Specify) 其他(i	ই車車位 軍車車位 aces 輕型貨車泊車 Spaces 中型貨車泊 paces 重型貨車泊車 請列明)	車位	4 N/A N/A N/A N/A
		Total no. of vehicl 上落客貨車位/ Taxi Spaces 的士 Coach Spaces 旅 Light Goods Veh Medium Goods V Heavy Goods Ve Others (Please Sp Container Vehicle	·停車處總數 :車位 遊巴車位 icle Spaces 輕 /chicle Spaces hicle Spaces 重	型貨車車位 中型貨車位 型貨車車位		6 N/A N/A N/A N/A N/A

Master layout plan(s)/Layout plan(s) 總綱發展藍圖/布局設計圖		<u>Chinese</u> 中文	English 英文
Master layout plan(s)/Layout plan(s) 總綱發展藍圖/布局設計圖	Plans and Drawings 圖則及繪圖	•	
Block plan(s) 樓字位置圖 Floor plan(s) 樓字中面圖 Sectional plan(s) 截視圖 Elevation(s) 立視圖 Photomontage(s) showing the proposed development 顯示擬議發展的合成照片 Master landscape plan(s)/Landscape plan(s) 圆境設計總圖/園境設計圖 Others (please specify) 其他 (請註明) Location plan, Zoning plan, Plan showing land status of the site and Swept path analysis, Drainage proposal, Fire service installations proposal Reports 報告書 Planning Statement/Justifications 規劃綱領/理據 Environmental assessment (noise, air and/or water pollutions) 環境評估(噪音、空氣及/或水的污染) Traffic impact assessment (on vehicles) 就車輛的交通影響評估 Uisual impact assessment 視覺影響評估 Landscape impact assessment 景觀影響評估 Landscape impact assessment 景觀影響評估 Drainage impact assessment 非次影響評估 Sewerage impact assessment 排次影響評估 Bewerage impact assessment 排次影響評估 Bewerage impact assessment 無險評估			
Sectional plan(s) 模字中间圖 Sectional plan(s) 截視圖 □ □ □ Elevation(s) 立視圖 □ □ □ □ □ □ □ □ □ □ □ □ □ □ □ □ □ □ □			
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Note: The information in the Gist of Application above is provided by the applicant for easy reference of the general public. Under no circumstances will the Town Planning Board accept any liabilities for the use of the information nor any inaccuracies or discrepancies of the information provided. In case of doubt, reference should always be made to the submission of the applicant.

註: 上述申請摘要的資料是由申請人提供以方便市民大眾参考。對於所載資料在使用上的問題及文義上的歧異,城市規劃委員會概不負責。若有任何疑問,應查閱申請人提交的文件。

Supplementary Statement

1) Background

- 1.1 The applicant seeks planning permission from the Town Planning Board (the Board) to use *Lots* 2219 (Part) and 2220 (Part) in D.D. 92, Kwu Tung South, Sheung Shui, New Territories (the Site) for 'Proposed Temporary Warehouse (Excluding Dangerous Goods Godown (D.G.G.)) with Ancillary Facilities for a Period of 3 Years' (proposed development) (Plan 1).
- 1.2 The applicant, a construction and engineering company, intends to use the Site to continue operating the warehouse for the storage of the company's construction materials in order to support the growing demand in the construction industry and the development of various New Development Areas across the New Territories.

2) Planning Context

- 2.1 The Site falls within an area zoned "Recreation" ("REC") on the Draft Kwu Tung South Outline Zoning Plan (OZP) No. S/NE-KTS/21. According to the Notes of the OZP, the applied use is not a column one nor two use within the "REC" zone, which requires planning permission from the Board (Plan 2).
- 2.2 Although the applied use is not in line with the planning intention of "REC" zone, there is no existing or planned recreational development within the Site. Therefore, approval of the application on a temporary basis of 3 years would better utilize precious land resources, as well as to create new employment opportunities in Sheung Shui. Furthermore, the proposed development with low-rise structure is considered not incompatible with surrounding areas, which is dominated by temporary structures for warehouses, vehicle repair workshops, open storage and animal boarding establishments etc.
- 2.3 Portion of the Site has been occupied by open storage of construction materials before the first publication in the Gazette of the notice of the Kwu Tung South Interim Development Permission Area Plan No. IDPA/NE-KTS/1, hence, such operation is existing use. Since potential environmental nuisance (i.e. dust, air and noise impacts) may be arisen from the existing open storage use, the proposed structures would provide enclosed floor space for the applied use to minimize nuisance to the nearby environment.



- 2.4 The Site is the subject of a previously approved application (No. A/NE-KTS/517) for the same use submitted by the same applicant as the current application, which was approved by the Board on a temporary basis of 3 years in March 2023. Approval of the current application is in line with the Board's previous decision. When compared with the previous application, although the applied use, site area/boundary, number of structure and building height remain unchanged while the gross floor area (GFA), covered area and parking and loading/unloading (L/UL) spaces are slightly adjusted, within which the GFA of the warehouse (Structure B1) is increased from 17,208m² to 17,228m² (about) (i.e. +0.1%), whilst the number of parking spaces of private cars is reduce from 5 to 4 while the number of L/UL spaces is increased from 4 to 6. Such changes are intended to meet the operational needs.
- 2.5 The applicant has made effort to comply with the approval conditions of the previous application, details are shown at **Table 1** below:

Table 1 – Details of Compliance with Approval Conditions of the Previous Application

App	roval Conditions of Application No. A/NE-KTS/517	Date of Compliance
(0)	The design and provision of vehicular access, parking and	Partially complied
(e)	loading/unloading spaces and pedestrian facilities	with on 27.12.2023
(f)	The submission of a fire service installations (FSIs) proposal	6.9.2023
(g)	The implementation of the FSIs proposal	Not complied with
(h)	The submission of a drainage proposal	18.9.2023
(i)	The implementation of the drainage proposal	Not complied with

- 2.6 The applicant made submission of a revised run-in/out proposal to comply with approval condition (e) on 17.11.2023, which was considered partially acceptable by the Commissioner for Transport, 27.12.2023. As requested by Highways Department (HyD), a further proposal for relocation works of lamppost and a corresponding lighting improvement scheme are required to submit for his consideration. The applicant is currently seeking quotations from traffic contractors for the lighting improvement works. Upon obtaining planning permission from the Board, the applicant will proceed to submit the required proposal for HyD's approval, as well as to commence the implementation works for the accepted run-in/out proposal.
- 2.7 The applicant made submission of a FSIs proposal to comply with approval condition (f) on 02.08.2023, which was accepted by the Director of Fire Services on 06.09.2023. However, prior approval of Short Term Waiver (STW) is required for the erection of structures on Old Schedule Lots under Block Government Lease, on which the proposed FSIs will be installed. A

STW application was previously submitted to the District Lands Officer/North, Lands Department (LandsD) in April 2023 while the STW approval was granted by LandsD in May 2024. As such, the applicant did not have sufficient time to commence the implementation for FSIs to fulfill the compliance requirement, which led to the revocation of the planning permission in December 2024.

- 2.8 The applicant made submission of a drainage proposal to comply with approval condition (h) on 01.06.2023, which was accepted by the Chief Engineer/Mainland North, Drainage Services Department on 18.09.2023. Upon planning approval has been granted by the Board, the applicant will commence the implementation of the accepted drainage proposal.
- 2.9 In support of the application, the applicant has submitted the accepted drainage and run-in/out proposals under the previous application to minimize the potential adverse impact to the surrounding area, as well as an updated FSIs proposal to enhance fire safety of the proposed development (Appendices I to III). Upon obtaining planning permission from the Board, the applicant will continue to proceed with the implementation works of the accepted proposals.

3) Development Proposal

3.1 The Site occupies an area of 12,156 m² (about) (**Plan 3**). The operation hours of Site are Monday to Saturday from 09:00 to 19:00. No operation on Sunday and public holiday. One structure is proposed at the Site for warehouse (excluding D.G.G.), site office and washroom with total gross floor area (GFA) of 17,228 m² (about) (**Plan 4**). The ancillary site office is intended to provide indoor workspace for administrative staff to support the daily operation of the Site. It is estimated that the Site would be able to accommodate 10 staff. As the Site is proposed for 'warehouse' use with no shopfront, no visitor is anticipated at the Site. Details of development parameters are shown at **Table 1**.

Table 1 – Major Development Parameters

Application Site Area	12,156 m² (about)		
Covered Area	8,614 m² (about)		
Uncovered Area	3,542 m² (about)		
Plot Ratio	1.4 (about)		
Site Coverage	71% (about)		



Number of Structure	1	
Total GFA	17,228 m² (about)	
- Domestic GFA Not applicable		
- Non-Domestic GFA	17,228 m² (about)	
Building Height	15 m (about)	
No. of Storey	2	

- 3.2 The proposed warehouse is intended for storage of the company's construction materials (i.e. (e.g., bricks, tiles, glass etc.). No storage of dangerous goods, workshop, recycling, cleansing, dismantling and other workshop activities will be carried out at the Site during the planning approval period.
- 3.3 The Site has already been filled wholly with concrete for site formation of structures, parking, loading/unloading area and circulation space. As heavy loading of structures and vehicles would compact the existing soiled ground and weaken the ground surface, concrete site formation is required to meet the operation needs and that has been kept to minimal for the operation of the proposed development.
- 3.4 The Site is accessible from Kam Tsin Road via a local access (Plan 1). A total of 10 parking and loading/unloading (L/UL) spaces are provided at the Site (Plan 4). Details are shown at Table 2.

Table 2 – Parking and L/UL Provisions

Type of Space	No. of Space
Private Car Parking Space	4
- 2.5 m (W) x 5 m (L)	4
L/UL Space for Container Vehicle	6
- 3.5 m (W) x 16 m (L)	0

3.5 Sufficient space is provided for vehicles to smoothly manoeuvre within the Site to ensure that no vehicle will turn back onto the local access (**Plan 5**). As traffic generated and attracted by the proposed development is minimal (as shown at **Table 3**), adverse traffic impact should not be anticipated.

Table 3 – Estimated Trip Generation and Attraction

Time Period	PC		CV		2-Way
Time renou	In	Out	In	Out	Total
Trips at AM peak per hour	4	0	2	0	6
(09:00 – 10:00)	4	U	2	U	U
Trips at PM peak per hour	0	4	0	2	6
(18:00 – 19:00)	U	4	U	2	0
Traffic trip per hour	0	0	1	1	2
(10:00 – 18:00)	U	U	1	1	2

- 3.6 2.5m high solid metal wall will be erected along the site boundary to minimize potential nuisance to nearby sensitive receivers. The boundary wall will be installed properly by licensed contractor and maintenance will be conducted regularly to prevent misalignment off walls and to ensure that there is no gap or slit on boundary wall. In addition, 28 nos. of trees will be planted along the northern boundary of the Site as landscape buffer to minimize adverse visual impact to the adjoining residential development Casas Domingo.
- 3.7 The applicant will strictly follow the 'Code of Practice on Handling the Environmental Aspects of Temporary Uses and Open Storage Sites' issued by the Environmental Protection Department to minimize adverse environmental impacts and nuisance to the surrounding area. The applicant will strictly comply with all environmental protection/pollution control ordinances, i.e. Water Pollution Control Ordinance, Air Pollution Control Ordinance, Noise Control Ordinance etc. at all times during the planning approval period. The applicant will follow the Professional Persons Environmental Consultative Committee Practice Notes (ProPECCPNs) for sewage treatment at the Site.

4) Conclusion

- 4.1 The proposed development will not create significant nuisance to the surrounding areas. Adequate mitigation measures are provided, i.e. submission of the accepted drainage and run-in/out proposals and a fire service installations proposal, to mitigate any adverse impact arising from the proposed development (Appendices I to III).
- 4.2 In view of the above, the Board is hereby respectfully recommended to <u>approve</u> the subject application for 'Proposed Temporary Warehouse (Excluding Dangerous Goods Godown) with Ancillary Facilities for a Period of 3 Years'.



R-riches Property Consultants Limited January 2025



LIST OF PLANS

Plan 1	Location Plan
Plan 2	Plan Showing the Zoning of the Application Site
Plan 3	Plan Showing the Land Status of the Application Site
Plan 4	Layout Plan
Plan 5	Swept Path Analysis


APPENDICES


Appendix I Accepted Drainage Proposal of Application No. A/NE-KTS/517


Appendix II Accepted Run-in/out Proposal of Application No. A/NE-KTS/517


Appendix III Fire Service Installations Proposal




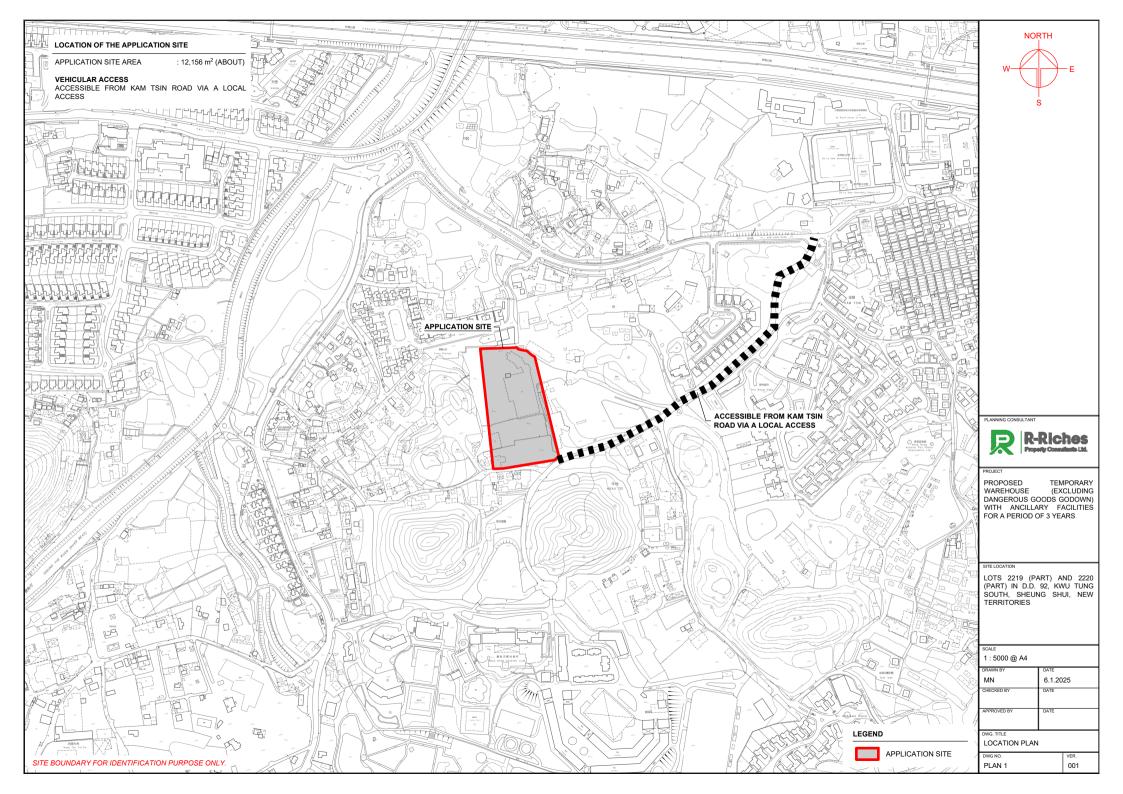

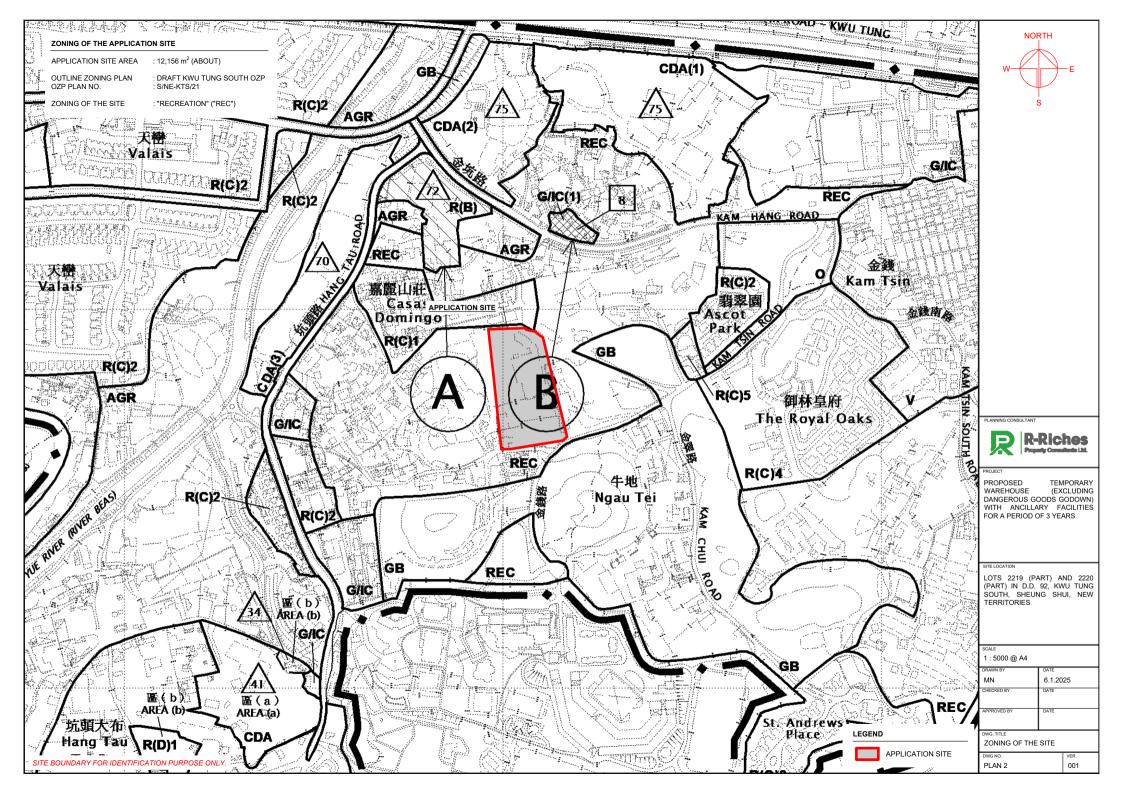

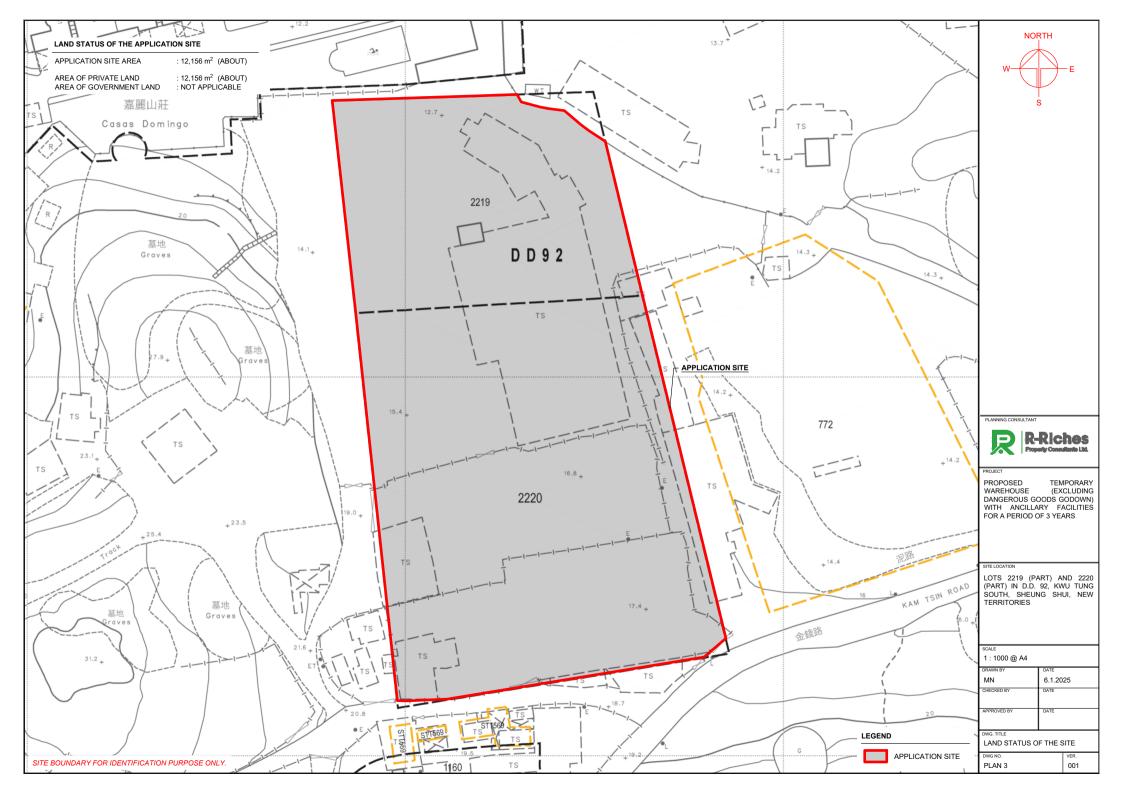

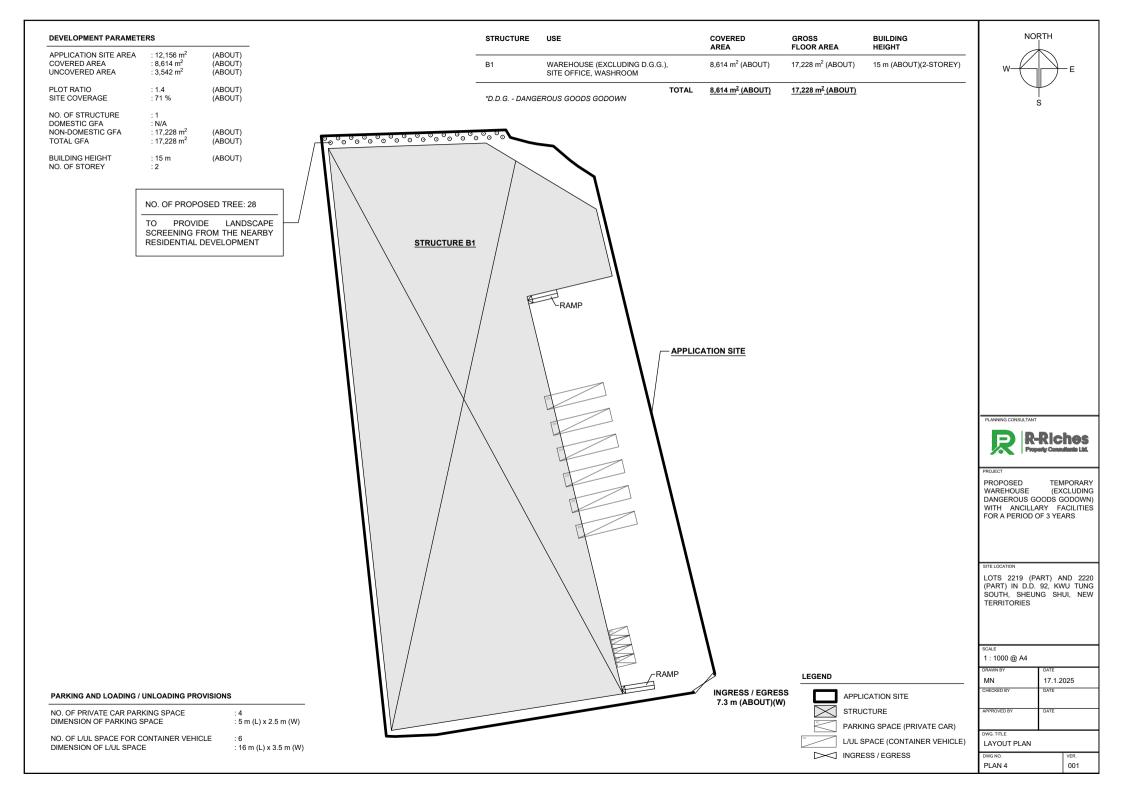

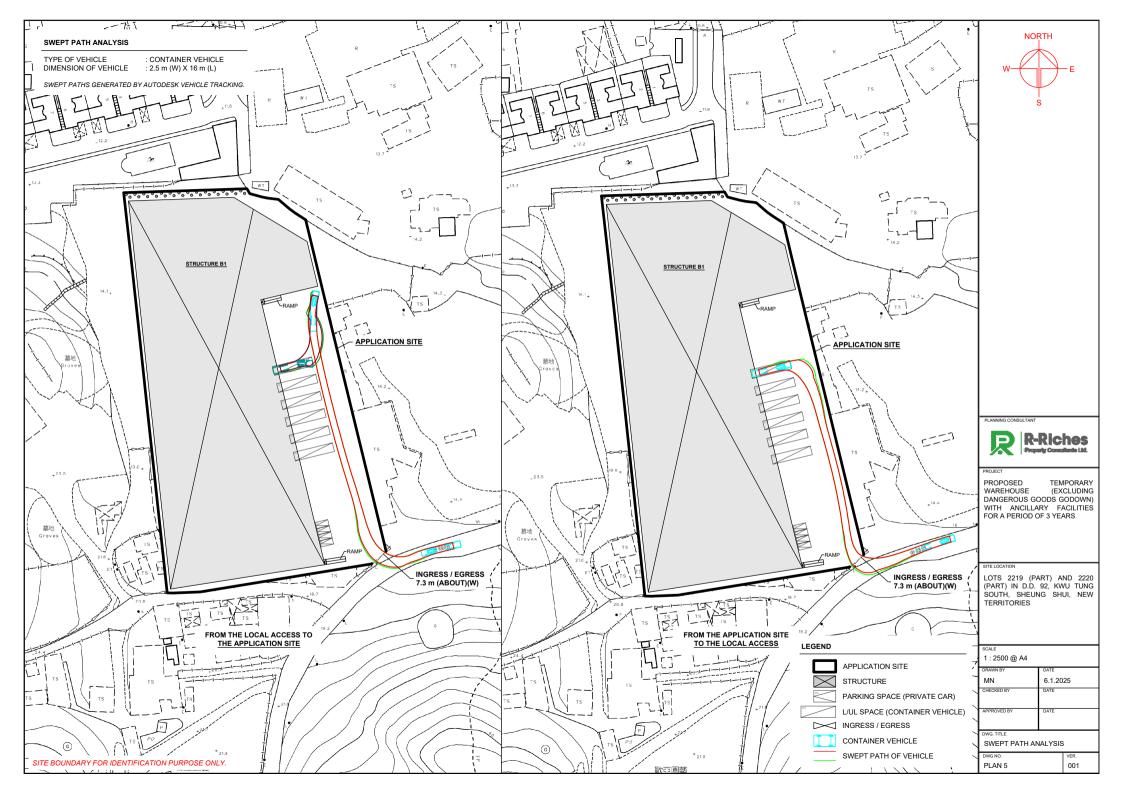

FSYLE/DPO

P.001/002

Appendix I

粉嶺、上水及元朗東規劃處 新界荃灣齊山公路 388 號 中染大魔 22 樓 2202 室



Planning Department

Fauling, Sheung Shui & Yuen Long East District Planning Office Unit 2202, 22/F, CDW Building, 388 Castle Peak Road, Tsuen Wan, N.T.

來函檔號 Your Reference

本署檔號 Our Reference) in TPB/A/NE-KTS/517

電話號碼 Tel. No. : 3168 4072 傳真機號碼 Fax No.: 3168 4074



Dear Sir/Madam,

Planning Application No. A/NE-KTS/517

Proposed Temporary Warehouse (excluding Dangerous Goods Godown) with Ancillary Office for a Period of 3 Years within "Recreation" Zone. Lots 2219 (Part) and 2220 (Part) in D.D. 92, Kwu Tung South, Sheung Shui, New Territories

> Compliance with Approval Condition (h) the submission of a drainage proposal

I refer to your email of 1.6.2023 submitting a set of documents for compliance with the captioned approval condition. Relevant department has been consulted on your submission. Your submission is considered:

☑ Acceptable. The captioned condition has been complied with.

- Since the captioned condition require both the submission and implementation of the proposal, it has not been fully complied with.
- ☐ Not acceptable. The captioned condition has not been complied with.

Should you have any queries on the departmental comments, please contact Mr. Keith LIU (Tel: 2300 1595) of Drainage Department direct.

Yours faithfully,

wthought

(Anthony LUK) District Planning Officer/

Fanling, Sheung Shui & Yuen Long East

Planning Department





c.c. CE/MN, DSD


(Attn.: Mr. Keith LIU)

Fax: 2739 8775

AL/FS/wm

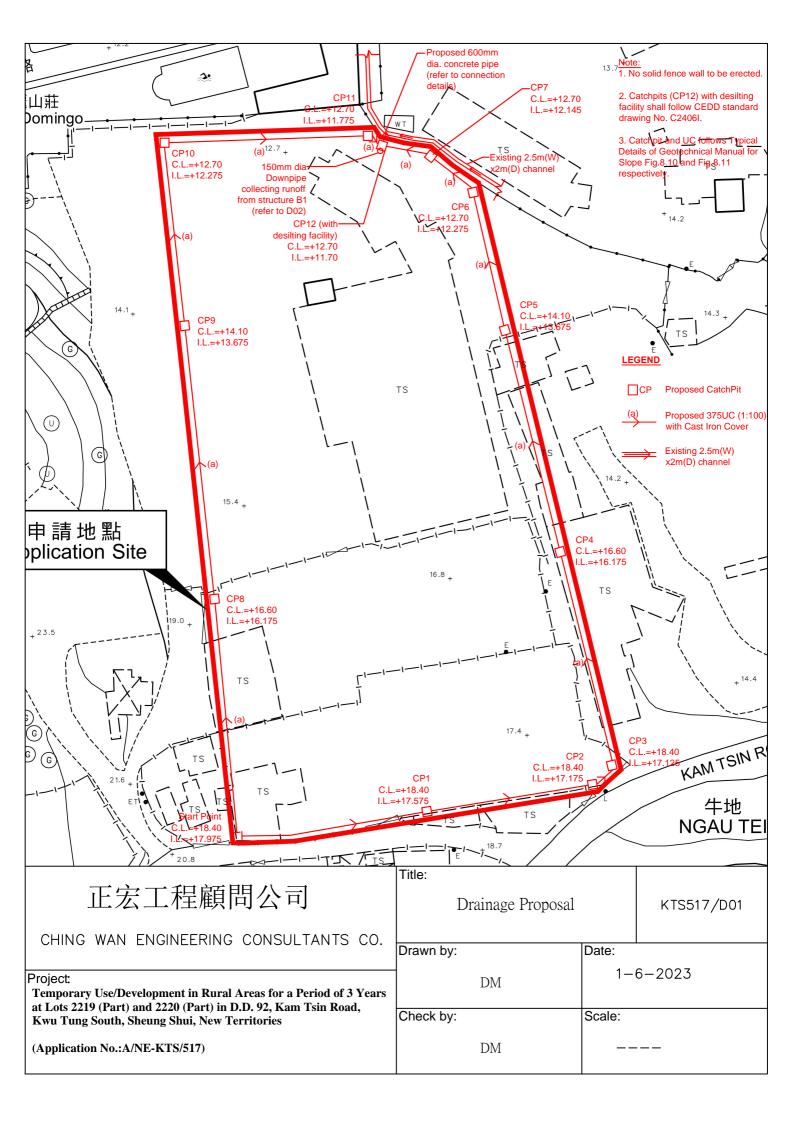

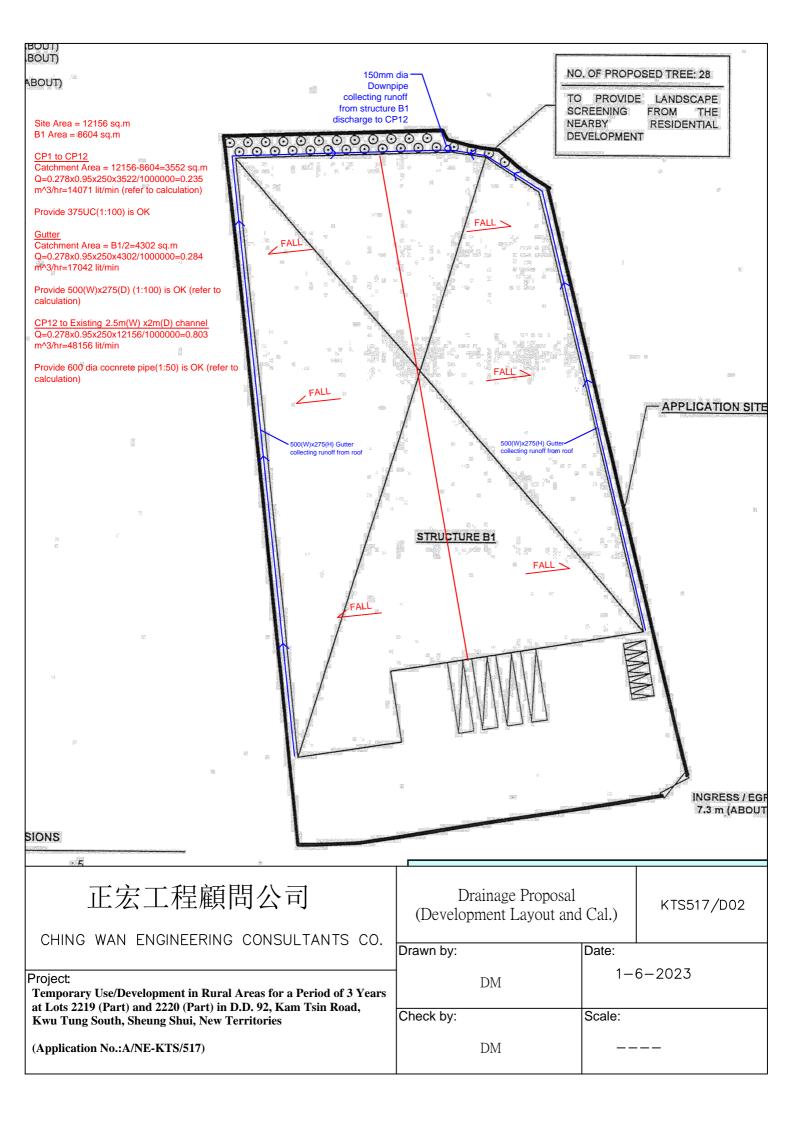

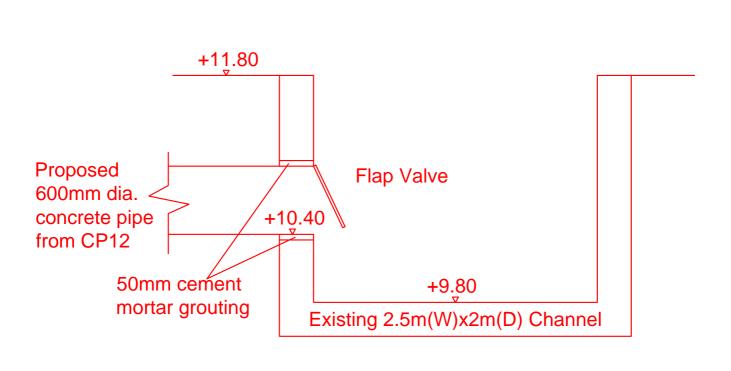

CONNECTION DETAILS

正宏工程顧問公司 CHING WAN ENGINEERING CONSULTANTS CO.	Drainage Proposal (Connection Details))	KTS517/D03
Project:	Drawn by:	Date: 1-	6-2023
Temporary Use/Development in Rural Areas for a Period of 3 Years at Lots 2219 (Part) and 2220 (Part) in D.D. 92. Kam Tsin Road.	DM		
Kwu Tung South, Sheung Shui, New Territories	Check by:	Scale:	
(Application No.:A/NE-KTS/517)	DM		

Site Area 3552 m2 Calculation of Runoff from the Proposed Development, $= 0.278 \,\mathrm{CiA}$ = 0.95(P.42 of Stormwater Drainage Manual) = 3552 Α m^2 = 0.003552 km^2 take = 250 mm/hr Therefore, = 0.278*0.95*250*0.003552 = 0.235m³/sec lit/min = 14071Provide 375UC(1:100) is OK 12156 m2 Site Area Calculation of Runoff from the Proposed Development, $= 0.278 \,\mathrm{CiA}$ Q = 0.95(P.42 of Stormwater Drainage Manual) Α = 12156 m^2 = 0.012156 km^2 take = 250 mm/hr Therefore, = 0.278*0.95*250*0.012156 = 0.803m³/sec = 48156 lit/min Calculation Maximum Capacity of Proposed 600mm dia. Underground pipe. $= R^{2/3}*S_f^{0.5}/n$ Manning Equation 600 mm dia where $= \pi r^2/2 \pi r$ r= 0.3 m= r/2= 0.15m = 0.012s/m^{1/3} (Table 13 of Stormwater Drainage Manual) 1/ 50 = 0.02V $= 0.15^{2/3}*0.02^{0.5}/0.012$ Therefore, = 3.327m/sec Maximum Capacity (Q_{max}) = V*A $= 3.42*\pi r^2$ = 0.941m³/sec 1 nos of pipe = 0.941m³/sec lit/min = 56442 lit/min > 48156 Provide 600mm dia underground pipe (1:50) is OK

Site Area 4302 m2 Calculation of Runoff from the Proposed Development, Q $= 0.278 \,\mathrm{CiA}$ C = 0.95(P.42 of Stormwater Drainage Manual) = 4302 m^2 = 0.004302 km^2 take = 250mm/hr Therefore, Q = 0.278*0.95*250*0.004302m³/sec = 0.284= 17042 lit/min Calculation Maximum Capacity of Proposed 500(W)x275(D) Gutter $V = R^{2/3} * S_f^{0.5} / n$ Manning Equation W =0.5 mm R = (WxD)/(2D+W)D=0.275 where m = 0.131m $s/m^{1/3}$ = 0.012(Table 13 of Stormwater Drainage Manual) 100 $S_{\rm f}$ = 0.01001/ $= 0.131^{2/3}*0.01^{0.5}/0.012$ Therefore, = 2.149m/sec Maximum Capacity (Q_{max}) = V*A= 2.149*0.5*0.275 m³/sec = 0.295m³/sec 1 nos of Gutter = 0.295= 17729lit/min > 17042 lit/min Provide 500(W)x275(D) Gutter (1:100) is OK


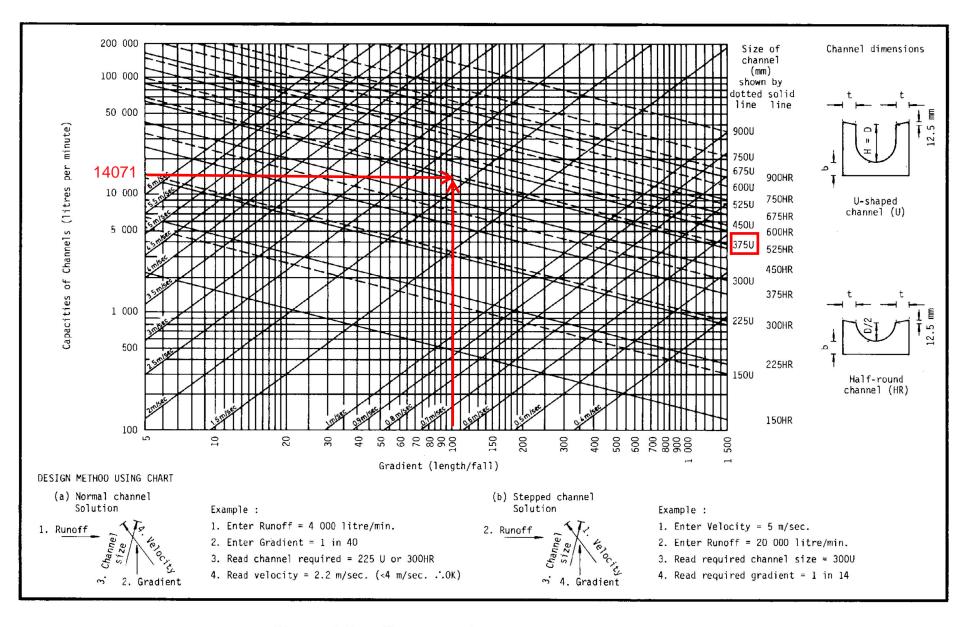


Figure 8.7 - Chart for the Rapid Design of Channels

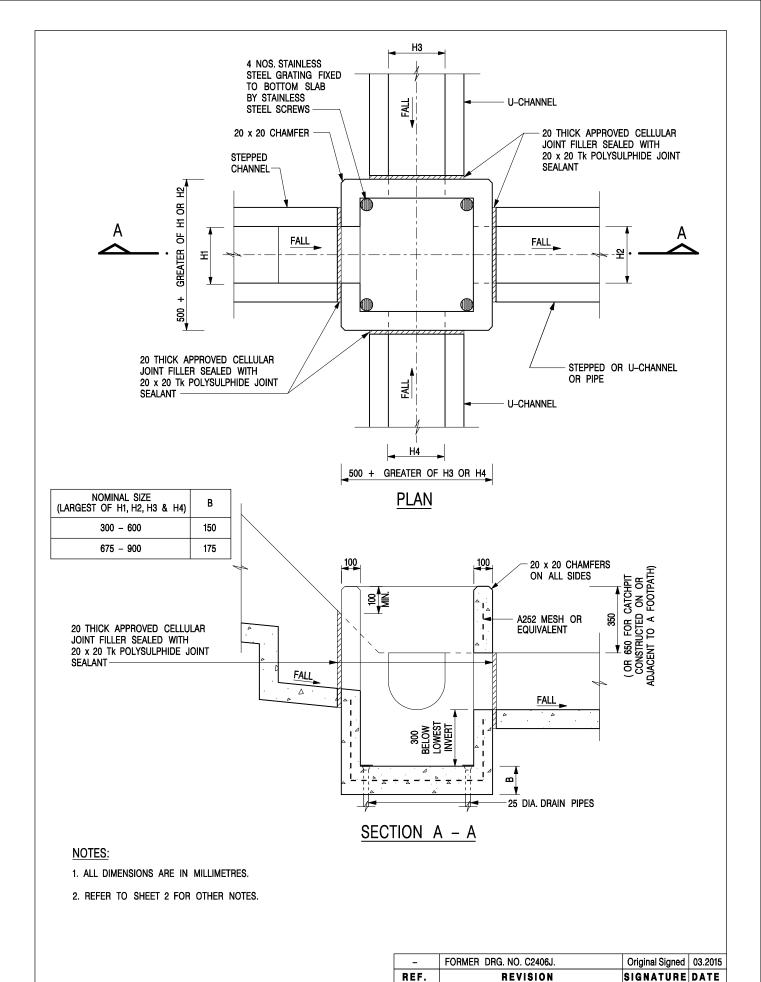

CATCHPIT WITH TRAP (SHEET 1 OF 2)


CEDD **DEVELOPMENT DEPARTMENT** SCALE 1:20 **DATE** JAN 1991

DRAWING NO. C2406 /1

CIVIL ENGINEERING AND

卓越工程 建設香港

We Engineer Hong Kong's Development

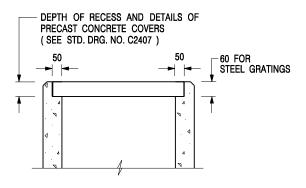

ALTERNATIVE TOP SECTION FOR PRECAST CONCRETE COVERS / GRATINGS

NOTES:

- 1. ALL DIMENSIONS ARE IN MILLIMETRES.
- 2. ALL CONCRETE SHALL BE GRADE 20 /20.
- 3. CONCRETE SURFACE FINISH SHALL BE CLASS U2 OR F2 AS APPROPRIATE.
- 4. FOR DETAILS OF JOINT, REFER TO STD. DRG. NO. C2413.
- 5. CONCRETE TO BE COLOURED AS SPECIFIED.
- UNLESS REQUESTED BY THE MAINTENANCE PARTY AND AS DIRECTED BY THE ENGINEER, CATCHPIT WITH TRAP IS NORMALLY NOT PREFERRED DUE TO PONDING PROBLEM.
- 7. UPON THE REQUEST FROM MAINTENANCE PARTY, DRAIN PIPES AT CATCHPIT BASE CAN BE USED BUT THIS IS FOR CATCHPITS LOCATED AT SLOPE TOE ONLY AND AS DIRECTED BY THE ENGINEER.
- FOR CATCHPITS CONSTRUCTED ON OR ADJACENT TO A FOOTPATH, STEEL GRATINGS (SEE DETAIL 'A' ON STD. DRG. NO. C2405) OR CONCRETE COVERS (SEE STD. DRG. NO. C2407) SHALL BE PROVIDED AS DIRECTED BY THE ENGINEER.
- 9. IF INSTRUCTED BY THE ENGINEER, HANDRAILING (SEE DETAIL 'G' ON STD. DRG. NO. C2405; EXCEPT ON THE UPSLOPE SIDE) IN LIEU OF STEEL GRATINGS OR CONCRETE COVERS CAN BE ACCEPTED AS AN ALTERNATIVE SAFETY MEASURE FOR CATCHPITS NOT ON A FOOTPATH NOR ADJACENT TO IT. TOP OF THE HANDRAILING SHALL BE 1 000 mm MIN. MEASURED FROM THE ADJACENT GROUND LEVEL.
- 10. MINIMUM INTERNAL CATCHPIT WIDTH SHALL BE 1 000 mm FOR CATCHPITS WITH A HEIGHT EXCEEDING 1 000 mm MEASURED FROM THE INVERT LEVEL TO THE ADJACENT GROUND LEVEL. AND, STEP IRONS (SEE DSD STD. DRG. NO. DS1043) AT 300 ℃ STAGGERED SHALL BE PROVIDED. THICKNESS OF CATCHPIT WALL FOR INSTALLATION OF STEP IRONS SHALL BE INCREASED TO 150 mm.
- FOR RETROFITTING AN EXISTING CATCHPIT WITH STEEL GRATING, SEE DETAIL 'F' ON STD. DRG. NO. C2405.
- SUBJECT TO THE APPROVAL OF THE ENGINEER, OTHER MATERIALS CAN ALSO BE USED AS COVERS / GRATINGS.

- FORMER DRG. NO. C2406J. Original Signed 03.2015
REF. REVISION SIGNATURE DATE

CIVIL ENGINEERING AND
DEVELOPMENT DEPARTMENT

CATCHPIT WITH TRAP (SHEET 2 OF 2)

 SCALE 1:20
 DRAWING NO.

 DATE JAN 1991
 C2406 /2

卓越工程 建設香港 We Engineer Hong Kong's Development

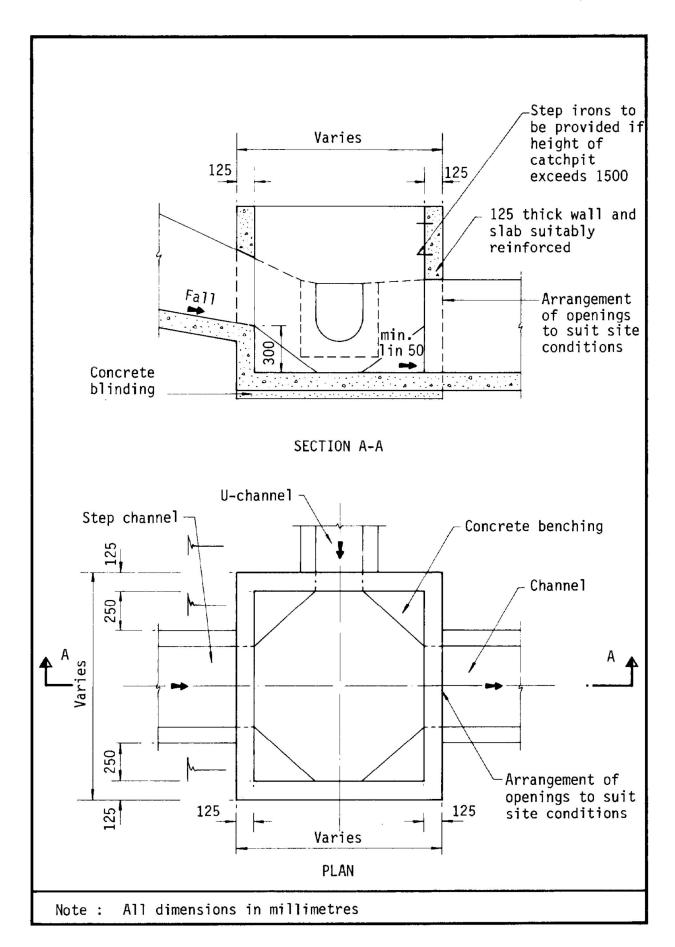


Figure 8.10 - Typical Details of Catchpits

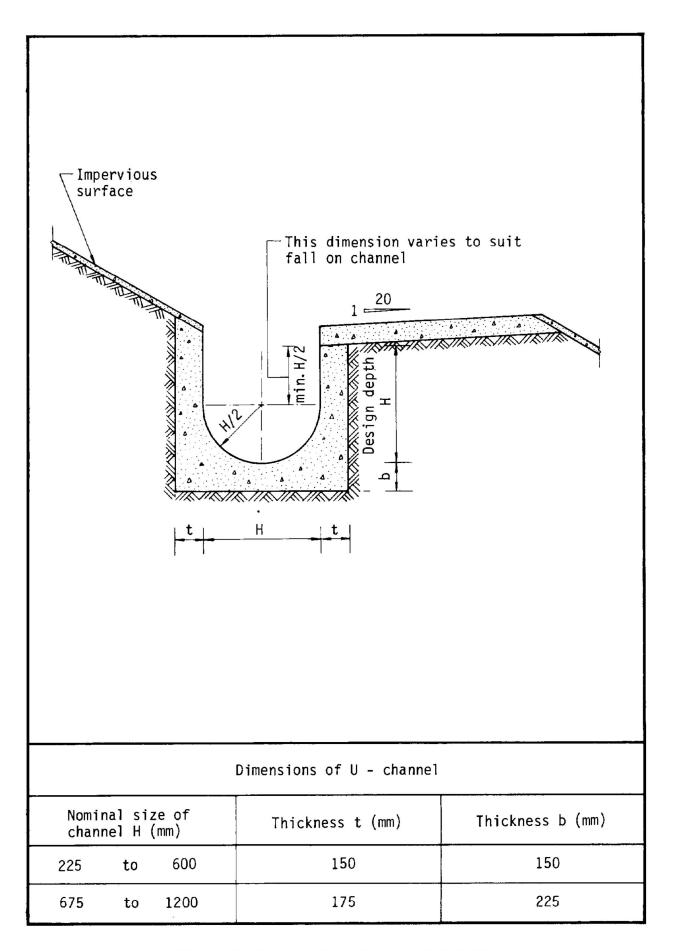


Figure 8.11 - Typical U-channel Details

FSYLE/DPO

Appendix II

Planning Department

規劃署

粉嶺、上水及元朗東規劃處 新界荃灣青山公路 388 號 中染大度 22 楼 2202 室



Fanling, Sheung Shui & Yuen Long East District Planning Office Unit 2202, 22/F., CDW Building, 388 Castle Peak Road, Tsuen Wan, N.T.

來函檔號 Your Reference

本署檔號) in TPB/A/NE-KTS/517 Our Reference (

電話號碼 Tel, No.:

3168 4072

傳真機號碼 Fax No.:

3168 4074



Dear Sir/Madam.

Planning Application No. A/NE-KTS/517

Proposed Temporary Warehouse (excluding Dangerous Goods Godown) with Ancillary Office for a Period of 3 Years within "Recreation" Zone, Lots 2219 (Part) and 2220 (Part) in D.D. 92,

Kwu Tung South, Sheung Shui, New Territories

Compliance with Approval Condition (c) the design and provision of vehicular access, parking and loading/unloading spaces and pedestrian facilities

I refer to your letter dated 17.11.2023 regarding the submission of a revised runin/out proposal for compliance with the captioned approval condition. Relevant departments have been consulted on your submission. Your submission is considered:

- ☐ Acceptable. The captioned condition has been complied with.
- ☑ Acceptable. Since the captioned condition require both the submission and implementation of the proposal, it has not been fully complied with. Please find the detailed comments in Appendix.
- ☐ Not acceptable. The captioned condition has not been complied with.

Should you have any queries on the departmental comments, please contact Mr. CHU Ho Man, Hoffman (Tel: 2399 6933) of the Transport Department.

Yours faithfully,

(Anthony LUK) District Planning Officer/ Fanling, Sheung Shui & Yuen Long East

Planning Department



FSYLE/DPO P.002/002

- 2 -

c.c.

C for T CE/Lighting, HyD (Attn.: Mr. CHU Ho Man, Hoffman) (Attn.: Mr. YIM Kwok Ho, Ivan)

CTP/TPB(3)

AL/LC/mw

Appendix

Comments of the Commissioner for Transport

Approval condition (e) has been partially complied with, subject to the following condition imposed by the Highways Department (HyD). The applicant shall submit a further proposal to HyD's office detailing the proposed permanent relocation works. Upon receiving the proposal, HyD's term contractor will provide the corresponding lighting improvement scheme and his office will advise the applicant of the cost of the works that to be settled by the applicant in form of Demand Note. Besides, the applicant shall be responsible for all the civil works, i.e. public lighting cable ducts and drawpits, relating to the permanent relocation of the concerned lamppost.



Our Ref. : DD92 Lot 2219 & 2220 Your Ref. : TPB/A/NE-KTS/517 顧問有限公司 **盈卓物業**

The Secretary
Town Planning Board
15/F, North Point Government office
333 Java Road
North Point, Hong Kong

By Email

17 November 2023

Dear Sir,

Compliance with Approval Condition (e)

Proposed Temporary Warehouse (excluding Dangerous Goods Godown)
with Ancillary Office for a Period of 3 Years in "Recreation" Zone,
Lots 2219 (Part) and 2220 (Part) in D.D.92, Kam Tsin Road, Kwu Tung South, Sheung Shui, N.T.

(S.16 Planning Application No. A/NE-KTS/517)

We are writing to submit a revised run-in/out proposal for compliance with approval condition (e) of the subject application, i.e. the design and provision of vehicular access, parking and loading/unloading spaces and pedestrian facilities (Appendix I).

Should you require more information regarding the application, please contact our Mr. Louis TSE at or the undersigned at your convenience. Your kind attention to the matter is much appreciated.

Yours faithfully,

For and on behalf of

R-riches Property Consultants Limited

Matthew NG

Planning and Development Manager

cc DPO/FSYLE, PlanD

(Attn.: Mr. Louis CHEUNG

email: lhwcheung@pland.gov.hk)

(Attn.: Ms. Monique WONG

email: mkmwong@pland.gov.hk)

Final Technical Note



Project Proposed Temporary Warehouse (Excluding Dangerous Goods

Godown) with Ancillary Office in Lots 2219 (Part) and 2220 Date 17/11/2023

(Part) in DD92 Kam Tsin Road, Kwu Tung, Sheung Shui

Note Run In / Out Proposal, Pedestrian Connection and Swept Path

Analysis

1 Introduction

1.1 The Applicant proposes a temporary warehouse development situated at Kam Tsin Road, Kwu Tung, Sheung Shui. To facilitate the approval condition for the proposed development, design of run in / out, pedestrian connection and swept path analysis for both run in / out and critical parking spaces were conducted with results summarized in this Technical Note.

2 Run In / Out Proposal

- 2.1 The proposed development is connected to Kam Tsin Road via the proposed run in / out located at the southeast corner of the site. To facilitate the manoeuvring of container trucks, the width of the run in / out is 7.3m, which is stipulated with Transport Planning and Design Manual (TPDM).
- 2.2 With a lamp post identified at the proposed access, relocation of lamp post would be required for the construction of the run in / out.
- 2.3 **Figure A** presents the details of the run in / out proposal and the associated swept path analysis for the run in / out.
- Acting as a dead end carriageway serving insignificant local developments only, Kam Tsin Road is a single-2 carriageway with minimal traffic identified along the carriageway. In particular, to facilitate a smooth operation of 16m container truck leaving the site, staff will be deployed at the run in / out, while only to allow container trucks leaving the site when no traffic is observed along Kam Tsin Road.

3 Pedestrian Connection

3.1 To facilitate effective pedestrian connection within the site, a footpath connecting the entrance of the warehouse structure and the proposed run in / out is proposed along the eastern side of the site. **Figure A** presents the location of the footpath.

4 Swept Path Analysis

4.1 Based on the latest design, the proposed development consists of 5 private car parking spaces and 4 parking spaces for container trucks.

Proposed Temporary Warehouse (Excluding Dangerous Goods Godown) with Ancillary Office in Lots 2219 (Part) and 2220 (Part) in DD92,Kam Tsin Road, Kwu Tung, Sheung Shui Final TN for Run In / Out Proposal, Pedestrian Connection and Swept Path Analysis




- 4.2 To ensure sufficient turning spaces for internal traffic circulation, swept path analysis is also conducted particularly for container trucks, with details presented in **Figure B**.
- 4.3 Assessment results indicate that sufficient turning spaces are provided within the proposed development.

Proposed Temporary Warehouse (Excluding Dangerous Goods Godown) with Ancillary Office in Lots 2219 (Part) and 2220 (Part) in DD92,Kam Tsin Road, Kwu Tung, Sheung Shui Final TN for Run In / Out Proposal, Pedestrian Connection and Swept Path Analysis



Figure

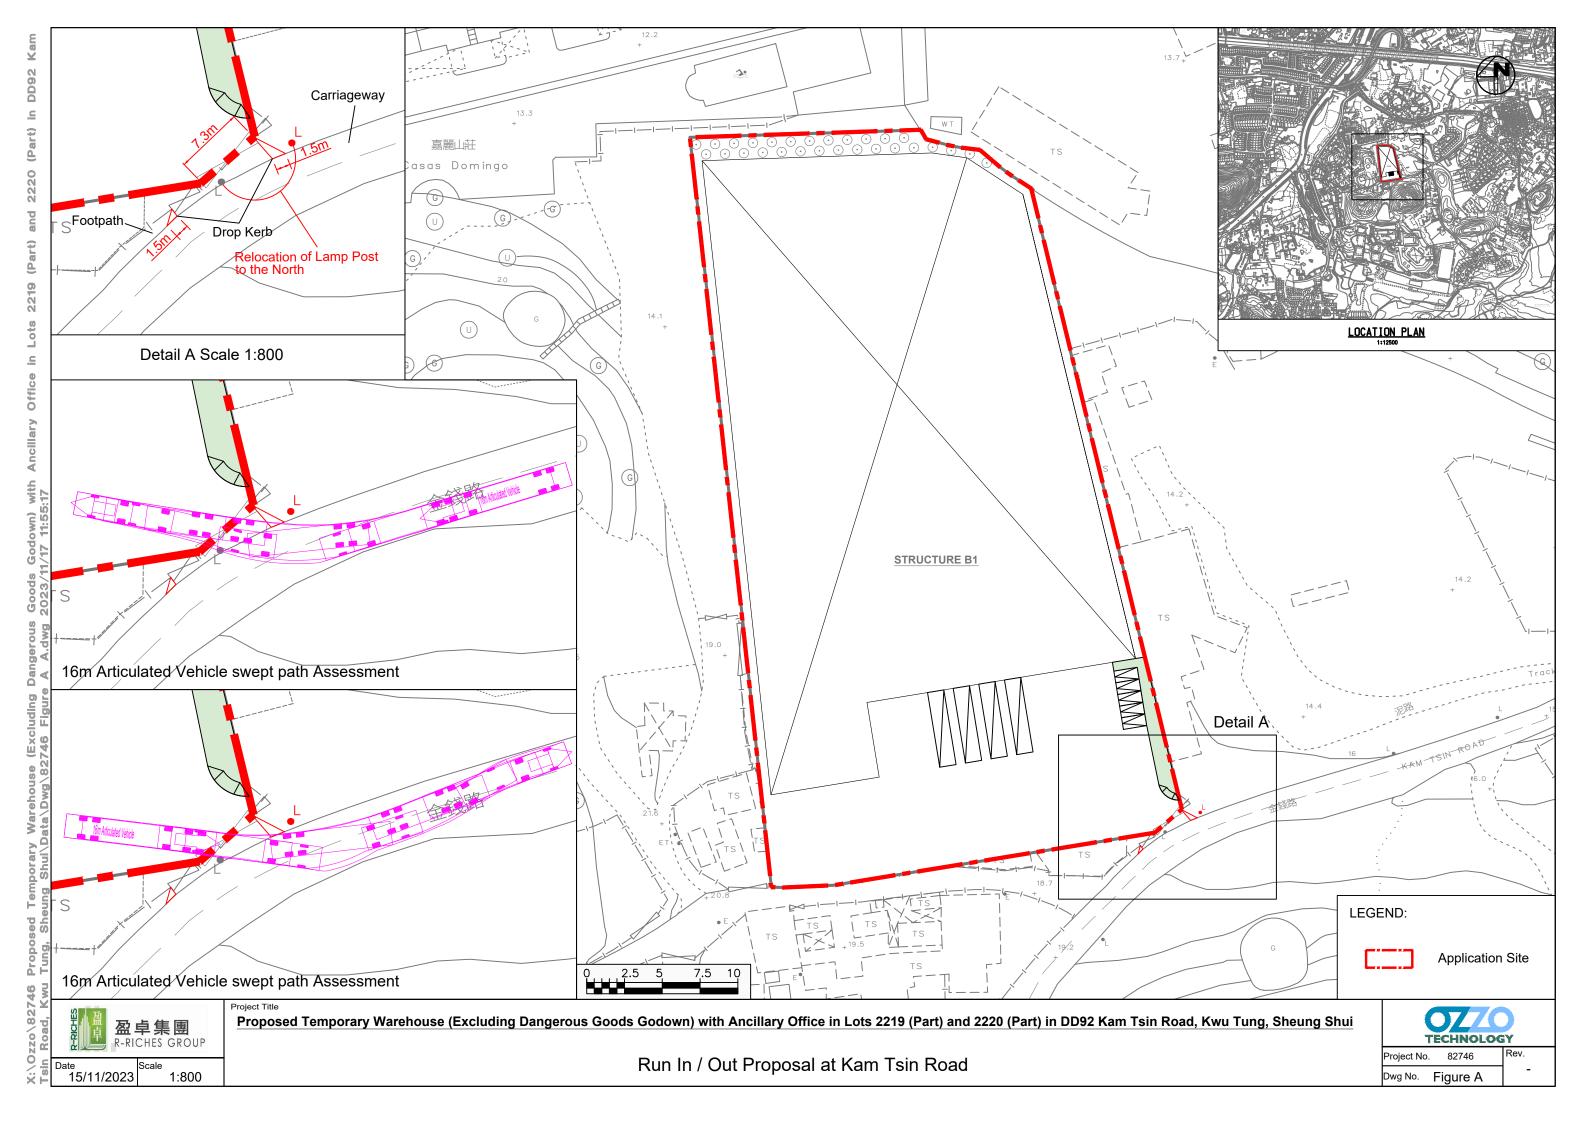



FIRE SERVICES NOTES:

- HOSE REEL SYSTEM
- HOSE REEL SHALL BE PROVIDED AT POSITIONS AS INDICATED ON PLANS.
- THERE SHALL BE SUFFICIENT HOSE REELS TO ENSURE THAT EVERY PART OF THE BUILDING CAN BE REACHED BY A LENGTH OF NOT MORE THAN 30M OF HOSE REEL TUBING. ONE ACTUATING POINT AND ONE AUDIO WARNING DEVICE TO BE LOCATED AT EACH HR POINT. THE ACTUATING POINT SHOULD INCLUDE FACILITIES FOR THE FIRE PUMP START DEVICE INITIATION.
- A MODIFIED HOSE REEL SYSTEM OF 2,000 LITRES WATER TANK TO BE PROVIDED FOR THE ENTIRE BUILDING AS INDICATED ON PLAN.
- NO FIRE SERVICES INLET TO BE PROVIDED FOR THE MODIFIED HOSE REEL SYSTEM. 14
- WATER SUPPLY FOR THE MODIFIED HOSE REEL SYSTEM TO BE SINGLE END FEED FROM THE GOVERNMENT TOWN MAIN.
- 1.6 TWO FIXED FIRE PUMPS (DUTY/STANDBY) TO BE PROVIDED AT F.S. & SPR. PUMP ROOM.
- THE HR SYSTEM INSTALLED SHOULD BE IN ACCORDANCE WITH PARA. 5.14 OF THE CODE OF PRACTICE FOR MINIMUM FIRE SERVICE INSTALLATION AND EQUIPMENT 2012. 1.7
- AN INSTRUCTION PLATE SHALL BE PROVIDED NEXT TO THE BREAK GLASS UNIT FOR OPERATION OF HOSE REEL.

AUTOMATIC SPRINKLER SYSTEM


- AUTOMATIC SPRINKLER SYSTEM SUPPLIED BY A 135,000L SPRINKLER WATER TANK AND HAZARD CLASS OH3 SHALL BE PROVIDED TO THE ENTIRE BUILDING/ STRUCTURE IN ACCORDANCE WITH LPC RULES INCORPORATING BS EN12845: 2015 AND FSD CIRCULAR LETTER 5/2020. THE SPRINKLER TANK, SPRINKLER PUMP ROOM, SPRINKLER INLET AND SPRINKLER CONTROL VALUE GROUP SHALL BE CLEARLY MARKED ON PLANS.
- THE CLASSIFICATION OF THE AUTOMATIC SPRINKLER INSTALLATION TO BE ORDINARY HAZARD GROUP 3.
- ONE NUMBER 135,000 LITRES SPRINKLER WATER TANK TO BE PROVIDED AS INDICATED ON PLANS.
- SPRINKLER CONTROL VALVE SET AND SPRINKLER INLET TO BE PROVIDED AS INDICATED ON PLANS.
- TYPE OF STORAGE METHOD FOR THE BUILDING IS AS FOLLOWS:
 - STORAGE CATEGORY: CATEGORY (I)
 - STORAGE HEIGHT: NOT EXCEEDING 4M
 - STORAGE: ST1

FIRE ALARM SYSTEM

- FIRE ALARM SYSTEM SHALL BE PROVIDED THROUGHOUT THE ENTIRE BUILDING IN ACCORDANCE WITH BS 5839-1: 2017 AND FSD CIRCULAR LETTER NO.6/2021. ONE ACTUATING POINT AND ONE AUDIO WARNING DEVICE SHOULD BE LOCATED AT EACH HOSE REEL POINT. THE ACTUATION POINT SHOULD INCLUDE FACILITIES FOR FIRE PUMP START AND AUDIO / VISUAL WARNING DEVICE INITIATION.
- AN ADDRESSABLE TYPE FIRE ALARM PANEL TO BE PROVIDED AND LOCATED INSIDE G/F F.S. & SPR. PUMP ROOM.

MISCELLANEOUS F.S. INSTALLATION

- PORTABLE FIRE EXTINGUISHER WITH SPECIFIED TYPE AND CAPACITY TO BE PROVIDED AT LOCATIONS AS INDICATED ON PLANS.
- 4.2 SUFFICIENT EMERGENCY LIGHTING SHALL BE PROVIDED THROUGHOUT THE ENTIRE BUILDINGS/STRUCTURES IN ACCORDANCE WITH BS 5266-1:2016, BS EN 1838:2013 AND FSD CL 4/2021.
- SUFFICIENT DIRECTIONAL AND EXIT SIGN SHALL BE PROVIDED IN ACCORDANCE WITH BS 5266: PART 1 AND FSD CIRCULAR LETTER 5/2008. 4.3
- 4.4 NO EMERGENCY GENERATOR TO BE PROVIDED FOR SERVING THE EMERGENCY POWER. DUPLICATED POWER SUPPLIES FOR ALL FIRE SERVICES INSTALLATIONS COMPRISING A CABLE CONNECTED FROM ELECTRICITY MAINS DIRECTLY BEFORE THE MAIN **SWITCH**
- WHEN A VENTILATION/ AIR CONDITIONING CONTROL SYSTEM TO A BUILDING IS PROVIDED, IT SHALL STOP MECHANICALLY INDUCED AIR MOVEMENT WITHIN A DESIGNATED FIRE COMPARTMENT.
- NO DYNAMIC SMOKE EXTRACTION SYSTEM SHALL BE PROVIDED SINCE FIRE COMPARTMENT NOT EXCEEDING 7000 CUBIC METRES AND THE AGGREGATE AREA OF OPENABLE WINDOWS OF THE RESPECTIVE COMPARTMENT EXCEEDS 6.25% OF THE FLOOR AREA OF THAT COMPARTMENT.

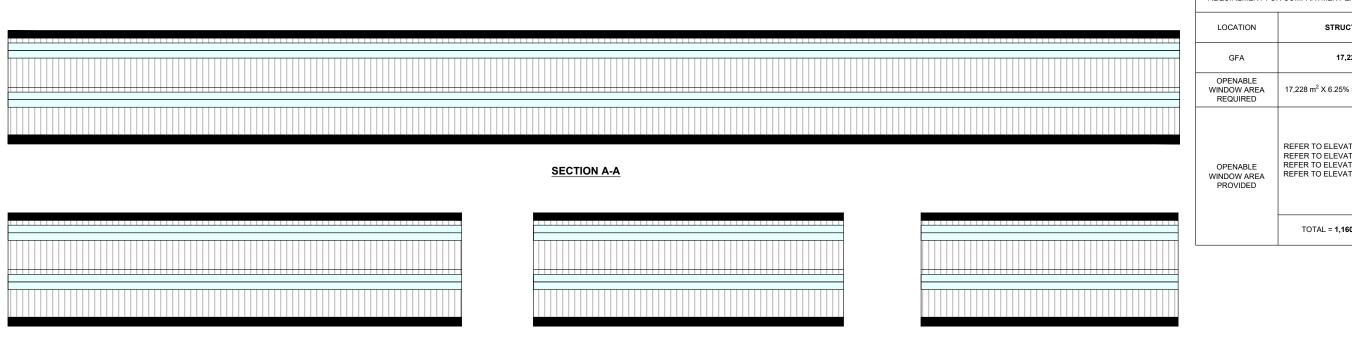

SECTION B-B SECTION C-C SECTION D-D

OPENABLE WINDOW AREA CALCULAION UNDER F.S.D. REQUIREMENT FOR COMPARTMENT EXCEEDING 7000m² STRUCTURE B1 17.228 m² 17,228 m² X 6.25% = **1,077 m² (ABOUT)** REFER TO ELEVATION - (A-A) = 620 m² REFER TO ELEVATION - (B-B) = 240 m² REFER TO ELEVATION - (C-C) = 164 m² REFER TO ELEVATION - (D-D) = 136 m $TOTAL = 1.160 \text{ m}^2 > 1.077 \text{ m}^2$

PROPOSED

WAREHOUSE (EXCLUDING DANGEROUS GOODS GODOWN WITH ANCILLARY FACILITIES FOR A PERIOD OF 3 YEARS

Appendix III

LOTS 2219 (PART) AND 2220 (PART) IN D.D. 92, KWU TUNG SOUTH, SHEUNG SHUI, NEW TERRITORIES

1.500 @ AS	
DRAWN BY	DATE
MN	22.1.2025
CHECKED BY	DATE
APPROVED BY	DATE

ESIs PROPOSAL (1/2)

APPENDIX II 001

DEVELOPMENT PARAMETERS


BUILDING HEIGHT NO. OF STOREY

APPLICATION SITE AREA : 12,156 m² : 8,614 m² : 3,542 m² (ABOUT) (ABOUT) (ABOUT) COVERED AREA UNCOVERED AREA PLOT RATIO (ABOUT) (ABOUT) SITE COVERAGE : 71 % NO. OF STRUCTURE DOMESTIC GFA NON-DOMESTIC GFA TOTAL GFA : 1 : N/A : 17,228 m² : 17,228 m² (ABOUT) (ABOUT)

: 15 m : 2

(ABOUT)

COVERED AREA GROSS FLOOR AREA BUILDING HEIGHT STRUCTURE USE WAREHOUSE (EXCLUDING D.G.G.), SITE OFFICE, WASHROOM В1 17,228 m² (ABOUT) 15 m (ABOUT)(2-STOREY) 8,614 m² (ABOUT)

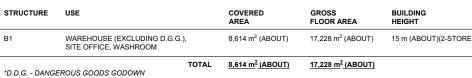



PROPOSED TEMPORARY
WAREHOUSE (EXCLUDING
DANGEROUS GOODS GODOWN)
WITH ANCILLARY FACILITIES
FOR A PERIOD OF 3 YEARS

LOTS 2219 (PART) AND 2220 (PART) IN D.D. 92, KWU TUNG SOUTH, SHEUNG SHUI, NEW TERRITORIES

SCALE	
1:800 @ A3	
DRAWN BY	DATE
MN	22.1.2025
CHECKED BY	DATE
APPROVED BY	DATE
DWG. TITLE	

FSIs PROPOSAL (2/2)

APPENDIX III

LEGEND

APPLICATION SITE STRUCTURE PARKING SPACE (PC) L/UL SPACE (CV) INGRESS / EGRESS

FIRE SERVICE INSTALLATIONS

EXIT EXIT SIGN

EMERGENCY LIGHTING

5 KG CO2 TYPE FIRE EXTINGUISHER

(F.E.) 4 KG DRY POWER TYPE FIRE EXTINGUISHER

 \bigcirc HOSE REEL PUMP

SPRINKLER PUMP

 \mathbb{C} 150mm FIRE ALARM BELL

PUMP CONTROL PANEL

0 BREAK GLASS UNIT

 \square VISUAL ALARM DEVICE

 \bowtie 2,000 LITRES FIBRE GLASS F.S. WATER TANK

135,000 LITRES R.C. SPRINKLER WATER TANK H.R. HOSE REEL SET

- SPRINKLER CONTROL VALVE

>>> SPRINKLER INLET



Our Ref. : DD92 Lot 2219 & 2220 Your Ref. : TPB/A/NE-KTS/553

The Secretary,
Town Planning Board,
15/F, North Point Government Offices,
333 Java Road,
North Point, Hong Kong

Dear Sir,



By Email

1 April 2025

1st Further Information

Proposed Temporary Warehouse (excluding Dangerous Goods Godown)
with Ancillary Facilities for a Period of 3 Years in "Recreation" Zone,
Lots 2219 (Part) and 2220 (Part) in D.D. 92, Kwu Tung South, Sheung Shui, New Territories

(S.16 Planning Application No. A/NE-KTS/553)

We are writing to submit further information to address departmental comments of the subject application (**Appendix I**).

Should you require more information regarding the application, please contact our Mr. Danny NG at or the undersigned at your convenience. Thank you for your kind attention.

Yours faithfully,

For and on behalf of

R-riches Property Consultants Limited

(Attn.: (Attn.:

Louis TSE

Town Planner

cc DPO/FSYLE, PlanD

.



Responses-to-Comments

Proposed Temporary Warehouse (excluding Dangerous Goods Godown)
with Ancillary Facilities for a Period of 3 Years in "Recreation" Zone,
Lots 2219 (Part) and 2220 (Part) in D.D. 92, Kwu Tung South, Sheung Shui, New Territories

(Application No. A/NE-KTS/553)

(i) A RtoC Table:

	Departmental Comments	Applicant's Responses	
1.	Comments of the Director of Environment Protection (DE	P)	
	(Contact Person: Ms. Abbey LAU; Tel.: 2835 1300)		
(a)	From the information provided, it is noted that the	Although the existing public sewer is located in the vicinity of the application site (the Site),	
	applicant will follow ProPECC PN 1/23 for sewerage	soakaway system will be adopted by the applicant for sewage treatment. Considering the	
	treatment at the site. According to our information,	small amount of sewage generated from the washroom of the Site, washroom connected to	
	there is existing public sewers in the vicinity of the	temporary septic tanks with a sufficient capacity is proposed to handle the sewage and then	
	application site. If the applicant convey the sewage to	tinkered away by a licensed contractor. Therefore, connection to the nearby public sewer	
	public sewer, a detailed Sewerage Impact Assessment	is not required.	
(SIA) is required in order to ensure no adverse sewerage			
	impact from the proposed development.		
(b)	The applicant shall advise the measures for sewage	During the operation of the proposed development, the major source of wastewater will be	
	treatment and disposal (e.g. chemical toilets or septic	sewage from washroom generated by on-site staff and drivers. The applicant will implement	
	tank and soakaway system).	good practices under <i>ProPECC PN 1/23</i> when designing on-site sewage system with the Site,	
		i.e. the use of soakaway system for sewage treatment. Licensed collectors will be employed	
		by the applicant to collect and dispose of sewage regularly.	



(c)	The applicant is reminded to review if there is any other	As the proposed development is solely for 'warehouse' use without any workshop activities,
	sources of sewage generation (e.g. drivers, floor	the major source of wastewater will be sewage from washroom generated by on-site staff
	cleaning, truck wheels cleaning, fire water testing for	and drivers.
	fire service installation, etc.), except from the washroom	
	for use by warehouse staff.	
2. (Comments of the Director of Fire Services (D of FS)	
(Contact Person: Mr. LI Chi-fung; Tel.: 2733 5844)	
(a)	The sprinkler control valve group shall be clearly marked	Noted. The applicant will submit a revised fire service installations (FSIs) proposal for the
	on plans;	consideration of the D of FS to enhance fire safety of the Site after planning approval has
		been obtained from the Town Planning Board (the Board).
(b)	The minimum clearance around each single storage	
	block (i.e. 2.4 m) & Max. storage block area of 50m shall	
	be specified in the FS Notes;	
(c)	Modified hose reel system shall be provided in	
	accordance with the FSI CoP 2022;	
(d)	The alarm bell should be located and incorporated with	
	each hose reel and clearly indicated on plans.	
(e)	The G/F and 1/F of a structure shall be regarded as	
	separate compartments. Therefore, the calculations of	
	openable windows for compartments shall be provided	
	accordingly and precisely indicated on plans.	
	accordingly and precisely indicated on plans.	



3. Comments of the Chief Town Planner/Urban Design and Landscape, Planning Department (CTP/UD&L, PlanD) (Contact Person: Mr. Henry NG; Tel.: 3565 3950)

(a) According to our site visit on 4.3.2025, some trees are observed mainly along the northeastern and southeastern boundaries of the Site. Most of them are of common species and generally in small/medium size and fair/poor condition while two number of trees (i.e. Ficus microcarpa) are large in size and in good condition along the southeastern boundary of the Site. With reference to Swept Path Analysis (Plan 5 rev.001) of the application, the proposed swept path of vehicle may conflict with the two Ficus microcarpa. Nevertheless, no treatment proposal for those trees (e.g. tree protection measures) has been provided.

All existing trees within the Site will be preserved and well-maintained by the applicant, including the two *Ficus macrocarpa* along the southeastern boundary of the Site. Please refer to the revised landscape proposal for details (**Annex I**). In addition, 28 nos. of trees (i.e. *Polyspora Axillaris*) with 1.2 m (L) $\times 1.2 \text{m}$ (W) $\times 1.2 \text{m}$ (D) tree pits will be planted along the northern boundary of the Site as landscape buffer to minimize adverse visual impact to the adjoining residential development. Regular horticultural maintenance on the existing/proposed trees will be provided by the applicant. Therefore, adverse landscape impact generated from the proposed development is not anticipated.

- (b) The applicant should provide survey on trees (with site photos showing the existing conditions) and treatment proposal for the existing trees (e.g. tree protection measures, particularly for the two *Ficus microcarpa*) as appropriate.
- (c) The applicant proposed to plant 28 number of trees along the northern boundary of the Site as shown on the Layout Plan (PLAN 4.ver.001). The species and size of proposed trees, the dimension of planting area and soil depth for tree planting should be provided to ensure

	sufficient space for healthy and sustainable growth of	
	the proposed trees.	
	• •	
(d)	The applicant is advised that approval of the application	Noted.
	does not imply approval of tree works, if any, such as	
	pruning, transplanting and felling. Application for any	
	tree works should be submitted direct to relevant	
	authority(ies) for approval.	
	authority(les) for approval.	
1	Commonts of the District Blanca Officer/Fauling Chause	Shui and Vuon Lang Fast, Planning Department (DDQ/FSVIF, PlanD)
		Shui and Yuen Long East, Planning Department (DPO/FSYLE, PlanD)
	Contact Person: Ms. Florence SIU; Tel.: 3168 4042)	
(a)	According to our recent site inspection, the layout of the	The existing structures within the Site will be demolished by the applicant and developed in
	current use at the application site is different from that	accordance with the proposed layout of the current application after planning approval has
	submitted under Application No. A/NE-KTS/553. Please	been obtained from the Board.
	explain. Should there involve major changes in the	
	layout and mix of uses, you are required to submit a	The proposed development is intended solely for 'warehouse (excluding dangerous goods
	fresh application.	godown)' use. All goods will be stored within the enclosed structure. No storage of
		dangerous goods, workshop, recycling, cleansing, dismantling and other workshop activities
		will be carried out at the Site during the planning approval period.
		O. M. C.
(b)	Referring to para. 3.3 of your planning statement, it is	The Site has been filled wholly with concrete to meet the operational needs. No further
(,	stated that "concrete site formation is required to meet	filling of land will be carried out during the planning approval period.
	the operation needs". Please clarify if there will involve	Thining of fathe will be earlied out during the planning approval period.
	any filling of land or further site formation works within	
	the application site.	



5. Comments of the Commissioner for Transport (C for T) (Contact Person: Mr. Brian CHAN; Tel.: 2399 2175)

- (a) Please clarify whether there will be a gate installed at the entrance. If so, please ensure such arrangement will not cause queuing of vehicles outside the subject site;
- (b) The applicant shall advise the management/control measures to be implemented to ensure no queuing of vehicles outside the subject site. In particular the road outside the subject lot is a one-lane two-way carriageway which shall not be blocked.
- (c) The applicant shall advise the provision and management of pedestrian facilities to ensure pedestrian safety.

No gate is proposed at the Site's ingress/egress to facilitate smooth entry of vehicles onto the Site. Staff will be deployed at the ingress/egress of the Site to direct vehicles entering and exiting the Site to ensure that queuing of vehicles would not be carried out at any time during the planning approval period.

Besides, 'BEWARE OF HEAD ON TRAFFIC' and 'BEWARE OF PEDESTRIAN' signs will be respectively shown at the junction of Kam Tsin Road and the site ingress/egress to enhance road to ensure no queuing of vehicles outside the Site and pedestrian safety.

As the Site is proposed for 'warehouse' use with no shopfront, no visitor is anticipated and only the applicant's fleets will be allowed to enter/exit the Site. As the vehicular trips could be strictly controlled by the applicant, only 2 vehicular trips would be scheduled for container vehicle during the AM and PM peak hour respectively to reduce congestion and improve safety.

With the implementation of the above traffic management measures, it is expected that adverse impact on the local traffic and pedestrian safety will be minimal.

6. Comments of the Chief Highway Engineer/New Territories East, Highways Department (CHE/NTE, HyD) (Contact Person: Mr. Danny TSE; Tel.: 2762 3966)

(a) The applicant is required to construct the run-in/out in accordance with prevailing HyD Standard Drawings to the satisfaction of HyD and TD.

The applicant will implement the accepted run-in/out proposal after planning approval has been obtained from the Board.



(b) The section of Kam Tsin Road adjacent to the application site is under HyD's maintenance purview. However, the proposed access to the site will pass through a strip of land between the Kam Tsin Road and the subject site, which is not maintained by HyD. The applicant is required to sort out the land issue as sketch below with relevant land authorities; and

Noted. The applicant will consult the relevant parties regarding the land issue after planning approval has been obtained from the Board.

(c) Adequate drainage measures shall be provided to prevent surface water running from the application site to the nearby public road and drains.

Noted. The applicant has submitted a drainage proposal to review the drainage arrangement for the proposed development (Annex II). Surface run-off arising from the Site will be collected by the peripheral U-channel and eventually discharged to the existing channel situated to the northeastern of the Site. Sufficient drainage facilities will be provided by the applicant to the satisfaction of the Director of Drainage.

7. Comments of the Chief Highway Engineer/Lighting, Highways Department (CHE/L, HyD) (Contact Person: Mr. Ivan YIM; Tel.: 3903 6559)

(a) The applicant shall submit a further proposal to this office detailing the proposed permanent relocation works. Upon receiving the proposal, our term Contractor will provide the corresponding lighting improvement scheme and this office will advise the applicant of the cost of the works that to be settled by the applicant in form of Demand Note. Besides, the applicant shall be responsible for all the civil works, ie. public lighting cable ducts and drawpits, relating to the permanent relocation of the concerned lamppost.

Noted. As relocation of the existing lamp post, which is identified at the proposed access, would be required for the construction of the run-in/out, the applicant will submit a further proposal to provide the corresponding lighting improvement scheme after planning approval has been obtained from the Board.




8.	8. Comments of the Chief Engineer/Mainland North, Drainage Services Department (CE/MN, DSD)			
	(Contact Person: Mr. Keith LIU; Tel.: 2300 1595)			
(a)	As the roof layout was changed, the applicant should	Noted. A revised drainage proposal is provided by the applicant to review the drainage		
	revise drawing no. KTS517/D02	arrangement (Annex II). During the operation of the proposed development, surface run-		
		off arising from the Site will be collected by the peripheral U-channel and eventually		
(b)	Should the applicant choose to connect his proposed	discharged to the existing channel situated to the northeastern of the Site. The calculation		
	sewerage system to DSD's network, they shall furnish	shows that the proposed drainage facilities can handle the runoff from the Site.		
	DSD with their connection proposal, with manhole			
	types, sizes and invert levels, for agreement. After			
	obtaining DSD's agreement, the applicant shall submit a			
	duly completed Form HBP1 with a cross cheque covering			
	the technical audit fee and a plan showing the details of			
	the proposed drainage connection works to this Division			
	for formal application for the required connection. Upon			
	DSD's acceptance of the connection application, the			
	applicant shall carry out the proposed connection works			
	in accordance with DSD Standard Drawings at the			
	resources of the applicant. The connection pipe outside			
	the lot boundaries shall be handed over to DSD for			
	maintenance after satisfactory technical audit by DSD.			
(c)	Should the applicant choose to dispose of sewage of the	Noted.		
(0)	proposed development through other means, views	Noted.		
	from EPD should be sought.			
	Hom Erb should be sought.			



Annex I

Landscape Proposal




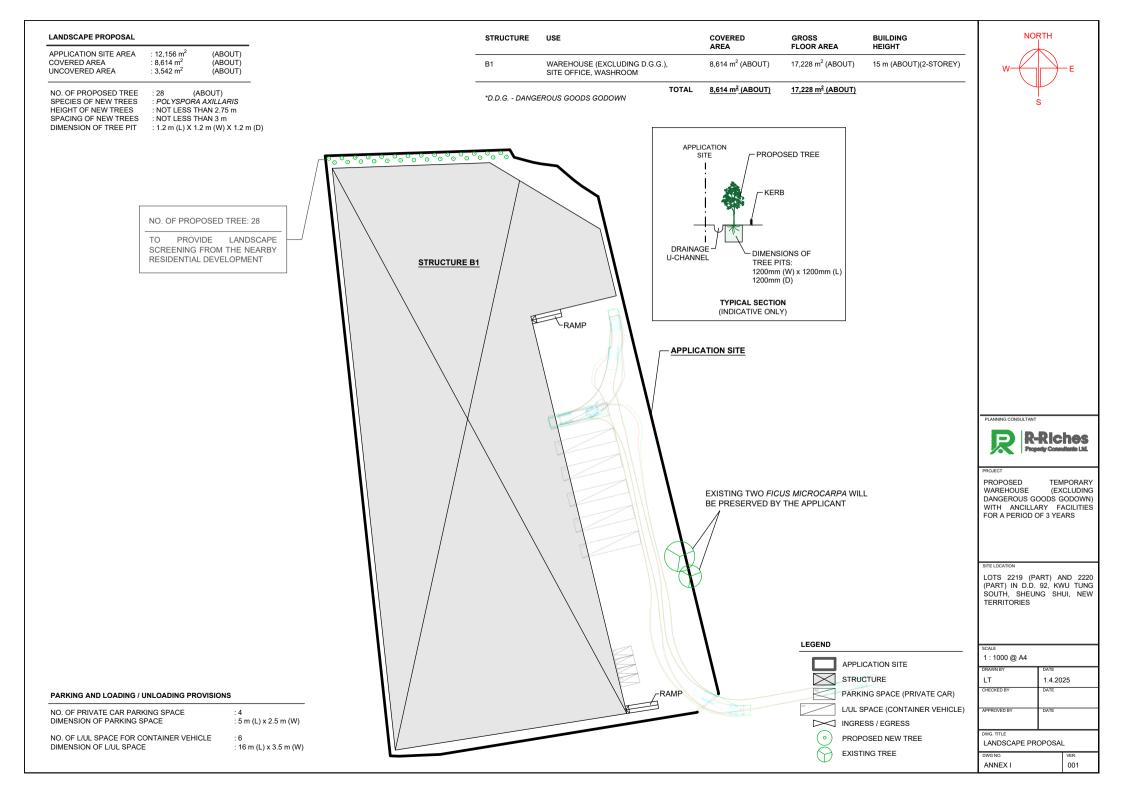



Annex II

Drainage Proposal



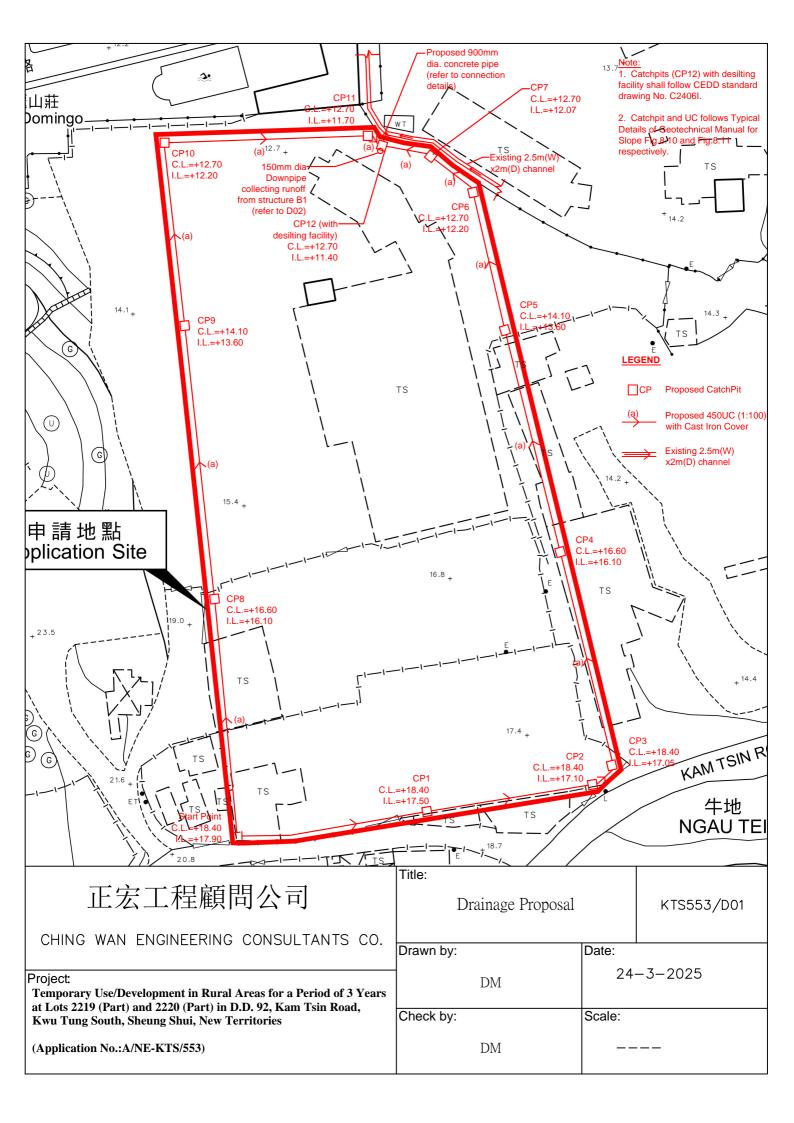

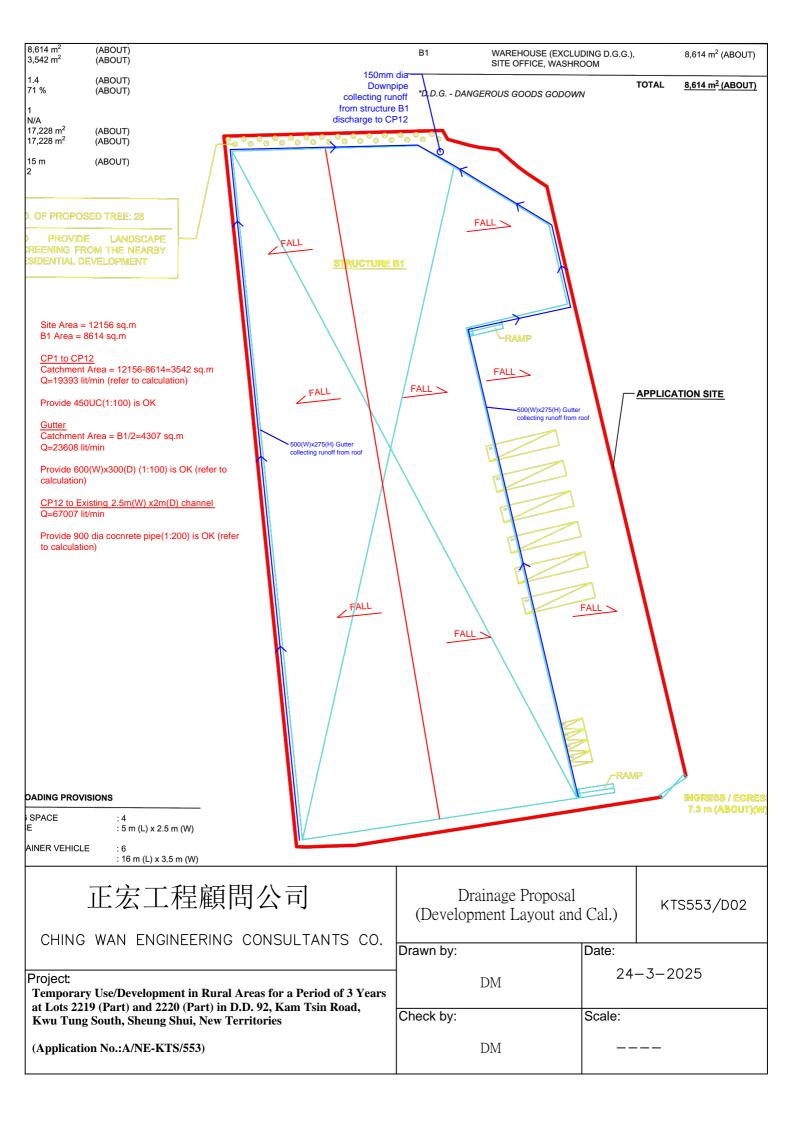

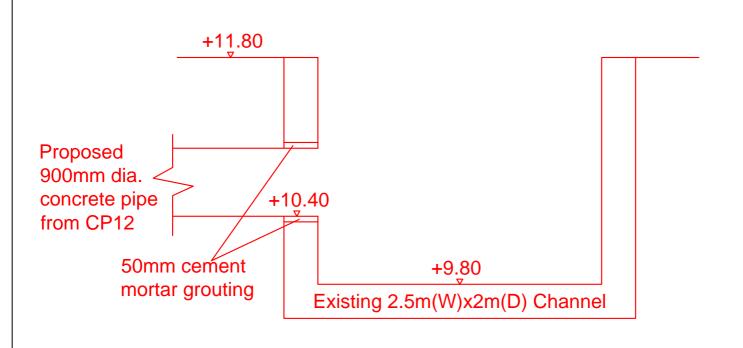

CONNECTION DETAILS

正宏工程顧問公司 CHING WAN ENGINEERING CONSULTANTS CO.	Drainage Proposal (Connection Details))	KTS553/D03
CHING WAN ENGINEERING CONSOLIANTS CO.	Drawn by:	Date:	
Project: Temporary Use/Development in Rural Areas for a Period of 3 Years	DM	24-3-2025	
at Lots 2219 (Part) and 2220 (Part) in D.D. 92, Kam Tsin Road, Kwu Tung South, Sheung Shui, New Territories	Check by:	Scale:	
(Application No.:A/NE-KTS/553)	DM		


Site Area 3542 m2 Calculation of Runoff from the Proposed Development, $= 0.278 \,\mathrm{CiA}$ = 0.95(P.42 of Stormwater Drainage Manual) $= 0.14465 \text{ L/ H}^{0.2} \text{A}^{0.1}$ $= 0.14465*10/1^{0.2}*3542^{0.1}$ = 0.639min (50 yrs return period, Table 3a, Corrigendum 2024, $= 1.111*a/(t+b)^{c}$ SDM) and (11.1% increase due to climate change) $= 1.111*505.5/(0.639+3.29)^{0.355}$ = 345.5mm/hr m^2 = 3542= 0.003542 km^2 Therefore, = 0.278*0.95*345.9*0.003542= 0.323m³/sec = 19393 lit/min Provide 450UC(1:100) is OK 12156 m2 Site Area Calculation of Runoff for Proposed 600mm dia Pipe, $= 0.278 \,\mathrm{CiA}$ C = 0.95(P.42 of Stormwater Drainage Manual) = 12156 m^2 = 0.012156 km^2 $= 0.14465 \text{ L/ H}^{0.2} \text{A}^{0.1}$ $= 0.14465*10/1^{0.2}*12156^{0.1}$ = 0.565min (50 yrs return period, Table 3a, Corrigendum 2024, $= 1.111*a/(t+b)^{c}$ SDM) and (11.1% increase due to climate change) $= 1.111*505.5/(0.565+3.29)^{0.355}$ = 347.9mm/hr = 0.278*0.95*347.9*0.012156Q Therefore, = 1.117m³/sec


lit/min

= 67007

Geotechnical Engineering Office, Civil Engineering and Development Department The Government of the Hong Kong Special Administrative Region

GEO Technical Guidance Note No. 43 (TGN 43) Guidelines on Hydraulic Design of U-shaped and Half-round Channels on Slopes

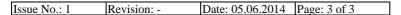

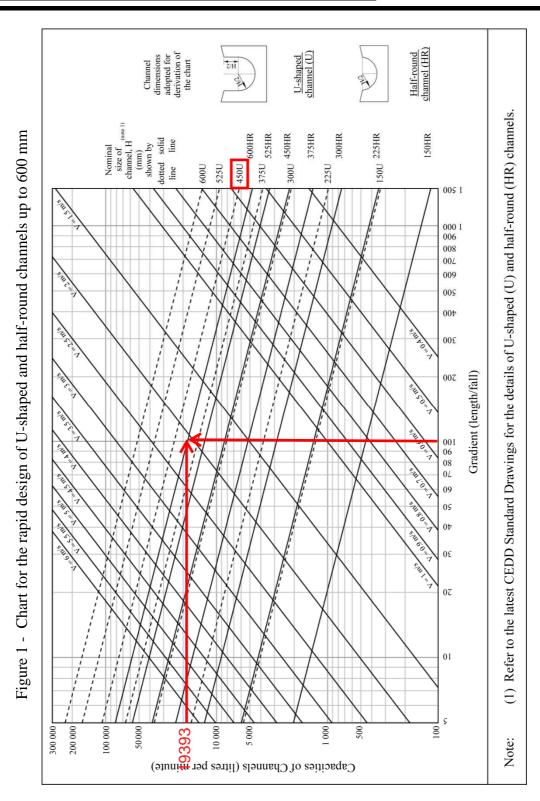

Check 900mm dia. Pipes by Colebrook-White Equation

$$V = -\sqrt{(8gDs)} \log(\frac{ks}{3.7D} + \frac{2.51v}{D\sqrt{(2gDs)}})$$

2.6991


where:

Therefore, design V of pipe capacity


m/s

(Table 14, from DSD SDM, concrete pipe)

Site Area 4307 Calculation of Runoff from the Proposed Development, Q $= 0.278 \,\mathrm{CiA}$ C = 0.95(P.42 of Stormwater Drainage Manual) Α = 4307 m^2 = 0.004307 km^2 $= 0.14465 \text{ L/ H}^{0.2} \text{A}^{0.1}$ $= 0.14465*10/1^{0.2}*4307^{0.1}$ = 0.626min (50 yrs return period, Table 3a, Corrigendum 2024, i $= 1.111*a/(t+b)^{c}$ SDM) and (11.1% increase due to climate change) $= 1.111*505.5/(0.626+3.29)^{0.355}$ = 345.9mm/hr = 0.278*0.95*345.9*0.004302Therefore, Q = 0.393m³/sec = 23608lit/min Calculation Maximum Capacity of Proposed 600(W)x300(D) Gutter $= R^{2/3} * S_f^{0.5} / n$ Manning Equation W= 0.6 mm R = (WxD)/(2D+W)0.3 where D=m = 0.150m $s/m^{1/3}$ = 0.012(Table 13 of Stormwater Drainage Manual) 1/ 100 = 0.0100 $= 0.15^{2/3} * 0.01^{0.5} / 0.012$ Therefore, = 2.353m/sec Maximum Capacity (Q_{max}) = V*A = 2.353*0.6*0.3= 0.423m³/sec 1 nos of Gutter = 0.423m³/sec = 25408lit/min > 23608 lit/min Provide 600(W)x300(D) Gutter (1:100) is OK

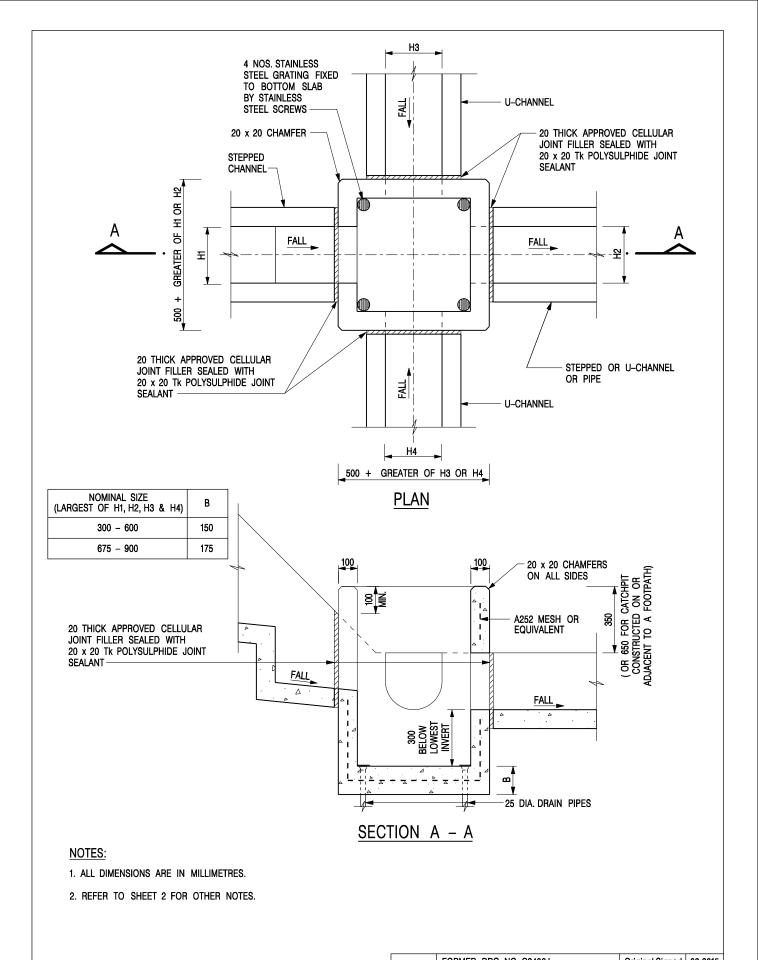

	-	FORMER DRG. NO. C2406J.		Original Signed	03.2015
	REF.	REVISION		SIGNATURE	DATE
CATCHPIT WITH TRAP	CIVIL ENGINEERING AND DEVELOPMENT DEPARTMENT			IT	
(CHEET 1 OF 0)	SCAL	. E 1 : 20	DRAWI		
(SHEET 1 OF 2)	DATE	JAN 1991	C24	406 /1	
卓越工程 建設香港	We Engineer Hong Kong's Development				

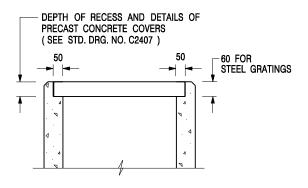

ALTERNATIVE TOP SECTION FOR PRECAST CONCRETE COVERS / GRATINGS

NOTES:

- 1. ALL DIMENSIONS ARE IN MILLIMETRES.
- 2. ALL CONCRETE SHALL BE GRADE 20 /20.
- 3. CONCRETE SURFACE FINISH SHALL BE CLASS U2 OR F2 AS APPROPRIATE.
- 4. FOR DETAILS OF JOINT, REFER TO STD. DRG. NO. C2413.
- 5. CONCRETE TO BE COLOURED AS SPECIFIED.
- UNLESS REQUESTED BY THE MAINTENANCE PARTY AND AS DIRECTED BY THE ENGINEER, CATCHPIT WITH TRAP IS NORMALLY NOT PREFERRED DUE TO PONDING PROBLEM.
- 7. UPON THE REQUEST FROM MAINTENANCE PARTY, DRAIN PIPES AT CATCHPIT BASE CAN BE USED BUT THIS IS FOR CATCHPITS LOCATED AT SLOPE TOE ONLY AND AS DIRECTED BY THE ENGINEER.
- FOR CATCHPITS CONSTRUCTED ON OR ADJACENT TO A FOOTPATH, STEEL GRATINGS (SEE DETAIL 'A' ON STD. DRG. NO. C2405) OR CONCRETE COVERS (SEE STD. DRG. NO. C2407) SHALL BE PROVIDED AS DIRECTED BY THE ENGINEER.
- 9. IF INSTRUCTED BY THE ENGINEER, HANDRAILING (SEE DETAIL 'G' ON STD. DRG. NO. C2405; EXCEPT ON THE UPSLOPE SIDE) IN LIEU OF STEEL GRATINGS OR CONCRETE COVERS CAN BE ACCEPTED AS AN ALTERNATIVE SAFETY MEASURE FOR CATCHPITS NOT ON A FOOTPATH NOR ADJACENT TO IT. TOP OF THE HANDRAILING SHALL BE 1 000 mm MIN. MEASURED FROM THE ADJACENT GROUND LEVEL.
- 10. MINIMUM INTERNAL CATCHPIT WIDTH SHALL BE 1 000 mm FOR CATCHPITS WITH A HEIGHT EXCEEDING 1 000 mm MEASURED FROM THE INVERT LEVEL TO THE ADJACENT GROUND LEVEL. AND, STEP IRONS (SEE DSD STD. DRG. NO. DS1043) AT 300 ℃ STAGGERED SHALL BE PROVIDED. THICKNESS OF CATCHPIT WALL FOR INSTALLATION OF STEP IRONS SHALL BE INCREASED TO 150 mm.
- FOR RETROFITTING AN EXISTING CATCHPIT WITH STEEL GRATING, SEE DETAIL 'F' ON STD. DRG. NO. C2405.
- SUBJECT TO THE APPROVAL OF THE ENGINEER, OTHER MATERIALS CAN ALSO BE USED AS COVERS / GRATINGS.

- FORMER DRG. NO. C2406J. Original Signed 03.2015
REF. REVISION SIGNATURE DATE

CIVIL ENGINEERING AND
DEVELOPMENT DEPARTMENT

CATCHPIT WITH TRAP (SHEET 2 OF 2)

卓越工程 建設香港

 SCALE 1:20
 DRAWING NO.

 DATE JAN 1991
 C2406 /2

We Engineer Hong Kong's Development

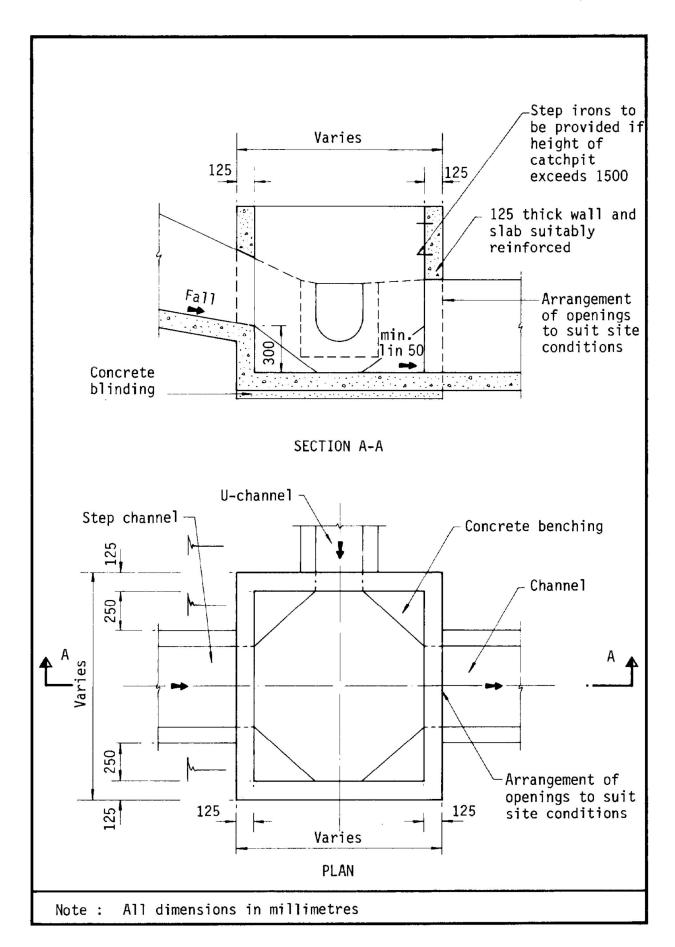


Figure 8.10 - Typical Details of Catchpits

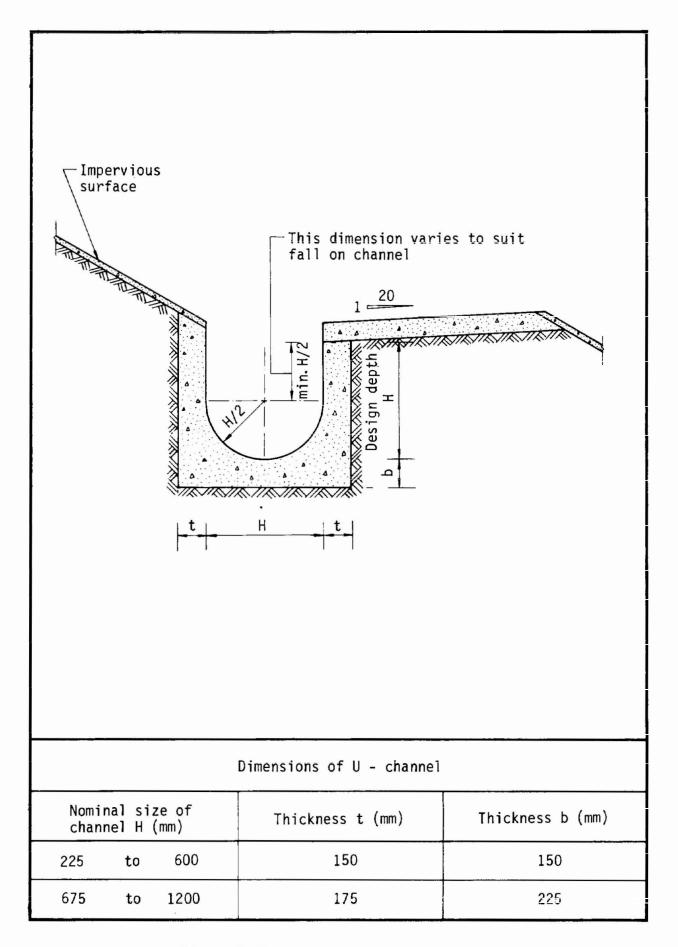


Figure 8.11 - Typical U-channel Details



Our Ref. : DD92 Lot 2219 & 2220 Your Ref. : TPB/A/NE-KTS/553

North Point, Hong Kong

The Secretary,
Town Planning Board,
15/F, North Point Government Offices,
333 Java Road,

Dear Sir,



By Email

3 April 2025

2nd Further Information

Proposed Temporary Warehouse (excluding Dangerous Goods Godown)
with Ancillary Facilities for a Period of 3 Years in "Recreation" Zone,
Lots 2219 (Part) and 2220 (Part) in D.D. 92, Kwu Tung South, Sheung Shui, New Territories

(S.16 Planning Application No. A/NE-KTS/553)

We are writing to submit further information to address departmental comments of the subject application (**Appendix I**).

Should you require more information regarding the application, please contact our Mr. Danny NG at or the undersigned at your convenience. Thank you for your kind attention.

Yours faithfully,

For and on behalf of

R-riches Property Consultants Limited

Louis TSETown Planner

cc DPO/FSYLE, PlanD





Responses-to-Comments

Proposed Temporary Warehouse (excluding Dangerous Goods Godown) with Ancillary Facilities for a Period of 3 Years in "Recreation" Zone, Lots 2219 (Part) and 2220 (Part) in D.D. 92, Kwu Tung South, Sheung Shui, New Territories

(Application No. A/NE-KTS/553)

- (i) 2.5m high solid metal wall will be erected along the whole site boundary to minimise potential nuisance to the nearby sensitive receivers.
- (ii) A total of 19 existing trees are along the eastern and southeastern of the application site, including the two *Ficus microcarpa*. All these existing trees will be preserved and maintained by the applicant during the planning approval period.
- (iii) A RtoC Table:

	Departmental Comments	Applicant's Responses		
1.	Comments of the District Lands Officer/North,	Lands Department, Lands Department		
	(DLO/N, LandsD)			
	(Contact Person: Mr. HO Kwok-leung; Tel.: 2675 177	77)		
(a)	The following irregularity not covered by the			
	subject planning application has been detected by			
	this office:			
	Unlawful occupation of Government land not	The unlawful occupation of Government		
	covered by the planning application	land (GL) will be demolished by the applicant after planning approval has		
	The GL adjoining the application site has been	been obtained from the Town Planning		
	illegally occupied with unauthorized structures	Board (the Board). No structure will be		
	without permission. The GL being illegally	erected on GL.		
occupied is not included in the application. Any				
	occupation of GL without Government's prior			
	approval is an offence under Cap. 28 or the			
	applicant should advise any toleration has been			
	given by competent authority. This office			
	reserves the rights to take necessary land control			
	action against the illegal occupation of GL without			
	further notice.			
(b)	The lot owners/applicant shall cease the illegal	The applicant will apply for modification		
	occupation of the GL not covered by the subject	of the STW conditions to rectify the		
	planning application immediately; and, subject to	proposed scheme after planning		
	the approval of the Town Planning Board to the	approval has been obtained from the		
	planning application which shall have reflected	Board.		



the rectification as aforesaid required, the STW holder will need to apply to this office for modification of the STW conditions where appropriate. The application for modification of the STW will be considered by LandsD in its capacity as the landlord and there is no guarantee that it will be approved. The application, if approved, will be on whole lot basis and subject to such terms and conditions including the payment of waiver fee and administrative fee as considered appropriate to be imposed by LandsD. In addition, LandsD reserves the right to take land control action for any unlawful occupation of GL and to take enforcement action (if required) under the STW. Besides, given the proposed use is temporary in nature, only erection of temporary structure(s) will be considered.



Previous s.16 Applications involving the Application Site

Approved Application

	Application No.	Uses/Developments	Date of Consideration
1.	A/NE-KTS/517	Proposed Temporary Warehouse (excluding Dangerous Goods Godown) with Ancillary Office for a Period of 3 Years	31.3.2023 (Revoked on 30.12.2024)

Rejected Application

	Application No. Uses/Developments		Date of Consideration	Rejection Reasons
1.	A/NE-KTS/491	Temporary Warehouse with Ancillary Office for a Period of 3 Years	6.11.2020	1, 2

Rejection Reasons:

- 1. Not in line with the planning intention and no strong justification for a departure.
- 2. Failure to demonstrate that the development would not generate adverse traffic impact on the surrounding areas.

Similar s.16 Applications within the nearby "Recreation" Zone on the Approved Kwu Tung South Outline Zoning Plan No. S/NE-KTS/22 in the Past Five Years

Approved Applications

Application No.	Uses/Developments	Date of Consideration
A/NE-KTS/532	Proposed Temporary Warehouse (Hardware Accessories) with Ancillary Office for a Period of 3 Years	19.4.2024
A/NE-KTS/545	Proposed Temporary Warehouse (Hardware Accessories) with Ancillary Office for a Period of 3 Years	20.12.2024

Government Departments' General Comments

1. Traffic

Comments of the Commissioner for Transport (C for T):

- no comment on the application;
- an approval condition on the design and provision of parking and loading/unloading spaces and pedestrian facilities to the satisfaction of the C for T is recommended; and
- the advisory comments are at **Appendix V**.

Comments of the Chief Highway Engineer/New Territories East, Highways Department (CHE/NTE, HyD):

- no comment on the application;
- given the understanding that the applicant will submit the design drawings for the runin/out to C for T and HyD for review and approval, and construct the run-in/out to the satisfaction of both C for T and HyD, he has no further comments on the application. In this connection, approval conditions should be imposed in relation to the design and provision of run-in/out to the satisfaction of C for T and Director of Highways; and
- the advisory comments are at **Appendix V**.

2. Fire Safety

Comments of the Director of Fire Services (D of FS):

- no objection in principle to the submitted fire service installations (FSIs) proposal subject to FSIs and water supplies for firefighting being provided to his satisfaction; and
- the advisory comments are at **Appendix V**.

3. Drainage

Comments of the Chief Engineer/Mainland North, Drainage Services Department (CE/MN, DSD):

- no objection to the application from public drainage viewpoint;
- the drainage proposal submitted with the application is found generally in order. Condition should also be imposed for the applicant to implement the drainage proposal to his satisfactory; and
- the advisory comments are at Appendix V.

4. Landscape

Comments of the Chief Town Planner/Urban Design and Landscape, Planning Department (CTP/UD&L, PlanD):

- no adverse comment on the application from landscape planning perspective;
- with reference to the aerial photo of Mar 2024, the Site is located in an area of rural inland plain landscape character comprising village houses, temporary structures, open storages and tree groups. The Sheung Yue River is to the west of the Site;
- with reference to DPO's site photos taken on 25.2.2025, the Site has been hard paved with temporary structures and open storage of construction materials. The proposed development is considered not incompatible with the landscape setting in the proximity;
- significant adverse landscape impact arising from the proposed use is not anticipated;
 and
- the advisory comments are at **Appendix V**.

5. Electrical and Mechanical Services

Comments of the Director of Electrical and Mechanical Services (DEMS):

- no adverse comments on the application as far as the proposed warehouse will not result in a significant increase in the number of working personnel;
- there is a high pressure underground town gas transmission pipeline (running along Kam Hang Road) in the vicinity of the proposed temporary warehouse; and
- the advisory comments are at **Appendix V**.

6. Recreation and Leisure Facilities

Comments of the Director of Leisure and Cultural Services (DLCS):

- no planning projects are involved in the Site;
- no venue or roadside amenity area under his purview is identified to be affected; and
- no trees under his maintenance are affected by the application.

7. Other Departments

The following government departments have no objection to / no comment on the application and their advisory comments, if any are provided in **Appendix V**:

• Director of Agriculture, Fisheries and Conservation;

- Project Manager (North), Civil Engineering and Development Department;
- Chief Highway Engineer/New Territories East, Highways Department;
- Chief Engineer/Construction, Water Supplies Department;
- Chief Building Surveyor/New Territories West, Buildings Department;
- Commissioner of Police; and
- District Officer (North), Home Affairs Department.

Recommended Advisory Clauses

- (a) to resolve any land issues relating to the development at the application site (the Site) with the concerned owner(s);
- (b) prior planning permission should have been obtained before commencing the development at the Site:
- (c) the permission is given to the uses and structures under application. It does not condone any other uses and structures which currently occur on the Site but not covered by the application. Immediate action should be taken to discontinue such uses and remove such structures not covered by the permission;
- (d) should you fail to comply with the approval conditions resulting in the revocation of the planning permission, sympathetic consideration may not be given to any further application;
- (e) to note the comments of the District Lands Officer/North, Lands Department (LandsD) that:
 - illegal occupation of Government Land (GL) should not be encouraged. The lot owners/applicant shall cease the illegal occupation of the GL not covered by the planning application immediately; and the Short Term Waiver (STW) holder will need to apply to his office for modification of the STW conditions where appropriate. The application for modification of the STW will be considered by LandsD in its capacity as the landlord and there is no guarantee that it will be approved. The application will be on whole lot basis and subject to such terms and conditions including the payment of waiver fee and administrative fee as considered appropriate to be imposed by LandsD. In addition, LandsD reserves the right to take land control action for any unlawful occupation of GL and to take enforcement action (if required) under the STW. Besides, given the proposed use is temporary in nature, only erection of temporary structure(s) will be considered;
- (f) to note the comments of Commissioner for Transport that:
 - the vehicular access between Kam Tsin Road and the Site is not managed by Transport Department. The applicant shall seek agreement/comment from the responsible party for the management and maintenance measures to be implemented for the vehicular access; and
 - no gate shall be installed at the Site's ingress/egress, as proposed by the applicant, to ensure no queueing of vehicles outside the Site;
- (g) to note the comments of the Chief Highway Engineer/New Territories East, Highways Department (HyD) that:
 - the section of Kam Tsin Road adjacent to the Site is under HyD's maintenance purview. However, the proposed access to the Site will pass through a strip of land between the Kam Tsin Road and the Site, which is not maintained by HyD. The applicant is required to sort out the land issue with relevant land authorities; and
 - adequate drainage measures shall be provided to prevent surface water running from the Site to the nearby public road and drains;
- (h) to note the comments of the Chief Engineer/Lighting, HyD that:

- the applicant shall submit a further proposal to his office detailing the proposed permanent relocation works of lamp post. Upon receiving the proposal, his term Contractor will provide the corresponding lighting improvement scheme and his office will advise the applicant of the cost of the works that to be settled by the applicant in form of Demand Note. Besides, the applicant shall be responsible for all the civil works, i.e. public lighting cable ducts and drawpits, relating to the permanent relocation of the concerned lamppost;
- (i) to note the comments of the Director of Fire Services that:
 - the applicant is advised to note the following points in the submission of fire service installations (FSIs) proposal:
 - i. the sprinkler control valve group shall be clearly marked on plans;
 - ii. the minimum clearance around each single storage block (i.e. 2.4 m) and maximum storage block area of 50m shall be specified in the FS Notes;
 - iii. modified hose reel system shall be provided in accordance with the Codes of Practice for Minimum Fire Service Installations and Equipment and Inspection, Testing and Maintenance of Installations and Equipment 2022;
 - iv. the alarm bell should be located and incorporated with each hose reel and clearly indicated on plans; and
 - v. G/F and 1/F of a structure shall be regarded as separate compartments. Therefore, the calculations of openable windows for compartments shall be provided accordingly and precisely indicated on plans;
 - if the proposed structures are required to comply with the Buildings Ordinance (BO) (Cap. 123), detailed fire service requirements will be formulated upon receipt of formal submission of general building plans while the above comments on the submitted FSIs proposal will no longer be valid;
- (j) to note the comments of the Chief Engineer/Mainland North, Drainage Services Department (DSD) that:
 - no stud pipe is reserved for the Site. Should the applicant choose to connect his proposed sewerage system to DSD's network, they shall furnish DSD with their connection proposal, with manhole types, sizes and invert levels, for agreement. After obtaining DSD's agreement, the applicant shall submit a duly completed Form HBP1 with a cross cheque covering the technical audit fee and a plan showing the details of the proposed drainage connection works to his Division for formal application for the required connection. Upon DSD's acceptance of the connection application, the applicant shall carry out the proposed connection works in accordance with DSD Standard Drawings at the resources of the applicant. The connection pipe outside the lot boundaries shall be handed over to DSD for maintenance after satisfactory technical audit by DSD; and
 - should the applicant choose to dispose of sewage of the proposed development through other means, views and comments from Environmental Protection Department should be sought;

- (k) to note the comments of the Director of Environmental Protection that:
 - no operation between 7:00 p.m. and 9:00 a.m. Mondays to Saturdays and on Sundays and public holidays, as proposed by the applicant, is allowed on the Site during the planning approval period;
 - a 2.5m-high solid metal wall along the site boundary should be provided, as proposed by the applicant;
 - the relevant mitigation measures and requirements in "Code of Practice on Handling the Environmental Aspects of Temporary Uses and Open Storage Sites" and the statutory requirements under relevant pollution control ordinances should be followed; and
 - given the temporary nature of the proposed development, septic tank and soakaway system is an acceptable means for wastewater collection, treatment and disposal, provided that its design and construction follow the requirements of the Professional Persons Environmental Consultative Committee Practice Notes (ProPECC PN) 1/23 and are duly certified by an Authorised Person. The requirements of ProPECC PN 2/24 and ProPECC PN 1/23 to properly handle the construction runoff and sewerage produced from the development should be followed; and
- (l) to note the comments of the Chief Town Planner/Urban Design and Landscape, Planning Department that:
 - approval of the application does not imply approval of tree works, if any, such as pruning, transplanting and felling. Application for any tree works should be submitted direct to relevant authorities for approval;
- (m) to note the comments of the Chief Building Surveyor/New Territories West, Buildings Department (BD) that:
 - before any new building works (including containers / open sheds as temporary buildings, demolition and land filling, etc.) are to be carried out on the Site, prior approval and consent of the Building Authority (BA) should be obtained, otherwise they are unauthorised building works (UBW) under the BO. An Authorised Person should be appointed as the co-ordinator for the proposed building works in accordance with the BO;
 - the Site shall be provided with means of obtaining access thereto from a street and emergency vehicular access in accordance with Regulations 5 and 41D of the Building (Planning) Regulations (B(P)R) respectively;
 - the Site does not abut on a specified street of not less than 4.5m wide and its permitted development intensity shall be determined under Regulation 19(3) of the B(P)R at building plan submission stage;
 - the headroom (15m) of the two-storey structure (i.e. warehouse) are considered excessive. It should be justified upon formal plan submission to BD;
 - if the existing structures (not being a New Territories Exempted House) are erected on leased land without the approval of the BA, they are UBW under the BO and should not be designated for any proposed use under the application;

- for UBW erected on leased land, enforcement action may be taken by the BD to effect their removal in accordance with the prevailing enforcement policy against UBW as and when necessary. The granting of any planning approval should not be construed as an acceptance of any existing building works or UBW on the Site under the BO;
- any temporary shelters or converted containers for office, storage, washroom or other uses are considered as temporary buildings are subject to the control of Part VII of the B(P)R;
- the applicant's attention is also drawn to the provision under regulations 40 and 41 of the Building (Standards of Sanitary Fitments, Plumbing, Drainage Works and Latrines) Regulations in respect of disposal of foul water and surface water respectively; and
- detailed checking under the BO will be carried out at building plan submission stage;
- (n) to note the comments of the Director of Electrical and Mechanical Services (DEMS) that:
 - there is a high pressure underground town gas transmission pipeline (running along Kam Hang Road) in the vicinity of the proposed temporary warehouse. The project proponent shall liaise with the Hong Kong and China Gas Company Limited in respect of the exact locations of existing or planned gas pipes/gas installations in the vicinity of the proposed work areas and any required minimum set back distance away from them during the design and construction stages of work; and
 - the number of working personnel in the proposed temporary warehouse shall be minimised as far as reasonably practicable.

致城市規劃委員會秘書:

專人送遞或郵遞:香港北角渣華道 333 號北角政府合署 15 樓

傳真: 2877 0245 或 2522 8426

電郵: tpbpd@pland.gov.hk

To: Secretary, Town Planning Board

By hand or post: 15/F, North Point Government Offices, 333 Java Road, North Point, Hong Kong

By Fax: 2877 0245 or 2522 8426 By e-mail: tpbpd@pland.gov.hk

有關的規劃申請編號 The application no. to which the comment relates <u>A/NE-KTS/553</u>

意見詳情 (如有需要,請另頁說明)

Details of the Comment (use separate sheet if necessary)

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簽署 Signature	(No-1	日期 Date	2025.2.27

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致城市規劃委員會秘書:

專人送遞或郵遞:香港北角渣華道 333 號北角政府合署 15 樓

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意見詳情(如有需要,請另頁說明)

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「提意見人」姓名/名稱 Name of person/company making this comment 1 7 7 万 3

簽署 Signature 1支品道

日期 Date 4-3- 202

金錢材材代表

致城市規劃委員會秘書:

專人送遞或郵遞:香港北角渣華道 333 號北角政府合署 15 樓

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有關的規劃申請編號 The application no. to which the comment relates


A/NE-KTS/553

意見詳情 (如有需要,請另頁說明)

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「提意見人」姓名/名稱 Name of person/company making this comment Have Tim Kau



___ 日期 Date <u> 3-3-2</u>o25
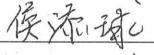
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From:

Sent:

2025-03-10 星期一 03:13:07

To:

tpbpd/PLAND <tpbpd@pland.gov.hk>

Subject:

A/NE-KTS/553 DD 92 Kwu Tung South Recreation

From:

To: tpbpd <tpbpd@pland.gov.hk>

Date: Monday, 10 March 2025 3:11 AM HKT

Subject: Re: A/NE-KTS/517 DD 92 Kwu Tung South Recreation

Dear TPB Members,

517 was revoked 30 Dec 2024 for failure to fulfill a number of condtiions. So back for another quickie to be streamlined and rubber stamped despite proof that the operator is dragging his feet with regard to compliance:

Table 1 – Details of Compliance with Approval Conditions of the Previous Application

Approval Conditions of Application No. A/NE-KTS/517 Date of Compliance

(e) The design and provision of vehicular access, parking and loading/unloading spaces and pedestrian facilities

Partially complied with on 27.12.2023

- (f) The submission of a fire service installations (FSIs) proposal 6.9.2023
- (g) The implementation of the FSIs proposal Not complied with
- (h) The submission of a drainage proposal 18.9.2023
- (i) The implementation of the drainage proposal Not complied with
- 2.6 The applicant made submission of a revised run-in/out proposal to comply with approval condition (e) on 17.11.2023, which was considered partially acceptable by the Commissioner for Transport, 27.12.2023

ONE AND A HALF YEARS LATER.

This is a large site, a fire or flooding would have a serious impact on the community.

IT IS HIGH TIME THAT BOTH GOVT DEPTS AND TPB GOT SERIOUS ABOUT THE TRUE INTENTION OF NATIONAL SECURITY - INSURING THE SAFETY AND WELL BEING OF THE COMMUNITY.

Applications like this should be rejected to send out a strong message that delaying tactics and failure to comply with regulations will no longer be tolerated.

Mary Mulvihill

From:

To: tpbpd < tpbpd@pland.gov.hk>

Date: Sunday, 20 November 2022 3:03 AM HKT

Subject: A/NE-KTS/517 DD 92 Kwu Tung South Recreation

A/NE-KTS/517

Lots 2219 (Part) and 2220 (Part) in D.D. 92, Kam Tsin Road nr Casas Domingo, Kwu Tung South

Site area: About 12,156sq.m

Zoning: "Recreation"

Applied use: Warehouse / 9 Vehicle Parking

Dear TPB Members,

Application 491 - 659th RNTPC MEETING ON 06.11.2020

After deliberation, the Committee decided to reject the application. The reasons were :

"(a) the proposed development is not in line with the planning intention of the "Recreation" zone in the Kwu Tung South area which is **primarily for recreational** developments for the use of the general public and to encourage the development of active and/or passive recreation and tourism/eco-tourism. There is no strong planning justification in the submission for a departure from the planning intention, even on a temporary basis; and

(b) the applicant fails to demonstrate that the proposed development would not generate adverse traffic impact on the surrounding areas."

This was just part of a larger operation, that appears to have been established years ago without the requisite approvals. Recreation zoning has always been a joke.

Joe Public can assume that the outcome for the current application will be similar but the operation will continue.

How much longer can this farcical charade persist?

Mary Mulvihill

From:

To: tpbpd <tpbpd@pland.gov.hk>

Date: Thursday, 15 October 2020 12:55 AM CST

Subject: A/NE-KTS/491 DD 92 Kwu Tung South Recreation

A/NE-KTS/491

Lot 2220 (Part) in D.D. 92, Kwu Tung South

Site area: About 4,795.98sq.m

Zoning: "Recreation"

Applied use: Warehouse / 12 Vehicle Parking

□Urgent	□Return receipt □Expand Group □Restricted □Prevent Copy
	Dear TPB Members,
Т	This is clearly an application to legitimatize an ongoing brownfield operation.
Т	The site lies at the heart of a cluster of residential enclaves and natural terrain.
е	The Kwu Tung South Development Plan was completed last year so now expectations are that the administration will get cracking with the project. Step No 1 is to remove brownfield operations that are not in line with the master plan.
	There is no previous history of approvals so members should expedite progress by ejecting applications that will impede implementation.
N	Mary Mulvihill