
This document is received on

The Town Planning Board will formally acknowledge the date of receipt of the application only upon receipt of all the required information and documents.

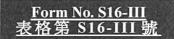

APPLICATION FOR PERMISSION UNDER SECTION 16 OF THE TOWN PLANNING ORDINANCE (CAP. 131)

根據《城市規劃條例》(第131章) 第16條遞交的許可申請

Applicable to Proposal Only Involving Temporary Use/Development of Land and/or Building Not Exceeding 3 Years in Rural Areas or Regulated Areas, or Renewal of Permission for such Temporary Use or Development*

適用於祇涉及位於鄉郊地區或受規管地區土地上及/或建築物內進行 為期不超過三年的臨時用途/發展或該等臨時用途/發展的許可續期的建議*

*Form No. S16-I should be used for other Temporary Use/Development of Land and/or Building (e.g. temporary use/developments in the Urban Area) and Renewal of Permission for such Temporary Use or Development.

*其他土地上及/或建築物內的臨時用途/發展 (例如位於市區內的臨時用途或發展)及有關該等臨時用途/發展的許可續期,應使用表格第 S16-I 號。

Applicant who would like to publish the <u>notice of application</u> in local newspapers to meet one of the Town Planning Board's requirements of taking reasonable steps to obtain consent of or give notification to the current land owner, please refer to the following link regarding publishing the notice in the designated newspapers: https://www.tpb.gov.hk/en/plan_application/apply.html

申請人如欲在本地報章刊登<u>申請通知</u>,以採取城市規劃委員會就取得現行土地擁有人的同意或通知現行土地擁有人所指定的其中一項合理步驟,請瀏覽以下網址有關在指定的報章刊登通知: https://www.tpb.gov.hk/tc/plan_application/apply.html

General Note and Annotation for the Form 填寫表格的一般指引及註解

- "Current land owner" means any person whose name is registered in the Land Registry as that of an owner of the land to which the application relates, as at 6 weeks before the application is made 「現行土地擁有人」指在提出申請前六星期,其姓名或名稱已在土地註冊處註冊為該申請所關乎的土地的擁有人的人
- & Please attach documentary proof 請夾附證明文件
- ^ Please insert number where appropriate 請在適當地方註明編號

Please fill "NA" for inapplicable item 請在不適用的項目填寫「不適用」

Please use separate sheets if the space provided is insufficient 如所提供的空間不足,請另頁說明

Please insert a 「✔」 at the appropriate box 請在適當的方格內上加上「✔」號

For Official Use Only	Application No. 申請編號	A/NE-TRL/757
請勿填寫此欄	Date Received 收到日期	2 4 APR 2C24

- 1. The completed form and supporting documents (if any) should be sent to the Secretary, Town Planning Board (the Board), 15/F, North Point Government Offices, 333 Java Road, North Point, Hong Kong. 申請人須把填妥的申請表格及其他支持申請的文件 (倘有),送交香港北角渣華道 333 號北角政府合署 15 樓城市規劃委員會(下稱「委員會」)秘書收。
- 2. Please read the "Guidance Notes" carefully before you fill in this form. The document can be downloaded from the Board's website at http://www.tpb.gov.hk/. It can also be obtained from the Secretariat of the Board at 15/F, North Point Government Offices, 333 Java Road, North Point, Hong Kong (Tel: 2231 4810 or 2231 4835), and the Planning Enquiry Counters of the Planning Department (Hotline: 2231 5000) (17/F, North Point Government Offices, 333 Java Road, North Point, Hong Kong and 14/F, Sha Tin Government Offices, 1 Sheung Wo Che Road, Sha Tin, New Territories). 請先細閱《申請須知》的資料單張,然後填寫此表格。該份文件可從委員會的網頁下載(網址: http://www.tpb.gov.hk/),亦可向委員會秘書處(香港北角渣華道 333 號北角政府合署 15 樓-電話:2231 4810 或2231 4835)及規劃資料查詢處(熱線:2231 5000) (香港北角渣華道 333 號北角政府合署 17 樓及新界沙田 上禾輋路 1 號沙田政府合署 14 樓)索取。
- 3. This form can be downloaded from the Board's website, and obtained from the Secretariat of the Board and the Planning Enquiry Counters of the Planning Department. The form should be typed or completed in block letters. The processing of the application may be refused if the required information or the required copies are incomplete. 此表格可從委員會的網頁下載,亦可向委員會秘書處及規劃署的規劃資料查詢處索取。申請人須以打印方式或以正楷填寫表格。如果申請人所提交的資料或文件副本不齊全,委員會可拒絕處理有關申請。

		Le Just 1 tot de la desta
l.	Name of Applicant	申請人姓名/名稱

(□Mr. 先生 /□Mrs. 夫人 /□Miss 小姐 /□Ms. 女士 / ☑ Company 公司 /□ Organisation 機構)

Luck Great Global Engineering Limited 興盛環球工程有限公司

Name of Authorised Agent (if applicable) 獲授權代理人姓名/名稱(如適用)

(□Mr. 先生 /□Mrs. 夫人 /□Miss 小姐 /□Ms. 女士 / ☑ Company 公司 /□ Organisation 機構)

R-riches Property Consultants Limited 盈卓物業顧問有限公司

3.	Application Site 申請地點	
(a)	Full address / location / demarcation district and lot number (if applicable) 詳細地址/地點/丈量約份及地段號碼(如適用)	Lots 5, 6 S.A, 6 S.A ss.1, 7, 8 S.A, 8 S.B, 9 S.A (Part), 9 S.B (Part), 10 S.B (Part) and 11 (Part) in D.D. 84, Ta Kwu Ling, New Territories
(b)	Site area and/or gross floor area involved 涉及的地盤面積及/或總樓面面 積	☑Site area 地盤面積 7,508 sq.m 平方米☑About 約 ☑Gross floor area 總樓面面積 6,804 sq.m 平方米☑About 約
(c)	Area of Government land included (if any) 所包括的政府土地面積(倘有)	N/A sq.m 平方米 □About 約

(d)	Name and number of statutory plan(s) 有關法定圖則的名稱及		Approved Ping Che and Ta Kwu Ling Outling S/NE-TKL/14	ne Zoning Plan No.	
(e)	Land use zone(s) involve 涉及的土地用途地帶	ed	"Agriculture" and "Industrial (Group D)" zon	es	
(f)	Current use(s) 現時用途		Vacant (If there are any Government, institution or community plan and specify the use and gross floor area) (如有任何政府、機構或社區設施,請在圖則上顯示		
4.	"Current Land Ow	ner" of A	pplication Site 申請地點的「現行土均	也擁有人」	
The	applicant 申請人 -				
	is the sole "current land c 是唯一的「現行土地擁	owner" ^{#&} (ple 有人」 ^{#&} (請	ease proceed to Part 6 and attach documentary proof 靠繼續填寫第6部分,並夾附業權證明文件)。	of ownership).	
	is one of the "current land owners" ^{# &} (please attach documentary proof of ownership). 是其中一名「現行土地擁有人」 ^{# &} (請夾附業權證明文件)。				
\checkmark	is not a "current land owner". 並不是「現行土地擁有人」#。				
	□ The application site is entirely on Government land (please proceed to Part 6). 申請地點完全位於政府土地上(請繼續填寫第 6 部分)。				
5.	Statement on Owne 就土地擁有人的		nt/Notification 紅土地擁有人的陳述		
(a)	involves a total of	"c	年		
(b)	The applicant 申請人 -				
	has obtained consen	ıt(s) of	"current land owner(s)"#.		
	三取得	名「	現行土地擁有人」"的同意。		
	Details of consent	of "current l	and owner(s)"# obtained 取得「現行土地擁有人	」"同意的詳情	
	No. of 'Current Land Owner(s)' 「現行土地擁有 人」數目	Registry wh	address of premises as shown in the record of the Land ere consent(s) has/have been obtained :冊處記錄已獲得同意的地段號碼/處所地址	Date of consent obtained (DD/MM/YYYY) 取得同意的日期 (日/月/年)	
	(Please use separate sh	heets if the spa	ace of any box above is insufficient. 如上列任何方格的空	5間不足,請另頁說明)	

	Details of the "current land owner(s)" # notified 已獲通知「現行土地擁有人」 #的詳細資料							
	No. of 'Current Land Owner(s)' 「現行土地擁 有人」數目	Lot number/address of premises as shown in the record of the Land Registry where notification(s) has/have been given 根據土地註冊處記錄已發出通知的地段號碼/處所地址	Date of notification given (DD/MM/YYYY) 通知日期(日/月/年)					
		-						
(1	Please use separate s	heets if the space of any box above is insufficient. 如上列任何方格的空	2間不足,請另頁說明)					
		e steps to obtain consent of or give notification to owner(s): 取得土地擁有人的同意或向該人發給通知。詳情如下:						
R	Leasonable Steps to	Obtain Consent of Owner(s) 取得土地擁有人的同意所採取的	内合理步驟					
		r consent to the "current land owner(s)" on (日/月/年)向每一名「現行土地擁有人」"郵遞要求同						
<u>R</u>	Reasonable Steps to Give Notification to Owner(s) 向土地擁有人發出通知所採取的合理步驟							
		ces in local newspapers on(DD/MM/YY (日/月/年)在指定報章就申請刊登一次通知&	YY) ^{&}					
Ţ		n a prominent position on or near application site/premises on /04/2024 (DD/MM/YYYY)&						
	於	(日/月/年)在申請地點/申請處所或附近的顯明位置	貼出關於該申請的通					
S	office(s) or run	relevant owners' corporation(s)/owners' committee(s)/mutual aid ral committee on05/04/2024 (DD/MM/YYYY)& (日/月/年)把通知寄往相關的業主立案法團/業主委 即鄉事委員會 ^{&}						
<u>C</u>	Others 其他							
	others (please 其他(請指明							
			,					

6.	Type(s) of Applica	tion 申請類別	到		THE CONTRACT OF THE CONTRACT O	
(A)	Temporary Use/Dev Regulated Areas 位於鄉郊地區或受規 (For Renewal of Perm proceed to Part (B)) (如屬位於鄉郊地區或	管地區土地上及 ission for Tempo	:/或建築物內進? rary Use or Devel	了為期不超過三年 opment in Rural	F的臨時用途/發展 Areas or Regulated A	
ι	Proposed ise(s)/development 疑議用途/發展	Ancillary F	acilities for a Peri	od of 3 Years and	Dangerous Goods Goo Associated Filling of L	_and
ŗ	Effective period of permission applied for 申請的許可有效期	☑ y	te the details of the pro rear(s) 年 nonth(s) 個月	oposal on a layout pla	n) (請用平面圖說明擬議記	<u> </u>
	Development Schedule 發		() () ()			
	Proposed uncovered land		面積		4,106 sq.m	✓About 約
	roposed covered land are				3,402 sq.m [
	Proposed number of build			数目	1	
	Proposed domestic floor a				N/Asq.m [□About 約
	Proposed non-domestic flo				6,804sq.m	
	Proposed gross floor area 擬議總樓面面積 6,804 sq.m ☑About 約					
	osed height and use(s) of		buildings/structures			
	議用途 (如適用) (Please			202		
ST	RUCTURE USE		COVERED AREA	GFA	BUILDING HEIGHT	******
B1	WAREHOUSE (E SITE OFFICE, W	EXCLUDING D.G.G.), 'ASHROOM	3,402 m ² (ABOUT)	6,804 m² (ABOUT)	13 m (ABOUT)(2-STOREY)	
		TOTAL	3,402 m ² (ABOUT)	6,804 m ² (ABOUT)		
Prop	osed number of car parki	ng spaces by types	不同種類停車位的	り擬議數目		
Priva	ate Car Parking Spaces 系	公家車車位			4 (Private Car)	
	orcycle Parking Spaces					
_	t Goods Vehicle Parking					
	ium Goods Vehicle Parki vy Goods Vehicle Parkins	5-50 AM Statement AM				
	ers (Please Specify) 其他		·/ロギ-IIL			
	1 0, , , , ,	(0.4% 3.54)				
Prop	osed number of loading/u	ınloading spaces 🕸	落客貨車位的擬諱	養數 目		
Taxi	Spaces 的士車位					
	ch Spaces 旅遊巴車位					
	t Goods Vehicle Spaces			3	(Medium Goods Vehic	ole)
	ium Goods Vehicle Space yy Goods Vehicle Spaces					
	ers (Please Specify) 其他				3 (Container Vehicle)	
	Suite (1 teace Speedy) (N/E (BA/ 1/1)					

Proposed operating hours 擬議營運時間 Monday to Saturday from 07:00 to 19:00, no operation on Sunday and public holiday					
(d)	Any vehicular acce the site/subject buildi 是否有車路通往地 有關建築物?	ing?	 ✓ There is an existing access. (please indicate the street name, where appropriate) 有一條現有車路。(請註明車路名稱(如適用)) Accessible from Ping Che Road via a local access □ There is a proposed access. (please illustrate on plan and specify the width) 有一條擬議車路。(請在圖則顯示,並註明車路的闊度) 		
		No 否			
(e)	(If necessary, please u	ise separate shee for not providin	議發展計劃的影響 ts to indicate the proposed measures to minimise possible adverse impacts or give g such measures. 如需要的話,請另頁註明可盡量減少可能出現不良影響的		
(ii)	Does the development proposal involve alteration of existing building? 擬議發展計劃是否包括現有建築物的改動? Does the development proposal involve the operation on the right? 擬議發展是否涉及右列的工程?	No 否 🗹 Yes 是 🗹 (Please provide details 請提供詳情 Please indicate on site plan the boundary of concerned land/pond(s), and particulars of stream iversion, the extent of filling of land/pond(s) and/or excavation of land) 請用地盤平面圖顯示有關土地/池塘界線,以及河道改道、填塘、填土及/或挖土的細節及/或範圍) Diversion of stream 河道改道 Filling of pond 填塘 Area of filling 填塘面積 Depth of filling 填塘深度		
(iii)	Would the development proposal cause any adverse impacts? 擬議發展計劃會否造成不良影響?	Landscape Imp Tree Felling Visual Impact	第 Yes 會 □ No 不會 ▼ y 對供水 Yes 會 □ No 不會 ▼ 排水 Yes 會 □ No 不會 ▼ 財坡 Yes 會 □ No 不會 ▼ pes 受斜坡影響 Yes 會 □ No 不會 ▼ act 構成景觀影響 Yes 會 □ No 不會 ▼ 次伐樹木 Yes 會 □ No 不會 ▼		

diamet 請註明	state measure(s) to minimise the impact(s). For tree felling, please state the number, er at breast height and species of the affected trees (if possible) are also because of the affected trees (if possibl
[10] : [r Temporary Use or Development in Rural Areas or Regulated Areas 區臨時用途/發展的許可續期
(a) Application number to which the permission relates 與許可有關的申請編號	A//
(b) Date of approval 獲批給許可的日期	(DD 日/MM 月/YYYY 年)
(c) Date of expiry 許可屆滿日期	(DD 日/MM 月/YYYY 年)
(d) Approved use/development 已批給許可的用途/發展	
(e) Approval conditions 附帶條件	□ The permission does not have any approval condition 許可並沒有任何附帶條件 □ Applicant has complied with all the approval conditions 申請人已履行全部附帶條件 □ Applicant has not yet complied with the following approval condition(s): 申請人仍未履行下列附帶條件: □ Reason(s) for non-compliance: 仍未履行的原因: □ (Please use separate sheets if the space above is insufficient) (如以上空間不足,請另頁說明)
(f) Renewal period sought 要求的續期期間	□ year(s) 年 □ month(s) 個月

7. Justifications 理由
The applicant is invited to provide justifications in support of the application. Use separate sheets if necessary. 現請申請人提供申請理由及支持其申請的資料。如有需要,請另頁說明)。
Please refer to the supplementary statement.
7
*

8. Declaration 聲明
I hereby declare that the particulars given in this application are correct and true to the best of my knowledge and belief. 本人謹此聲明,本人就這宗申請提交的資料,據本人所知及所信,均屬真實無誤。
I hereby grant a permission to the Board to copy all the materials submitted in this application and/or to upload such materials to the Board's website for browsing and downloading by the public free-of-charge at the Board's discretion. 本人現准許委員會酌情將本人就此申請所提交的所有資料複製及/或上載至委員會網站,供公眾免費瀏覽或下載。
Signature 日本 Applicant 申請人 / Authorised Agent 獲授權代理人
Michael WONG
Name in Block Letters Position (if applicable) 姓名(請以正楷填寫) 職位 (如適用)
Professional Qualification(s) 專業資格 □ Member 會員 / □ Fellow of 資深會員 □ HKIP 香港規劃師學會 / □ HKIA 香港建築師學會 / □ HKIS 香港測量師學會 / □ HKIE 香港工程師學會 / □ HKILA 香港園境師學會 / □ HKIUD 香港城市設計學會 □ RPP 註冊專業規劃師 Others 其他
on behalf of R-riches Property Consultants Limited 盈卓物業顧問有限公司
▼ Company 公司 / □ Organiskion Name and Chop (if applicable) 機構名稱及蓋章(如適用) Date 日期 15/4/2024 (DD/MM/YYYY 日/月/年)

Remark 備註

The materials submitted in this application and the Board's decision on the application would be disclosed to the public. Such materials would also be uploaded to the Board's website for browsing and free downloading by the public where the Board considers appropriate.

委員會會向公眾披露申請人所遞交的申請資料和委員會對申請所作的決定。在委員會認為合適的情況下,有關申請資料亦會上載至委員會網頁供公眾免費瀏覽及下載。

Warning 警告

Any person who knowingly or wilfully makes any statement or furnish any information in connection with this application, which is false in any material particular, shall be liable to an offence under the Crimes Ordinance. 任何人在明知或故意的情况下,就這宗申請提出在任何要項上是虛假的陳述或資料,即屬違反《刑事罪行條例》。

Statement on Personal Data 個人資料的聲明

- 1. The personal data submitted to the Board in this application will be used by the Secretary of the Board and Government departments for the following purposes:
 - 委員會就這宗申請所收到的個人資料會交給委員會秘書及政府部門,以根據《城市規劃條例》及相關的城市規劃委員會規劃指引的規定作以下用途:
 - (a) the processing of this application which includes making available the name of the applicant for public inspection when making available this application for public inspection; and 處理這宗申請,包括公布這宗申請供公眾查閱,同時公布申請人的姓名供公眾查閱;以及
 - (b) facilitating communication between the applicant and the Secretary of the Board/Government departments. 方便申請人與委員會秘書及政府部門之間進行聯絡。
- 2. The personal data provided by the applicant in this application may also be disclosed to other persons for the purposes mentioned in paragraph 1 above.
 申請人就這宗申請提供的個人資料,或亦會向其他人士披露,以作上述第 1 段提及的用途。
- 3. An applicant has a right of access and correction with respect to his/her personal data as provided under the Personal Data (Privacy) Ordinance (Cap. 486). Request for personal data access and correction should be addressed to the Secretary of the Board at 15/F, North Point Government Offices, 333 Java Road, North Point, Hong Kong. 根據《個人資料(私隱)條例》(第 486 章)的規定,申請人有權查閱及更正其個人資料。如欲查閱及更正個人資料,應向委員會秘書提出有關要求,其地址為香港北角渣華道 333 號北角政府合署 15 樓。

Gist of Application 申請摘要	Gist	of A	pplica	ation	申請摘要
--------------------------	------	------	--------	-------	------

(Please provide details in both English and Chinese <u>as far as possible</u>. This part will be circulated to relevant consultees, uploaded to the Town Planning Board's Website for browsing and free downloading by the public and available at the Planning Enquiry Counters of the Planning Department for general information.)

(請<u>盡量以英文及中文填寫。此部分將會發送予相關諮詢人士、上載至城市規劃委員會網頁供公眾免費瀏覽及下載及於規劃署規劃資料查詢處供一般參閱。)</u>

下 取 及 於 祝 動 者 祝 !	到貞科宣問處供一般奓ര。)
Application No. 申請編號	(For Official Use Only) (請勿填寫此欄)
Location/address 位置/地址	Lots 5, 6 S.A, 6 S.A ss.1, 7, 8 S.A, 8 S.B, 9 S.A (Part), 9 S.B (Part), 10 S.B (Part) and 11 (Part) in D.D. 84, Ta Kwu Ling, New Territories
Site area	7,508 sq. m 平方米 ☑ About 約
地盤面積	(includes Government land of包括政府土地 N/A sq. m 平方米 □ About 約)
Plan 圖則	Approved Ping Che and Ta Kwu Ling Outline Zoning Plan No. S/NE-TKL/14
Zoning 地帶	"Agriculture" and "Industrial (Group D)" zones
Type of Application 申請類別	 ✓ Temporary Use/Development in Rural Areas or Regulated Areas for a Period of 位於鄉郊地區或受規管地區的臨時用途/發展為期 ✓ Year(s) 年 3 □ Month(s) 月
	w rear(s) + □ Wionun(s) /
	□ Renewal of Planning Approval for Temporary Use/Development in Rural Areas or Regulated Areas for a Period of 位於鄉郊地區或受規管地區臨時用途/發展的規劃許可續期為期 □ Year(s) 年 □ Month(s) 月
Applied use/ development 申請用途/發展	Proposed Temporary Warehouse (Excluding Dangerous Goods Godown) with Ancillary Facilities for a Period of 3 Years and Associated Filling of Land

(i)	Gross floor area		sq.	m 平方米	Plot R	Katio 地積比率
	and/or plot ratio 總樓面面積及/或 地積比率	Domestic 住用	N/A	□ About 約 □ Not more than 不多於	N/A	□About 約 □Not more than 不多於
		Non-domestic 非住用	6,804	☑ About 約 □ Not more than 不多於	0.91	☑About 約 □Not more than 不多於
(ii)	No. of blocks 幢數	Domestic 住用		N/A		-
		Non-domestic 非住用		1		
(iii) Building height/No. of storeys 住用 N/A 建築物高度/層數		N/A	□ (Not	m 米 more than 不多於)		
				N/A	□ (Not	Storeys(s) 層 more than 不多於)
		Non-domestic 非住用		13 (about)	□ (Not	m 米 more than 不多於)
				2	□ (Not	Storeys(s) 層 more than 不多於)
(iv)	Site coverage 上蓋面積		45		%	☑ About 約
(v)	No. of parking spaces and loading / unloading spaces 停車位及上落客貨車位數目	Total no. of vehicle parking spaces 停車位總數 Private Car Parking Spaces 私家車車位 Motorcycle Parking Spaces 電單車車位 Light Goods Vehicle Parking Spaces 輕型貨車泊車位 Medium Goods Vehicle Parking Spaces 中型貨車泊車位 Heavy Goods Vehicle Parking Spaces 重型貨車泊車位 Others (Please Specify) 其他 (請列明) Total no. of vehicle loading/unloading bays/lay-bys 上落客貨車位/停車處總數 Taxi Spaces 的士車位		4 4 (Private Car)		
		Coach Spaces 旅 Light Goods Veh Medium Goods Veh Heavy Goods Veh Others (Please Sp Container Vehicle	遊巴車位 icle Spaces 輕 Yehicle Spaces hicle Spaces 重 ecify) 其他(中型貨車位 型貨車車位		3 (Medium Goods Vehicle) 3 (Container Vehicle)

Submitted Plans, Drawings and Documents 提交的圖則、繪圖及文件		
	<u>Chinese</u> 中文	English 英文
Plans and Drawings 圖則及繪圖		
Master layout plan(s)/Layout plan(s) 總綱發展藍圖/布局設計圖		\checkmark
Block plan(s) 樓宇位置圖		
Floor plan(s) 樓宇平面圖		
Sectional plan(s) 截視圖		
Elevation(s) 立視圖		
Photomontage(s) showing the proposed development 顯示擬議發展的合成照片		
Master landscape plan(s)/Landscape plan(s) 園境設計總圖/園境設計圖		
Others (please specify) 其他 (請註明)		\checkmark
Location Plan, Plan showing the land status, zoning and land filling area of the application	i site,	
Swept path analysis		
Reports 報告書		_,
Planning Statement/Justifications 規劃綱領/理據		\mathbf{Z}
Environmental assessment (noise, air and/or water pollutions)		
環境評估(噪音、空氣及/或水的污染)		_
Traffic impact assessment (on vehicles) 就車輛的交通影響評估		
Traffic impact assessment (on pedestrians) 就行人的交通影響評估		
Visual impact assessment 視覺影響評估		
Landscape impact assessment 景觀影響評估		
Tree Survey 樹木調査		
Geotechnical impact assessment 土力影響評估		
Drainage impact assessment 排水影響評估		
Sewerage impact assessment 排污影響評估 Risk Assessment 風險評估		
Others (please specify) 其他(請註明)		
Outers (brease abcour) Adm (relativity		
Mote: May insert more than one 「 v 」. 註:可在多於一個方格內加上「 v 」號		
Note: May lisert more than one V]. 註・円仕夕於一個刀恰內加工 V] 號		

Note: The information in the Gist of Application above is provided by the applicant for easy reference of the general public. Under no circumstances will the Town Planning Board accept any liabilities for the use of the information nor any inaccuracies or discrepancies of the information provided. In case of doubt, reference should always be made to the submission of the applicant. 註: 上述申請摘要的資料是由申請人提供以方便市民大眾參考。對於所載資料在使用上的問題及文義上的歧異,城市規劃委員

Supplementary Statement

1) Background

- 1.1 The applicant seeks planning permission from the Town Planning Board (the Board) to use Lots 5, 6 S.A, 6 S.A ss.1, 7, 8 S.A, 8 S.B, 9 S.A (Part), 9 S.B (Part), 10 S.B (Part) and 11 (Part) in D.D. 84, Ta Kwu Ling, New Territories (the Site) for 'Proposed Temporary Warehouse (Excluding Dangerous Goods Godown) with Ancillary Facilities for a Period of 3 Years and Associated Filling of Land' (proposed development) (Plan 1 to 3).
- 1.2 Due to the increasing demand for warehouse floorspace in recent years, the applicant would like to use the Site for warehouse in order to support the local warehousing and storage industry.

2) Planning Context

- 2.1 The Site currently falls within an area zoned as "Agriculture" ("AGR") and "Industrial (Group D)" ("(D)") Zones on the Approved Ping Che and Ta Kwu Ling Outline Zoning Plan (OZP) No.: S/NE-TKL/14. According to the Notes of the OZP, the applied use is not a column one nor two uses within the "AGR" zone, which requires planning permission from the Board (Plan 2).
- 2.2 Although the Site falls within area zoned as "AGR", there is no active agricultural use within the Site. The Site is also surrounded by sites occupied by open storage yards and some low-rise temporary structures; hence, the proposed development is considered not incompatible with the surrounding area. Therefore, approval of the current application on a temporary basis of 3 years would better utilize deserted agricultural land in the New Territories and would not jeopardize the long-term planning intention of the "AGR" zone.
- 2.3 Portion of the Site is the subject of a previous S.16 planning application (No. A/NE-TKL/306) for 'temporary open storage of metal goods and equipment', however, the application was rejected by the Board in 2008. As the proposed development is in different nature and was rejected by the Board 16 years ago, the previous rejected application is considered irrelevant. Furthermore, similar S.16 planning application (No. A/NE-TKL/737) for the same use was approved within the same "AGR" zone by the Board, hence, approval of the current application is in line with the Board's previous decisions and would not set undesirable precedent within the "AGR" zone.



3) Development Proposal

3.1 The Site occupied an area of 7,508 m² (about) (**Plan 3**). The operation hours of Site are Monday to Saturday from 07:00 to 19:00. No operation on Sunday and public holiday. One 2-storey structure is proposed at the Site for warehouse (excluding dangerous goods godown), site office and washroom with total GFA of 6,804 m² (about) (**Plan 4**). The ancillary site office is intended to provide indoor workspace for administrative staff to support the daily operation of the Site. It is estimated that the Site would be able to accommodate 8 staff. As the Site is proposed for 'warehouse' use with no shopfront, no visitor is anticipated at the Site. Details of development parameters are shown at **Table 1** below:

Table 1 – Major Development Parameters

-		
Application Site Area	7,508 m² (about)	
Covered Area	3,402 m² (about)	
Uncovered Area	4,106 m² (about)	
Plot Ratio	0.91 (about)	
Site Coverage	45 % (about)	
Number of Structure	1	
Total GFA	6,804 m² (about)	
- Domestic GFA	Not applicable	
- Non-Domestic GFA	6,804 m² (about)	
Building Height	13 m (about)	
No. of Storey	2	

- 3.2 The proposed warehouse is intended for storage of miscellaneous goods (including but not limited to packaged food, apparel, footwear, electronic goods, furniture etc.). No dangerous goods and workshop activities will be stored/conducted at the Site at any time during the planning approval period.
- 3.3 The Site is proposed to be filled wholly with concrete of not more than 2.1 m (about) in depth for site formation of structures, parking space, loading/unloading (L/UL) spaces and circulation area (Plan 5). As heavy loading of structures and vehicles would compact the existing soiled ground and weaken the ground surface, concrete site formation is required to meet the operation needs and the extent of filling has been kept to minimal. The applicant will

reinstate the Site to an amenity area after the planning approval period.

- 3.4 All the proposed works will be carried out at 3 m away from the top bank of the existing Ping Yuen River that is located at the west of the Site (**Plans 1**, **3** and **4**). All the proposed works will not create any adverse impact both during and after the construction to the existing Ping Yuen River.
- 3.5 The Site is accessible from Ping Che Road via a local access (**Plan 1**). A total of 10 parking and L/UL spaces are provided at the Site, details are shown at **Table 2** below:

Table 2 – Parking and L/UL Provisions

Type of Space	No. of Space	
Private Car (PC) Parking Space for Staff	4	
- 2.5 m (W) x 5 m (L)	+	
L/UL Space for Medium Goods Vehicle (MGV)	2	
- 3.5 m (W) x 11 m (L)	3	
L/UL Space for Container Vehicle (CV)	2	
- 3.5 m (W) x 16 m (L)	3	

3.6 Private car parking spaces are provided for staff to commute to the Site. MGVs and CV are deployed for transportation of goods to be stored at the Site, hence, L/UL spaces for the aforesaid vehicles are provided (Plan 4). Sufficient space is also provided for vehicle to smoothly manoeuvre within the Site to ensure that no vehicle will turn back onto the local access (Plan 6). Staff is also deployed at the ingress/ egress of the Site to direct vehicle entering/exiting the Site to enhance pedestrian safety. As traffic generated and attracted by the proposed development is minimal (as shown at Table 3 below), adverse traffic impact to the nearby road network should not be anticipated.

Table 3 –Trip Generation and Attraction of the Site

Time Period	PC		MGV		CV		2-Way
Time Period	In	Out	In	Out	In	Out	Total
Trips at AM peak per hour	1	0	2	2	2	2	9
(07:00 – 08:00)	1		2	2	2		9
Trips at PM peak per hour	1	1	2	2	2	2	10
(15:00 – 16:00)		1	2	2	2		10
Traffic trip per hour	1	1	1	1	1	1	6
(average)	1	1	1	1	1		0



3.7 The applicant will strictly follow the 'Code of Practice on Handling the Environmental Aspects of Temporary Uses and Open Storage Sites' issued by Environmental Protection Department (EPD) to minimise adverse environmental impacts and nuisance to the surrounding area. The applicant will strictly comply with all environmental protection / pollution control ordinances, i.e. Water Pollution Control Ordinance, Air Pollution Control Ordinance, Noise Control Ordinance etc. at any time during the planning approval period. The applicant will follow the Professional Persons Environmental Consultative Committee Practice Notes (ProPECCPNs) for sewage treatment at the Site.

4) Conclusion

- 4.1 The proposed development will not create significant nuisance to the surrounding areas. Adequate mitigation measures will be provided, i.e. submission of drainage and fire service installations proposals to mitigate any adverse impact arising from the proposed development after planning permission has been granted from the Board.
- 4.2 In view of the above, the Board is hereby respectfully recommended to <u>approve</u> the subject application for 'Proposed Temporary Warehouse (Excluding Dangerous Goods Godown) with Ancillary Facilities for a Period of 3 Years and Associated Filling of Land'.

R-riches Property Consultants Limited


April 2024





LIST OF PLANS

Plan 1	Location Plan
Plan 2	Plan Showing the Zoning of the Application Site
Plan 3	Plan Showing the Land Status of the Application Site
Plan 4	Layout Plan
Plan 5	Plan Showing the Filling of Land Area of the Application Site
Plan 6	Swept Path Analysis



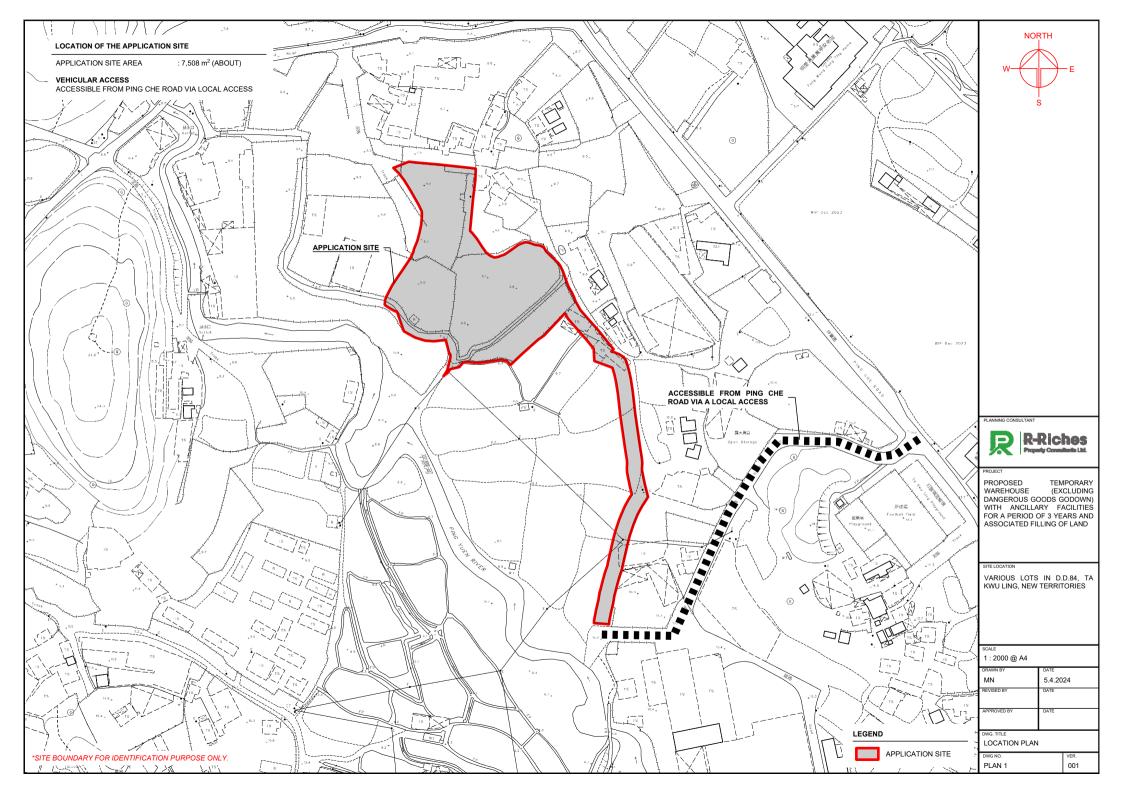

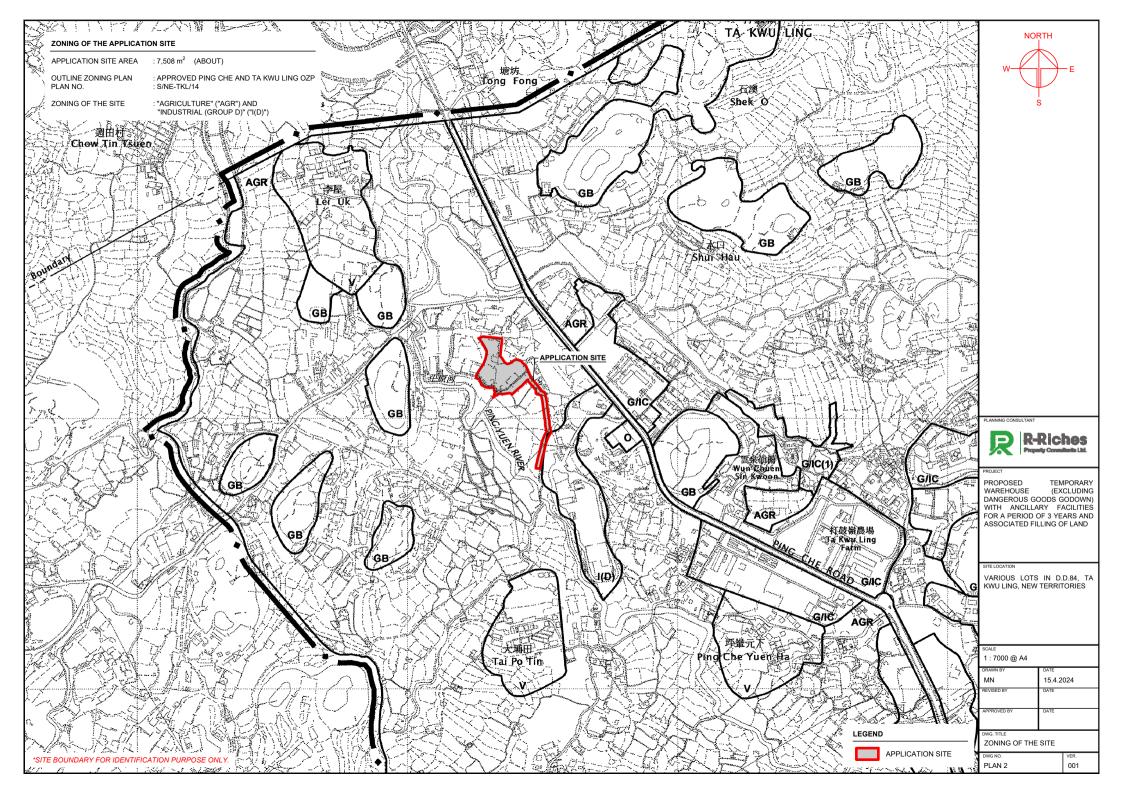

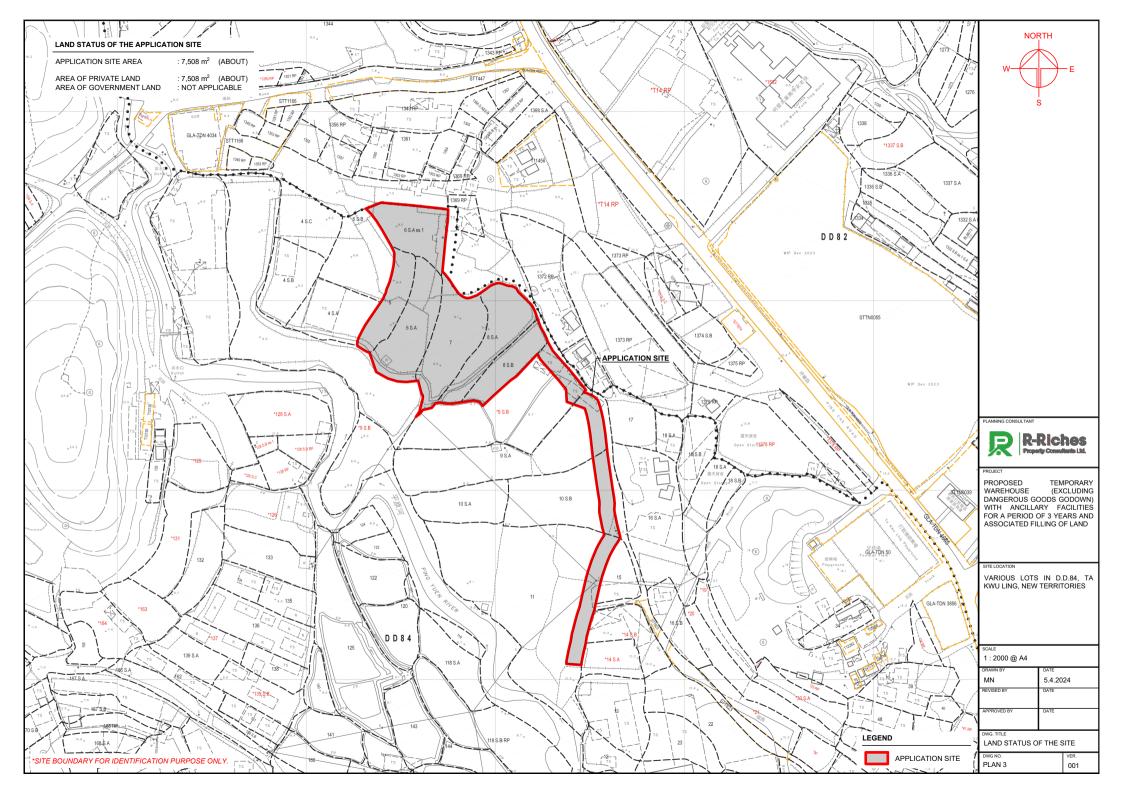

DEVELOPMENT PARAMETERS : 7,508 m² : 3,402 m² : 4,106 m² (ABOUT) (ABOUT) (ABOUT) APPLICATION SITE AREA COVERED AREA UNCOVERED AREA


(ABOUT) (ABOUT) PLOT RATIO SITE COVERAGE : 45 % NO. OF STRUCTURE DOMESTIC GFA NON-DOMESTIC GFA : 1 : NOT APPLICABLE

(ABOUT) (ABOUT) : 6,804 m² : 6,804 m² TOTAL GFA BUILDING HEIGHT NO. OF STOREY (ABOUT) : 13 m : 2

STRUCTURE	USE	COVERED AREA	GFA	BUILDING HEIGHT
B1	WAREHOUSE (EXCLUDING D.G.G.), SITE OFFICE, WASHROOM	3,402 m ² (ABOUT)	6,804 m ² (ABOUT)	13 m (ABOUT)(2-STOREY)

6,804 m² (ABOUT)

TOTAL 3,402 m² (ABOUT)

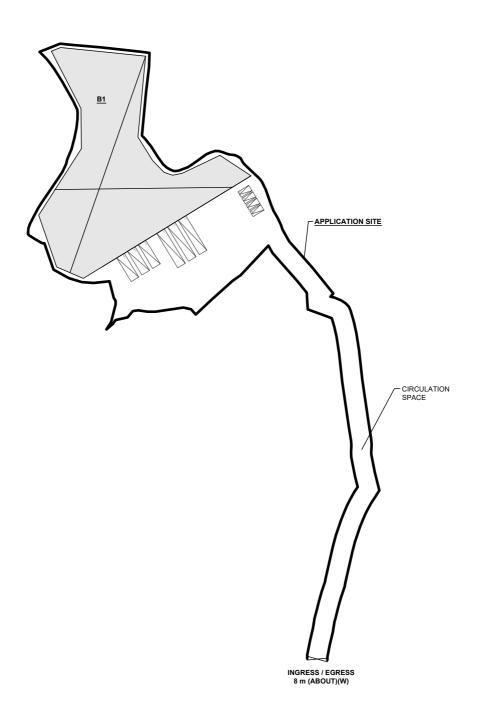

PARKING AND LOADING / UNLOADING (L/UL) PROVISIONS

NO. OF PRIVATE CAR PARKING SPACE DIMENSION OF PARKING SPACE

: 4 : 5 m (L) x 2.5 m (W) : 3 : 11 m (L) x 3.5 m (W)

NO. OF LOADING / UNLOADING SPACE FOR MEDIUM GOODS VEHICLE (MGV) DIMENSION OF L/UL SPACE

NO. OF LOADING/UNLOADING SPACE FOR CONTAINER VEHICLE (CV) DIMENSION OF L/UL SPACE

: 3 : 16 m (L) x 3.5 m (W)

LEGEND

APPLICATION SITE STRUCTURE

PARKING SPACE (PC)

LOADING / UNLOADING SPACE (MGV) LOADING / UNLOADING SPACE (CV)

INGRESS / EGRESS



PROJECT PROJECT
PROPOSED TEMPORARY WAREHOUSE
(EXCLUDING DANGEROUS GOODS GODOWN)
WITH ANCILLARY FACILITIES FOR A PERIOD
OF 3 YEARS AND ASSOCIATED FILLING OF
LAND ADDRESS VARIOUS LOTS IN D.D.84, TA KWU LING, NEW **TERRITORIES**

1 : 1500 @ A4	LAYOUT PLAN		
MN	5.4.2024		
REVISED BY	DATE	DWG NO.	VER.



APPLICATION SITE BEFORE FILLING OF LAND

APPLICATION SITE AREA

EXISTING SITE CONDITION

SITE LEVELS BEFORE FILLING OF LAND

: 7,508 m²

: SOILED GROUND

: +8.1 mPD - 9.6 mPD (ABOUT)

(ABOUT)

APPLICATION SITE AREA COVERED BY STRUCTURE : 7.508 m² (ABOUT) : 3,402 m² (ABOUT)

(ABOUT)

PROPOSED LAND FILLING AREA DEPTH OF LAND FILLING

EXISTING FILLING OF LAND AREA

: 7,508 m² : NOT MORE THAN 2.1 m


PROPOSED SITE LEVELS MATERIAL OF LAND FILLING : +10.2 mPD (ABOUT) : CONCRETÈ


PARKING AND LOADING / UNLOADING

: SITE FORMATION OF STRUCTURES,

AND CIRCULATION AREA



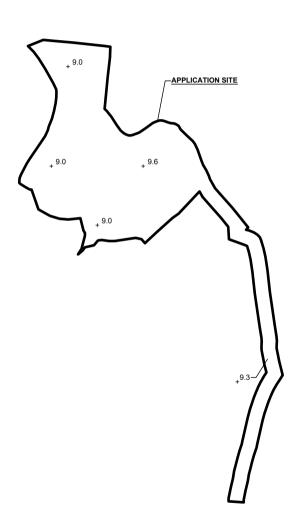

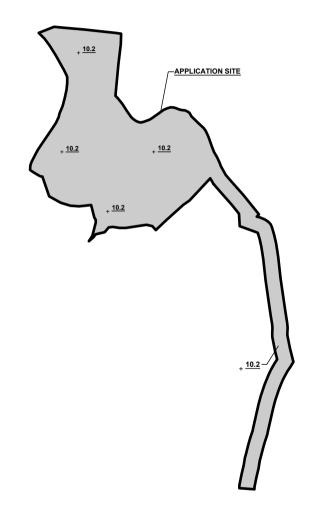

PLANNING CONSULTANT



PROPOSED TEMPORARY WAREHOUSE (EXCLUDING DANGEROUS GOODS GODOWN) WITH ANCILLARY FACILITIES FOR A PERIOD OF 3 YEARS AND ASSOCIATED FILLING OF LAND

VARIOUS LOTS IN D.D.84, TA KWU LING, NEW TERRITORIES

1:2000 @ A4 MN 5.4.2024 REVISED BY DWG. TITLE

FILLING OF LAND

LEGEND

APPLICATION SITE

LAND FILLING AREA

+ 3.4 PROPOSED SITE LEVEL


PLAN 5 001

LEGEND

APPLICATION SITE

_3.4 EXISTING SITE LEVEL

*SITE LEVELS ARE FOR REFERENCE ONLY.

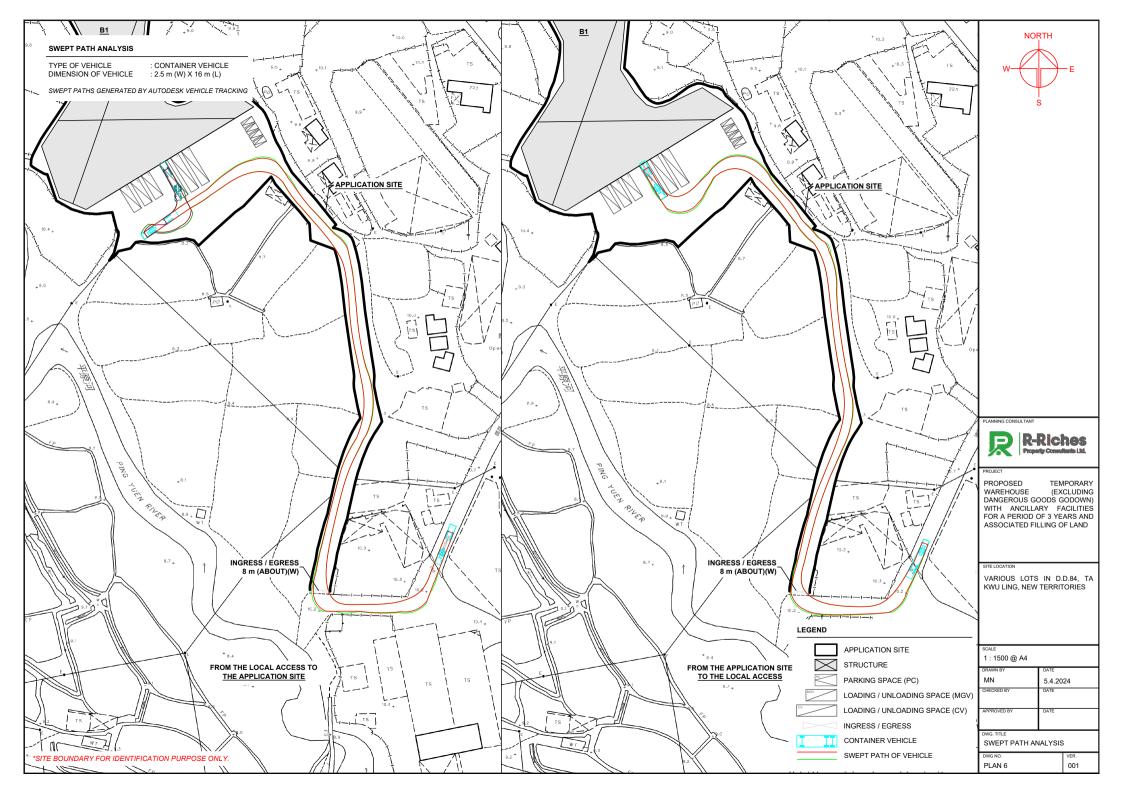





Our Ref.: DD84 Lot 5 & VL TPB/A/NE-TKL/757 Your Ref.:

The Secretary, Town Planning Board, 15/F, North Point Government Offices, 333 Java Road, North Point, Hong Kong

By Email

13 June 2024

Dear Sir,

1st Further Information

Proposed Temporary Warehouse (Excluding Dangerous Goods Godown) with Ancillary Facilities for a Period of 3 Years and Associated Filling of Land in "Agriculture" and "Industrial (Group D)" Zones, Various Lots in D.D. 84, Ta Kwu Ling, New Territories

(S.16 Planning Application No. A/NE-TKL/757)

We are writing to submit further information to address departmental comments of the subject application (Appendix I).

Should you require more information regarding the application, please contact our Mr. Christian CHIM at (852) 2339 0884 / christianchim@r-riches.com.hk or the undersigned at your convenience. Thank you for your kind attention.

Yours faithfully,

For and on behalf of

R-riches Property Consultants Limited

Louis TSE

Town Planner

cc DPO/STN, PlanD

(Attn.: Ms. Sheren LEE


email: sswlee@pland.gov.hk

(Attn.: Ms. Katie LEUNG

email: kyyleung@pland.gov.hk)





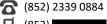



Responses-to-Comments

Proposed Temporary Warehouse (Excluding Dangerous Goods Godown) with Ancillary Facilities for a Period of 3 Years and Associated Filling of Land
<a href="in-"Agriculture" and "Industrial (Group D)" Zones, Various Lots in D.D. 84, Ta Kwu Ling, New Territories

(Application No. A/NE-TKL/757)

(i) A RtoC Table:

	Departmental Comments	Applicant's Responses
1. Comments of the Director of Agriculture, Fisheries and Conservation (DAFC)
(a)	From agricultural perspective The subject site falls mostly within the "AGR" zone and part of the site is generally abandoned or under cultivation. The agricultural activities are active in the vicinity, and agricultural infrastructures such as road access and water source are also available. The subject site can be used for agricultural activities such as open-field cultivation, greenhouses, plant nurseries, etc. As the subject site possesses potential for agricultural rehabilitation, the proposed development is not supported from agricultural perspective.	Although the application site (the Site) partially falls within area zoned as "Agriculture" ("AGR"), there is no active agricultural use within the Site. The proposed use is considered not incompatible with surrounding land uses which is dominated by open storage yards and some low-rise temporary structures. Therefore, approval of the current application on a temporary basis of 3 years would better utilize deserted agricultural land in the New Territories and would not jeopardize the long-term planning intention of the "AGR" zone.
(b)	From nature conservation perspective I noted the boundary is revised by comparing that to the previous planning application No. A/NE-TKL/750 and is set slightly away from Ping Yuen River. However, the Ping Yuen River is still located close to the southwestern boundary of the subject site. The applicant should clarify whether Ping Yuen River will be affected by the proposed development during the construction and operation stage and	Boundary fencing will be placed along the Site during the planning approval period to avoid adverse impact to the Ping Yuen River. The boundary fencing will be installed properly by licensed contractor and maintenance will be conducted regularly to prevent misalignment of walls and to ensure that there is no gap or silt on the boundary fencing.

proposed measures to avoid adverse impact to the Ping Yuen River nearby.

2. Comments of the Chief Highway Engineer/New Territories East, Highways Department (CHE/NTE, HyD)

(a) We have no comment on the captioned planning application. Please note that the access road adjacent to the site is not maintained by HyD.

Noted.

3. Comments of Chief Town Planner/Urban Design and Landscape, Planning Department (CTP/UD&L, PlanD)

Based on the aerial photo of 2023, the site is located in an area of miscellaneous rural fringe landscapes character comprising of open storages, temporary structures, vegetated areas, farmlands, clusters of trees and woodlands within the "Green Belt" zones at the west. The proposed use under this application is considered not incompatible with its surrounding environment. Based on our site record taken on 25.3.2024, the site is mostly fenced off and vacant. Tree groups of common and self-seeded invasive species are observed along the boundary within the northern portion of the site. In comparison with the aerial photo of Feb 2023, vegetation in the centre of the site have been cleared. Several piles of felled tree branches and scattered burnt plants were observed. Impact on the landscape resources within the site has been taken place. According to Para. 3.3 of the Supplementary Statement, the site is proposed to be filled wholly with concrete of not more than 2.1m (about) in depth. Noting that no information on existing trees within and along the site boundary, proposed tree treatment, and mitigation measures/ landscape proposal are provided in the application,

A landscape proposal is submitted by the applicant to provide landscape mitigation measures for the proposed development (**Plan 1**). <u>18</u> new trees (N1 to N18) are proposed to be planted along the southeast boundary of the application site (the Site) to enhance the landscape quality. All these new trees within the Site will be maintained by the applicant during the planning approval period.



	makankial aduana inggatan dan kanapitating landagan magawas within	
	potential adverse impact on the existing landscape resources within	
	the site arising from the proposed use cannot be reasonably	
	ascertained.	
(b)	The applicant is advised to provide basic information (e.g. species,	
	size, general conditions and tree photos) on existing trees within and	
	along the site boundary, proposed tree treatments and mitigation	
	measures for TPB's consideration.	
4 (Comments of the Commissioner for Transport (C for T)	
(a)	The applicant should conduct traffic count surveys to the nearby	Traffic count surveys were conducted at the key locations on 29/5/2024
	road links and junctions, advise and substantiate the additional	(Wednesday) PM and 30/5/2024 (Thursday) AM with survey period of 07:00
	traffic flow generated by the development will not cause substantial	- 10:00 and 16:00 – 19:00. The AM and PM peak hours are identified to occur
	traffic impact to the surrounding road network;	at 08:00 - 09:00 and 17:00 - 18:00 respectively. The results of the survey
		have shown that all the link flows in the vicinity of the application site (the
		Site) would be operating within capacity during the AM and PM peak hour
		even with the estimated peak hours trips from the proposed development
		(Annexes I and II).
(b)	The applicant shall advise the management/control measures to be	The Site is proposed for 'warehouse' use, which only the company fleets of
	implemented to ensure no queuing of vehicles outside the subject	the applicant would be allowed to access the Site. To facilitate the smooth
	site;	entry of vehicles to the Site, an ingress/egress gate with vehicle detection
		sensors will be implemented to initiate the pre-opening sequence based on
		the detection of the approaching vehicles. Staff will also be deployed at the
		ingress/egress of the Site to direct vehicle entering/exiting the Site to ensure
		no queuing of vehicle outside the Site. Furthermore, sufficient passing areas
		are also provided along the local access connecting the Site to Ping Che Road,
		therefore, queuing of vehicle outside the Site will not be anticipated (Annex



		III).
(c)	The applicant shall advise the provision and management of pedestrian facilities to ensure pedestrian safety; and	Staff will be deployed by the applicant to direct vehicle entering/exiting the Site. Lighting and alarm systems will be installed at ingress/egress to regulate traffic flow. 'Stop and give way' and 'beware of pedestrians' signs would also be erected to ensure pedestrian safety to/from the Site.
(d)	The applicant shall advise measure in preventing illegal parking by visitors to the subject site; and	The Site is proposed for 'warehouse' use with no shopfront, hence, no visitor is anticipated at the Site. If illegal parking is observed at the local access connecting the Site to Ping Che Road, it would be reported to respective Government Departments.
(e)	The proposed vehicular access between Ping Che Road and the application site is not managed by TD. The applicant should seek comments from the responsible party.	Noted.
5. C	comments of the Chief Engineer/Mainland North, Drainage Services D	Department (CE/MN, DSD)
(a)	Flooding incidents have been recorded in the area in the vicinity of the application site. The applicant should submit a drainage proposal for the site to ensure flooding susceptibility of the adjoining areas would not be adversely affected by the proposed development and to propose measures to mitigate the flooding susceptibility of the area. The applicant is required to assess whether the downstream for drainage connection would have sufficient capacity to receive the stormwater runoff. Flood mitigation measures proposed in the drainage proposal and any other storm-water drainage facilities should be provided and maintained by the applicant to the satisfaction of this Division.	A drainage layout plan, with provision of peripheral u-channels, catchpits and storage tank, is submitted by the applicant to mitigate adverse drainage impact generated by the proposed development (Annex IV). The applicant will submit a drainage proposal to the satisfaction of CE/MN, DSD after planning approval has been granted by the Town Planning Board (the Board). The applicant will commence the construction works or operations, including site formation works, only after the drainage proposal is considered acceptable by CE/MN, DSD.



S.16 Planning Application No. A/NE-TKL/757

(b)	No land filling on site shall be allowed until the flood mitigation measures have been implemented to the satisfaction of DSD.	Noted.
	incusures have been implemented to the satisfaction of bob.	
(c)	The site is in an area where no public sewerage connection is available. EPD should be consulted regarding the sewage treatment/disposal facilities for the proposed development.	Noted.
	treatment/disposar facilities for the proposed development.	



LANDSCAPE PROPOSAL APPLICATION SITE AREA COVERED AREA UNCOVERED AREA : 7,508 m² : 3,402 m² : 4,106 m² (ABOUT) (ABOUT) (ABOUT) PLOT RATIO SITE COVERAGE : 0.91 : 45 % (ABOUT) (ABOUT)


NO. OF STRUCTURE DOMESTIC GFA NON-DOMESTIC GFA : NOT APPLICABLE : 6,804 m² (ABOUT) : 6,804 m² (ABOUT)

TOTAL GFA

: NO LESS THAN 2.75 m : NOT LESS THAN 3 m : 1 m (W) X 1 m (L) X 1.2 m (D)

STRUCTURE	USE	COVERED AREA	GFA	BUILDING HEIGHT
B1	WAREHOUSE (EXCLUDING D.G.G.), SITE OFFICE, WASHROOM	3,402 m ² (ABOUT)	6,804 m ² (ABOUT)	13 m (ABOUT)(2-STOREY)

TOTAL 3,402 m² (ABOUT) 6,804 m² (ABOUT)

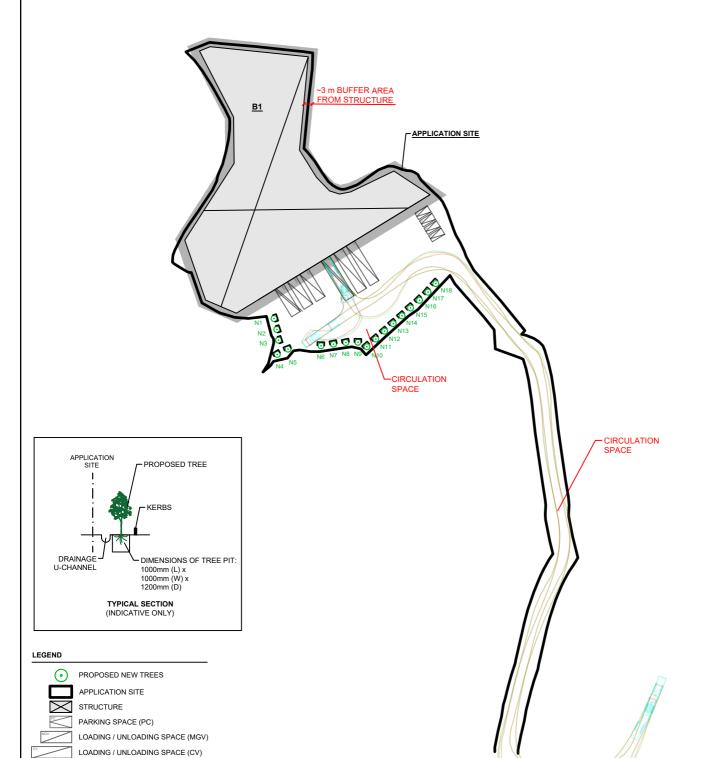





INGRESS / EGRESS

CONTAINER VEHICLE SWEPT PATH OF VEHICLE

PROPOSED TEMPORARY WAREHOUSE (EXCLUDING DANGEROUS GOODS GODOWN) WITH ANCILLARY FACILITIES FOR A PERIOD OF 3 YEARS AND ASSOCIATED FILLING OF LAND

VARIOUS LOTS IN D.D.84, TA KWU LING, NEW **TERRITORIES**

1 : 1300 @ A4		LANDSCAPE PROPOSAL		
DATE 23.5.2024		FROPOSAL		
REVISED BY	DATE	DWG NO. PLAN 1	VER. 001	l

INGRESS / EGRESS 8 m (ABOUT)(W)



Annex I - Result of The Traffic Count Survey

1) Existing Nearby Road Network

- 1.1 The application site (the Site) is accessible from Ping Che Road via the aforesaid local access.
- 1.2 The existing local access that connects the Site to Ping Che Road is a village track. Ping Che Road is district distributor which provides major access for traffic commuting to/from Ta Kwu Ling and other areas of North East New Territories.

2) Existing Traffic Flows with the Proposed Development

2.1 In order to gain understanding of the existing traffic condition of the vicinity of the Site, traffic count surveys were conducted at the key locations on 29/5/2024 (Wednesday) PM and 30/5/2024 (Thursday) AM with survey period of 07:00 – 10:00 and 16:00 – 19:00. The AM and PM peak hours are identified to occur at 08:00 – 09:00 and 17:00 – 18:00 respectively. The survey results are shown at **Tables 1** and **2** below and **Figures 1 and 2**:

Table 1: 2024 Peak Hour Junction Capacity Performance (w/o the proposed development)

Junction No.	Location	DFC for AM Peak	DFC for PM Peak
J1	Ping Che Road / Local Access	0.04#	0.03#

[#]Please refer to the junction capacity performance calculation at **Annex II**.

Table 2: 2024 Peak Hour Road Link Performance (w/o the proposed development)

		Design	AM Peak		PM Peak	
Location	Direction	Capacity	Flows [#] (veh/hr)	P/Df	Flows (veh/hr)	P/Df
L1 Ping Che Road	NB	400*	193	0.48	183	0.46
	SB	400*	184	0.46	175	0.44
L2 Ping Che Road	NB	400*	195	0.49	185	0.46
	SB	400*	185	0.46	176	0.44
Local Access	2-way	100	37	0.37	31	0.31
	Ping Che Road Ping Che Road	Ping Che Road Ping Che Road NB NB NB SB SB	Ping Che Road NB 400* SB 400* NB 400* SB 400* SB 400*	Location Direction Design Capacity Flows# (veh/hr) Ping Che Road NB 400* 193 SB 400* 184 Ping Che Road NB 400* 195 SB 400* 185	Location Direction Design Capacity Flows# (veh/hr) P/Df Ping Che Road NB 400* 193 0.48 SB 400* 184 0.46 Ping Che Road NB 400* 195 0.49 SB 400* 185 0.46	Location Direction Design Capacity Flows* (veh/hr) P/Df (veh/hr) Flows (veh/hr) Ping Che Road NB 400* 193 0.48 183 SB 400* 184 0.46 175 Ping Che Road NB 400* 195 0.49 185 SB 400* 185 0.46 176

^{*}According to TPDM 2.4.1.1, the design flow of a 2-lane single carriageway may be taken as 800 veh/h

2.2 The traffic count results indicate that the key link flows in the vicinity of the proposed development are currently operating within capacity during the AM and PM peak hour.

3) Trip Generation and Attraction of the Proposed Development

3.1 The applicant has been a warehouse operator for decades and intends to operate the proposed development at the Site to provide more local storage space to support the local warehousing and logistics industry. According to the applicant, the below Table 3 is the estimated trip



[#]According to TPDM 2.3.1.1, flow (vehicle/hr) has been converted to passenger car units

generation and attraction of the proposed development at 08:00 - 09:00 and 17:00 - 18:00, details are as follows:

Table 3: Trip Generation and Attraction of the Proposed Development

	Trip Generation and Attraction						
Time Period	P	С	MGV		CV/T		2-Way
	In	Out	In	Out	In	Out	Total
Trips at	2	0	0	2	0	3	7
08:00 - 09:00	2		U	2	U	3	,
Trips at	0	2	2	0	3	0	7
17:00 – 18:00	U	2	۷	U	3	U	,

[#]According to TPDM 2.3.1.1, flow of vehicle has been converted to passenger car units

4) Future Traffic Situation with the Proposed Development

4.1 Based on the results of the traffic count survey on the existing peak hours traffic flows with the accumulation of the estimated peak hour traffic generation and attraction by the proposed development, the peak hour traffic flows with the proposed development are shown at **Tables 4 and 5** below and **Figure 2**:

Table 4: 2024 Peak Hour Junction Capacity Performance (with the proposed development)

Junction No.	Location	DFC for AM Peak	DFC for PM Peak
J1	Ping Che Road / Local Access	<u>0.05</u> #	<u>0.04</u> #

[#]Please refer to the junction capacity performance calculation at **Annex II**.

 Table 5: 2024 Peak Hour Road Link Performance (with the proposed development)

Link		Direction Capa	Docian	AM Peak		PM Peak	
No.	Location		Capacity	Flows (veh/hr)	P/Df	Flows (veh/hr)	P/Df
L1	Ping Che Road	NB	400*	<u>198</u> (+5)	<u>0.50</u>	183	0.41
LI	Ping Che Road	SB	400*	184	0.41	<u>180</u> (+5)	<u>0.45</u>
L2 Ping Che Road	NB	400*	<u>197</u> (+2)	<u>0.49</u>	185	0.42	
	Ping Che Road	SB	400*	185	0.41	<u>178</u> (+2)	<u>0.45</u>
L3	Local Access	2-way	100	<u>44</u> (+7)	<u>0.44</u>	<u>38</u> (+7)	<u>0.38</u>

^{*}According to TPDM 2.4.1.1, the design flow of a 2-lane single carriageway may be taken as 800 veh/h

4.2 As advised by the applicant, goods vehicle would likely enter/leave the Site from/towards Heung Yuen Wai Highway, while private car would likely enter/leave the Site from/towards Sha Tau Kok Road (Ma Mei Ha). Therefore, vehicular trips are added to respective road links at AM and PM peak.




- 4.3 The results shown at **Tables 4, 5** and **Annex II** indicate that all the link flows in the vicinity of the proposed development would be operating <u>within</u> capacity during the AM and PM peak hour even with the estimated peak hours trips from the proposed development.
- 4.4 Furthermore, passing areas are also provided along the local access connecting the Site to Ping Che Road, hence, adverse traffic impact arisen from the proposed development to the surrounding road network should not be anticipated (**Annex III**).



Figure 1 – Observed 2024 Peak Hour Traffic Flows (without the Proposed Development)

1) The AM and PM peak hours are identified to occur at 08:00 - 09:00 and 17:00 - 18:00 respectively.

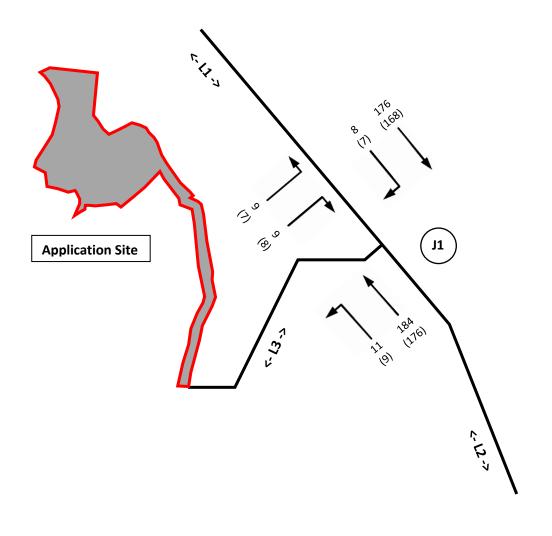



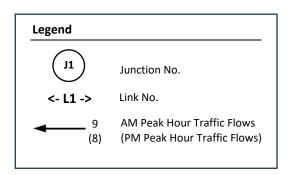




Figure 2 – Future 2024 Peak Hour Traffic Flows (with the Proposed Development)

1) The AM and PM peak hours are identified to occur at 08:00 - 09:00 and 17:00 - 18:00 respectively.

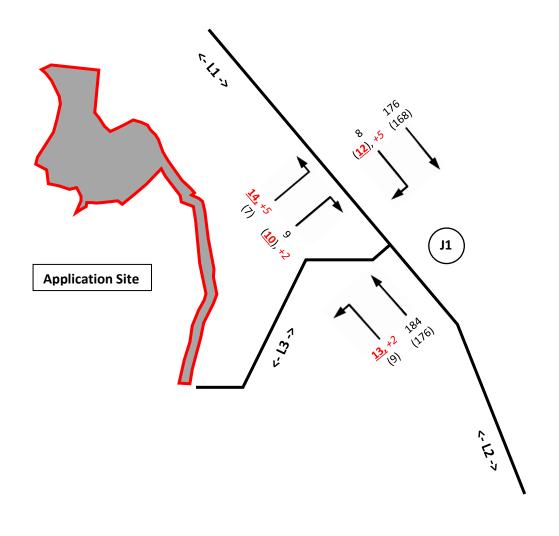

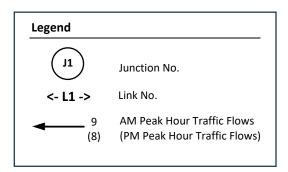



Proposed Temporary Warehouse (Excluding Dangerous Goods Godown) with Ancillary Facilities for a Period of 3 Years and Associated Filling of Land in "Agricutlure" and "Industrial (Group D)" Zones, Various Lots in D.D. 84, Ta Kwu Ling, New Territories

S.16 Planning Application No. A/NE-TKL/757

Priority Junction Calculation

2024 AM Peak (w/o the proposed development)

Geomatric details:	Geometric factors:	The capacity of movement:	Comparison of design flow to capacity:
Major Road (Arm A)			
W = 6.3 metres	D = 0.8659	Q b-a = 466.3031	DFC b-a = 0.0193
W cr = 0 metres	E = 0.8899	Q b-c = 615.2175	DFC b-c = 0.0146
q a-b = 11 pcu/hr	F = 0.8647	Q c-b = 596.1376	DFC c-b = 0.0134
q a-c = 184 pcu/hr	Y = 0.7827	Q b-ac = 466.3031	DFC b-ac (share lane) = 0.0386
Major Road (Arm C)		Total flow = 397 pcu/hr	
W c-b = 3.1 metres			
Vr c-b = 22 metres			Critical DFC = 0.04
q c-a = 176 pcu/hr		(8) (7)	
q c-b = 8 pcu/hr		9 9 Local Access	
Minor Road (Arm B)		(Arm B)	
W b-a = 3 metres		→	
W b-c = 3 metres	(9) 11		
VI b-a = 105 metres	(176) 184		
Vr b-a = 62 metres	(170) 104	8 (7)	
Vr b-c = 62 metres		176 (168)	
q b-a = 9 pcu/hr	Ping Che Road	Ping Che Road	
q b-c = 9 pcu/hr	(Arm A)	(Arm C)	
W = Major Road Width		D = Stream-specific B-A	
W cr = Central Reserve Width		E = Stream-specific B-C	
W b-a = Lane width available to vehicle w	vaiting in stream b-a	F = Stream-specific C-B	
W b-c = Lane width available to vehicle w	vaiting in stream b-c	Y = (1-0.0345W)	
W c-b = Lane width available to vehicle w			
VI b-a = Visibility to the left for vehicles v	•		
Vr b-a = Visibility to the right for vehicles	· ·		
Vr b-c = Visibility to the right for vehicles			
Vr c-b = Visibility to the right for vehicles	· ·		
• =			

Proposed Temporary Warehouse (Excluding Dangerous Goods Godown) with Ancillary Facilities for a Period of 3 Years and Associated Filling of Land in "Agricutlure" and "Industrial (Group D)" Zones, Various Lots in D.D. 84, Ta Kwu Ling, New Territories

S.16 Planning Application No. A/NE-TKL/757

Priority Junction Calculation

2024 PM Peak (w/o the proposed development)

Geomatric details:	Geometric factors:	The capacity of movement:	Comparison of design flow to capacity:		
Major Road (Arm A)					
W = 6.3 metres	D = 0.8659	Q b-a = 470.0655	DFC b-a = 0.0170		
W cr = 0 metres	E = 0.8899	Q b-c = 617.4462	DFC b-c = 0.0113		
q a-b = 9 pcu/hr	F = 0.8647	Q c-b = 598.6009	DFC c-b = 0.0117		
q a-c = 176 pcu/hr	Y = 0.7827	Q b-ac = 470.0655	DFC b-ac (share lane) = 0.0319		
Major Road (Arm C)		Total flow = 375 pcu/hr			
W c-b = 3.1 metres					
Vr c-b = 22 metres			Critical DFC = 0.03		
q c-a = 168 pcu/hr		(8) (7)			
q c-b = 7 pcu/hr		9 9 Local Access			
Minor Road (Arm B)		(Arm B)			
W b-a = 3 metres		→			
W b-c = 3 metres	(9) 11				
VI b-a = 105 metres	(176) 184				
Vr b-a = 62 metres	(======================================	★ 8 (7)			
Vr b-c = 62 metres		176 (168)			
q b-a = 8 pcu/hr	Ping Che Road	Ping Che Road			
q b-c = 7 pcu/hr	(Arm A)	(Arm C)			
W = Major Road Width		D = Stream-specific B-A			
W cr = Central Reserve Width		E = Stream-specific B-C			
W b-a = Lane width available to vehicle	waiting in stream b-a	F = Stream-specific C-B			
W b-c = Lane width available to vehicle	waiting in stream b-c	Y = (1-0.0345W)			
W c-b = Lane width available to vehicle	waiting in stream c-b				
VI b-a = Visibility to the left for vehicles	waiting in steam b-a				
Vr b-a = Visibility to the right for vehicle	es waiting in steam b-a				
Vr b-c = Visibility to the right for vehicle	es waiting in steam b-c				
Vr c-b = Visibility to the right for vehicle	es waiting in steam c-b				

Proposed Temporary Warehouse (Excluding Dangerous Goods Godown) with Ancillary Facilities for a Period of 3 Years and Associated Filling of Land in "Agricutlure" and "Industrial (Group D)" Zones, Various Lots in D.D. 84, Ta Kwu Ling, New Territories

S.16 Planning Application No. A/NE-TKL/757

Priority Junction Calculation

2024 AM Peak (with the proposed development)

Geomatric details:		Geome	Geometric factors:		The capacit	The capacity of movement:			Comparison of design flow to capacity:				
Major R	oad (Arr	m A)											
W	=	6.3	metres	D	=	0.8659	Q b-a	= 466.3	1079		DFC b-a	=	0.0193
W cr	=	0	metres	E	=	0.8899	Q b-c	= 615.0	0169		DFC b-c	=	0.0228
q a-b	=	<u>13</u>	pcu/hr	F	=	0.8647	Q c-b	= 595.6	6450		DFC c-b	=	0.0134
q a-c	=	184	pcu/hr	Υ	=	0.7827	Q b-ac	= 466.3	1079		DFC b-ac (share lane)	=	0.0493
Major R	oad (Arr	m C)					Total flow	=	404	pcu/hr			
W c-b	=	3.1	metres										
Vr c-b	=	22	metres								Critical DFC	=	0.05
q c-a	=	176	pcu/hr				(<u>10</u>) (7)	1					
q c-b	=	8	pcu/hr				9 14	Local Acc	ess				
Minor R	oad (Arr	m B)						(Arm B)					
W b-a	=	3	metres				← J						
W b-c	=	3	metres	(9)	<u>13</u>								
VI b-a	=	105	metres	(176)									
Vr b-a	=	62	metres	` ′				★	8	3 (<u>12</u>)			
Vr b-c	=	62	metres					-	_ 1	76 (168)			
q b-a	=	9	pcu/hr		Ping	Che Road		Ping Che	Road				
q b-c	=	<u>14</u>	pcu/hr		(Arm			(Arm C)					
W	= M	lajor Road V	Vidth				D	= Strean	n-specifi	ic B-A			
W cr	= Ce	entral Reser	ve Width				E	= Strean	n-specifi	ic B-C			
W b-a	= La	ane width av	ailable to vehicle v	vaiting in strear	n b-a		F	= Strean	n-specifi	ic C-B			
W b-c	= La	ane width av	ailable to vehicle v	vaiting in strear	n b-c		Υ	= (1-0.03	345W)				
W c-b			vailable to vehicle v	•				•	,				
VI b-a			e left for vehicles v										
Vr b-a	·												
Vr b-c		· ·	e right for vehicles	=									
Vr c-b		-	e right for vehicles	=									

Proposed Temporary Warehouse (Excluding Dangerous Goods Godown) with Ancillary Facilities for a Period of 3 Years and Associated Filling of Land in "Agricutlure" and "Industrial (Group D)" Zones, Various Lots in D.D. 84, Ta Kwu Ling, New Territories

S.16 Planning Application No. A/NE-TKL/757


Priority Junction Calculation

2024 PM Peak (with the proposed development)

Geomatric details:		Geome	Geometric factors:		The capacit	The capacity of movement:			Comparison of design flow to capacity:				
Major R	oad (Arn	n A)											
W	=	6.3	metres	D	=	0.8659	Q b-a	=	468.3035		DFC b-a	=	0.0214
W cr	=	0	metres	Е	=	0.8899	Q b-c	=	617.4462		DFC b-c	=	0.0113
q a-b	=	9	pcu/hr	F	=	0.8647	Q c-b	=	598.6009		DFC c-b	=	0.0200
q a-c	=	176	pcu/hr	Υ	=	0.7827	Q b-ac	=	468.3035		DFC b-ac (share lane)	=	0.0363
Major R	oad (Arn	n C)					Total flow	=	382	pcu/hr			
W c-b	=	3.1	metres										
Vr c-b	=	22	metres								Critical DFC	=	0.04
q c-a	=	168	pcu/hr				(<u>10</u>) (7)						
q c-b	=	<u>12</u>	pcu/hr				9 <u>14</u>	Lo	cal Access				
							1 1	(A	rm B)				
Minor R	oad (Arn	n B)											
W b-a	=	3	metres				+ +	` <u>L</u>					
W b-c	=	3	metres	(9)									
VI b-a	=	105	metres	(176) 1	.84								
Vr b-a	=	62	metres					ŧ		8 (<u>12</u>)			
Vr b-c	=	62	metres					-	 :	176 (168 <u>)</u>			
q b-a	=	<u>10</u>	pcu/hr		Ping	Che Road		Piı	ng Che Road				
q b-c	=	7	pcu/hr		(Arm	n A)		(A	rm C)				
W	= Ma	ajor Road V	Vidth				D	=	Stream-specif	fic B-A			
W cr	= Ce	entral Reser	ve Width				E	=	Stream-specif	fic B-C			
W b-a	= La	ne width av	ailable to vehicle w	aiting in stream	ı b-a		F	=	Stream-specif	fic C-B			
W b-c	= La	ne width av	ailable to vehicle w	aiting in strean	ı b-c		Υ	=	(1-0.0345W)				
W c-b	= La	ne width av	ailable to vehicle w	aiting in strean	ı c-b				•				
VI b-a			e left for vehicles w										
Vr b-a													
Vr b-c = Visibility to the right for vehicles waiting in steam b-c													
Vr c-b		•	e right for vehicles	•									
		•		-									


Annex III – Passing Areas at the Local Access


(i) Adequate passing areas are also provided along the local access connecting the Site to Ping Che Road, details are as follows:

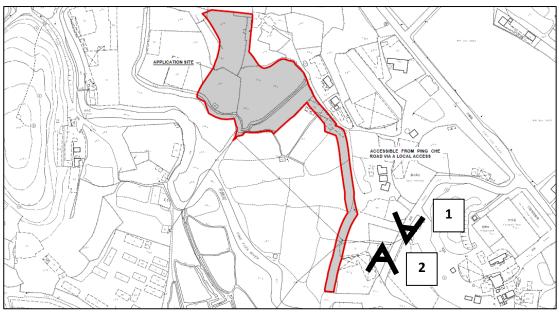






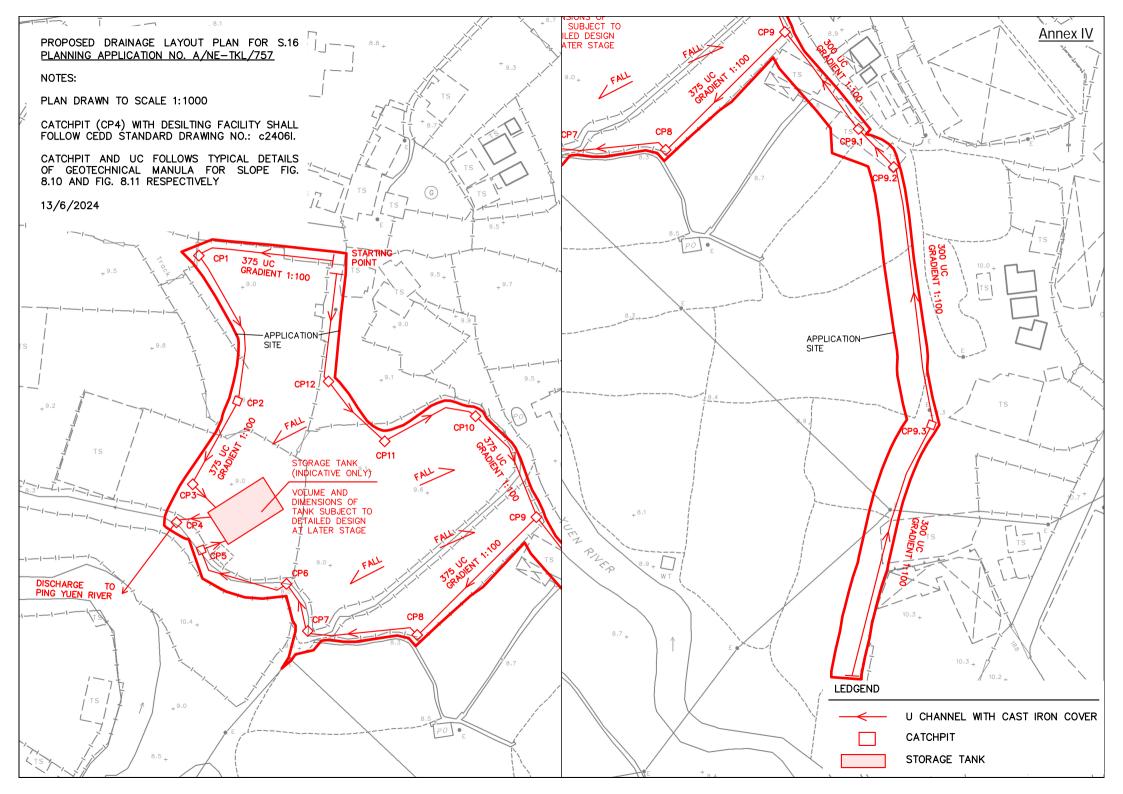

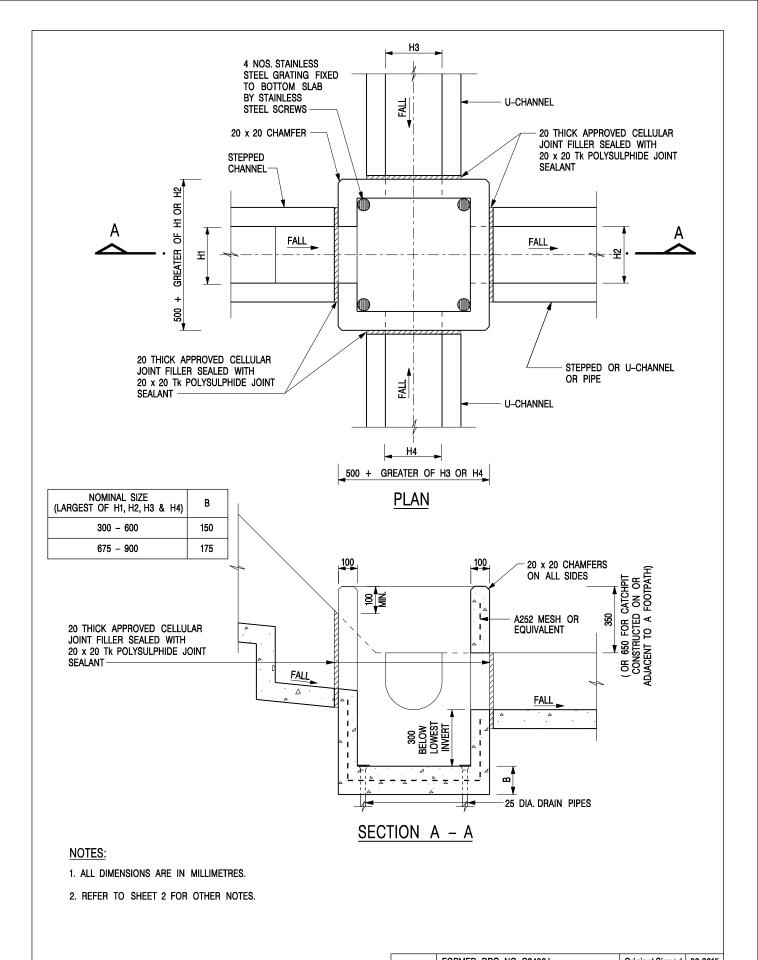

	-	FORMER DRG. NO. C2406J.		Original Signed	03.2015
	REF.	REVISION		SIGNATURE	DATE
CATCHPIT WITH TRAP	CI	CIVIL EN DEVELOPM	GINEERI Ent de	ING AND Partmen	IT
(CHEET 1 OF 0)	SCAL	. E 1 : 20	DRAWI		
(SHEET 1 OF 2)	DATE	JAN 1991	C24	406 /1	
卓越工程 建設香港	V	Ve Engineer Hong I	Cong's De	velopment	

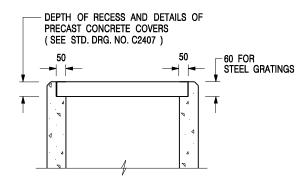

ALTERNATIVE TOP SECTION FOR PRECAST CONCRETE COVERS / GRATINGS

NOTES:

- 1. ALL DIMENSIONS ARE IN MILLIMETRES.
- 2. ALL CONCRETE SHALL BE GRADE 20 /20.
- 3. CONCRETE SURFACE FINISH SHALL BE CLASS U2 OR F2 AS APPROPRIATE.
- 4. FOR DETAILS OF JOINT, REFER TO STD. DRG. NO. C2413.
- 5. CONCRETE TO BE COLOURED AS SPECIFIED.
- UNLESS REQUESTED BY THE MAINTENANCE PARTY AND AS DIRECTED BY THE ENGINEER, CATCHPIT WITH TRAP IS NORMALLY NOT PREFERRED DUE TO PONDING PROBLEM.
- 7. UPON THE REQUEST FROM MAINTENANCE PARTY, DRAIN PIPES AT CATCHPIT BASE CAN BE USED BUT THIS IS FOR CATCHPITS LOCATED AT SLOPE TOE ONLY AND AS DIRECTED BY THE ENGINEER.
- FOR CATCHPITS CONSTRUCTED ON OR ADJACENT TO A FOOTPATH, STEEL GRATINGS (SEE DETAIL 'A' ON STD. DRG. NO. C2405) OR CONCRETE COVERS (SEE STD. DRG. NO. C2407) SHALL BE PROVIDED AS DIRECTED BY THE ENGINEER.
- 9. IF INSTRUCTED BY THE ENGINEER, HANDRAILING (SEE DETAIL 'G' ON STD. DRG. NO. C2405; EXCEPT ON THE UPSLOPE SIDE) IN LIEU OF STEEL GRATINGS OR CONCRETE COVERS CAN BE ACCEPTED AS AN ALTERNATIVE SAFETY MEASURE FOR CATCHPITS NOT ON A FOOTPATH NOR ADJACENT TO IT. TOP OF THE HANDRAILING SHALL BE 1 000 mm MIN. MEASURED FROM THE ADJACENT GROUND LEVEL.
- 10. MINIMUM INTERNAL CATCHPIT WIDTH SHALL BE 1 000 mm FOR CATCHPITS WITH A HEIGHT EXCEEDING 1 000 mm MEASURED FROM THE INVERT LEVEL TO THE ADJACENT GROUND LEVEL. AND, STEP IRONS (SEE DSD STD. DRG. NO. DS1043) AT 300 ℃ STAGGERED SHALL BE PROVIDED. THICKNESS OF CATCHPIT WALL FOR INSTALLATION OF STEP IRONS SHALL BE INCREASED TO 150 mm.
- FOR RETROFITTING AN EXISTING CATCHPIT WITH STEEL GRATING, SEE DETAIL 'F' ON STD. DRG. NO. C2405.
- SUBJECT TO THE APPROVAL OF THE ENGINEER, OTHER MATERIALS CAN ALSO BE USED AS COVERS / GRATINGS.

- FORMER DRG. NO. C2406J. Original Signed 03.2015
REF. REVISION SIGNATURE DATE

CIVIL ENGINEERING AND
DEVELOPMENT DEPARTMENT

CATCHPIT WITH TRAP (SHEET 2 OF 2)

 SCALE 1:20
 DRAWING NO.

 DATE JAN 1991
 C2406 /2

卓越工程 建設香港 We Engineer Hong Kong's Development

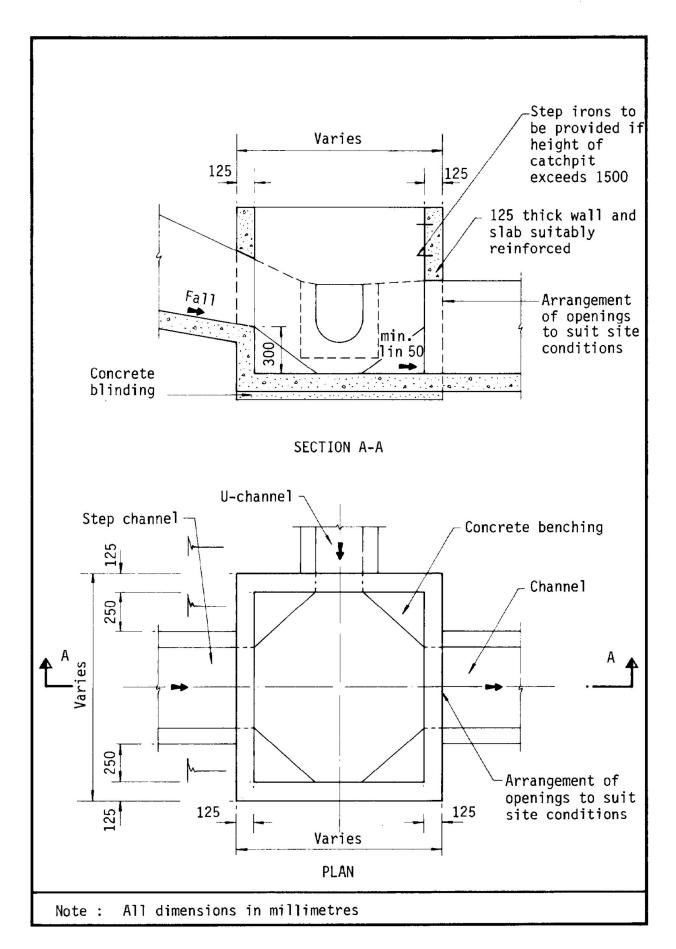


Figure 8.10 - Typical Details of Catchpits

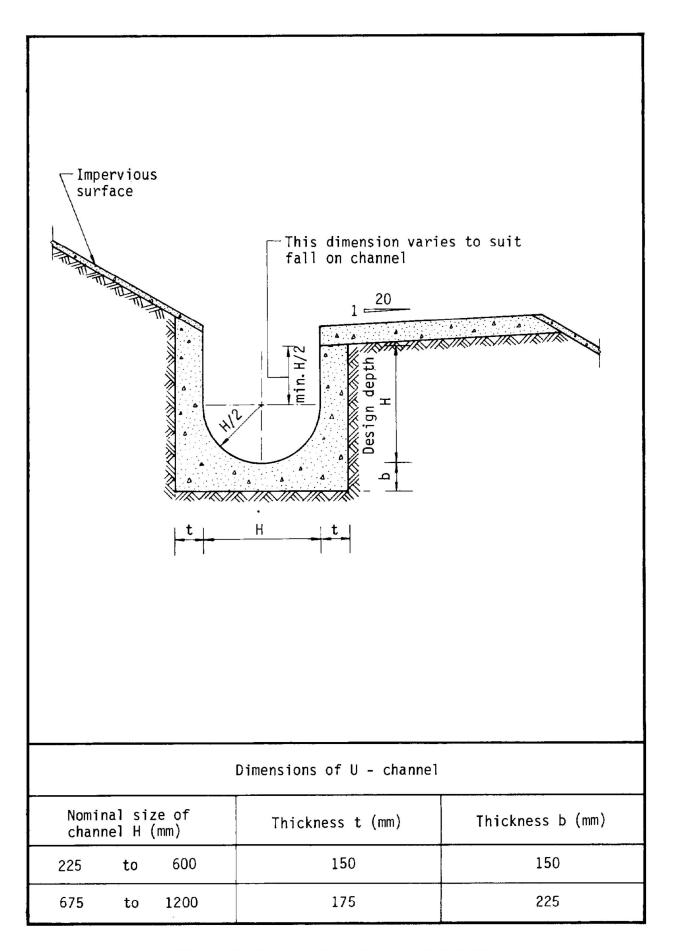


Figure 8.11 - Typical U-channel Details



Our Ref.: DD84 Lot 5 & VL TPB/A/NE-TKL/757 Your Ref.:

The Secretary, Town Planning Board, 15/F, North Point Government Offices, 333 Java Road, North Point, Hong Kong

By Email

14 June 2024

Dear Sir,

2nd Further Information

Proposed Temporary Warehouse (Excluding Dangerous Goods Godown) with Ancillary Facilities for a Period of 3 Years and Associated Filling of Land in "Agriculture" and "Industrial (Group D)" Zones, Various Lots in D.D. 84, Ta Kwu Ling, New Territories

(S.16 Planning Application No. A/NE-TKL/757)

We are writing to submit further information to address departmental comments of the subject application (Appendix I).

Should you require more information regarding the application, please contact our Mr. Christian CHIM at (852) 2339 0884 / christianchim@r-riches.com.hk or the undersigned at your convenience. Thank you for your kind attention.

Yours faithfully,

For and on behalf of

R-riches Property Consultants Limited

Louis TSE

Town Planner

cc DPO/STN, PlanD

(Attn.: Ms. Sheren LEE


email: sswlee@pland.gov.hk


(Attn.: Ms. Katie LEUNG

email: kyyleung@pland.gov.hk)





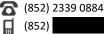

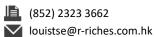

Responses-to-Comments

Proposed Temporary Warehouse (Excluding Dangerous Goods Godown)
with Ancillary Facilities for a Period of 3 Years and Associated Filling of Land
in "Agriculture" and "Industrial (Group D)" Zones,

Various Lots in D.D. 84, Ta Kwu Ling, New Territories

(Application No. A/NE-TKL/757)

- (i) The majority of the application site (the Site) (i.e. about 7,493m², 99.8% of the Site) falls within an area zoned as "Agriculture". The remaining area (i.e. about 15m², 0.2% of the Site) falls within "Industrial (Group D)" zone (**Plan 1**).
- (ii) All the proposed works will be carried out 3 m away from the top bank of the existing Ping Yuen River that is located at the west of the Site.
- (iii) No dismantling, maintenance, repairing, cleansing, paint spraying or other workshop activities will be carried out within the Site at any time during the planning approval period.
- (iv) A RtoC Table

	Departmental Comments	Applicant's Responses
1. C	comments of the District Lands Officer/North, Lar	nds Department (DLO/N, LandsD)
(a)	The application site comprises Old Schedule Agriculture Lots held under the Block Government Lease which contains the restrictions that no structures are allowed to be erected without the prior approval of the Government. No right of access via Government land (GL) is granted to the application site.	Noted. The applicant will submit Short Term Waiver (STW) application to rectify the applied use erected on the concerned lots after planning approval has been obtained from the Town Planning Board (the Board). The unauthorised structures erected on the concerned lots will be demolished by the applicant after planning approval has been obtained from the Board
(b)	I must point out that the following irregularities covered by the subject planning application have been detected by this office: Unauthorised structures within the said private lot covered by the planning application There are unauthorized structures on Lot Nos. 9 S.A and 9 S.B in D.D.84. As access is not available, the above mentioned unauthorised structures may not be exhaustive. The lot owners should immediately rectify the lease breaches and this office reserves the right to	to facilitate the proposed scheme.



	take necessary lease enforcement action	
	against the breaches without further notice.	
(c)	The following irregularities <u>not</u> covered by the subject application have been detected by this office:	Noted.
	Unauthorised structures within the said private lot not covered by the planning application There are unauthorised structures within Lot No. 9 S.B in D.D. 84, which is not covered by the subject planning application but covered by another planning application (No. A/NE-TKL/755) referred to this office for comments on 30 April 2024. The access is also not available, the above mentioned unauthorised structure may not be exhaustive. The lot owner should immediately rectify the lease breaches and this office reserves the rights to take necessary lease enforcement action against the breaches without further notice.	
(d)	The STW application (if submitted) referred in para.5 below will be considered on Lot basis. There is no information provided to show the subject planning is related to planning application (No. A/NE-TKL/755) mentioned in para.3 above. The graphical division of the lot submitted in the 2 separate planning application may create complication to the STW application(s) and the Applicant should resolve the complication in submitting the STW application(s).	The applicant will consult the applicant of planning application (No. A/NE-TKL/755) to resolve the complication in submitting the STW application(s) after planning approval has been obtained from the Board.
(e)	The lot owners shall <u>either</u> (i) remove the unauthorised structures pr provide any evidence for these are tolerated structures; <u>or</u> (ii) include the unauthorised structures in the subject planning application for the further consideration by the relevant departments <u>and</u> , subject to the approval of the Town Planning Board to the planning application which shall have reflected the rectification or amendment as aforesaid required, apply to this office for an STW to permit the structures	Noted. The applicant will apply for relevant approval to rectify the applied use accordingly.




disturbed unless with prior approval.

erected/to be erected. The applications for STW will be considered by the Government in its capacity as a landlord and there is no guarantee that they will be approved. The STW, if approved, will be subject to such terms and conditions including the payment of waiver fee/rent and administrative fee as considered appropriate to be imposed by LandsD. In addition, LandsD reserves the right to take enforcement action against the lot owners for any breach of the lease conditions, including the breaches already in existence or to be detected at any point of time in future. Besides, given the proposed use is temporary in nature, only erection of temporary structures will be considered. The applicant should comply with all the land Noted. The applicant will comply with all filling requirements imposed by relevant the land filling requirements imposed by relevant Government department. No GL Government department. GL should not be

will be disturbed.



(f)

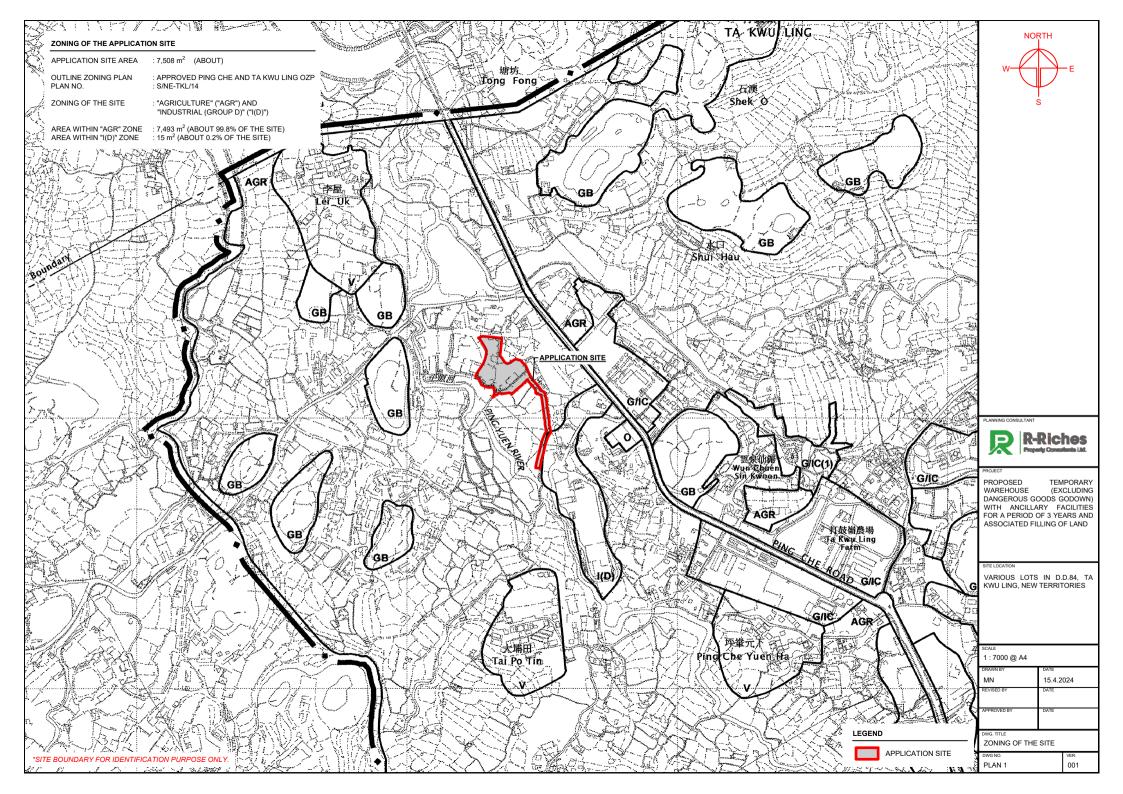

Previous S.16 Applications

Rejected Applications

Application No.	Proposed Developments	Date of Consideration	Rejection Reasons
A/NE-TKL/306	Proposed Temporary Open Storage of Metal Goods and Equipment for a Period of 3 Years	7.3.2008 (Reviewed on 28.11.2008)	R1
A/NE-TKL/308	Proposed Temporary Open Storage of Construction Materials and Equipment for a Period of 3 Years	6.6.2008	R2

Rejection Reasons

- R1 The application did not comply with the Town Planning Board Guidelines for 'Application for Open Storage and Port Back-up Uses' in that no previous planning approval had been granted to the application site and there were adverse departmental comments on the application. Insufficient information had been submitted to demonstrate that the proposed use would not generate adverse environmental, traffic and landscape impacts on the surrounding areas.
- R2 The application did not comply with the Town Planning Board Guidelines for 'Application for Open Storage and Port Back-up Uses' in that no previous planning approval had been granted to the application site and there were adverse departmental comments and local objection to the application. Insufficient information had been submitted to demonstrate that the proposed use would not generate adverse environmental, drainage and landscape impacts on the surrounding areas.

Similar S.16 Applications for Temporary Warehouse (excluding Dangerous Goods Godown) with Ancillary Facilities within the same "Agriculture" Zone in the vicinity of the Application Site in the Ping Che and Ta Kwu Ling Area

Approved Applications

Application No.	Uses/ Development	Date of Consideration
A/NE-TKL/695	Proposed Temporary Open Storage and Warehouse for Storage of Timber and Wooden Parts for a Period of 3 Years	18.3.2022 (Revoked on 18.9.2023)
A/NE-TKL/721	Proposed Temporary Warehouse for Storage of Construction Materials and Electronic Products for a Period of 3 Years	19.5.2023
A/NE-TKL/737	Proposed Temporary Warehouse (Excluding Dangerous Goods Godown) with Ancillary Facilities for a Period of 3 Years and Associated Filling of Land	11.9.2023

Government Departments' General Comments

1. Traffic

Comments of Commissioner for Transport (C for T):

- no comment on the application upon reviewing the Further Information (FI) submitted by the applicant (**Appendix Ia**); and
- approval conditions on the implementation of traffic management measures as proposed by the applicant within 9 months from the date of planning approval and maintenance of the implemented traffic management measures to the satisfaction of the Commissioner for Transport or of the Town Planning Board shall be imposed.

2. Fire Safety

Comments of the Director of Fire Services (D of FS):

• no in-principle objection to the proposal subject to fire service installations and water supplies for firefighting being provided to the satisfaction of the D of FS.

3. **Project Interface**

Comments of the Project Manager (North), North Development Office, Civil Engineering and Development Department:

• it is noted that the proposed temporary warehouse (excluding dangerous goods godown) with ancillary facilities on a 3-year basis and associated filling of land (the subject development) is located within the proposed New Territories North (NTN) New Town under the Planning and Engineering (P&E) Study for NTN New Town and Man Kam To. Please note that the P&E Study already commenced on 29 Oct 2021. While the implementation programme of NTN New Town will be formulated under the P&E Study, the site formation works will likely commence soon after the completion of detailed design in next stage. Hence, please be reminded that subject to the land use planning in the P&E Study, the subject development, if approved, may need to be vacated for the site formation works.

4. Other Departments

The following government departments have no comments on the application:

- (a) Chief Highway Engineer/New Territories East, Highways Department;
- (b) Chief Building Surveyor/New Territories West, Buildings Department; and
- (c) Chief Engineer/Construction, Water Supplies Department.

Recommended Advisory Clauses

- (a) to note the following comments of the District Lands Officer/North, Lands Department (DLO/N, LandsD) that:
 - (i) the Site comprises Old Schedule Agricultural Lots held under the Block Government Lease which contains the restriction that no structures are allowed to be erected without the prior approval of the Government. No right of access via Government land (GL) is granted to the application site;
 - (ii) the following irregularity covered by the subject planning application has been detected by his office:

Unauthorized structures within the said private lot covered by the planning application

there are unauthorized structures on Lots 9 S.A and 9 S.B in D.D. 84. As access is not available, the above mentioned unauthorised structures may not be exhaustive. The lot owners should immediately rectify the lease breaches and his office reserves the rights to take necessary lease enforcement action against the breaches without further notice;

(iii) the following irregularity not covered by the subject planning application has been detected by his office:

Unauthorized structure within the said private lot not covered by the planning application

there are unauthorized structures within Lot 9 S.B in D.D. 84 not covered by the subject planning application but covered by another planning application (No. A/NE-TKL/755) referred to this office for comments on 30 April 2024. The access is also not available, the above mentioned unauthorized structure may not be exhaustive. The lot owner should immediately rectify the leas breaches and his office reserves the rights to take necessary lease enforcement action against the breaches without further notice;

- (iv) the STW application (if submitted) referred in (v) below will be considered on Lot basis. There is no information provided to show the subject planning application is related to planning application No. A/NE-TKL/755 mentioned in (iii) above. The graphical division of the lot submitted in the two separate planning applications may create complication to the STW application(s) and the applicant should resolve the complication in submitting the STW application(s);
- (v) the lot owners shall either (i) remove the unauthorized structures or provide evidence to demonstrate they are tolerated structures; or (ii) include the unauthorized structures in the subject planning application for the further consideration by the relevant departments and, subject to the approval of the Board to the planning application which shall have reflected the rectification or amendment as aforesaid required, apply to his office for a STW to permit the structures erected/to be erected. The application for STW will be considered by the Government in its capacity as a landlord and there is no guarantee that it will be approved. The STW, if approved, will be subject to such terms and conditions including the payment of waiver fee and administrative fee as considered appropriate to be imposed by LandsD. In addition, LandsD reserves the right to take enforcement action against the lot owners for any breach of the lease conditions, including the breaches already in existence or to be detected at any point of time in future. Besides, given the proposed use is temporary in nature, only erection of temporary structures will be considered; and

- (vi) the applicant should comply with all the land filling requirements imposed by relevant Government departments. GL should not be disturbed unless with prior approval.
- (b) to note the comments of the Chief Highway Engineer/New Territories East, Highways Department (CHE/NTE, HyD) that the access road adjacent to the Site is not maintained by HyD.
- (c) to note the comments of the Commissioner for Transport (C for T) that the vehicular access between Ping Che Road and the Site is not managed by TD and the applicant should seek comment from the responsible party.
- (d) to note the comments of the Director of Environmental Protection (DEP) that:
 - (i) the latest "Code of Practice on Handling the Environmental Aspects of Temporary Uses and Open Storage Sites" issued by EPD should be followed to minimize potential environmental nuisance to the surrounding area;
 - (ii) adequate supporting infrastructure/facilities for proper collection, treatment and disposal of waste/wastewater generated from the proposed use should be provided. If septic tank and soakaway system will be used in case of unavailability of public sewer, its design and construction shall follow the requirements of EPD's Practice Note for Professional Person (ProPECC) PN 1/23 "Drainage Plans subject to Comment by the Environmental Protection Department" including percolation test;
 - (iii) the applicant should observe the Water Pollution Control Ordinance and follow the mitigation measures as required under Environment, Transport and Works Bureau Technical Circular (Works) (ETWB TC(Works)) No. 5/2005 "Protection of natural streams/rivers from adverse impacts arising from construction works" for the land filling works during construction phase; and
 - (iv) it is the obligation of the applicant to meet the statutory requirements under relevant pollution control ordinances.
- (e) to note the comments of the Chief Town Planner/ Urban Design and Landscape, Planning Department (CTP/UD&L, PlanD) that approval of the application does not imply approval of tree works such as pruning, transplanting and felling. The applicant should seek approval for any proposed tree works from relevant departments prior to commencement of the works.
- (f) to note the comments of the Director of Fire Services (D of FS) that:
 - (i) in consideration of the design/nature of the proposal, fire service installations (FSIs) are anticipated to be required. The applicant is advised to submit relevant layout plans incorporated with the proposed FSIs to his Department for approval. In addition, the applicant should also be advised on the following points:
 - (i) the layout plans should be drawn to scale and depicted with dimensions and nature of occupancy;
 - (ii) the location of where the proposed FSI to be installed should be clearly marked on the layout plans; and

- (ii) if the proposed structures are required to comply with the Buildings Ordinance (Cap. 123), detailed fire service requirements will be formulated upon receipt of formal submission of general building plans.
- (g) to note the following comments of the Chief Building Surveyor/New Territories West, Buildings Department (CBS/NTW, BD):
 - the Site shall be provided with means of obtaining access thereto from a street under the regulation 5 of the Building (Planning) Regulations (B(P)R) and emergency vehicular access shall be provided under the regulation 41D of the B(P)R;
 - the Site is not abutting on a specified street having a width not less than 4.5m, the development intensity shall be determined by the Building Authority (BA) under regulation 19(3) of the B(P)R at building plan submission stage;
 - it is noted that a new structure had been proposed in the application. Before any new building works are to be carried out on the application site, prior approval and consent of the BA should be obtained unless they are exempted building works, designated exempted works or minor works commenced under the simplified requirements under the BO. Otherwise they are Unauthorized Building Works (UBW). An Authorized Person (AP) should be appointed as the coordinator for the proposed building works in accordance with the BO;
 - for UBW erected on leased land, enforcement action may be taken by the BA to effect their removal in accordance with BD's enforcement policy against UBW as and when necessary. The granting of any planning approval should not be construed as an acceptance of any existing building works or UBW on the application site under the BO;
 - any temporary shelters or converted containers for storage or office, canteen or other uses are considered as temporary buildings are subject to the control of Part VII of the B(P)R;
 - in general there is no requirement under the BO in respect of provision of car parking spaces for a proposed development. However, the applicant's attention is drawn to the provision of accessible car parking spaces designated for the use of persons with a disability as per the requirements under the regulation 72 of the B(P)R and Division 3 of Design Manual: Barrier Free Access 2008;
 - the applicant's attention is drawn to the provision under regulations 40 and 41 of the Building (Standards of Sanitary Fitments, Plumbing, Drainage Works and Latrines) Regulations in respect of disposal of foul water and surface water respectively; and
 - formal submission under the BO is required for any proposed new works, including any temporary structures, site formation works like filling of ponds and land and site formation drainage works. Detailed comments under BO on individual sites for private developments such as permissible plot ratio, site coverage, emergency vehicular access,

private streets and/or access roads, barrier free access and facilities, compliance with the sustainable building design guidelines (SBD), etc. will be formulated at the formal building plan submission stage.

(h) to note the comments of the Project Manager (North), North Development Office, Civil Engineering and Development Department (PM(N), CEDD) that the proposed temporary warehouse (excluding dangerous goods godown) with ancillary facilities on a 3-year basis and associated filling of land (the subject development) is located within the proposed New Territories North (NTN) New Town under the Planning and Engineering (P&E) Study for NTN New Town and Man Kam To. Please note that the P&E Study already commenced on 29 Oct 2021. While the implementation programme of NTN New Town will be formulated under the P&E Study, the site formation works will likely commence soon after the completion of detailed design in next stage. Hence, please be reminded that subject to the land use planning in the P&E Study, the subject development, if approved, may need to be vacated for the site formation works.

Appendix VI of RNTPC Paper No. A/NE-TKL/757

致城市規劃委員會秘書:

專人送遞或郵遞:香港北角渣蕐道 333 號北角政府合署 15 樓

傳真: 2877 0245 或 2522 8426

電郵: tpbpd@pland.gov.hk

To: Secretary, Town Planning Board

By hand or post: 15/F, North Point Government Offices, 333 Java Road, North Point, Hong Kong

By Fax: 2877 0245 or 2522 8426 By e-mail: tpbpd@pland.gov.hk

有關的規劃申請編號 The application no. to which the comment relates

A/NE-TKL/757

意見詳情 (如有需要, 請另頁說明)

Details of the Comment (use separate sheet if necessary)

	•		•
	• .	•	
		the second of the second of the second of	
	,		
「提意見人」	」姓名/名稱 Name of person/co	ompany making this comment]ž,
簽署 Signate	ure And	日期 Date 2014. S.	8

			The second second	
⊔∪rgent	⊔Return receipt	□Expand Group	⊔Kestrictea	⊔Prevent Copy

From:

Sent:

2024-05-24 星期五 13:36:04

To:

tpbpd/PLAND <tpbpd@pland.gov.hk>

Subject:

Attachment:

KFBG's comments on SIX planning applications

240524 s16 KTN 104.pdf; 240524 s16 TKL 756 & 757.pdf;

240524 s12a LFS 13c.pdf; 240524 s16 KTS 1003.pdf; 240524 s16

PH 1008.pdf

Dear Sir/ Madam,

Attached please see our comments regarding SIX applications. There are FIVE pdf files attached to this email. If you cannot see/ download/ open these files, please notify us through email.

Also, please do not disclose our email address.

Thank You and Best Regards,

Ecological Advisory Programme Kadoorie Farm and Botanic Garden

Email Disclaimer:

The information contained in this e-mail (including any attachments) is confidential and is intended solely for the addressee. If you are not the intended recipient, please notify the sender immediately and delete this e-mail from your system. Any unauthorised use, disclosure, copying, printing, forwarding or dissemination of any part of this information is prohibited. KFBG does not accept responsibility and shall not be liable for the content of any e-mail transmitted by its staff for any reason other than bona fide official purposes. There is no warranty that this e-mail is error or virus free. You should not rely on any information that is not transmitted via secure technology.



嘉道理農場暨植物園公司 Kadoorie Farm & Botanic Garden Corporation

The Secretary,
Town Planning Board,
15/F, North Point Government Offices,
333, Java Road, North Point,
Hong Kong.
(Email: tpbpd@pland.gov.hk)

24th May, 2024.

By email only

Dear Sir/ Madam,

Proposed Temporary Warehouse (Excluding Dangerous Goods Godown) for a Period of 3 Years and Associated Filling of Land (A/NE-TKL/756)

&

Proposed Temporary Warehouse (Excluding Dangerous Goods Godown) with

Ancillary Facilities for a Period of 3 Years and Associated Filling of Land

(A/NE-TKL/757)

- 1. We refer to the captioned.
- 2. Both application sites are within or largely within Agriculture (AGR) zone. We would like the Board to investigate with relevant authorities the latest site status and as to whether the sites are involved in any ongoing unauthorised activities/enforcement cases.
- 3. The proposed uses are unlikely to be in line with the planning intention of the AGR zone and we urge the Board to reject these applications.
- 4. Thank you for your attention.

Ecological Advisory Programme Kadoorie Farm and Botanic Garden

□Urgent	□Return receipt	□Expand Group	□Restricted	□Prevent Copy

From:

2024-05-24 星期五 14:49:01 Sent:

To: tpbpd/PLAND <tpbpd@pland.gov.hk>

Cc:

Comments on the Section 16 Application No. A/NE-TKL/757

Attachment: TPB20240524(TKL757).pdf

Dear Sir/Madam,

Subject:

Please refer to the attachment for the captioned.

Yours faithfully, Ng Hei Man (Mr.) Campaign Manager The Conservancy Association

Registered Name 註冊名稱: The Conservancy Association 長春社 (Incorporated in Hong Kong with limited liability by guarantee 於香港註冊成立的擔保有限公司)

This email is for the sole use of the intended recipient(s) and may contain confidential information. Unauthorised use, disclosure or distribution of this email or its content is prohibited. If you have received this email in error, please delete it and notify the sender.



長春社 Since1968

The Conservancy Association

23rd May 2024

Town Planning Board
15/F North Point Government Offices
333 Java Road
North Point
Hong Kong

By e-mail: tpbpd@pland.gov.hk

Dear Sir/Madam,

Comments on the Section 16 Application No. A/NE-TKL/757

The Conservancy Association (CA) OBJECTS to the captioned application.

1. Not in line with the planning intention of Agriculture (AGR) zone

According to the draft Ta Kwu Ling Outline Zoning Plan (OZP) No. S/NE-TKL/14, the planning intention of AGR zone "primarily to retain and safeguard good quality agricultural land/farm/fish ponds for agricultural purposes. It is also intended to retain fallow arable land with good potential for rehabilitation for cultivation and other agricultural purposes". From the figures in the application, it seems that the entire site is covered by structures. Meanwhile, the aerial photo (Figure 1) demonstrates that there are agricultural activities in the northern periphery of the application site. No sufficient details are available to demonstrate how these measures can ensure protection of agricultural land. We do not think such plan is in line with the planning intention.

2. Adverse environmental impact

We worry that there would be several potential adverse environmental impacts:



長春社 since 1968

The Conservancy Association

- No plans on land recovery: The warehouse is intended for storage of miscellaneous goods (including but not limited to packaged food, apparel, footwear, electronic goods, furniture etc.). However, no details are available to illustrate how the land would be recovered after the proposed temporary use.
- Potential adverse drainage impact: No details are available to demonstrate that drainage impact would be properly handled. We worry that the proposed land filling activity would largely change the hydrology of the site, and such change would affect the adjacent temporary uses.
- Disturbance on natural stream: The application site is located very close to a natural stream (Figure 1). No details are available to demonstrate that no deterioration in water quality would be resulted during both construction and operation phase. Regarding the proposed staff washroom, we cannot see any details such as design; collection, treatment and disposal of sewage, and so on. We especially worry that it is very close to the natural stream. Leaking of human sewage can cause serious environmental and hygiene problems.


Yours faithfully, The Conservancy Association



長春社 since1968

The Conservancy Association

Figure 1 The application site (marked in red) is located very close to a natural stream (blue arrow)

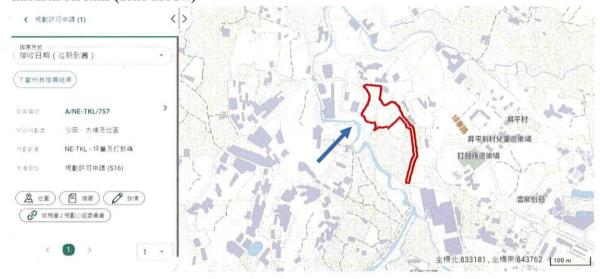

4

From:

Sent:

2024-05-24 星期五 02:50:33

To:

tpbpd/PLAND <tpbpd@pland.gov.hk>

Subject:

A/NE-TKL/757 DD 84 Ping Che

A/NE-TKL/757

Lots 5, 6 S.A, 6 S.A ss.1, 7, 8 S.A, 8 S.B, 9 S.A (Part), 9 S.B (Part), 10 S.B (Part) and 11 (Part) in D.D. 84, Ping Che

Site area: About 7,508sq.m

Zoning: "Agriculture" and "Industrial (Group D")"

Applied use: Warehouse / 10 Vehicle Parking / Filling of Land

Dear TPB Members,

750 withdrawn, back with some slight modification.

Previous objections relevant and upheld.

Mary Mulvihill

From:

To: tpbpd <tpbpd@pland.gov.hk>

Date: Wednesday, 10 April 2024 2:54 AM HKT Subject: A/NE-TKL/750 DD 84 Ping Che

A/NE-TKL/750

Lots 5, 6 S.A, 6 S.A ss.1, 7, 8 S.A, 8 S.B, 9 S.A (Part), 9 S.B (Part), 10 S.A (Part) and 11 (Part) in D.D. 84, Ping Che

Site area: About 7,630sq.m

Zoning: "Agriculture"

Applied use: Warehouse / 10 Vehicle Parking / Filling of Land

Dear TPB Members,

Strong objections, no previous history of approvals and the justification is 'increasing demand for warehouse space'??? As our economy is shrinking and retail and dining operations are closing down, this claim is not justified.

The site is adjacent to 721 approved 19 May 2023, conditions not yet fulfilled, for similar use. That site was considered under the 'streamline' formula even though the site was subject to extensive tree removal before the application was considered.

To further approve tree felling and encroachment and filling in of land along the river course is unacceptable. Reading the minutes indicates that there is no consideration re the long term negative impact of filling in significant tracts of land when drainage will be a major consideration re the looming issues of climate change. No data provided on number of trees to be removed.

The Site is proposed to be filled wholly with concrete of not more than 2.1 m (about) in depth for site formation of structures, parking space, loading/unloading (L/UL) spaces and circulation.

The administration pledged to phase out the inefficient land use brownfield operations via the development of high rise, high tech and custom built industrial parks. But the reality is that there is no onus on operators to upgrade and invest in such premises when under the 'streamline' formula EVERY APPLICATION FOR FILLING IN OF AGRICULTURE LAND IS AUTO APPROVED.

Mary Mulvihill