Form No. S16-III 表格第 S16-III 號

2 1 MAY 2024 This document is received on 2 1 MAY 2024. The Town Planning Board will formally acknowledge the date of receipt of the application only upon receipt of all the required information and documents.

APPLICATION FOR PERMISSION **UNDER SECTION 16 OF** THE TOWN PLANNING ORDINANCE (CAP. 131)

根據《城市規劃條例》(第131章) 第16條遞交的許可申請

Applicable to Proposal Only Involving Temporary Use/Development of Land and/or Building Not Exceeding 3 Years in Rural Areas or Regulated Areas, or Renewal of Permission for such Temporary Use or Development*

適用於祇涉及位於鄉郊地區或受規管地區土地上及/或建築物內進行 為期不超過三年的臨時用途/發展或該等臨時用途/發展的許可續期的建議*

*Form No. S16-I should be used for other Temporary Use/Development of Land and/or Building (e.g. temporary use/developments in the Urban Area) and Renewal of Permission for such Temporary Use or Development.

*其他土地上及/或建築物內的臨時用途/發展(例如位於市區內的臨時用途或發展)及有關該等臨時用途/發 展的許可續期,應使用表格第S16-I 號。

Applicant who would like to publish the notice of application in local newspapers to meet one of the Town Planning Board's requirements of taking reasonable steps to obtain consent of or give notification to the current land owner, please refer to the following link regarding publishing the notice in the designated newspapers: https://www.tpb.gov.hk/en/plan_application/apply.html

申請人如欲在本地報章刊登申請通知,以採取城市規劃委員會就取得現行土地擁有人的同意或通知現行 土地擁有人所指定的其中一項合理步驟,請瀏覽以下網址有關在指定的報章刊登通知: https://www.tpb.gov.hk/tc/plan application/apply.html

General Note and Annotation for the Form

填寫表格的一般指引及註解

- "Current land owner" means any person whose name is registered in the Land Registry as that of an owner of the land to which the application relates, as at 6 weeks before the application is made
 - 「現行土地擁有人」指在提出申請前六星期,其姓名或名稱已在土地註冊處註冊為該申請所關乎的 土地的擁有人的人
- & Please attach documentary proof 請夾附證明文件
- ^ Please insert number where appropriate 請在適當地方註明編號

Please fill "NA" for inapplicable item 請在不適用的項目填寫「不適用」

Please use separate sheets if the space provided is insufficient 如所提供的空間不足,請另頁說明

Please insert a 「✓」 at the appropriate box 請在適當的方格內上加上「✓」號

2401100 7/y by Form No. S16-III 表格第 S16-III 號

For Official Use Only 講 勿 填 寫 此 欄	Application No. 申請編號	A/YL-K7N/1018	•
	Date Received 收到日期	2 1 MAY 2024	

- The completed form and supporting documents (if any) should be sent to the Secretary, Town Planning Board (the Board), 15/F, North Point Government Offices, 333 Java Road, North Point, Hong Kong.
 申請人須把填妥的申請表格及其他支持申請的文件(倘有),送交香港北角渣華道 333 號北角政府合署 15 樓城市規劃委員會(下稱「委員會」)秘書收。
- 3. This form can be downloaded from the Board's website, and obtained from the Secretariat of the Board and the Planning Enquiry Counters of the Planning Department. The form should be typed or completed in block letters. The processing of the application may be refused if the required information or the required copies are incomplete. 此表格可從委員會的網頁下載,亦可向委員會秘書處及規劃署的規劃資料查詢處索取。申請人須以打印方式或以正楷填寫表格。如果申請人所提交的資料或文件副本不齊全,委員會可拒絕處理有關申請。

1. Name of Applicant 申請人姓名/名稱	,
(☑Mr. 先生 /□Mrs. 夫人 /□Miss 小姐 /□Ms. 女士 /□Company 公司 /□Organisation 機構)	
Tang Wai Ip 鄧偉業	

2. Name of Authorised Agent (if applicable) 獲授權代理人姓名/名稱(如適用)
(□Mr. 先生 /□Mrs. 夫人 /□Miss 小姐 /□Ms. 女士 /□Company 公司 /□Organisation 機構)

NA 不適用

3.	Application Site 申請地點	
(a)	Full address / location / demarcation district and lot number (if applicable) 詳細地址/地點/丈量約份及地段號碼(如適用)	Lot 1247 (Part), 1248 (Part), 1249 (Part), 1252 (Part) and 1253 (Part) in D.D. 107, Kam Tin North, Yuen Long 元朗錦田北丈量約份第107約地段第1247號(部份), 1248號(部份), 1249號(部份), 1252號(部份)及第1253號(部份)
(b)	Site area and/or gross floor area involved 涉及的地盤面積及/或總樓面面 積	□Site area 地盤面積 1,559.1 sq.m 平方米□About 約 □Gross floor area 總樓面面積 NA 不適用 sq.m 平方米□About 約
(c)	Area of Government land included (if any) 所包括的政府土地面積(倘有)	NA 不適用 sq.m 平方米 □About 約

(d)	Name and number of the related statutory plan(s) 有關法定圖則的名稱及編號 APPROVED KAM TIN NORTH OUTLINE ZONING PLAN NO. S/YL-KTN/II						
(e)	Land use zone(s) involved 涉及的土地用途地帶						
(f)	空置 Vacant						
4.	"Current Land Owner"	of Application Site 申請地點的「現行土地擁有人」					
The	applicant 申請人 -						
	is the sole "current land owner"	#& (please proceed to Part 6 and attach documentary proof of ownership). #& (請繼續填寫第6部分,並夾附業權證明文件)。					
		ers'' ^{# &} (please attach documentary proof of ownership). 、」 ^{#&} (請夾附業權證明文件)。					
✓	is not a "current land owner"#. 並不是「現行土地擁有人」#	0					
	The application site is entirely 申請地點完全位於政府土地	on Government land (please proceed to Part 6). (請繼續填寫第 6 部分)。					
5.	Statement on Owner's C 就土地擁有人的同意	onsent/Notification /通知土地擁有人的陳述					
(a)	involves a total of	ne Land Registry as at					
(b)	The applicant 申請人 —						
	has obtained consent(s) o	"current land owner(s)".					
	已取得	名「現行土地擁有人」"的同意。					
		rrent land owner(s)"# obtained 取得「現行土地擁有人」#同意的詳情					
	No. of 'Current Land Owner(s)' 「現行土地擁有 人」數目 Lot number/address of premises as shown in the record of the Land (DD/MM/YYYY) 取得同意的日期 (日/月/年)						
	(Please use separate sheets if the space of any box above is insufficient. 如上列任何方格的空間不足,請另頁說明)						

NT.	Details of the "current land owner(s)" notified 已獲通知「現行土地擁有人」"的詳細資料 No. of 'Current						
La r	No. of 'Current Land Owner(s)' 「現行土地擁有人」數目 Lot number/address of premises as shown in the record of the given that the properties of premises as shown in the record of the given that the properties of premises as shown in the record of the given that the properties of premises as shown in the record of the given that the properties of premises as shown in the record of the given that the properties of premises as shown in the record of the given that the properties of premises as shown in the record of the given that the properties of premises as shown in the record of the given that the properties of premises as shown in the record of the given that the properties of premises as shown in the record of the given that the properties of premises as shown in the record of the given that the properties of the properties of premises as shown in the record of the given that the properties of the propert						
(Ple	ase use separate she	eets if the space of any box above	is insufficient. 如上列任何方格的	的空間不足,請另頁說明)			
已挖	采取合理步驟以耳	steps to obtain consent of or g 収得土地擁有人的同意或向記	亥人發給通知。詳情如下:				
Rea			取得土地擁有人的同意所採				
	□ sent request for consent to the "current land owner(s)" on(DD/MM/YYYY)** 於(日/月/年)向每一名「現行土地擁有人」*郵遞要求同意書*						
Rea	Reasonable Steps to Give Notification to Owner(s) 向土地擁有人發出通知所採取的合理步驟						
	published notices in local newspapers on(DD/MM/YYYY) ^{&} 於(日/月/年)在指定報章就申請刊登一次通知 ^{&}						
\checkmark		a prominent position on or no	ear application site/premises on				
	<u>於 10/04/2024</u>	(日/月/年)在申請地	點/申請處所或附近的顯明位	2置貼出關於該申請的通			
		d committee on 10/04/2024	/owners' committee(s)/mutual (DD/MM/YYYY)& F往相關的業主立案法團/業3				
	處,或有關的網						
<u>Oth</u>	ers 其他						
	others (please sp 其他(請指明)	- · ·					
•							

6. Type(s) of Applicatio	n 申請類別					
	pment of Land and/or Build	ling Not Exceeding 3 Years in Rural Areas or				
o o	Regulated Areas 位於鄉郊地區或受規管地區土地上及/或建築物內進行為期不超過三年的臨時用途/發展					
		可知的地理是一中的歸時用述/致茂 elopment in Rural Areas or Regulated Areas, please				
proceed to Part (B))	on for remporary case or zove	vopinion in the state of the guillour, proude				
	見管地區臨時用途/發展的規劃許	可續期,請填寫(B)部分)				
(a) Proposed use(s)/development 擬議用途/發展	Proposed Temporary Open Storage of Construction Machinery and Materials for a Period of 3 Years and Filling of Land Materials for a Period of 3 Years and Filling of Land					
(b) Effective period of	☑ year(s) 年	3				
permission applied for 申請的許可有效期	□ month(s) 個月					
(c) Development Schedule 發展						
Proposed uncovered land are		1,559.1 sq.m ☑About 約				
		NA 不適用sq.m □About 約				
Proposed covered land area		NA 不適田				
Proposed number of building	s/structures 擬議建築物/構築物	数目 NA 不適用				
Proposed domestic floor area	擬議住用樓面面積	sq.m □About 約 NA 不適用				
Proposed non-domestic floor	area 擬議非住用樓面面積	sq.m 凵About 約				
Proposed gross floor area 擬	議總樓面面積	NA 不適用sq.m □About 約				
的擬議用途 (如適用) (Please us	se separate sheets if the space below	s (if applicable) 建築物/構築物的擬議高度及不同樓層 w is insufficient) (如以下空間不足,請另頁說明)				
Proposed number of car parking	spaces by types 不同種類停車位	的擬議數目				
Private Car Parking Spaces 私家車車位 Motorcycle Parking Spaces 電單車車位 Light Goods Vehicle Parking Spaces 輕型貨車泊車位 Medium Goods Vehicle Parking Spaces 中型貨車泊車位 Heavy Goods Vehicle Parking Spaces 重型貨車泊車位 Others (Please Specify) 其他 (請列明)						
Proposed number of loading/unlo	Proposed number of loading/unloading spaces 上落客貨車位的擬議數目					
Taxi Spaces 的士車位		· 收女人 口				
Coach Spaces 旅遊巴車位						
Light Goods Vehicle Spaces 輕		2				
Medium Goods Vehicle Spaces 中型貨車車位						
Heavy Goods Vehicle Spaces 重型貨車車位						
Others (Please Specify) 其他 (請列明)						

	sed operating hours 排 月一至六上午九時至			· 眾假期休息。	••••••		•••••	
Yes 是 (d) Any vehicular access to the site/subject building? 是否有車路通往地盤/ 有關建築物?			 	appropriate) 有一條現有車路。(請註明車路名稱(如適用)) Shui Mei Road, turn to local track. 水尾路,轉到郊區小徑。				區小徑。 nd specify the width)
		No 否						
	Impacts of Developm (If necessary, please u justifications/reasons 措施,否則請提供理	ise separate sh for not provid	heets to in	dicate the propo	sed measures			
` '	Does the development	Yes 是	Please	provide details	請提供詳情	Ē		
	proposal involve alteration of existing building? 擬議發展計劃是否包括現有建築物的改動?	No 否 【v	 Z					
	Does the development proposal involve the operation on the right? 擬議發展是否涉及右列的工程?	No否	diversion (請用地類 範圍) Dive Filli Area Dep Exc Area Dep	the extent of filling E平面圖顯示有關 ersion of stream ing of pond 填塊 a of filling 填塊 ing of land 填土 a of filling 填土 a oth of filling 填土 avation of land a of excavation oth of excavation	g of land/pond(s) 土地/池鄉界線 河道改道 面積 ・・・・・・・・・・・・・・・・・・・・・・・・・・・・・・・・・・・	and/or excavation ,以及河道改道 sq sq sq sqn	of land) 填 ^{塘、填土} m 平 方 米 m	□About 約 □About 約 □About 約 □About 約 □About 約
	Would the development proposal cause any adverse impacts? 擬議發展計劃會否造成不良影響?	On environm On traffic 堂 On water sup On drainage On slopes 堂 Affected by Landscape In Tree Felling Visual Impac Others (Plea	對交通 如 如 如 如 對 對 對 對 以 的 以 的 以 的 以 的 以 的 以 的 以 的 的 的 的 的 的 的 的 的 的 的 的 的	本 斜坡影響 成景觀影響 本	明) ——	Yes 會 Yes 會 Yes 會 Yes 會 Yes Yes Yes 會 Yes 會		No N

diameter 請註明盡 幹直徑及	ate measure(s) to minimise the impact(s). For tree felling, please state the number, at breast height and species of the affected trees (if possible) 是量減少影響的措施。如涉及砍伐樹木,請說明受影響樹木的數目、及胸高度的樹长品種(倘可) Temporary Use or Development in Rural Areas or Regulated Areas
位於鄉郊地區或受規管地區 (a) Application number to which the permission relates 與許可有關的申請編號	區時用途/發展的許可續期 A//
(b) Date of approval 獲批給許可的日期	(DD 日/MM 月/YYYY 年)
(c) Date of expiry 許可屆滿日期	(DD 日/MM 月/YYYY 年)
(d) Approved use/development 已批給許可的用途/發展	
(e) Approval conditions 附帶條件	□ The permission does not have any approval condition 許可並沒有任何附帶條件 □ Applicant has complied with all the approval conditions 申請人已履行全部附帶條件 □ Applicant has not yet complied with the following approval condition(s): 申請人仍未履行下列附帶條件: □ Reason(s) for non-compliance: 仍未履行的原因: □ (Please use separate sheets if the space above is insufficient) (如以上空間不足,請另頁說明)
(f) Renewal period sought 要求的續期期間	□ year(s) 年 □ month(s) 個月

7. Justifications 理由
The applicant is invited to provide justifications in support of the application. Use separate sheets if necessary. 現請申請人提供申請理由及支持其申請的資料。如有需要,請另頁說明)。
Please refer to the Justification Document.

8. Declaration 聲明				
I hereby declare that the particulars given in this application are correct and true to the best of my knowledge and belief. 本人謹此聲明,本人就這宗申請提交的資料,據本人所知及所信,均屬真實無誤。				
I hereby grant a permission to the Board to copy all the materials submitted in this application and to the Board's website for browsing and downloading by the public free-of-charge at the Board's 本人現准許委員會酌情將本人就此申請所提交的所有資料複製及/或上載至委員會網站,使	discretion.			
Signature ☑ Applicant 申請人 / □ Author 簽署	rised Agent 獲授權代理人			
都樟葉 NA 不適)	#			
Name in Block Letters Position (if ap 姓名(請以正楷填寫) 職位 (如初	_			
Professional Qualification(s) □ Member 會員 / □ Fellow of 資深會員 □ HKIP 香港規劃師學會 / □ HKIA 香港建築師學會 □ HKIS 香港測量師學會 / □ HKIE 香港工程師學會 □ HKILA 香港園境師學會/ □ HKIUD 香港城市設計 □ RPP 註冊專業規劃師 Others 其他	<i>ġ /</i> ∵學會			
on behalf of				
代表				
☐ Company 公司 / ☐ Organisation Name and Chop (if applicable) 機構名稱及	文盆草(如烟用)			
Date 日期 25/04/2024 (DD/MM/YYYY 日/月/年)				

Remark 備註

The materials submitted in this application and the Board's decision on the application would be disclosed to the public. Such materials would also be uploaded to the Board's website for browsing and free downloading by the public where the Board considers appropriate.

委員會會向公眾披露申請人所遞交的申請資料和委員會對申請所作的決定。在委員會認為合適的情況下,有關申請資料亦會上載至委員會網頁供公眾免費瀏覽及下載。

Warning 警告

Any person who knowingly or wilfully makes any statement or furnish any information in connection with this application, which is false in any material particular, shall be liable to an offence under the Crimes Ordinance. 任何人在明知或故意的情况下,就這宗申請提出在任何要項上是虛假的陳述或資料,即屬違反《刑事罪行條例》。

Statement on Personal Data 個人資料的聲明

- 1. The personal data submitted to the Board in this application will be used by the Secretary of the Board and Government departments for the following purposes:
 - 委員會就這宗申請所收到的個人資料會交給委員會秘書及政府部門,以根據《城市規劃條例》及相關的城市規劃委員會規劃指引的規定作以下用途:
 - (a) the processing of this application which includes making available the name of the applicant for public inspection when making available this application for public inspection; and 處理這宗申請,包括公布這宗申請供公眾查閱,同時公布申請人的姓名供公眾查閱;以及
 - (b) facilitating communication between the applicant and the Secretary of the Board/Government departments. 方便申請人與委員會秘書及政府部門之間進行聯絡。
- 2. The personal data provided by the applicant in this application may also be disclosed to other persons for the purposes mentioned in paragraph 1 above. 申請人就這宗申請提供的個人資料,或亦會向其他人士披露,以作上述第 1 段提及的用途。
- 3. An applicant has a right of access and correction with respect to his/her personal data as provided under the Personal Data (Privacy) Ordinance (Cap. 486). Request for personal data access and correction should be addressed to the Secretary of the Board at 15/F, North Point Government Offices, 333 Java Road, North Point, Hong Kong. 根據《個人資料(私隱)條例》(第 486 章)的規定,申請人有權查閱及更正其個人資料。如欲查閱及更正個人資料,應向委員會秘書提出有關要求,其地址為香港北角渣華道 333 號北角政府合署 15 樓。

Gist of Application 申請摘要

(Please provide details in both English and Chinese <u>as far as possible</u>. This part will be circulated to relevant consultees, uploaded to the Town Planning Board's Website for browsing and free downloading by the public and available at the Planning Enquiry Counters of the Planning Department for general information.)

(請<u>盡量以英文及中文填寫。此部分將會發送予相關諮詢人士、上載至城市規劃委員會網頁供公眾免費瀏覽及下載及於規劃署規劃資料查詢處供一般參閱。)</u>

Application No. 申請編號	(For Official Use Only) (請勿填寫此欄)
Location/address 位置/地址	Lot 1247 (Part), 1248 (Part), 1249 (Part), 1252 (Part) and 1253 (Part) in D.D. 107, Kam Tin North, Yuen Long 元朗錦田北丈量約份第107約地段第1247號(部份), 1248號(部份), 1252號(部份)及第1253號(部份)
Site area 地盤面積	1,559.1 sq. m 平方米 ☑ About 約 (includes Government land of 包括政府土地 NA 不適用 sq. m 平方米 □ About 約)
Plan 圖則	錦田北分區計劃大綱核准圖編號 S/YL-KTN/11 APPROVED KAM TIN NORTH OUTLINE ZONING PLAN NO. S/YL-KTN/11
Zoning 地帶	· 農業 Agriculture
Type of Application 申請類別	 ✓ Temporary Use/Development in Rural Areas or Regulated Areas for a Period of 位於鄉郊地區或受規管地區的臨時用途/發展為期 ✓ Year(s) 年 3
	位於鄉郊地區或受規管地區臨時用途/發展的規劃許可續期為期 □ Year(s) 年 □ Month(s) 月
Applied use/ development 申請用途/發展	Proposed Temporary Open Storage of Construction Machinery and Materials for a Period of 3 Years and Filling of Land 擬議臨時露天存放建築機械及物料(為期3年)及填上工程

(i) Gross floor area and/or plot ratio			sq.m 平方米		Plot Ratio 地積比率	
總相	要面面積及/或 責比率	Domestic 住用	NA 不適用	□ About 約 □ Not more than 不多於	NA 不適用	□About 約 □Not more than 不多於
		Non-domestic 非住用	NA 不適用	□ About 約 □ Not more than 不多於	NA 不適用	□About 約 □Not more than 不多於
(ii) No. 幢婁	of blocks 女	Domestic 住用	NA 不	、適用		
		Non-domestic 非住用	NA 不	、適用		
of st	lding height/No. toreys 終物高度/層數	Domestic 住用	NA 不	、適用	□ (Not r	m 米 more than 不多於)
			NA 不	、適用	□ (Not r	Storeys(s) 層 more than 不多於)
		Non-domestic 非住用	NA 不	適用	□ (Not r	m 米 more than 不多於)
			NA 不	5.適用	□ (Not r	Storeys(s) 層 more than 不多於)
	e coverage 蓋面積		NA 不	這 適用	%	□ About 約
spac unlo 停車	of parking ces and loading / pading spaces 草位及上落客貨 立數目	Medium Goods V	ng Spaces 私家ng Spaces 電單icle Parking Spaces fehicle Parking Spaces for the parking Spaces	K車車位 E車車位 aces 輕型貨車泊車 Spaces 中型貨車沿 paces 重型貨車泊車	白車位	
		Total no. of vehicle loading/unloading bays/lay-bys 上落客貨車位/停車處總數 Taxi Spaces 的士車位				
		Coach Spaces 版 Light Goods Vehi Medium Goods V Heavy Goods Veh Others (Please Sp	遊巴車位 icle Spaces 輕極 ehicle Spaces nicle Spaces 重	中型貨車位 型貨車車位		LGV: 2

Submitted Plans, Drawings and Documents 提交的圖則、繪圖及文件		
	<u>Chinese</u> 中文	English 英文
Plans and Drawings 圖則及繪圖		
Master layout plan(s)/Layout plan(s) 總綱發展藍圖/布局設計圖		
Block plan(s) 樓宇位置圖		
Floor plan(s) 樓宇平面圖		
Sectional plan(s) 截視圖		
Elevation(s) 立視圖		
Photomontage(s) showing the proposed development 顯示擬議發展的合成照片		
Master landscape plan(s)/Landscape plan(s) 園境設計總圖/園境設計圖		
Others (please specify) 其他(請註明)	abla	\square
Location Plan, Proposed Layout Plan and Paved Area and Existing Vehicular Access	•	
Reports 報告書		
Planning Statement/Justifications 規劃綱領/理據	\square	
Environmental assessment (noise, air and/or water pollutions)		
環境評估(噪音、空氣及/或水的污染)		
Traffic impact assessment (on vehicles) 就車輛的交通影響評估		
Traffic impact assessment (on pedestrians) 就行人的交通影響評估		
Visual impact assessment 視覺影響評估		
Landscape impact assessment 景觀影響評估		
Tree Survey 樹木調査		
Geotechnical impact assessment 土力影響評估		Ш
Drainage impact assessment 排水影響評估		
Sewerage impact assessment 排污影響評估		
Risk Assessment 風險評估		닐
Others (please specify) 其他(請註明)		
Note: May insert more than one 「✔」. 註:可在多於一個方格內加上「✔」號		


Note: The information in the Gist of Application above is provided by the applicant for easy reference of the general public. Under no circumstances will the Town Planning Board accept any liabilities for the use of the information nor any inaccuracies or discrepancies of the information provided. In case of doubt, reference should always be made to the submission of the applicant. 註: 上述申請摘要的資料是由申請人提供以方便市民大眾參考。對於所載資料在使用上的問題及文義上的歧異,城市規劃委員會概不負責。若有任何疑問,應查閱申請人提交的文件。

申請理由

根據城市規劃條例第 16 條作出規劃許可申請 擬在新界元朗錦田丈量約份第 107 約地段第 1247 號(部份)、第 1248 號(部份)、 第 1249 號(部份)、第 1252 號(部份)及第 1253 號(部份) 作為期三年的臨時露天存放建築機械及物料及填土工程之用途

- ▶ 申請地點的面積約為 1,559.1 平方米,根據錦田北分區計劃大綱核准圖編號 S/YL-KTN/11,申請地點現時被規劃作「農業」地帶。
- 本擬議發展為臨時性質,因此不會影響申請地點長遠待規劃意向。根據租賃文件,該用地可作農業用,在未首先獲得批准的情況下,該地段不允許用於其他土地用途。因此, "露天存放建築機械及物料"開發申請仍然符合租約。
- ▶ 擬議申請的露天存放在同一個「農業」地帶,城市規劃委員會曾批准相類似的露天存放,申請包括: A/YL-KTN/962 (2023年12月8日獲批)。因此希望城市規劃委員會對本申請作出相同的對待。
- ▶ 臨時貨倉計劃放置建築機械及物料。不會用作存放危險品。
- ▶ 城市高速發展及土地資源稀少的情況下,有大量用作工業及棕地的土地已改作其他發展或計劃用作其他發展,例如錦田北分區計劃大綱核准圖編號 S/YL-KTN/11 內部份模範鄉至部份逢吉鄉由農業及工業用途外劃為住宅及政府、機構或社區」用途、洪水橋/厦村新發展區及鄰近元朗工業邨的棕地等。本人希望透過規劃申請,提供臨時土地收納及滿足需要搬遷的小型露天存放的巨大需求。
- ▶ 本申請只作存放用途,不會進行任何作業。
- ▶ 擬議用途的營業時間為星期一至星期六上午九時至下午七時,星期日及公眾假期休息。
- ▶ 申請地點會採用混凝土作平整物料,平整厚度不超過 0.2 米,申請期限結束後會將混凝土打碎並運走。
- 申請用途的用途、形式及佈局與周遭環境並沒有不協調,亦會顧及自然特色。

- 當場地發展後,附帶條件的美化環境建議能加強申請地點及周圍的綠化效果,使整體視野變得 美觀更令人舒服。渠務建議計劃及舒緩環境措施,也能令附近地區受惠,有效地加強該地區及 附近範圍的環境保護,並能減少水浸可能。
- 》 根據以上各點,誠意懇求城市規劃委員會寬大批准新界元朗錦田丈量約份第 107 約地段第 1247 號(部份)、第 1248 號(部份)、第 1249 號(部份)、第 1252 號(部份)及第 1253 號(部份)作為期三年的臨時露天存放建築機械及物料及填土工程之用途。

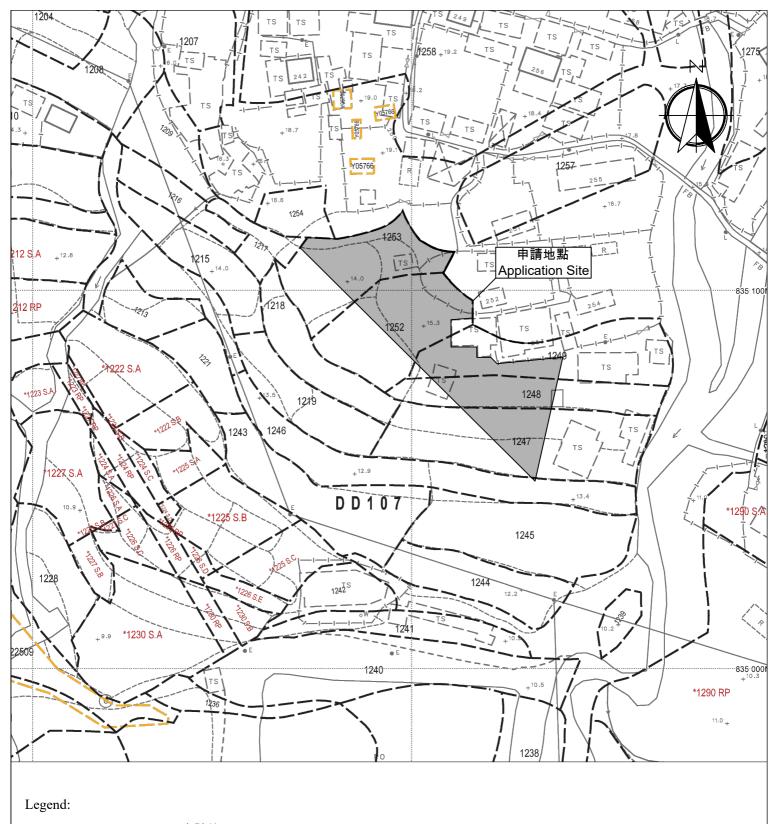

Application Site 申請範圍

Appendix 1

Location: DD 107 Lot 1247 (Part), 1248 (Part), 1249 (Part), 1252 (Part)

and 1253 (Part)

OZP: S/YL-KTN/11 District: Kam Tin North Zoning: Agriculture

Date: 23 April 2024

<u>Location</u> 位置圖

擬議臨時露天存放建築機械及物料 (為期3年)及填土

Proposed Temporary Open Storage of Construction Machinery and Materials For a Period of 3 Years and Filling of Land

SCALE

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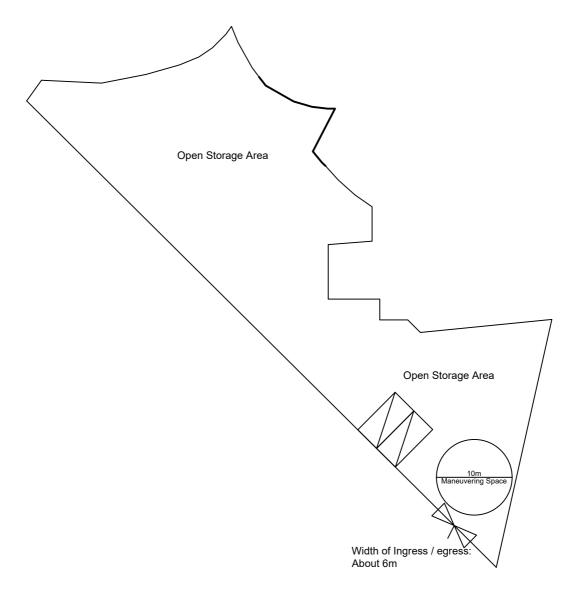
For Identification Only

Drawing No.:

LGV L/UL Space Dimension: 7m x 3.5m

Unit(s): 2





Legend:

Ingress/egress (Width: About 6m)

LGV L/UL Space (Unit(s): 2)

0 **Maneuvering Space**

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Δ	n	n	$\boldsymbol{\mathcal{L}}$	n	n	IV	,

Location: DD 107 Lot 1247 (Part), 1248 (Part), 1249 (Part), 1252 (Part)

and 1253 (Part)

OZP: S/YL-KTN/11 District: Kam Tin North Zoning: Agriculture

Proposed Layout Plan

擬議佈局平面圖

擬議臨時露天存放建築機械及物料 (為期3年)及填土

Proposed Temporary Open Storage of **Construction Machinery and Materials** For a Period of 3 Years and Filling of Land


CCM	
SUAL	г

Total Area: 1,559.1 m² (About)

1:500

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For Identification Only	Drawing No.:
Date: 23 May 2024	2-01

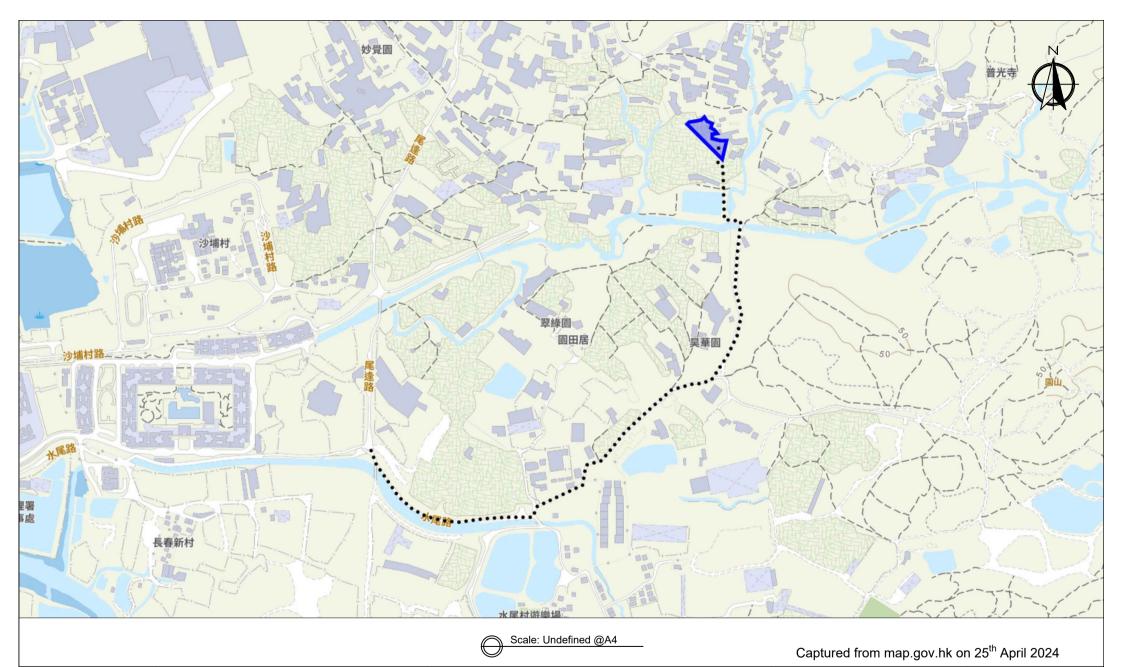

Appendix 3

Location: D.D. 107 Lot 1247 (Part), 1248 (Part),

1249 (Part), 1252 (Part) and 1253 (Part)

Existing Vehicular OZP: S/YL-KTN/11 Access District: Kam Tin North Zoning: Agriculture

Proposed Temporary Open Storage of **Construction Machinery and Materials** For a Period of 3 Years and Filling of Land Width of Shui Mei Road: 3-6m (About) Map Legend:

•••• Road Path Site Boundary Drawing No.: 3-01

For Identification Only

Date: 25/04/2024



Total Area: 1,559.1 m² (About)

Legend:

Paved Area 平整範圍

Appendix 4

Location: DD 107 Lot 1247 (Part), 1248 (Part), 1249 (Part), 1252 (Part)

and 1253 (Part)

OZP: S/YL-KTN/11 District: Kam Tin North Zoning: Agriculture

Date: 25 April 2024

Paved Area 平整位置圖

擬議臨時露天存放建築機械及物料 (為期3年)及填土

Proposed Temporary Open Storage of Construction Machinery and Materials For a Period of 3 Years and Filling of Land

1:500

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For Identification Only

Drawing No.:

To: tpbpd/PLAND <tpbpd@pland.gov.hk></tpbpd@pland.gov.hk>
Subject: Fw: S. 16 Planning Application no. A/YL-KTN/1018 - Departmental Comments
From: Tang Lok San Sent: Monday, September 16, 2024 12:35 PM Subject: Re: S. 16 Planning Application no. A/YL-KTN/1018 - Departmental Comments 2024年10月16日前可下載附件 Ms Ng,
I would like to supersede the email that I sent at 11:38 a.m. on 15 September with this email. Please see the attachment for the Further Information. If you have any question regarding to the application, please do not hesitate to contact Mr. Tang on phone or email to vour sincerely, Mr. Tang
從 iCloud 下載

AYL-KTN 10...0916 (U).pdf 35.7 MB

Proposed operating hours 擬議營運時間 星期一至六上午九時至下午七時,星期日及公眾假期休息。				
	•••••			
(d)	Any vehicular acce the site/subject buildi 是否有車路通往地 有關建築物?	ing?	 ✓ There is an existing access. (please indicate the street name, where appropriate) 有一條現有車路。(請註明車路名稱(如適用)) Shui Mei Road, turn to local track. 水尾路,轉到郊區小徑。 □ There is a proposed access. (please illustrate on plan and specify the width) 有一條擬議車路。(請在圖則顯示,並註明車路的闊度) □ 	
(e)	(If necessary, please t	use separate shee for not providin	延議發展計劃的影響 ets to indicate the proposed measures to minimise possible adverse impacts or give ng such measures. 如需要的話,請另頁註明可盡量減少可能出現不良影響的	
(ii)	Does the development proposal involve alteration of existing building? 擬議發展計劃是否包括現有建築物的改動? Does the development proposal involve the operation on the right? 擬議發展是否涉及右列的工程?	No 否	Please provide details in its	
(iii)	Would the development proposal cause any adverse impacts? 擬議發展計劃會否造成不良影響?	On environment 對環境 On traffic 對交通 On water supply 對供水 On drainage 對排水 On slopes 對斜坡 Affected by slopes 受斜坡影響 Landscape Impact 構成景觀影響 Tree Felling 砍伐樹木 Visual Impact 構成視覺影響 Others (Please Specify) 其他 (請列明) ———————————————————————————————————		

城市規劃委員會:

有關城市規劃委員會對 A/YL-KTN/1018 的查詢

收悉 貴委員會對 A/YL-KTN/1018 申請的疑問,本人現書面回覆。

申請範圍方面,雖然 A/YL-KTN/962 的申請人同是本人,但兩個申請沒有關聯。現時申請的範圍比 A/YL-KTN/962 大,因為在上次申請時未能向業主承租現時全部申請範圍,現已向相關持分者承租相關範圍。因此向 貴委員會 重新申請,望 貴委員會諒解。

申請理由是因城市高速發展及土地資源稀少的情況下,有大量用作工業 及棕地的土地已改作其他發展或計劃用作其他發展,例如錦田北分區計劃大綱 核准圖編號 S/YL-KTN/11 內部份模範鄉至部份逢吉鄉由農業及工業用途外劃 為住宅及政府、機構或社區」用途、洪水橋/厦村新發展區及鄰近元朗工業邨的 棕地等,存放的需求大大增加。因此,本人希望能透過規劃申請,提供臨時土 地收納及滿足需要搬遷的小型露天存放。

存放高度最高不超過 6 米。現場會存放小型機械及水電工程所包含的工程材料,例如排水管、水喉及電箱、挖掘機、升降台等。物料大小及長度不一,最長約 4.5 米。

本申請只會用在存放用途,不會進行任何有關回收、清潔、修理、拆解 或其他工場作業。

申請範圍約 1,559.1 平方米,當中有約 268 平方米為車輛上落區、車輛轉動區及樹木保護區,上述範圍不會用在露天存放。相關圖則請參考 Appendix 2 (2-02)。

希望此附加文件能釋除 貴署的隱憂,並支持本申請。

LGV L/UL Space Dimension: 7m x 3.5m Unit(s): 2 Open Storage Area Tree Protection Zone Open Storage Area Vehicle L/UL and Maneuvering Space Width of Ingress / egre

Legend:

LGV L/UL Space (Unit(s): 2)

Maneuvering Space

Total Area: 1,559.1 m² (About)

About 6m

Open Storage Area: 1,291.1 m² (About)

Vehicle Maneuvering Space and Tree Protection Zone: 268 m² (About)

Appendix 2

Location: DD 107 Lot 1247 (Part), 1248 (Part), 1249 (Part), 1252 (Part)

and 1253 (Part)

OZP: S/YL-KTN/11 District: Kam Tin North Zoning: Agriculture Proposed Layout Plan

擬議佈局平面圖

擬議臨時露天存放建築機械及物料 (為期3年)及填土

Proposed Temporary Open Storage of Construction Machinery and Materials For a Period of 3 Years and Filling of Land

SCALE

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For Identification Only	Drawing No.:
Date: 11 September 2024	2-02

城市設計及園境組及城市規劃委員會:

有關城市設計及園境組對 A/YL-KTN/1018 的查詢

收悉 貴組對 A/YL-KTN/1018 申請的疑問,本人現書面回覆。

保護樹木方面,會將樹幹兩米內的混凝土打碎並運走,亦會豎立約 1.2 米高的短柱保護樹木,建立樹木保護區,保護區不會放置任何物品,以免影響 樹木生長。樹木會定期檢查及修剪,保護樹木。本人為錯誤平整相關範圍致 歉,望 貴組諒解。

希望此附加文件能釋除 貴署的隱憂,並支持本申請。

運輸署及城市規劃委員會:

有關對運輸署 A/YL-KTN/1018 的查詢

收悉運輸署對 A/YL-KTN/1018 申請的疑問,現以書面回覆。

本人預計本申請地點的車流為以下:

時段	車輛數目(包括出/入)
00:00-01:00	0
01:00-02:00	0
02:00-03:00	0
03:00-04:00	0
04:00-05:00	0
05:00-06:00	0
06:00-07:00	0
07:00-08:00	0
08:00-09:00	0
09:00-10:00	0 - 2
10:00-11:00	0 - 2
11:00-12:00	0 - 2
12:00-13:00	0 - 2
13:00-14:00	0 - 2
14:00-15:00	0 - 2
15:00-16:00	0 - 2
16:00-17:00	0 - 2
17:00-18:00	0 - 2
18:00-19:00	0 - 2
19:00-20:00	0
20:00-21:00	0
21:00-22:00	0
22:00-23:00	0
23:00-00:00	0

以下為最近水尾路大約的車流量^:

時段	車流量
00:00-01:00	2-5 輛
01:00-02:00	2-5 輛
02:00-03:00	2-5 輛
03:00-04:00	2-5 輛
04:00-05:00	2-5 輛
05:00-06:00	2-5 輛
06:00-07:00	5-10 輛
07:00-08:00	10-15 輛
08:00-09:00	15-20 輛
09:00-10:00	15-20 輛

10:00-11:00 15-20 輛 11:00-12:00 15-20 輛 12:00-13:00 20-25 輛 13:00-14:00 20-25 輛 14:00-15:00 15-20 輛 15:00-16:00 15-20 輛 16:00-17:00 15-20 輛 17:00-18:00 20-25 輛 18:00-19:00 20-25 輛 19:00-20:00 20-25 輛 20:00-21:00 15-20 輛 21:00-22:00 15-20 輛 22:00-23:00 10-15 輛 23:00-00:00 5-10 輛		
12:00-13:00 20-25 輛 13:00-14:00 20-25 輛 14:00-15:00 15-20 輛 15:00-16:00 15-20 輛 16:00-17:00 15-20 輛 17:00-18:00 20-25 輛 18:00-19:00 20-25 輛 19:00-20:00 20-25 輛 20:00-21:00 15-20 輛 21:00-22:00 15-20 輛 22:00-23:00 10-15 輛	10:00-11:00	15-20 輛
13:00-14:00 20-25 輛 14:00-15:00 15-20 輛 15:00-16:00 15-20 輛 16:00-17:00 15-20 輛 17:00-18:00 20-25 輛 18:00-19:00 20-25 輛 19:00-20:00 20-25 輛 20:00-21:00 15-20 輛 21:00-22:00 15-20 輛 22:00-23:00 10-15 輛	11:00-12:00	15-20 輛
14:00-15:00 15-20 輛 15:00-16:00 15-20 輛 16:00-17:00 15-20 輛 17:00-18:00 20-25 輛 18:00-19:00 20-25 輛 19:00-20:00 20-25 輛 20:00-21:00 15-20 輛 21:00-22:00 15-20 輛 22:00-23:00 10-15 輌	12:00-13:00	20-25 輛
15:00-16:00 15-20 輛 16:00-17:00 15-20 輛 17:00-18:00 20-25 輛 18:00-19:00 20-25 輛 19:00-20:00 20-25 輛 20:00-21:00 15-20 輛 21:00-22:00 15-20 輛 22:00-23:00 10-15 輌	13:00-14:00	20-25 輛
16:00-17:00 15-20 輛 17:00-18:00 20-25 輛 18:00-19:00 20-25 輛 19:00-20:00 20-25 輛 20:00-21:00 15-20 輛 21:00-22:00 15-20 輛 22:00-23:00 10-15 輛	14:00-15:00	15-20 輛
17:00-18:00 20-25 輛 18:00-19:00 20-25 輛 19:00-20:00 20-25 輛 20:00-21:00 15-20 輛 21:00-22:00 15-20 輛 22:00-23:00 10-15 輌	15:00-16:00	15-20 輛
18:00-19:00 20-25 輛 19:00-20:00 20-25 輛 20:00-21:00 15-20 輛 21:00-22:00 15-20 輛 22:00-23:00 10-15 輛	16:00-17:00	15-20 輛
19:00-20:00 20-25 輛 20:00-21:00 15-20 輛 21:00-22:00 15-20 輛 22:00-23:00 10-15 輛	17:00-18:00	20-25 輛
20:00-21:00 15-20 輛 21:00-22:00 15-20 輛 22:00-23:00 10-15 輛	18:00-19:00	20-25 輛
21:00-22:00 15-20 輛 22:00-23:00 10-15 輛	19:00-20:00	20-25 輛
22:00-23:00 10-15 輛	20:00-21:00	15-20 輛
1119	21:00-22:00	15-20 輛
23:00-00:00 5-10 輛	22:00-23:00	10-15 輛
	23:00-00:00	5-10 輛

[^]此數字在 2024 年 5 月 8 日統計。

由於方便上落物料駕車到本申請地點,現申請 2 個客貨車上落貨位置。本申請不會對公眾開放。因此,2 個客貨車上落貨位置已足夠此申請運作。

申請地點有道路連接,前往本申請地點途經水尾路,再轉到郊區小徑。 水尾路及郊區小徑沿途道路約有 3-6 米闊,沿途設有避車處,客貨車有足夠的 位置通過。申請地點的出入口約 6 米闊。沿途道路相片請參考文件末端,而相 片的觀看點請參考 Appendix 3。

在申請地點內有一個直徑超過 10 米的圓形空間,足夠讓車輛進行調遣的動作,不需在公用道路上讓車輛等候進入本申請地點,停泊在公用道路及以倒後形式進出本申請地點。參考文件末端的 Appendix 2。

本人明白及了解連接申請地點的道路不是由 貴署管理。

希望此附加文件能釋除 貴署的隱憂,並支持本申請。

道路相片:













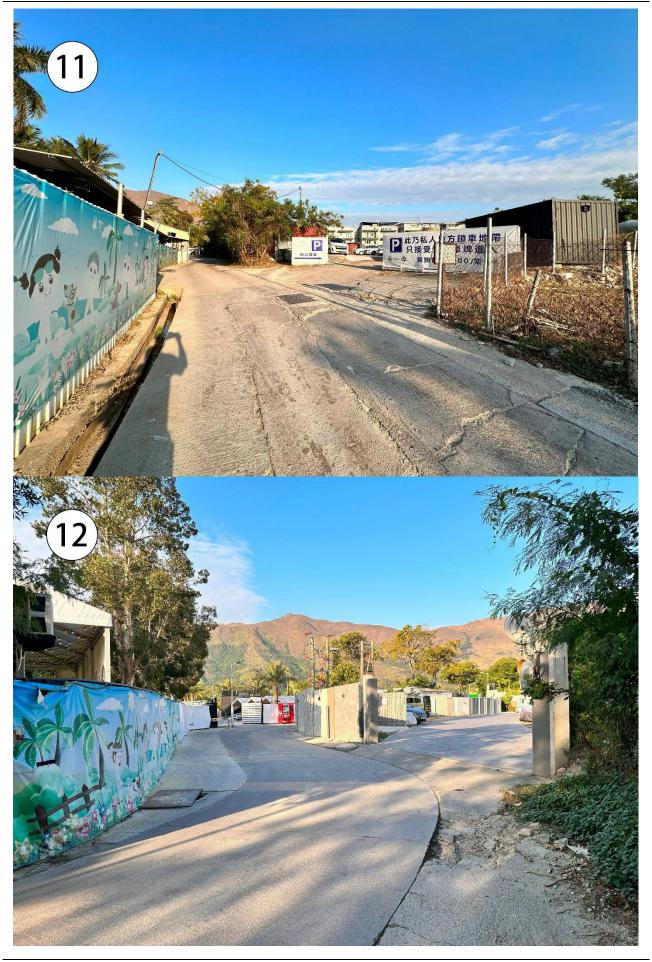

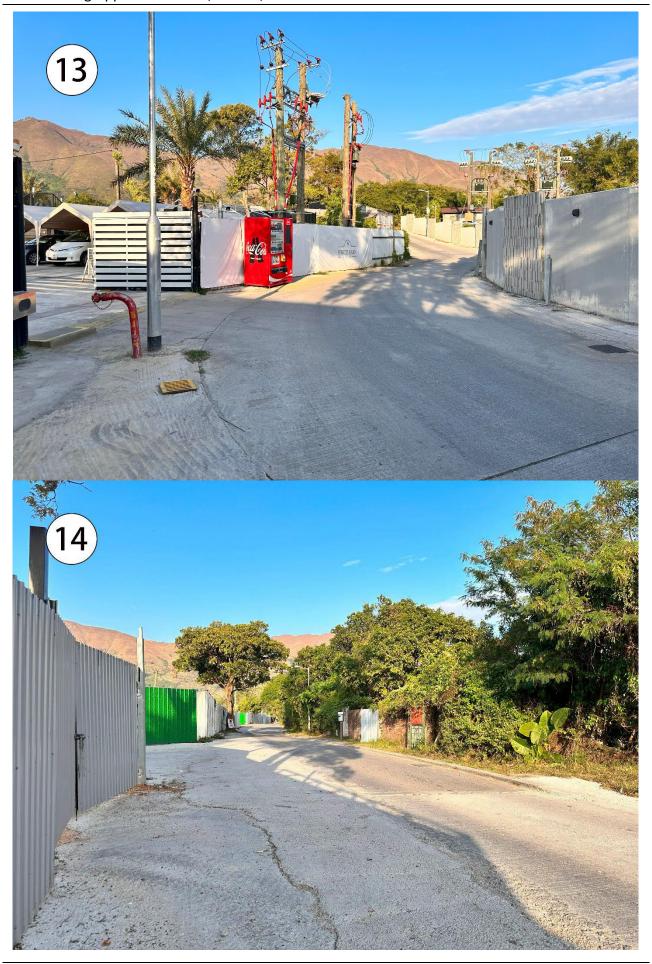










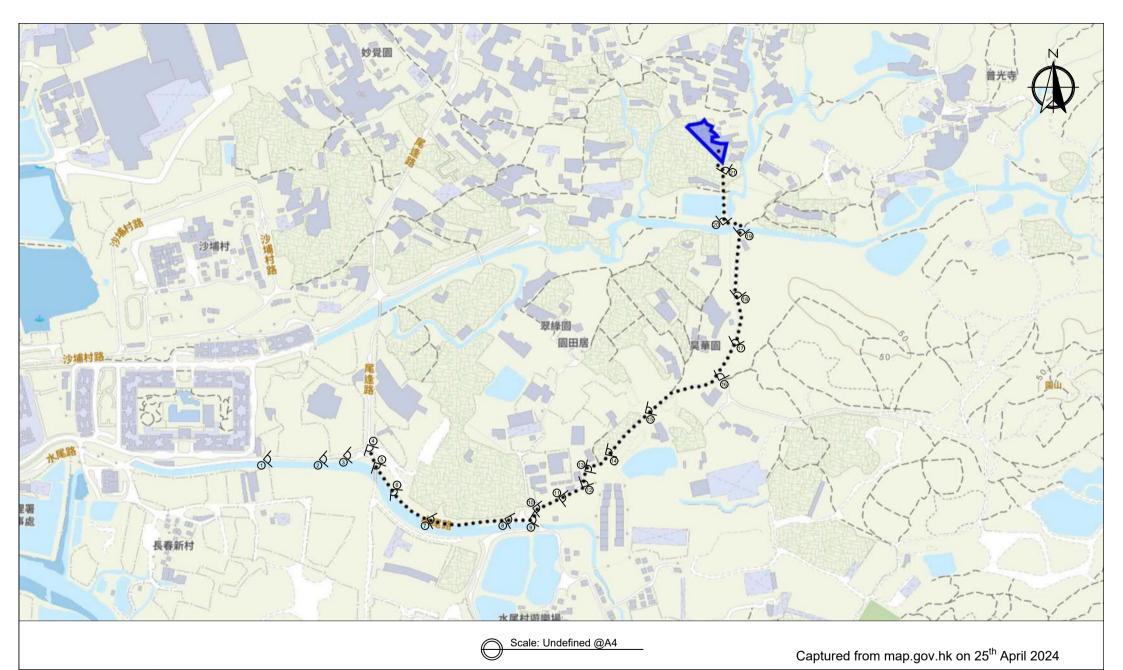

Appendix 3

Location: D.D. 107 Lot 1247 (Part), 1248 (Part),

1249 (Part), 1252 (Part) and 1253 (Part)

Existing Vehicular
Access
OZP: S/YL-KTN/11
District: Kam Tin North
Zoning: Agriculture

Proposed Temporary Open Storage of Construction Machinery and Materials For a Period of 3 Years and Filling of Land Width of Shui Mei Road: 3-6m (About)
Map Legend:

<u>~</u>

Road Path Site Boundary Viewing Point Drawing No.: 3-01

For Identification Only

Date: 07/06/2024

渠務署及城市規劃委員會:

A/YL-KTN/1018 的渠務報告詳細

申請地點範圍有約 1,559.1 平方米,位於錦田北的鄉郊範圍。目前為露天空間及建有臨時建築物。

申請地點附近有大量的臨時建築物及草地。現有水平為約+14.4 mPD (此水平已完成填土及平整)。

有一條自然溪流位於申請地點的東面,並計劃將場內水流引導到該溪 流。

申請範圍的東北面水平比申請地點高,有機會會有水流從這面流入。申 請範圍北外改有約 450mm 的渠道,因此沒有流水從其他方向流入申請地點。

申請地點的擬議佈局平面圖請參考 Appendix 2。

申請地點範圍有約 1,559.1 平方米,全部將以混凝土作表面,在申請地點外有約 4,115.9 平方米,大多為草地、道路及建築物。

擬議發展	
申請地點範圍 (約 m²),全部已以混	1,559.1
凝土平整	
申請地點外集水區	
申請地點外北面集水區 (約 m²),大	4,115.9
多為草地、道路及建築物,本報告將	
以約93%混凝土作評估	

根據 STORMWATER DRAINAGE MANUAL (SDM) - Table 10 - Recommended Design Return Periods based on Flood Levels

Intensively Used Agricultural Land	2-5 years
Village Drainage including Internal Drainage	10 years
System under a Polder Scheme	
Main Rural Catchment Drainage Channels	50 years
Urban Drainage Trunk Systems	200 years
Urban Drainage Branch Systems	50 years

本報告將使用 Main Rural Catchment Drainage Channels, 1 in 50 years return period 作評估。

 Intensity-Duration-Frequency Relationship - The Recommended Intensity-Duration-Frequency relationship is used to estimate the intensity of rainfall. It can be expressed by the following algebraic equation.

$$i = \frac{a}{(t_d + b)^c}$$

The site is located within the HKO Headquarters Rainfall Zone. Therefore, for 50 years return period, the following values are adopted.

$$a = 451.3$$

$$b = 2.46$$

$$c = 0.337$$

2. The peak runoff is calculated by the Rational Method.

$$Q_p = 0.278 \ C \ i \ A$$

where $V = peak runoff in m^3/s$

C = runoff coefficient (dimensionless)

i = rainfall intensity in mm/hr

A = $catchment area in km^2$

3. According to Section 7.5.2(b) of the Stormwater Drainage Manual (SDM), Fifth Edition January 2018

Surface Characteristics	Runoff coefficient, C
Asphalt	0.70-0.95
Concrete	0.80-0.95
Brick	0.70-0.85
Grassland (heavy soil)	
Flat	0.13-0.25
Steep	0.25-0.35
Grassland (sandy soil)	
Flat	0.05-0.15
Steep	0.15-0.20

The run-off coefficient (C) of surface runoff area taken as follows:

- Concrete Area C = 0.95

Grassland (Heavy soil) with flat surface C = 0.25

4. Manning's Equation is used for calculation of velocity of flow inside the channels. It can be expressed by the following algebraic equation.

$$V = \frac{R^{1/6}}{n} \sqrt{RS_f}$$

where V = Velocity of the pipe flow (m/s)

S_f = Hydraulic gradient

n = manning's coefficient

R = Hydraulic radius (m)

5. Colebrook-White Equation is used for calculation of velocity of flow inside the pipes. It can be expressed by the following algebraic equation.

$$\overline{V} = -\sqrt{32gRS} \log \log \left(\frac{k_s}{14.8R} + \frac{1.255v}{R\sqrt{32gRS_f}} \right)$$

where V = Velocity of the pipe flow (m/s)

S_f = Hydraulic gradient

k_f = roughness value (m)

v = kinematics viscosity of fluid

D = pipe diameter (m)

R = Hydraulic radius (m)

申請範圍主要平坦,並緩緩斜向東面,渠道設計請參考 Appendix 5。

渠道容量計算請參考 Appendix - Calculation。

根據本報告,本臨時發展不會對附近的渠道有重大影響。

二零二四年七月二十日

Check The Capacity of Existing Natural Stream

Manning Equation is used in hydraulic design and analysis. The cross-sectional mean velocity is given in the following expression:

$$V = \frac{R^{1/6}}{n} \sqrt{RS_f}$$

Where

R = hydraulic (m)

N = Manning coefficient (s/m1/3), refer Table 13 of SDM

Sf = friction gradient (dimensionless)

Using Manning's Equation

$$V = R^{2/3} * S_f^{0.5} / n$$

Where R = A/P = 0.667 m A = 4 m²
$$P = 6 m$$
 n = 0.05 s/m^{1/3} (Table 13 of Stormwater Drainage Manual)
$$S_f = 0.245$$

Therefor V =
$$0.667^{2/3}*0.245^{0.5}/0.05$$

= 7.55 m/sec

Maximum Capacity (Qmax)

= V*A

 $= 30.2 \text{ m}^3/\text{sec}$

> Q total *Allowed 10% for situation.

The Existing Natural Stream has enough capacity.

Appendix – Calculation

Capacity Flows Estimation for Propose Catchments and Drainage System with 50 Year Return Period

A1. Calculation of On-Site Runoff (After Development)

Surface Type	Catchment Area (A), m ²	Catchment Area (A), km²	Average slope (H), m/100m	Flow path length (L), m	Inlet time (t₀), min	Time of Concentration (t _c), min	Duration (t _d), min	a (50 year return period)	b (50 year return period)	c (50 year return period)	(i) mm/hr	Runoff coefficient (C)	C×A	Peak runoff (Q _p),
7% Grassland (Heavy soil) with flat surface + 93% Concrete	5,675	0.005675	3.52	96.7	4.58	4.58	4.58	451.3	2.46	0.337	234	0.9	0.0051075	0.332

0.332 Total

A2. Calculation of the Capacity of Proposed Drainage (After Development)

Channel Type	Width, m	Depth, m	Slope	Length, m	Manning's Roughness	Cross Section	Wetted	Hydraulic	Mean	Capacity	Catchment	Runoff, m3/s	% of capacity	Sufficient
					Coefficient	Area, m2	Perimeter, m	radius, m	Velocity, m/s	flow, m3/s	Served, km²	Kulloli, Ilis/S	flow	Capacity (Y/N)
Concrete Channel	0.45	0.45	0.005	203	0.015	0.26	1.157	0.225	1.74	0.453	0.005675	0.332	73%	Υ

*Allowed 10% for siltation

Note:

Runoff is calculated in accordance with DSD's "Stormwater Drainage Manual – Planning, Design and Management" (SDM), fifth edition, January 2018.

Equation used: $t_0 = \frac{0.14465L}{H^{0.2}A^{0.1}}$

 $t_c = t_0 + t_f$ $i = \frac{a}{(t_d + b)^c}$ $Q_p = 0.278 \ C \ i \ A$ $V = \frac{R^{1/6}}{n} \sqrt{RS_f}$

B1. Calculation of the runoff of Existing Drainage System


Surface Type	Catchment Area (A), m²	Catchment Area (A), km²	Average slope (H), m/100m	Flow path length (L), m	Inlet time (t _o), min	Time of Concentration (t _c), min	Duration (t _d), min	a (50 year return period)	b (50 year return period)	c (50 year return period)	(i) mm/hr	Runoff coefficient (C)	CxA	Peak runoff (Q _p),
15% Concrete + 85% Grassland (Heavy soil) with steep surface	545,522	0.545522	24.5	1,470	29.93	29.93	29.93	451.3	2.46	0.337	140	0.44	0.24003	9.34

Total 9.34

B2. Adequacy Check for Existing Drainage System

	8	87													
Channel Type	Width, m	Depth, m	m Slope	Length, m	Longth m	Manning's Roughness	Cross Section	Wetted	Hydraulic	Mean	Capacity	Catchment	Runoff, m3/s	% of capacity	Sufficient
Спаппеттуре					Coefficient	Area, m2	Perimeter, m	radius, m	Velocity, m/s	flow, m3/s	Served, km²	Rulloll, Ilis/s	flow	Capacity (Y/N)	
Natural-Stream (7)	2	2	0.245	1,470	0.05	4	6	0.667	7.55	30.2	0.530231	9.34	31%	Υ	

^{*}Allowed 10% for siltation. For assessment purpose, assume width and depth of the channel is 2m.

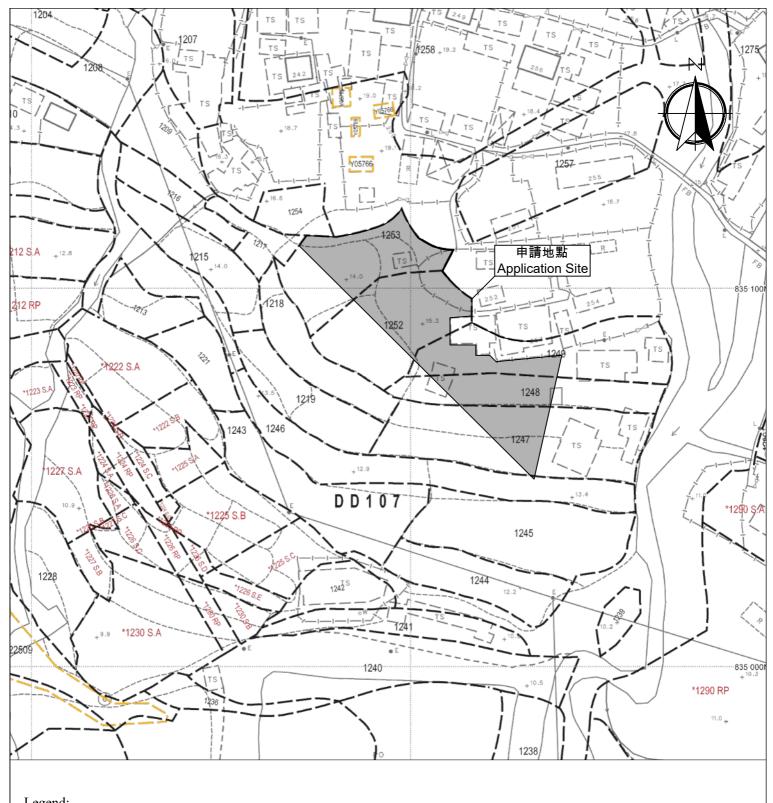

Legend:

Application Site 申請範圍

Appendix 1

Location: DD 107 Lot 1247 (Part), 1248 (Part), 1249 (Part), 1252 (Part)

and 1253 (Part)

OZP: S/YL-KTN/11 District: Kam Tin North Zoning: Agriculture

Date: 23 April 2024

Location 位置圖

擬議臨時露天存放建築機械及物料 (為期3年)及填土

Proposed Temporary Open Storage of **Construction Machinery and Materials** For a Period of 3 Years and Filling of Land

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For Identification Only

Drawing No.:

LGV L/UL Space Dimension: 7m x 3.5m Unit(s): 2 Open Storage Area Tree Protection Zone Open Storage Area 10m Maneuvering Space Width of Ingress / egress About 6m

Legend:

LGV L/UL Space (Unit(s): 2)

Maneuvering Space

۸			_		لہ	:	2
А	D	D	е	n	u	ix	2

Location: DD 107 Lot 1247 (Part), 1248 (Part), 1249 (Part), 1252 (Part)

and 1253 (Part)

OZP: S/YL-KTN/11 District: Kam Tin North Zoning: Agriculture

Proposed Layout Plan 擬議佈局平面圖

擬議臨時露天存放金屬、膠喉、機器、 汽車零件及建築材料(為期3年)及填土

Proposed Temporary Open Storage of Metal, Plastic Pipes, Machinery, Vehicle Parts and Construction Materials For a Period of 3 Years and Filling of Land


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Total Area: 1,559.1 m² (About)

1:500

@A4

For Identification Only	Drawing No.:
Date: 16 September 2024	2-01

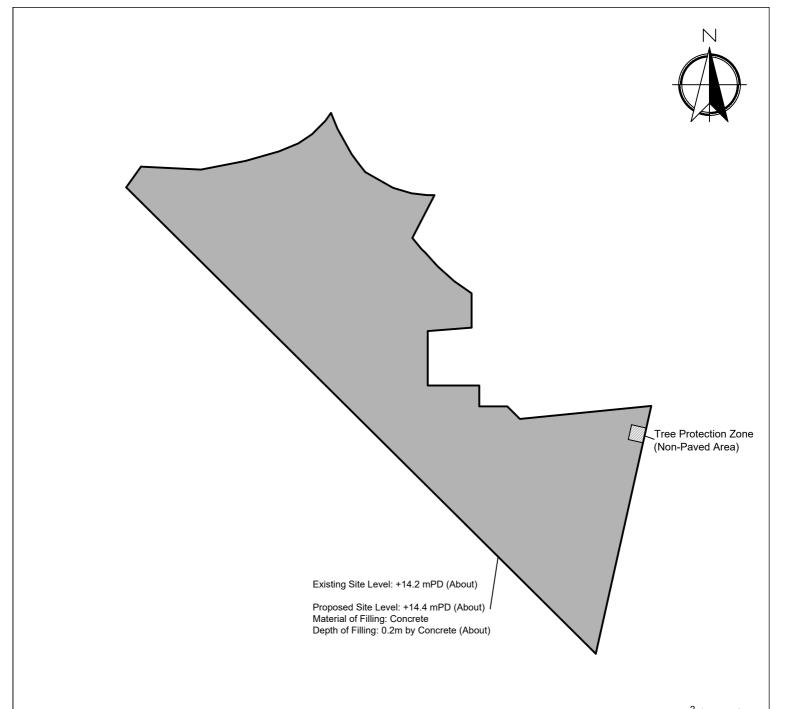

Total Area: 1,559.1 m² (About)
Paved Area: 1,555.1 m² (About)
Non-Paved Area: 4 m² (About)

Legend:

Paved Area 平整範圍

Non-Paved Area 不平整範圍

Appendix 4

Location: DD 107 Lot 1247 (Part), 1248 (Part), 1249 (Part), 1252 (Part) and 1253 (Part)

and 1253 (Part)

OZP: S/YL-KTN/11 District: Kam Tin North Zoning: Agriculture

Date: 15 September 2024

Paved Area

平整位置圖

擬議臨時露天存放建築機械及物料 (為期3年)及填土

Proposed Temporary Open Storage of Construction Machinery and Materials For a Period of 3 Years and Filling of Land


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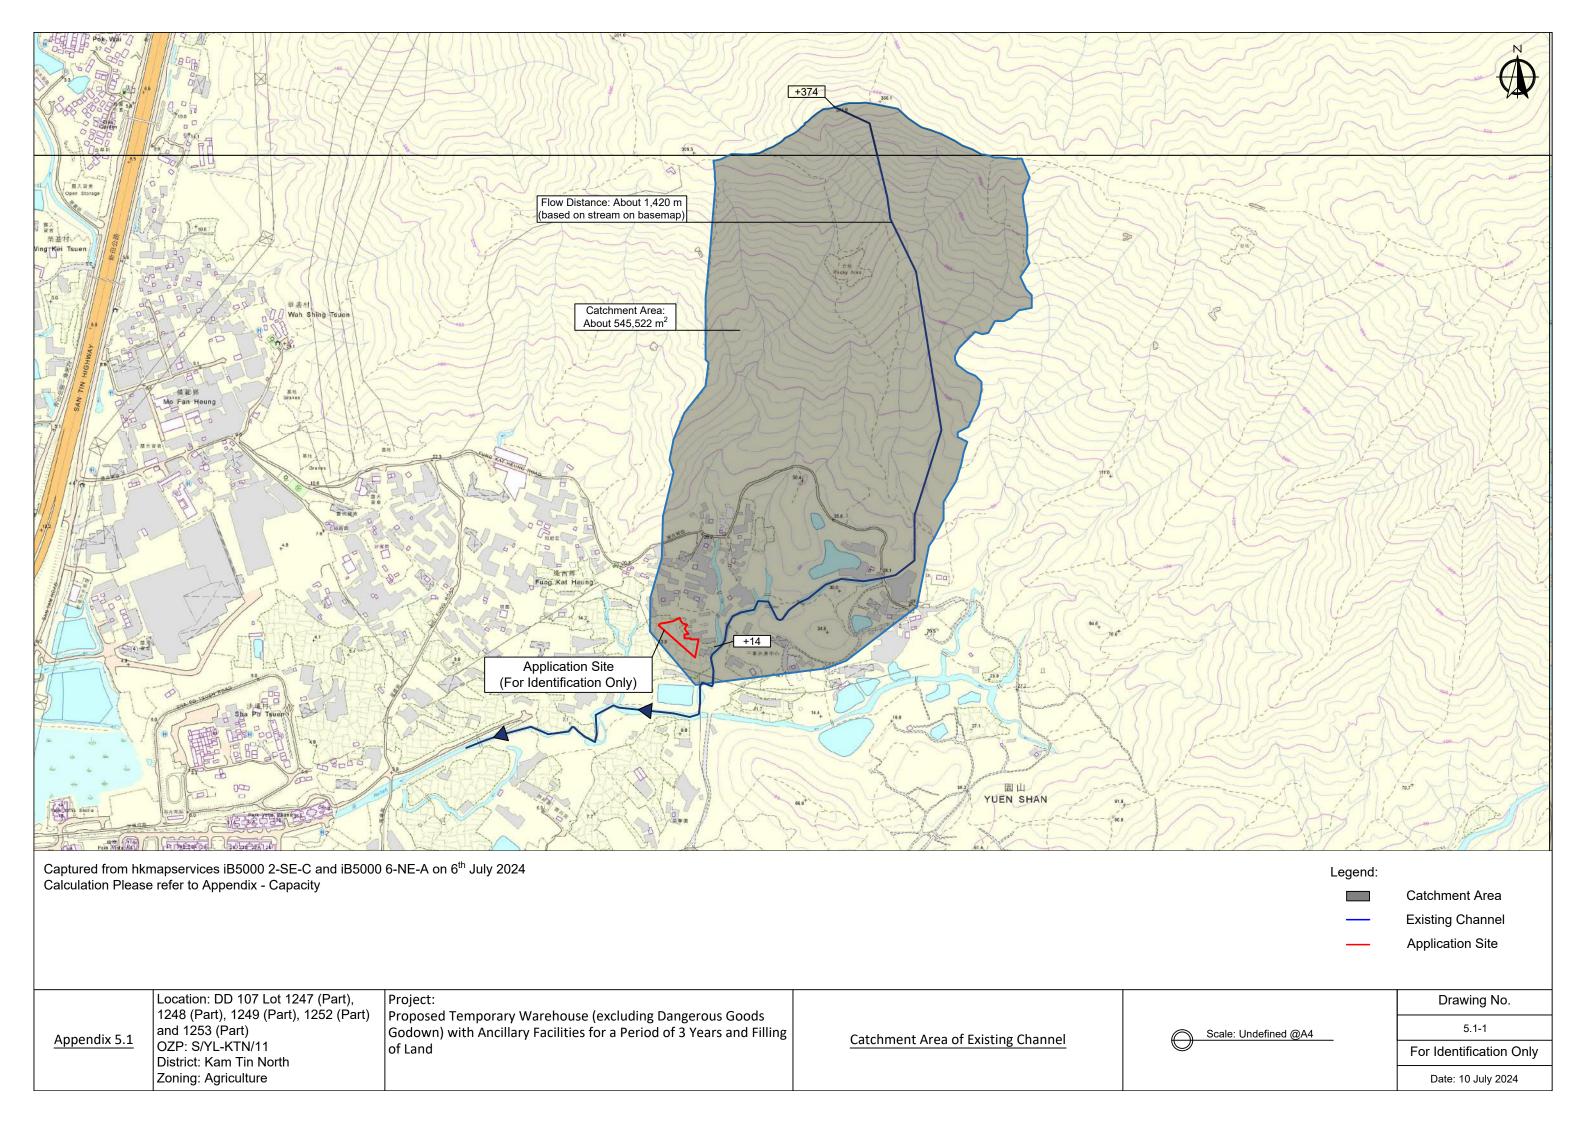
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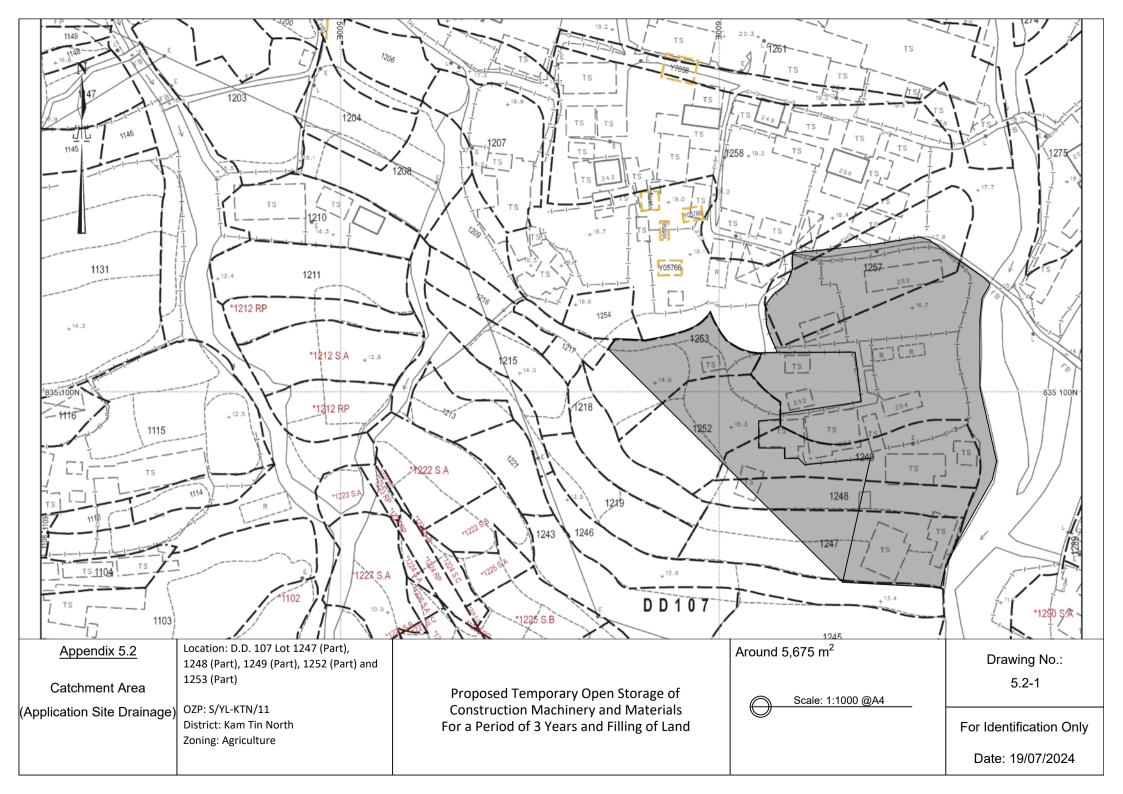
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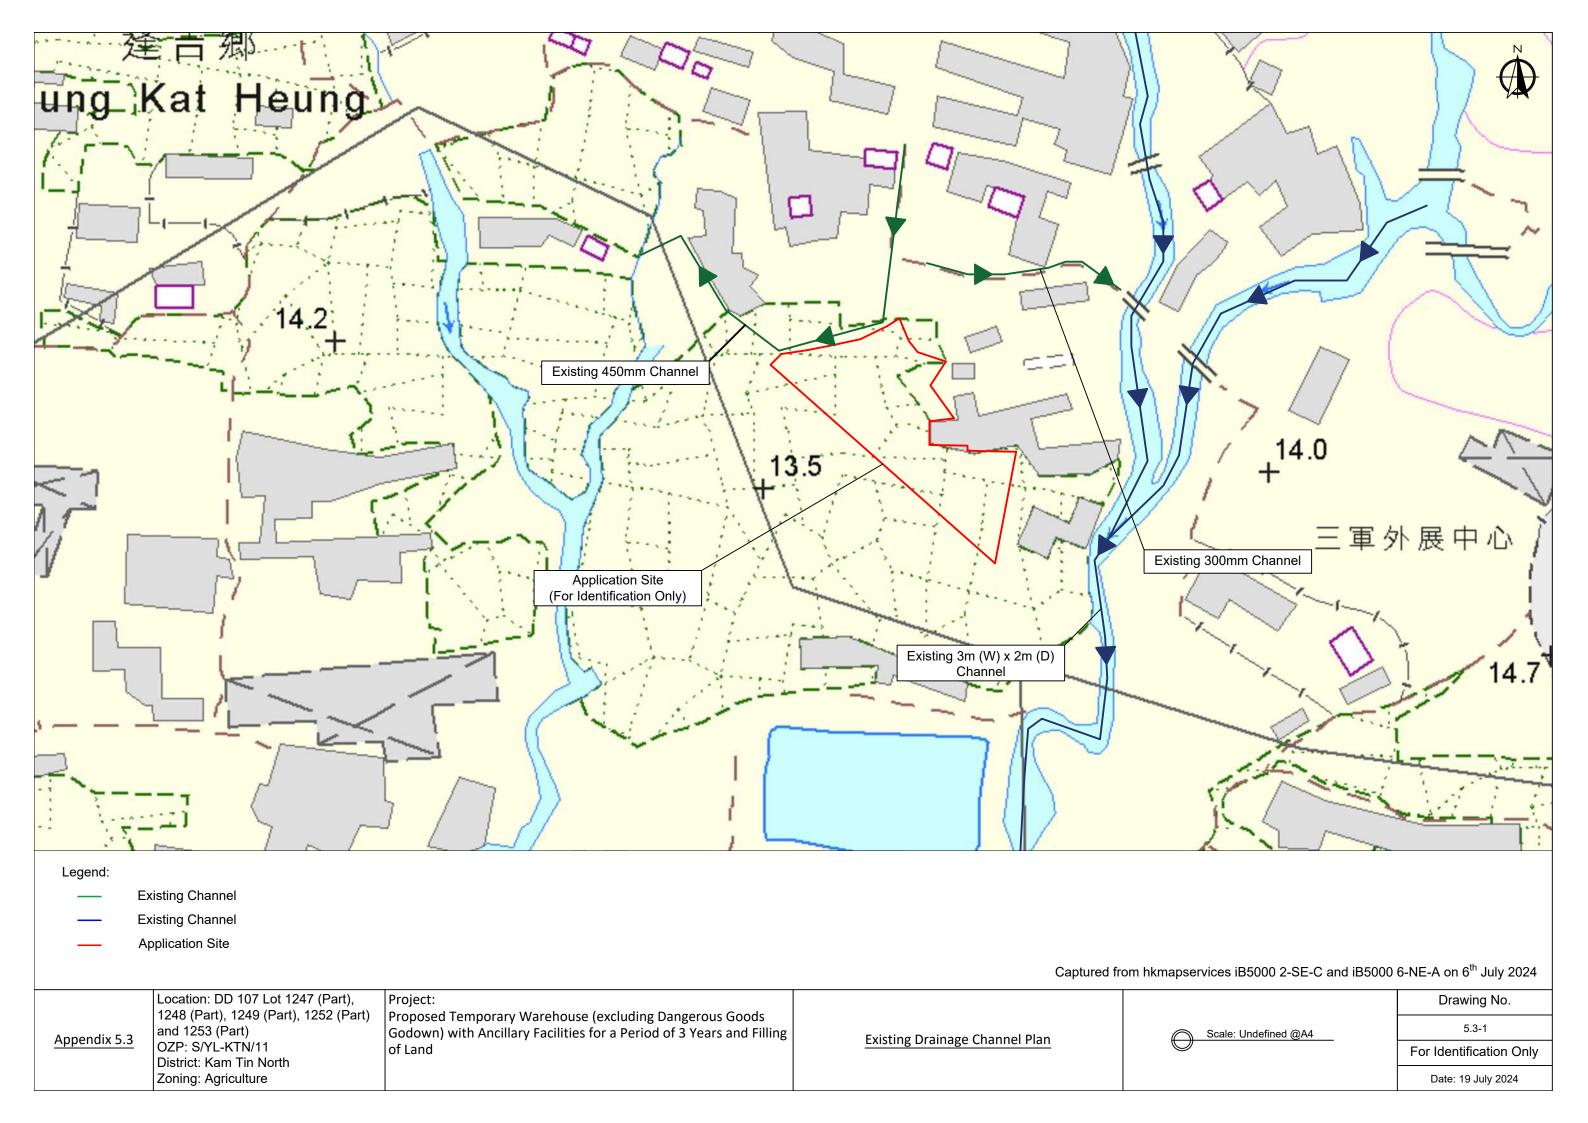
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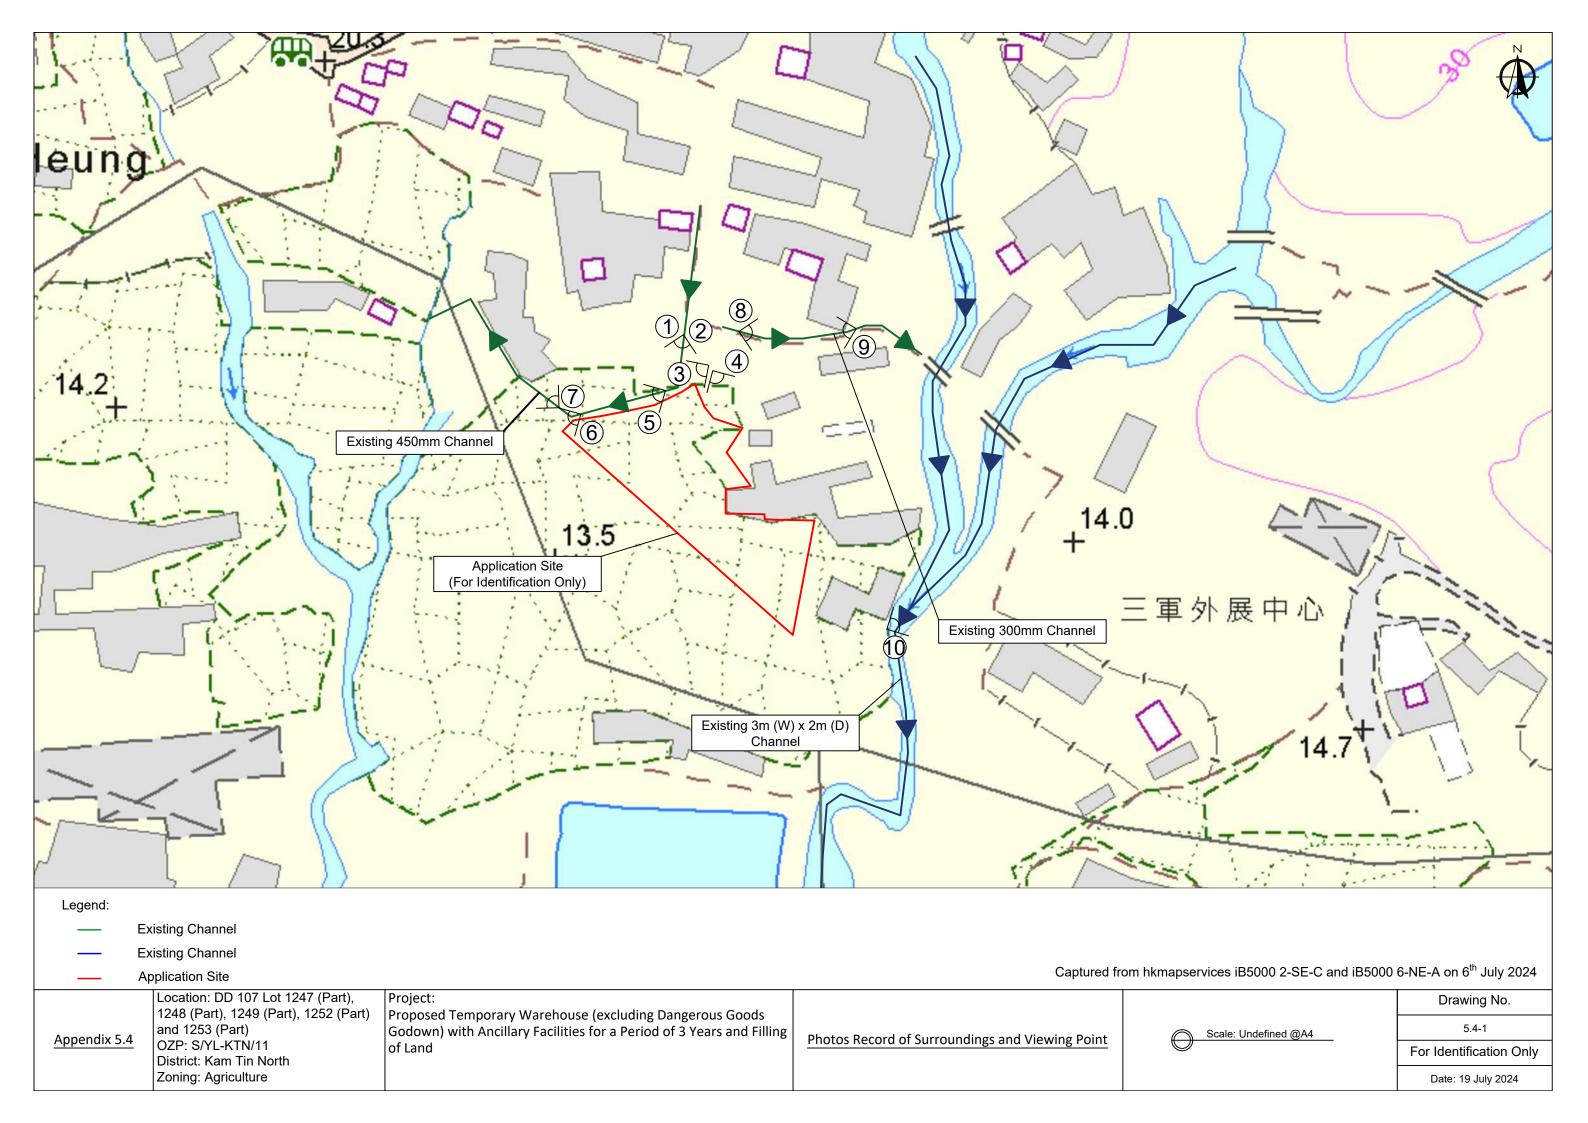
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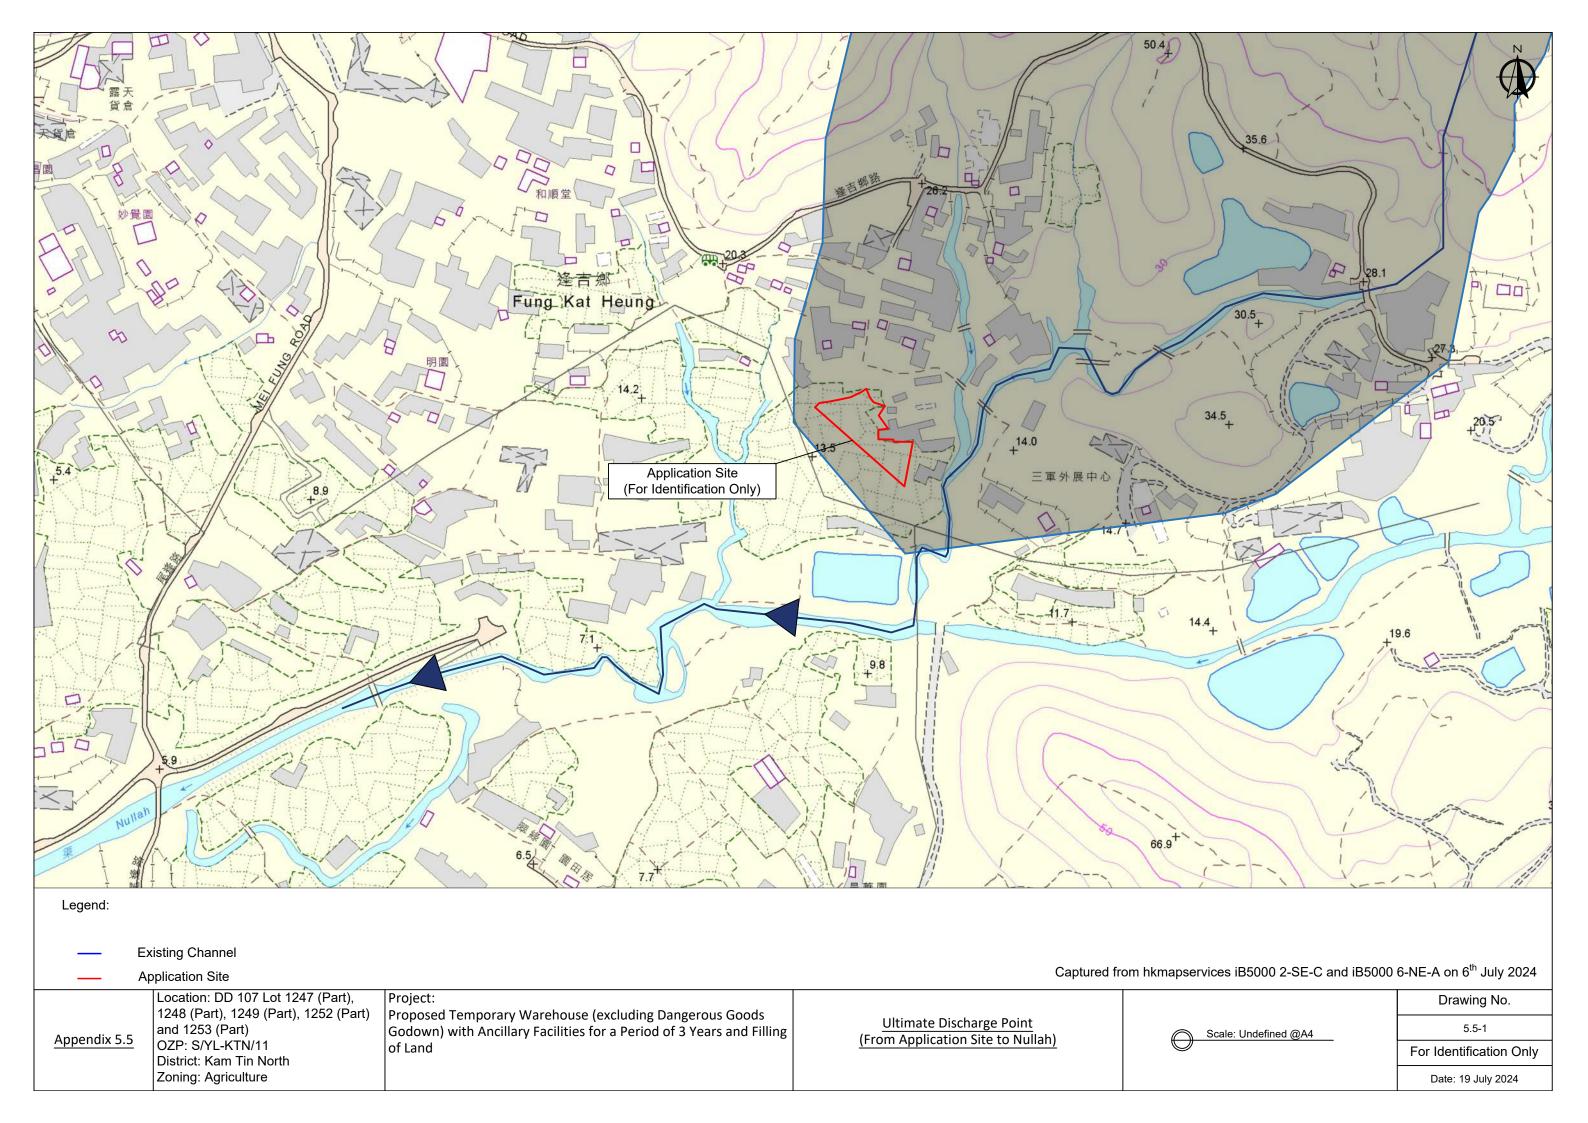










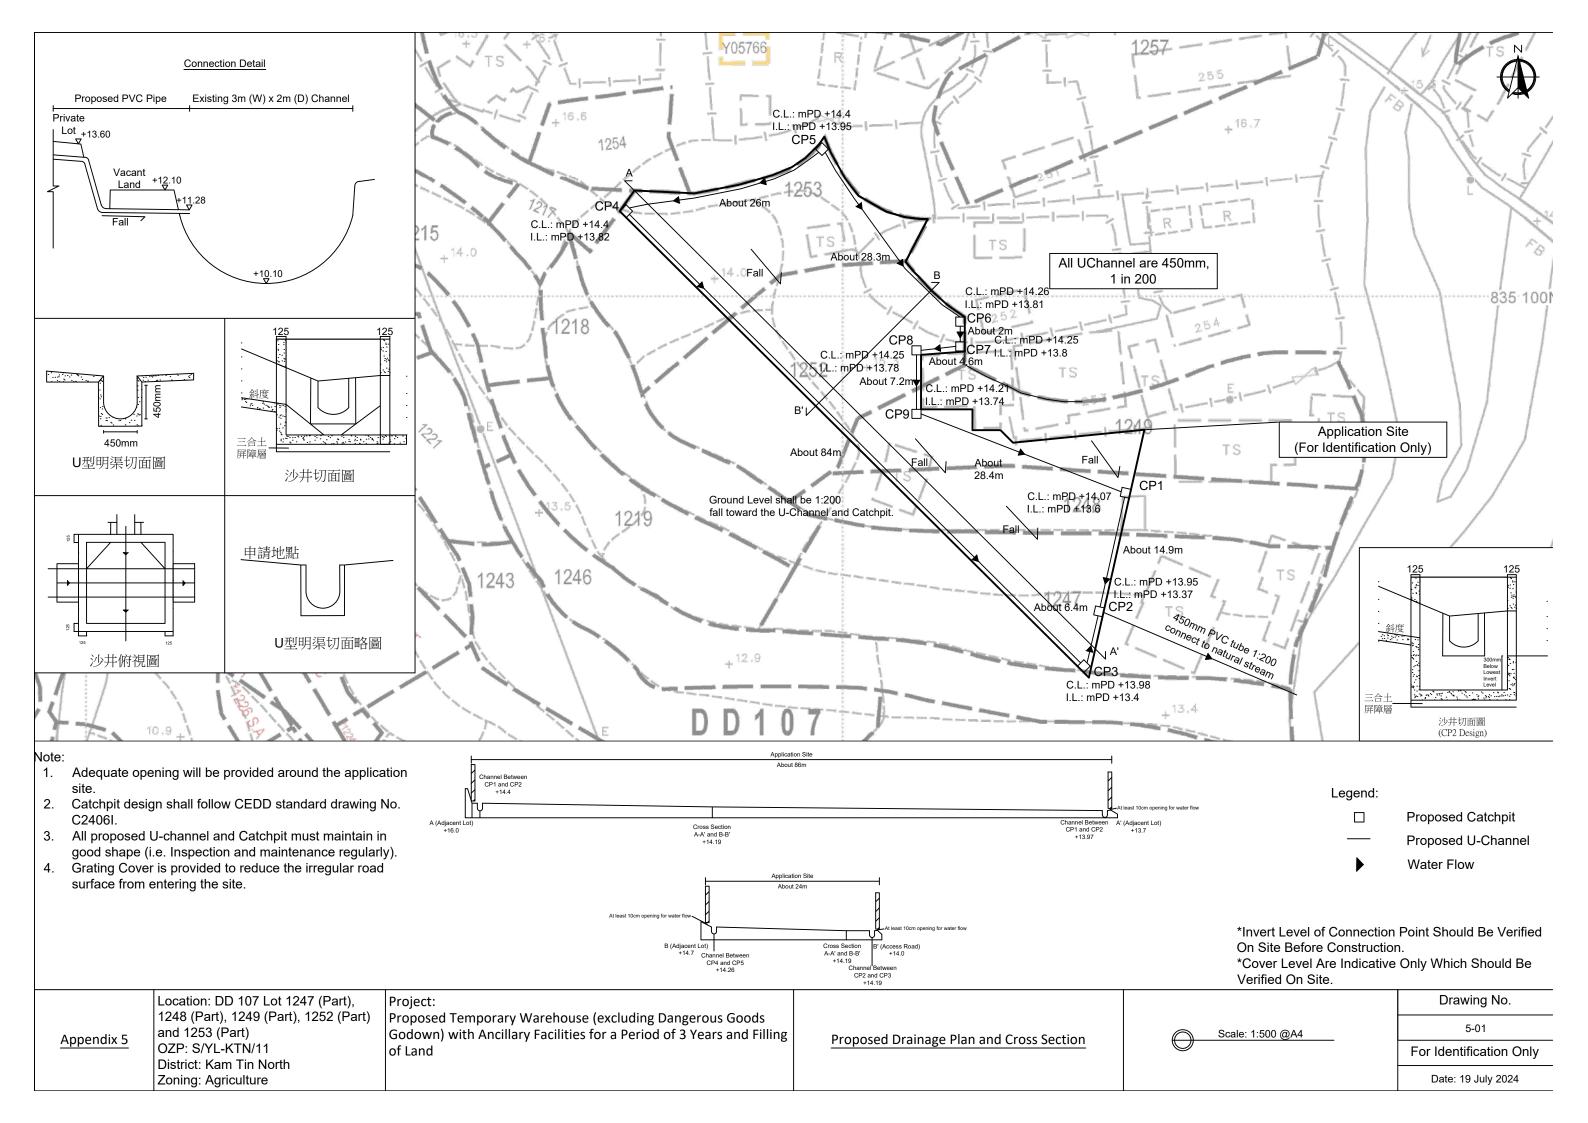

現場相片
















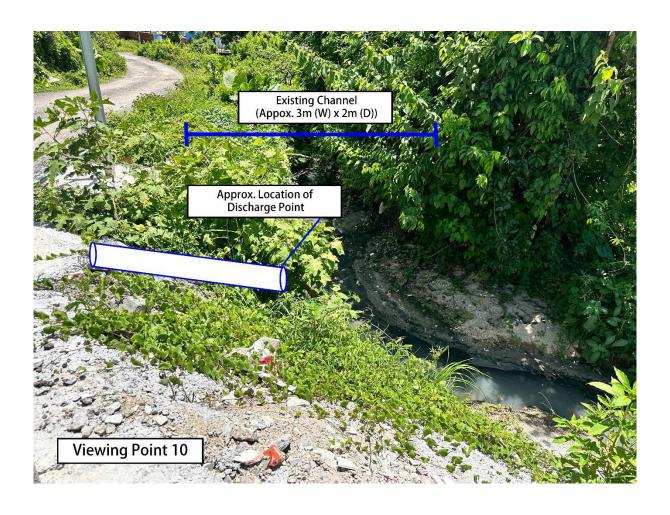

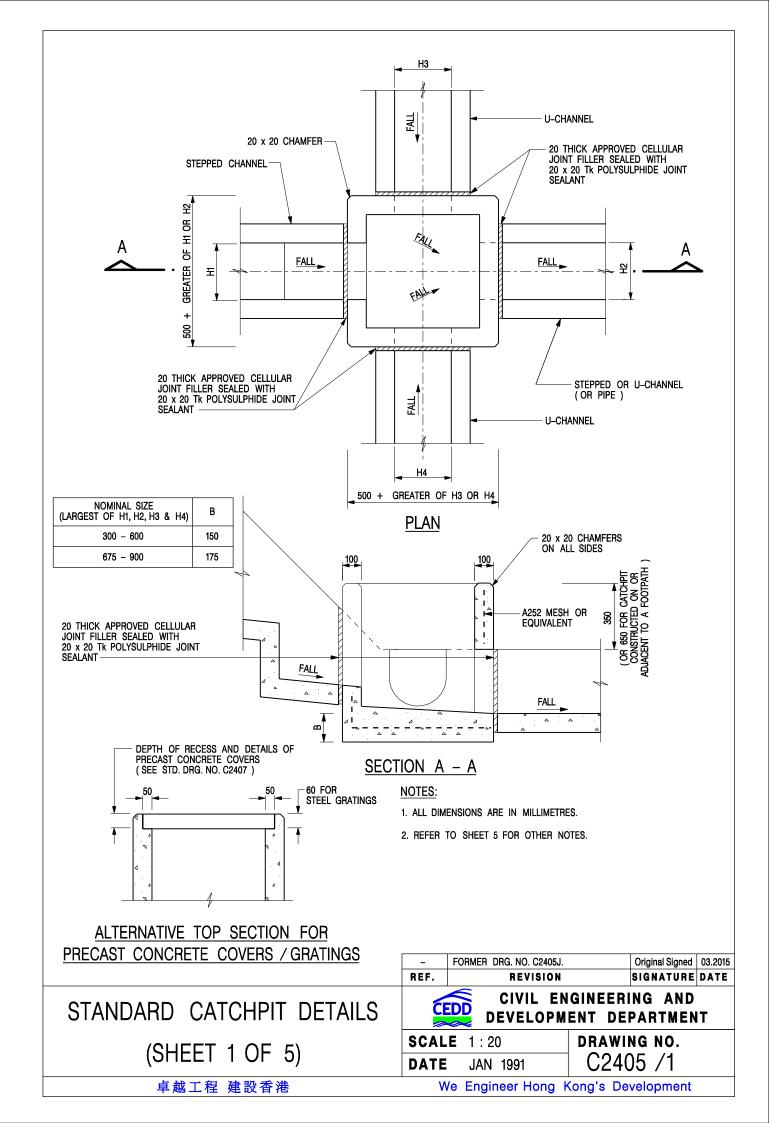

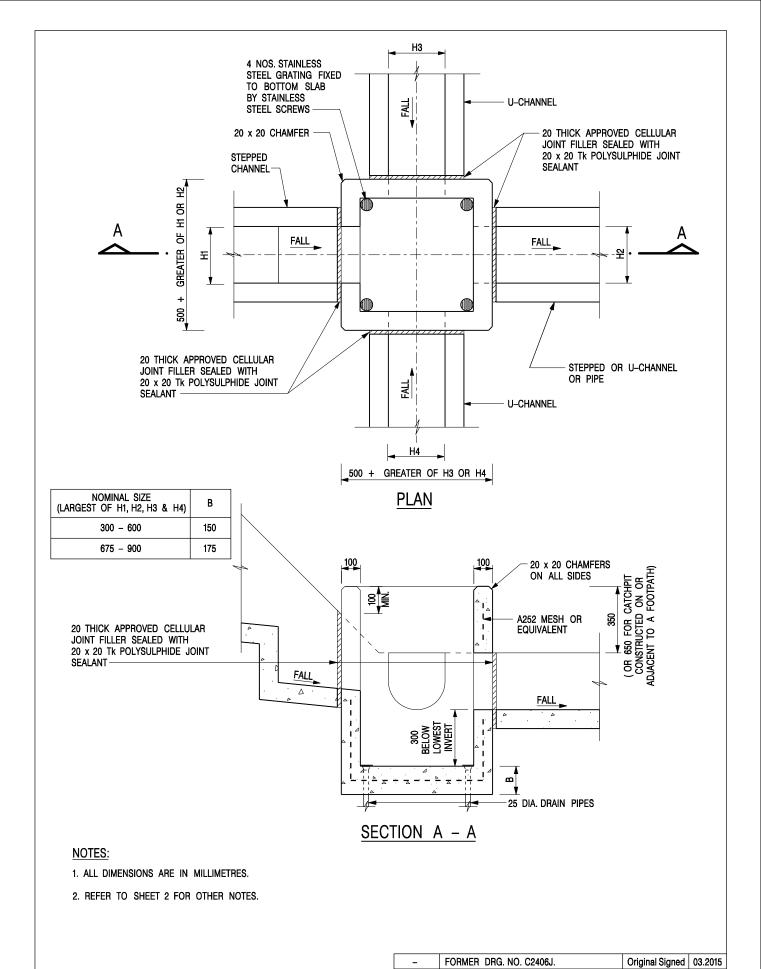

CATCHPIT WITH TRAP (SHEET 1 OF 2)

DEVELOPMENT DEPARTMENT SCALE 1:20

JAN 1991

REVISION

REF.

DATE


CEDD

DRAWING NO. C2406 /1

CIVIL ENGINEERING AND

SIGNATURE DATE

卓越工程 建設香港

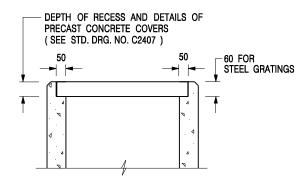

ALTERNATIVE TOP SECTION FOR PRECAST CONCRETE COVERS / GRATINGS

NOTES:

- 1. ALL DIMENSIONS ARE IN MILLIMETRES.
- 2. ALL CONCRETE SHALL BE GRADE 20 /20.
- 3. CONCRETE SURFACE FINISH SHALL BE CLASS U2 OR F2 AS APPROPRIATE.
- 4. FOR DETAILS OF JOINT, REFER TO STD. DRG. NO. C2413.
- 5. CONCRETE TO BE COLOURED AS SPECIFIED.
- UNLESS REQUESTED BY THE MAINTENANCE PARTY AND AS DIRECTED BY THE ENGINEER, CATCHPIT WITH TRAP IS NORMALLY NOT PREFERRED DUE TO PONDING PROBLEM.
- 7. UPON THE REQUEST FROM MAINTENANCE PARTY, DRAIN PIPES AT CATCHPIT BASE CAN BE USED BUT THIS IS FOR CATCHPITS LOCATED AT SLOPE TOE ONLY AND AS DIRECTED BY THE ENGINEER.
- FOR CATCHPITS CONSTRUCTED ON OR ADJACENT TO A FOOTPATH, STEEL GRATINGS (SEE DETAIL 'A' ON STD. DRG. NO. C2405 /2) OR CONCRETE COVERS (SEE STD. DRG. NO. C2407) SHALL BE PROVIDED AS DIRECTED BY THE ENGINEER.
- 9. IF INSTRUCTED BY THE ENGINEER, HANDRAILING (SEE DETAIL 'J' ON STD. DRG. NO. C2405 /5; EXCEPT ON THE UPSLOPE SIDE) IN LIEU OF STEEL GRATINGS OR CONCRETE COVERS CAN BE ACCEPTED AS AN ALTERNATIVE SAFETY MEASURE FOR CATCHPITS NOT ON A FOOTPATH NOR ADJACENT TO IT. TOP OF THE HANDRAILING SHALL BE 1 000 mm MIN. MEASURED FROM THE ADJACENT GROUND LEVEL.
- 10. MINIMUM INTERNAL CATCHPIT WIDTH SHALL BE 1 000 mm FOR CATCHPITS WITH A HEIGHT EXCEEDING 1 000 mm MEASURED FROM THE INVERT LEVEL TO THE ADJACENT GROUND LEVEL. AND, STEP IRONS (SEE DSD STD. DRG. NO. DS1043) AT 300 c/c STAGGERED SHALL BE PROVIDED. THICKNESS OF CATCHPIT WALL FOR INSTALLATION OF STEP IRONS SHALL BE INCREASED TO 150 mm.
- 11. FOR RETROFITTING AN EXISTING CATCHPIT WITH STEEL GRATING, SEE DETAIL 'G' ON STD. DRG. NO. C2405 /4.
- SUBJECT TO THE APPROVAL OF THE ENGINEER, OTHER MATERIALS CAN ALSO BE USED AS COVERS / GRATINGS.

Α	MINOR AMENDMENT.	Original Signed	04.2016
-	FORMER DRG. NO. C2406J.	Original Signed	03.2015
REF.	REVISION	SIGNATURE	DATE

CATCHPIT WITH TRAP (SHEET 2 OF 2)


卓越工程 建設香港



CIVIL ENGINEERING AND DEVELOPMENT DEPARTMENT

SCALE 1:20 **DATE** JAN 1991

DRAWING NO. C2406 /2A

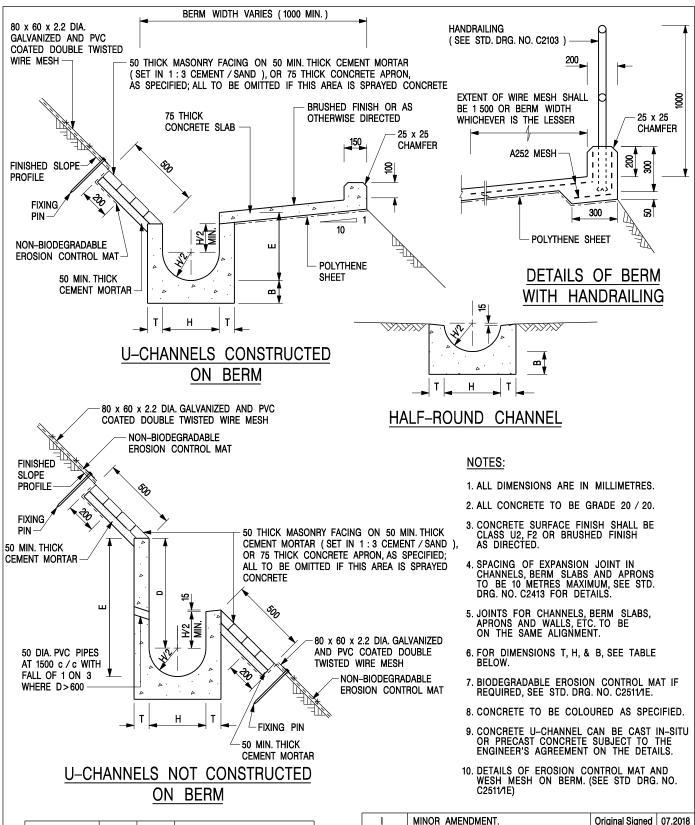

NOMINAL SIZE H	Т	В	REINFORCEMENT
300	80	100	A252 MESH PLACED CENTRALLY AND T=100
375 - 600	100	150	WHEN E>650
675 – 900	125	175	A252 MESH PLACED CENTRALLY

DETAILS	OF HAI	_F_ROUND	
	•		
AND U-CH	IANNELS	(TYPE A	_
		•	
WIIH M	ASONRY	APRON)	


		•	•
REF.	REVISION	SIGNATURE	DATE
В	MINOR AMENDMENTS.	Original Signed	3.94
С	150 x 100 UPSTAND ADDED AT BERM.	Original Signed	6.99
D	MINOR AMENDMENT.	Original Signed	08.2001
E	DRAWING TITLE AMENDED.	Original Signed	11.2001
F	GENERAL REVISION.	Original Signed	12.2002
G	MINOR AMENDMENT.	Original Signed	01.2004
Н	THICKNESS OF MASONRY FACING AMENDED.	Original Signed	01.2005
	MINOR AMENDMENT.	Original Signed	07.2018




CIVIL ENGINEERING AND **DEVELOPMENT DEPARTMENT**

DRAWING NO. SCALE 1:25 C24091 DATE JAN 1991

卓越工程 建設香港

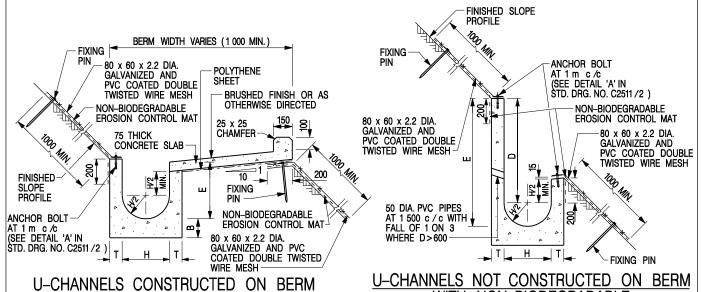

U-CHANNELS CONSTRUCTED ON BERM WITH NON-BIODEGRADABLE EROSION CONTROL MAT <u>U-CHANNELS NOT CONSTRUCTED ON BERM WITH NON-BIODEGRADABLE EROSION CONTROL MAT</u>

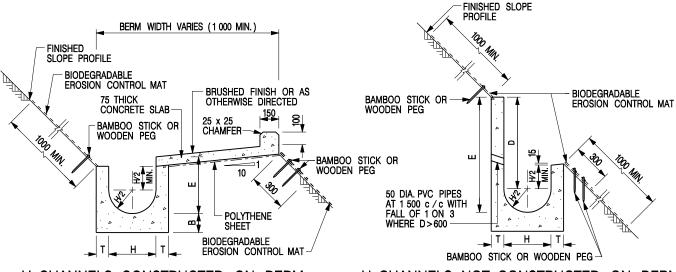

U-CHANNELS CONSTRUCTED ON BERM
WITH BIODEGRADABLE
EROSION CONTROL MAT

U-CHANNELS NOT CONSTRUCTED ON BERM WITH BIODEGRADABLE EROSION CONTROL MAT

NOTES:

- 1. ALL DIMENSIONS ARE IN MILLIMETRES.
- 2. ALL CONCRETE TO BE GRADE 20 /20.
- 3. CONCRETE SURFACE FINISH SHALL BE CLASS U2, F2 OR BRUSHED FINISH AS DIRECTED.
- 4. SPACING OF EXPANSION JOINT IN CHANNELS, BERM SLABS AND APRONS TO BE 10 METRES MAXIMUM, SEE STD. DRG. NO. C2413 FOR DETAILS.
- 5. JOINTS FOR CHANNELS, BERM SLABS, APRONS AND WALLS, ETC. TO BE ON THE SAME ALIGNMENT.
- 6. FOR DIMENSIONS T, H, & B, SEE TABLE BELOW.
- FOR TYPICAL FIXING PIN DETAILS, SEE STD. DRG. NO. C2511/2.
- 8. MINIMUM SIZE OF 25 x 50 x 300mm SHALL BE PROVIDED FOR WOODEN PEG.
- MINIMUM SIZE OF 10mm DIAMETER WITH 200mm LONG SHALL BE PROVIDED FOR BAMBOO STICK.
- 10. THE FIXING DETAILS OF NON-BIODEGRADABLE AND BIODEGRADABLE EROSION CONTROL MATS ON EXISTING BERM SHALL REFER TO STD. DRG. NO. C2511/1.

NOMINAL SIZE H	Т	В	REINFORCEMENT
300	80	100	A252 MESH PLACED CENTRALLY AND T=100
375 - 600	100	150	WHEN E>650
675 - 900	125	175	A252 MESH PLACED CENTRALLY

	675 - 900	125	175	A252 MESH CENTRALLY	l PLA	CED		
_				<u> </u>	<u> </u>			
L	DETAILS	O٢	· H	ALF-K(JU	ΝD	Α	ND
	U-CHAN	INE	LS	(TYPE	В	_	WI	TH

REF.	REVISION	SIGNATURE	DATE
Α	MINOR AMENDMENT.	Original Signed	10.92
В	MINOR AMENDMENT.	Original Signed	3.94
С	150 x 100 UPSTAND ADDED AT BERM.	Original Signed	6.99
D	MINOR AMENDMENT.	Original Signed	08.2001
E	GENERAL REVISION.	Original Signed	12.2002
F	MINOR AMENDMENT.	Original Signed	01.2004
G	DIMENSION TABLE AMENDED.	Original Signed	01.2005
н	FIXING DETAILS OF BIODEGRADABLE EROSION CONTROL MAT ADDED.	Original Signed	12.2017
I	MINOR AMENDMENT.	Original Signed	07.2018



CIVIL ENGINEERING AND DEVELOPMENT DEPARTMENT


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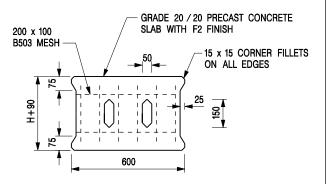
DATE JAN 1991

DRAWING NO. C24101

卓越工程 建設香港

EROSION CONTROL MAT APRON)



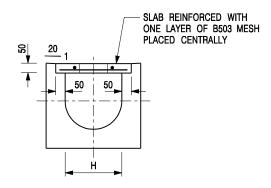



TYPICAL SECTION

PLAN OF SLAB

U-CHANNELS WITH PRECAST CONCRETE SLABS

(UP TO H OF 525)

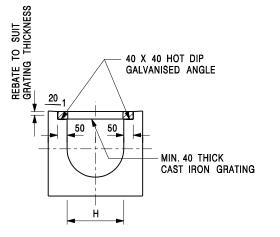

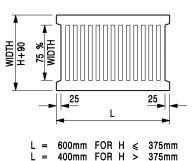

TYPICAL SECTION

CAST IRON GRATING

(DIMENSIONS ARE FOR GUIDANCE ONLY, CONTRACTOR MAY SUBMIT EQUIVALENT TYPE)

U-CHANNEL WITH CAST IRON GRATING

(UP TO H OF 525)

NOTES:

- 1. ALL DIMENSIONS ARE IN MILLIMETRES.
- 2. H=NOMINAL CHANNEL SIZE.
- 3. ALL CAST IRON FOR GRATINGS SHALL BE GRADE EN-GJL-150 COMPLYING WITH BS EN 1561.
- 4. FOR COVERED CHANNELS TO BE HANDED OVER TO HIGHWAYS DEPARTMENT FOR MAINTENANCE, THE GRATING DETAILS SHALL FOLLOW THOSE AS SHOWN ON HyD STD. DRG. NO. H3156.

Е	NOTES 3 & 4 AMENDED.	Original Signed	12.2014
D	NOTE 4 ADDED.	Original Signed	06.2008
С	MINOR AMENDMENT. NOTE 3 ADDED.	Original Signed	12.2005
В	NAME OF DEPARTMENT AMENDED.	Original Signed	01.2005
Α	CAST IRON GRATING AMENDED.	Original Signed	12.2002
REF.	REVISION	SIGNATURE	DATE

COVER SLAB AND CAST IRON GRATING FOR CHANNELS



CIVIL ENGINEERING AND DEVELOPMENT DEPARTMENT

 SCALE
 1:20
 DRAWING NO.

 DATE
 JAN 1991
 C2412E

卓越工程 建設香港 We Engineer Hong Kong's Development

Table 3a – Storm Constants for Different Return Periods of HKO Headquarters

Return Period T (years)	2	5	10	20	50	100	200	500	1000
a	499.8	480.2	471.9	463.6	451.3	440.8	429.5	414.0	402.1
b	4.26	3.36	3.02	2.76	2.46	2.26	2.05	1.77	1.55
С	0.494	0.429	0.397	0.369	0.337	0.316	0.295	0.269	0.251

Table 3b – Storm Constants for Different Return Periods of Tai Mo Shan Area

Return Period T (years)	2	5	10	20	50	100	200
a	1743.9	2183.2	2251.3	2159.2	1740.1	1307.3	1005.0
b	22.12	27.12	27.46	25.79	19.78	12.85	7.01
С	0.694	0.682	0.661	0.633	0.570	0.501	0.434

Table 3c – Storm Constants for Different Return Periods of West Lantau Area

Return Period T (years)	2	5	10	20	50	100	200
a	2047.9	1994.1	1735.2	1445.6	1107.2	909.1	761.8
b	24.27	24.23	21.82	18.36	13.01	8.98	5.40
С	0.733	0.673	0.619	0.561	0.484	0.428	0.377

Table 3d – Storm Constants for Different Return Periods of North District Area

Return Period T (years)	2	5	10	20	50	100	200
a	1004.5	1112.2	1157.7	1178.6	1167.6	1131.2	1074.8
b	17.24	18.86	19.04	18.49	16.76	14.82	12.47
С	0.644	0.614	0.597	0.582	0.561	0.543	0.523

Table 13 - Values of n to be used with the Manning equation

Source: Brater, E.F. & King, H.W. (1976)

Surface	Best	Good	Fair	Bad
Uncoated cast-iron pipe	0.012	0.013	0.014	0.015
Coated cast-iron pipe	0.011	0.012*	0.013*	
Commercial wrought-iron pipe, black	0.012	0.013	0.014	0.015
Commercial wrought-iron pipe, galvanized	0.013	0.014	0.015	0.017
Smooth brass and glass pipe	0.009	0.010	0.011	0.013
Smooth lockbar and welded "OD" pipe	0.010	0.011*	0.013*	
Riveted and spiral steel pipe	0.013	0.015*	0.017*	
Vitrified sewer pipe	0.010	0.013*	0.015	0.017
Common clay drainage tile	0.011	0.012*	0.014*	0.017
Glazed brickwork	0.011	0.012	0.013*	0.015
Brick in cement mortar; brick sewers	0.012	0.013	0.015*	0.017
Neat cement surfaces	0.010	0.011	0.012	0.013
Cement mortar surfaces	0.011	0.012	0.013*	0.015
Concrete pipe	0.012	0.013	0.015*	0.016
Wood stave pipe	0.010	0.011	0.012	0.013
Plank flumes - Planed	0.010	0.012*	0.013	0.014
- Unplaned	0.011	0.013*	0.014	0.015
- With battens	0.012	0.015*	0.016	
Concrete-lined channels	0.012	0.014*	0.016*	0.018
Cement-rubble surface	0.017	0.020	0.025	0.030
Dry-rubble surface	0.025	0.030	0.033	0.035
Dressed-ashlar surface	0.013	0.014	0.015	0.017
Semicircular metal flumes, smooth	0.011	0.012	0.013	0.015
Semicircular metal flumes, corrugated	0.0225	0.025	0.0275	0.030
Canals and ditches				
1. Earth, straight and uniform	0.017	0.020	0.0225*	0.025
2. Rock cuts, smooth and uniform	0.025	0.030	0.033*	0.035
3. Rock cuts, jagged and irregular	0.035	0.040	0.045	
4. Winding sluggish canals	0.0225	0.025*	0.0275	0.030
5. Dredged-earth channels	0.025	0.0275*	0.030	0.033
6. Canals with rough stony beds, weeds on earth banks	0.025	0.030	0.035*	0.040
7. Earth bottom, rubble sides	0.028	0.030*	0.033*	0.035
Natural-stream channels				
1. Clean, straight bank, full stage, no rifts or deep pools	0.025	0.0275	0.030	0.033
2. Same as (1) but some weeds and stones	0.030	0.033	0.035	0.040
3. Winding some pools and shoals, clean	0.033	0.035	0.040	0.045
4. Same as (3), lower stages, more ineffective slope and sections	0.040	0.045	0.050	0.055

Table 13 (Cont'd)


Surface	Best	Good	Fair	Bad
5. Same as (3) some weeds and stones	0.035	0.040	0.045	0.050
6. Same as (4) stony sections	0.045	0.050	0.055	0.060
7. Sluggish river reach, rather weedy or with very deep pools	0.050	0.060	0.070	0.080
8. Very weedy reaches	0.075	0.100	0.125	0.150

Notes: *Values commonly used for design.

LGV L/UL Space Dimension: 7m x 3.5m

Unit(s): 2



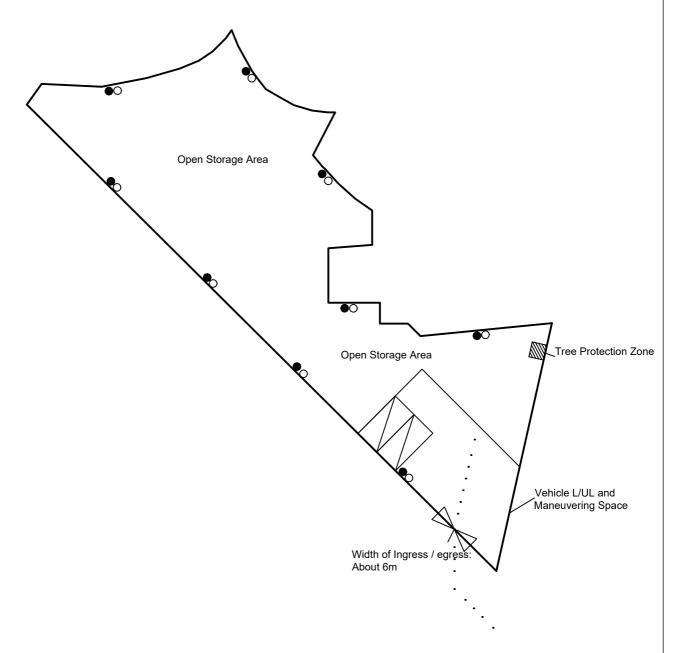

- *All FSI (includes installation/maintenance/modification/repair work) will be completed by RFSIC. For Emergency Vehicular Access, Please see Appendix 6.1
- * All Internal Access for Fire Appliances are within 4.5m
- * There will be clear width with 2m between the storage and lot boundaries.

Legend:

- O 5 kg Portable Carbon Dioxide Type Fire Extinguisher (9 in Total)
- 9 kg Portable Water Type Fire Extinguisher (9 in Total)
- · · · Emergency Vehicular Access

Appendix 6

Location: DD 107 Lot 1247 (Part), 1248 (Part), 1249 (Part), 1252 (Part)

and 1253 (Part)

App. No.: A/YL-KTN/1018

OZP: S/YL-KTN/11 District: Kam Tin North Zoning: Agriculture Date: 11 September 2024

Proposed Fire Service Installation Plan

擬議消防設備安裝計劃圖

擬議臨時露天存放建築機械及物料 (為期3年)及填土

Proposed Temporary Open Storage of Construction Machinery and Materials For a Period of 3 Years and Filling of Land

SCALE

1:500

@A4

For Identification Only

Drawing No.:



The Fire Hydrant No. 12103 is within 500m of the application site.



Scale: Undefined @A4

Captured from map.gov.hk on 25th April 2024

Appendix 6.1

Location: D.D. 107 Lot 1247 (Part), 1248 (Part), 1249

(Part), 1252 (Part) and 1253 (Part)

Emergency Vehicular Access

OZP: S/YL-KTN/11 District: Kam Tin North Zoning: Agriculture Proposed Temporary Open Storage of Construction Machinery and Materials For a Period of 3 Years and Filling of Land Width of Shui Mei Road: 3-6m (About)
Map Legend:

•••• Ro

Road PathSite Boundary

Drawing No.: 6.1-1

For Identification Only

Date: 11/09/2024

Appendix Ib of RNTPC Paper No. A/YL-KTN/1018B

寄件日期:	2025年01月06日星期一 12:17
收件者:	tpbpd/PLAND
Subject: Do: S. 16 Dlanning Appli	cation no. A/YL-KTN/1018 - Departmental Comments
Subject: Re: 5. 16 Planning Applic	Lation no. A) ft-kiny 1018 - Departmental Comments
Thank you for the phone or	all and email. Plesae see the attachment section for the updated
	u have any question regarding to the application, please do not hesitate
to contact Mr. Tang on pho	
Your sincerely,	
Mr. Tang	
	從 iCloud 下載
	AYL-KTN 10···250106.pdf
	24.8 MB

城市規劃委員會:

有關城市規劃委員會對 A/YL-KTN/1018 的查詢

收悉 貴委員會對 A/YL-KTN/1018 申請的疑問,本人現書面回覆。

申請範圍方面,本申請與舊有 A/YL-KTN/962 的申請有關連,現時申請的範圍比 A/YL-KTN/962 大,因為上次申請時未能向業主承租現時全部申請範圍,現已向相關持分者承租相關範圍,因此已即時向 貴委員會提出新申請,以符合相關條例。

此外,履行附加條件方面,上次申請 A/YL-KTN/962 亦因申請範圍方面 未能如期達成所以附加條件,本申請已向相關部門提供渠務報告及安裝消防系 統建議書,申請地點現時亦放置了防火筒 (講參考 FS251 證書),望 貴委員 會諒解。

申請理由是因城市高速發展及土地資源稀少的情況下,有大量用作工業 及棕地的土地已改作其他發展或計劃用作其他發展,例如錦田北分區計劃大綱 核准圖編號 S/YL-KTN/11 內部份模範鄉至部份逢吉鄉由農業及工業用途外劃 為住宅及政府、機構或社區」用途、洪水橋/厦村新發展區及鄰近元朗工業邨的 棕地等,存放的需求大大增加。因此,本人希望能透過規劃申請,提供臨時土 地收納及滿足需要搬遷的小型露天存放。


存放高度最高不超過 6 米。現場會存放小型機械及水電工程所包含的工程材料,例如排水管、水喉及電箱、挖掘機、升降台等。物料大小及長度不一,最長約 4.5 米。

本申請只會用在存放用途,不會進行任何有關回收、清潔、修理、拆解或其他工場作業。

LGV L/UL Space Dimension: 7m x 3.5m

Unit(s): 2



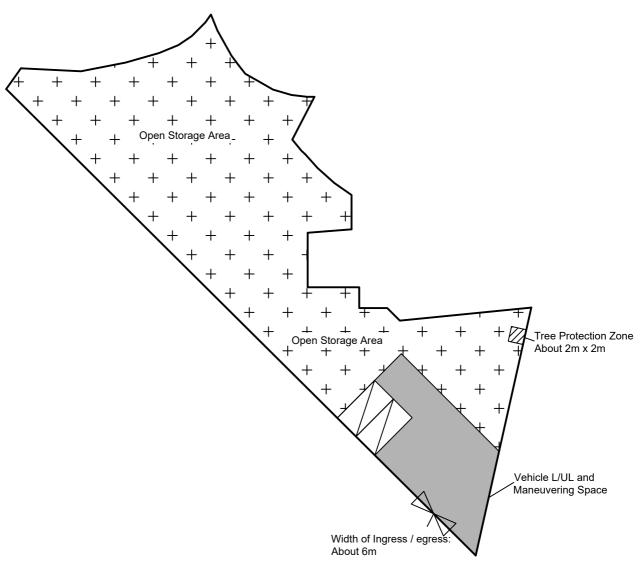

Legend:

∠ LGV L/UL Space (Unit(s): 2)

Maneuvering Space

Open Storage Area

Vehicle Maneuvering Space

Tree Protection Zone

Total Area: 1,559.1 m² (About)

Open Storage Area: 1,291.1 m² (About)

Vehicle Maneuvering Space: 264 m² (About)

Tree Protection Zone: 4 m² (About)

Appendix 2

Location: DD 107 Lot 1247 (Part), 1248 (Part), 1249 (Part), 1252 (Part)

and 1253 (Part)

OZP: S/YL-KTN/11 District: Kam Tin North Zoning: Agriculture Proposed Layout Plan 擬議佈局平面圖

擬議臨時露天存放建築機械及物料 (為期3年)及填土

Proposed Temporary Open Storage of Construction Machinery and Materials For a Period of 3 Years and Filling of Land

SCM	
SUAL	

1:500

@A4

For Identification Only	Drawing No.:
Date: 6 January 2025	2-02

申請範圍約 1,559.1 平方米,當中有約 268 平方米為車輛上落區、車輛轉動區及樹木保護區,上述範圍不會用在露天存放。相關圖則請參考 Appendix 2 (2-02)。

希望此附加文件能釋除 貴署的隱憂,並支持本申請。

城市設計及園境組及城市規劃委員會:

有關城市設計及園境組對 A/YL-KTN/1018 的查詢

收悉 貴組對 A/YL-KTN/1018 申請的疑問,本人現書面回覆。

保護樹木方面,會將樹幹 2 米範圍內的混凝土打碎並運走,亦會在該範圍邊豎立不少於 1.2 米高的短柱保護樹木,建立樹木保護區,保護區不會放置任何物品,以免影響樹木生長。樹木會定期檢查及修剪,保護樹木。本人為錯誤平整相關範圍致歉,望 貴組諒解。相關圖則請參考 Appendix 2 (2-01)。

希望此附加文件能釋除 貴署的隱憂,並支持本申請。

渠務署及城市規劃委員會:

A/YL-KTN/1018 的渠務報告詳細

申請地點範圍有約 1,559.1 平方米,位於錦田北的鄉郊範圍。目前為露 天空間及建有臨時建築物。

申請地點附近有大量的臨時建築物及草地。現有水平為約+14.4 mPD (此水平已完成填土及平整)。

有一條自然溪流位於申請地點的東面,並計劃將場內水流引導到該溪 流。

申請範圍的北面、西北面及東北面水平比申請地點高,有機會會有水流從這面流入,申請範圍北及西北外有約一條 450mm 及一條約 300mm 的渠道收集申請地點外的流水及引導流水,因此只有少量流水會由申請地點的東北面流入申請地點。

申請地點的擬議佈局平面圖請參考 Appendix 2。

申請地點範圍有約 1,559.1 平方米,全部將以混凝土作表面,在申請地點外有約 356 平方米,全部為道路及建築物。

擬議發展	
申請地點範圍 (約 m²),全部已以混	1,559.1
凝土平整	
申請地點外集水區	
申請地點外北面集水區 (約 m²),大	356
多為草地、道路及建築物,本報告將	
全部以凝土作評估	

本報告會使用 STORMWATER DRAINAGE MANUAL (SDM) (2018), SDM Corrigendum No. 1/2022 and 1/2024.

根據 STORMWATER DRAINAGE MANUAL (SDM) - Table 10 - Recommended Design Return Periods based on Flood Levels

Intensively Used Agricultural Land	2-5 years
Village Drainage including Internal Drainage	10 years
System under a Polder Scheme	
Main Rural Catchment Drainage Channels	50 years
Urban Drainage Trunk Systems	200 years
Urban Drainage Branch Systems	50 years

本報告將使用 Main Rural Catchment Drainage Channels, 1 in 50 years return period 作評估。

 Intensity-Duration-Frequency Relationship - The Recommended Intensity-Duration-Frequency relationship is used to estimate the intensity of rainfall. It can be expressed by the following algebraic equation.

$$i = \frac{a}{(t_d + b)^c}$$

Since the site is located within the HKO Headquarters Rainfall Zone, the value is taken from STORMWATER DRAINAGE MANUAL (SDM) (2018). Therefore, for 50 years return period, the following values are adopted.

a = 505.5

b = 3.29

c = 0.355

2. The peak runoff is calculated by the Rational Method.

$$Q_p = 0.278 \ C \ i \ A$$

where $V = peak runoff in m^3/s$

C = runoff coefficient (dimensionless)

i = rainfall intensity in mm/hr

A = catchment area in km²

3. According to Section 7.5.2(b) of the Stormwater Drainage Manual (SDM), Fifth Edition January 2018

Surface Characteristics	Runoff coefficient, C
Asphalt	0.70-0.95
Concrete	0.80-0.95
Brick	0.70-0.85
Grassland (heavy soil)	
Flat	0.13-0.25
Steep	0.25-0.35
Grassland (sandy soil)	
Flat	0.05-0.15
Steep	0.15-0.20

The run-off coefficient (C) of surface runoff area taken as follows:

4. Manning's Equation is used for calculation of velocity of flow inside the channels. It can be expressed by the following algebraic equation.

$$V = \frac{R^{1/6}}{n} \sqrt{RS_f}$$

where V = Velocity of the pipe flow (m/s)

S_f = Hydraulic gradient

n = manning's coefficient

R = Hydraulic radius (m)

5. Colebrook-White Equation is used for calculation of velocity of flow inside the pipes. It can be expressed by the following algebraic equation.

$$\bar{V} = -\sqrt{32gRS} \log \log \left(\frac{k_s}{14.8R} + \frac{1.255v}{R\sqrt{32gRS_f}} \right)$$

where V = Velocity of the pipe flow (m/s)

S_f = Hydraulic gradient

k_f = roughness value (m)

v = kinematics viscosity of fluid

D = pipe diameter (m)

R = Hydraulic radius (m)

申請範圍主要平坦,並緩緩斜向東南面,渠道設計請參考 Appendix 5。

渠道容量計算請參考 Appendix - Calculation。

根據本報告,本臨時發展不會對附近的渠道有重大影響。

R to C:

	渠務署意見	申請人回覆
(1)	The rainfall intensity is not correct. Please review	請參考 Appendix – Calculation,已修正
	the calculations.	該錯誤。
(2)	Please provide all drainage facilities and	請參考 Appendix 5.1。
	hoarding/fencing with adequate opening, if any,	
	in the section drawings.	
(3)	Please justify the proposed catchment areas. The	請參考 Appendix 5.2 及 Appendix
	catchment areas should be determined	5.3 °
	according to existing topographic levels.	
(4)	Please advise if any site formation/land filling	請參考 Appendix 4,填土及平整
	works to be carried out under this application.	不會影響附近流水。
	Please note that the overland flow from the	
	adjacent lands should not be affected.	

(5)	Surface channels at the peripheral of the site	已依照 貴署的意見更改,請參考
	should be constructed to intercept all such rain	Appendix 5 ∘
	water falling onto the site.	
(6)	Please indicate clearly the full alignment of the	請參考 Appendix 5 及 5.4。
	discharge path from the application site all the	
	way down to the ultimate discharge point (e.g. a	
	well-established stream course/public drainage	
	system).	
(7)	Please review the all invert levels as it should be	已依照 貴署的意見更改,請參考
	determined based on corresponding gradient	Appendix 5 °
	proposed.	
(8)	The capacity checking of existing natural stream	已依照 貴署的意見更改,請參考
	does not include the downstream flow.	Appendix – Calculation 。
(9)	The proposal should indicate how the runoff (the	已依照 貴署的意見更改,請參考
	flow direction) within the site would be	Appendix 5 ∘
	discharged to the proposed u-channel.	
(10)	The existing drainage facilities, to which the	本人了解現有的渠道設施不是由
	stormwater of the development from the subject	貴署所興建及保護。如興建及接駁
	site would discharge, are not maintained by this	 到其他私人或其他有關政府部門的
	office. The applicant should identify the owner	深道,會向有關持分者或部分了解 ————————————————————————————————————
	of the existing drainage facilities to which the	
	proposed connection will be made. Also, DSD	及取得同意後才會進行相關工程。
	noticed that the proposed drainage	
	connection(s) to the surrounding/downstream	
	area(s) will run through other private lot(s). The	
	applicant shall demonstrate that the proposed	
	drainage construction / improvement /	
	modification works and the operation of the	
	drainage can be practicably implemented.	
(11)	The applicant should check and ensure the	請參考 Appendix – Calculation 及 5.5。
	hydraulic capacity of the existing drainage	
	facilities would not be adversely affected by the	
	captioned development. Please provide site	
	photos to show existing condition of the existing	

S.16 Planning Application No. A/YL-KTN/1018

	drainage facilities which receives the discharge	
	from the application site.	
(12)	Please clarify whether any walls or hoarding	申請範圍將會以實心金屬板圍起,
	would be erected along the site	並會留有不少過 10cm 的空間讓水
	boundary. Where walls or hoarding are erected	 流通過,請參考 Appendix 5.1。
	are laid along the site boundary, adequate	
	opening should be provided to intercept the	
	existing overland flow passing through the site.	
(13)	The development should neither obstruct	本申請不會影響水流。
	overland flow nor adversely affect existing	
	natural streams, village drains, ditches and the	
	adjacent areas, etc.	
(14)	The applicant(s) shall resolve any	如興建及接駁到其他私人或其他有
	conflict/disagreement with relevant lot owner(s)	關政府部門的渠道,會向有關持分
	and seek LandsD's permission for laying new	 者或部分了解及取得同意後才會進
	drains/channels and/or modifying/upgrading	 行相關工程。
	existing ones in other private lots or on	1.1 1月 190 二- 1主
	Government land (where required) outside the	
	application site(s).	

R to C (Date: 9th October 2024):

	渠務署意見	申請人回覆
(1)	SDM Corrigendum No. 1/2022 and 1/2024	已依照 貴署的意見改用相關數
	should be considered.	據。
(2)	Channel turning at acute angle (i.e. at CP3 and	已依照 貴署的意見更改,請參考
	CP4) should be avoided wherever possible.	Appendix 5 °
(3)	The existing drainage facilities, to which the	本人了解現有的渠道設施不是由
	stormwater of the development from the subject	貴署所興建及保護。如興建及接駁
	site would discharge, are not maintained by this	 到其他私人或其他有關政府部門的
	office. The applicant should identify the owner	 渠道,會向有關持分者或部分了解
	of the existing drainage facilities to which the	
	proposed connection will be made. Also, DSD	及取得同意後才會進行相關工程。
	noticed that the proposed drainage	
	connection(s) to the surrounding/downstream	

	Application No. A/TE KIN/1016	
	area(s) will run through other private lot(s). The	
	applicant shall demonstrate that the proposed	
	drainage construction / improvement /	
	modification works and the operation of the	
	drainage can be practicably implemented.	
(4)	Please clarify whether any walls or hoarding	申請範圍將會以實心金屬板圍起,
	would be erected along the site boundary.	並會留有不少過 10cm 的空間讓水
	Where walls or hoarding are erected/laid along	 流通過,請參考 Appendix 5。
	the site boundary, adequate opening should be	
	provided to intercept the existing overland flow	
	passing through the site.	
(5)	Cross sections – Please justify the adjacent	已委託奧維環境顧問公司透過無人
	ground levels.	機在申請範圍及附近的土地上空測
		量申請地點與附近土地的高度,請
		參考 Appendix 5.6。根據高空
		圖,流水由北面、西北面及東北面
		流入,而相關方向已有現有渠道引
		導流水,因此只有少量流水會由申
		請地點的東北面流入申請地點,面
		積約 356 平方米。
(6)	The development should neither obstruct	申請範圍將會以實心金屬板圍起,
	overland flow nor adversely affect existing	並會留有不少過 10cm 的空間讓水
	natural streams, village drains, ditches and the	流 通 過 。
	adjacent areas, etc.	
(7)	The applicant(s) shall resolve any	如興建及接駁到其他私人或其他有
	conflict/disagreement with relevant lot owner(s)	關政府部門的渠道,會向有關持分
	and seek LandsD's permission for laying new	者或部分了解及取得同意後才會進
	drains/channels and/or modifying/upgrading	行相關工程。
	existing ones in other private lots or on	12 12 12 22
	Government land (where required) outside the	
	application site(s).	

Appendix – Calculation

Capacity Flows Estimation for Propose Catchments and Drainage System with 50 Year Return Period

A1. Calculation of On-Site Runoff (After Development)

Surface Type	Catchment Area (A), m ²	Catchment Area (A),	Average slope (H), m/100m	Flow path length (L), m	Time of Concentration (t _c), min	a (50 year return period)	b (50 year return period)	c (50 year return period)	Runoff intensity (i) mm/hr	Runoff coefficient (C)	C×A	Peak runoff (Q _P), m ³ /s
100% Concrete	1,915.1	0.0019151	0.63	71.9	5.36	505.5	3.29	0.355	245	0.95	0.0018193	0.124

Total 0.124

A2. Calculation of the Capacity of Proposed Drainage (After Development)

Channel Type	Width, m	Depth, m	Slope	Longth m	Manning's Roughness	Cross Section	Wetted	Hydraulic Mean		Mean Capacity		Runoff, m3/s	% of capacity Sufficient	
Chainlei Type	wiatii, iii	Deptil, III	tii, iii Siope	Length, m	Coefficient	Area, m2	Perimeter, m	radius, m	Velocity, m/s	flow, m3/s	Served, km²	Kulloli, Ilis/s	flow	Capacity (Y/N)
Concrete Channel	0.375	0.375	0.005	201.8	0.015	0.126	0.964	0.131	1.22	0.154	0.0019151	0.124	81%	Υ

^{*}Allowed 10% for siltation

Note:

Runoff is calculated in accordance with DSD's "Stormwater Drainage Manual – Planning, Design and Management" (SDM), fifth edition, January 2018.

Equation used: $t_0 = \frac{0.14465L}{H^{0.2}A^{0.1}}$ $t_c = t_0 + t_f$ $i = \frac{a}{(t_d + b)^c}$ $Q_p = 0.278 \ C \ i \ A$ $V = \frac{R^{1/6}}{n} \sqrt{RS_f}$

B1. Calculation of the runoff of Existing Drainage System

Surface Type	Catchment Area (A),	Catchment Area (A), km²	Average slope (H), m/100m	Flow path length (L), m	Time of Concentration (t _c), min	a (50 year return period)	b (50 year return period)	(50 year	Runoff intensity (i) mm/hr	Runoff coefficient (C)	C×A	Peak runoff (Q _p),
15% Concrete + 85% Grassland (Heavy soil) with steep surface	545,522	0.545522	24.5	1,470	29.93	505.5	3.29	0.355	140	0.44	0.24003	9.34

Total 9.34

B2. Adequacy Check for Existing Drainage System

Channel Type	Width, m	Depth, m	Slope	Length, m	Manning's Roughness Coefficient	Cross Section Area, m2	Wetted Perimeter, m	Hydraulic radius, m	Mean Velocity, m/s	Capacity flow, m3/s	Catchment Served, km ²	Runoff, m3/s	% of capacity flow	Sufficient Capacity (Y/N)
Natural-Stream (7)	2	2	0.245	1,470	0.05	4	6	0.667	7.55	30.2	0.530231	9.34	31%	Υ

 $^{^*}$ Allowed 10% for siltation. For assessment purpose, assume width and depth of the channel is 2m.

Check The Capacity of Existing Natural Stream

Manning Equation is used in hydraulic design and analysis. The cross-sectional mean velocity is given in the following expression:

$$V = \frac{R^{1/6}}{n} \sqrt{RS_f}$$

Where

R = hydraulic (m)

N = Manning coefficient (s/m1/3), refer Table 13 of SDM

Sf = friction gradient (dimensionless)

Using Manning's Equation

$$V = R^{2/3} * S_f^{0.5} / n$$

Where R = A/P = 0.667 m A = 4 m²
$$P = 6 m$$
 n = 0.05 s/m^{1/3} (Table 13 of Stormwater Drainage Manual)
$$S_f = 0.245$$

Therefor V =
$$0.667^{2/3}*0.245^{0.5}/0.05$$


= 7.55 m/sec

Maximum Capacity (Qmax)

= V*A= $30.2 \text{ m}^3/\text{sec}$

> Q total *Allowed 10% for situation.

The Existing Natural Stream has enough capacity.

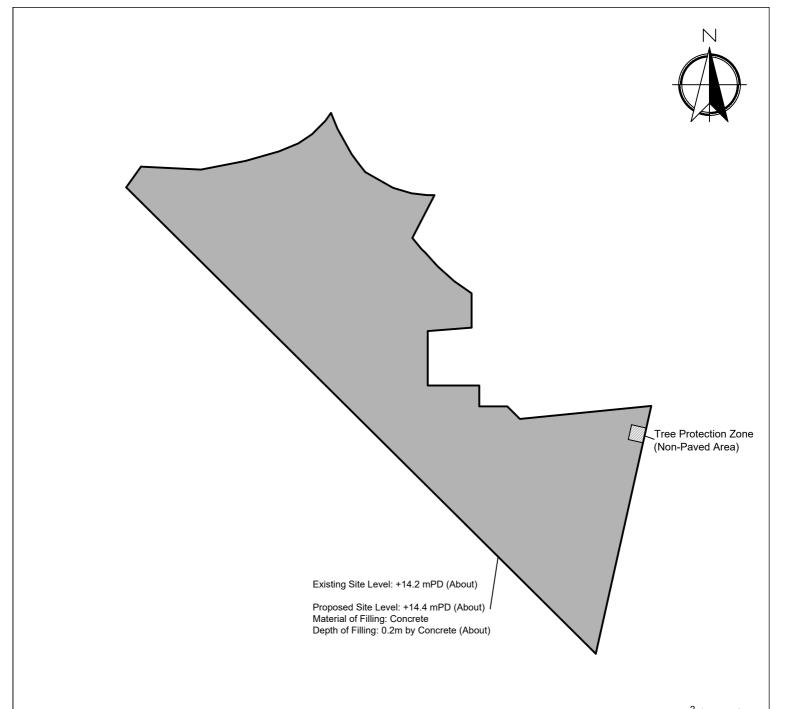

Total Area: 1,559.1 m² (About)
Paved Area: 1,555.1 m² (About)
Non-Paved Area: 4 m² (About)

Legend:

Paved Area 平整範圍

Non-Paved Area 不平整範圍

Appendix 4

Location: DD 107 Lot 1247 (Part), 1248 (Part), 1249 (Part), 1252 (Part) and 1253 (Part)

and 1253 (Part)

OZP: S/YL-KTN/11 District: Kam Tin North Zoning: Agriculture

Date: 15 September 2024

Paved Area

平整位置圖

擬議臨時露天存放建築機械及物料 (為期3年)及填土

Proposed Temporary Open Storage of Construction Machinery and Materials For a Period of 3 Years and Filling of Land


SCALE


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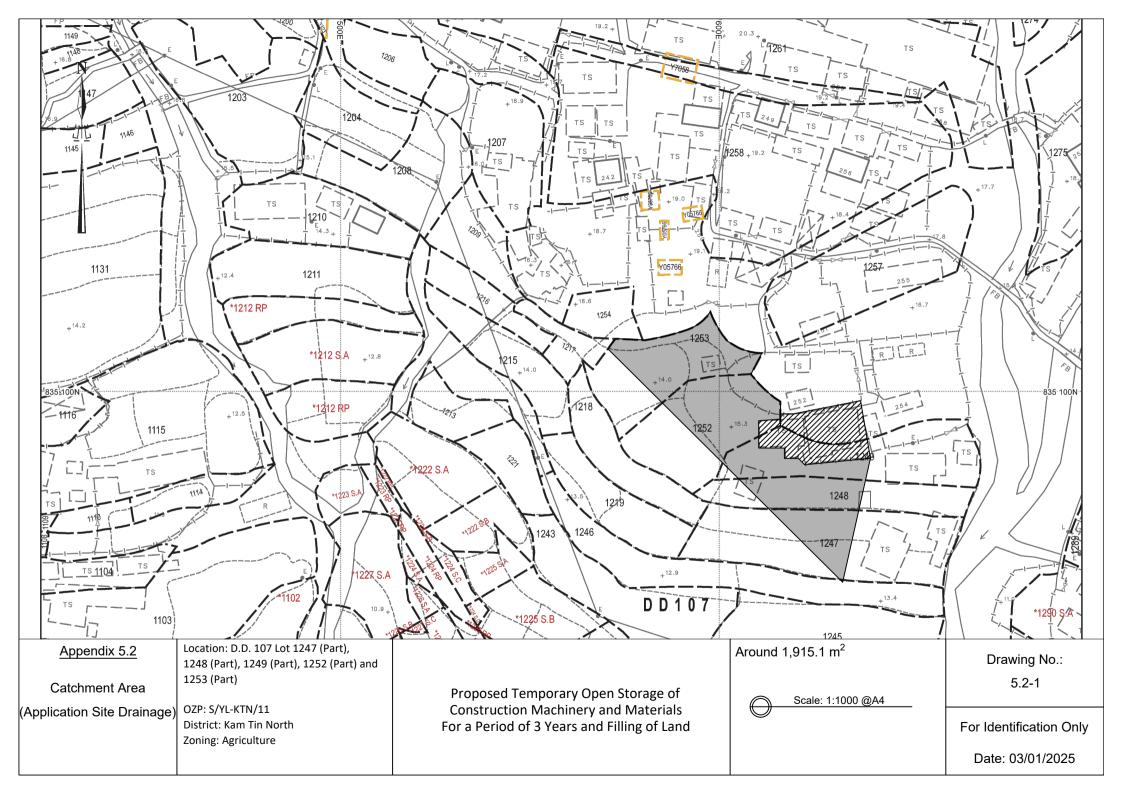
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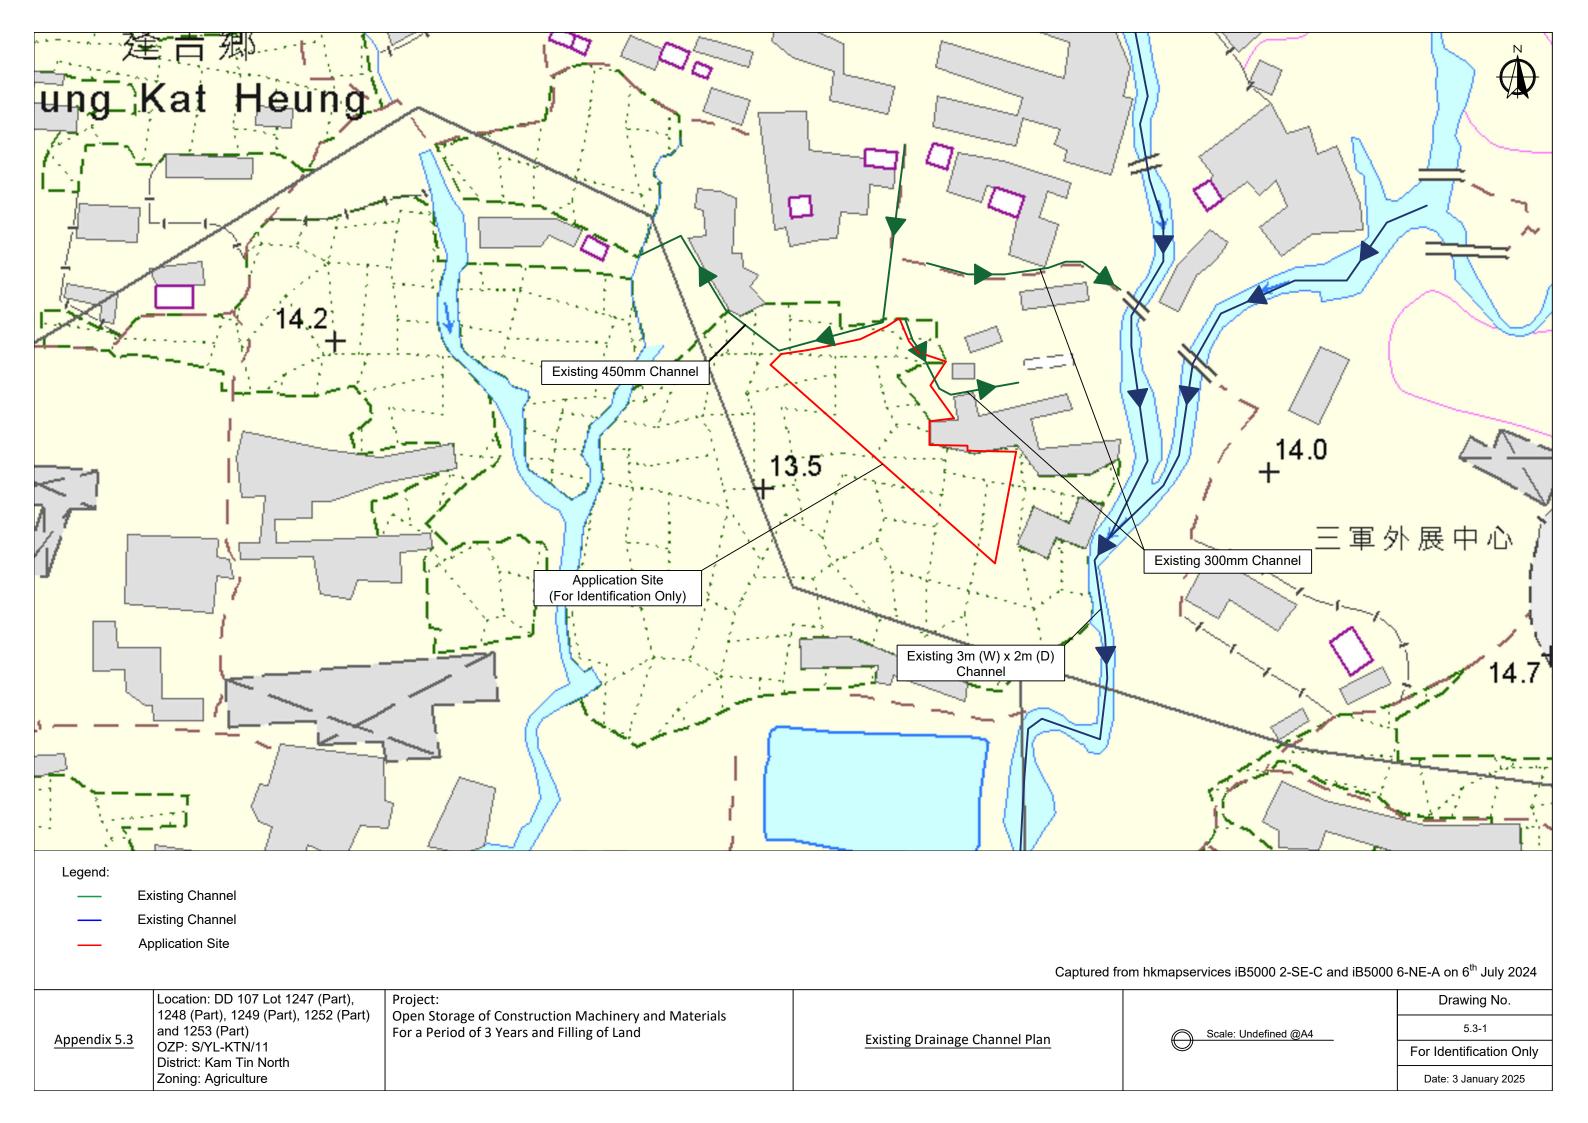
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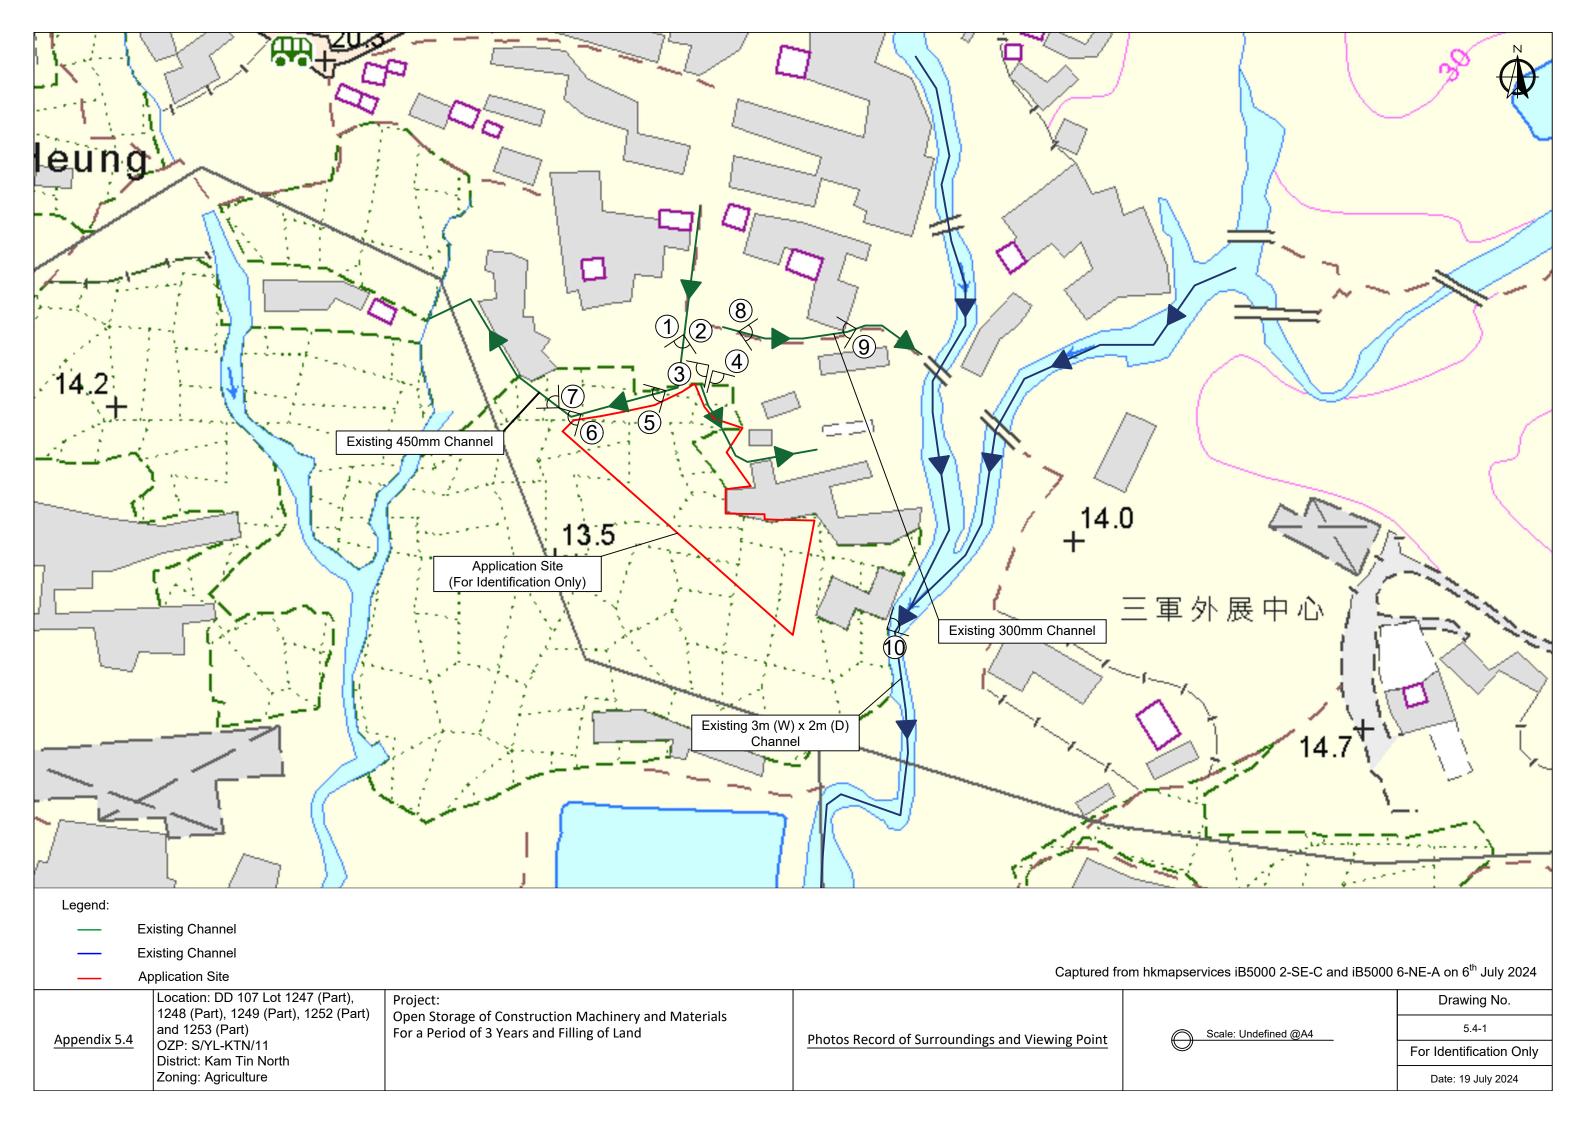
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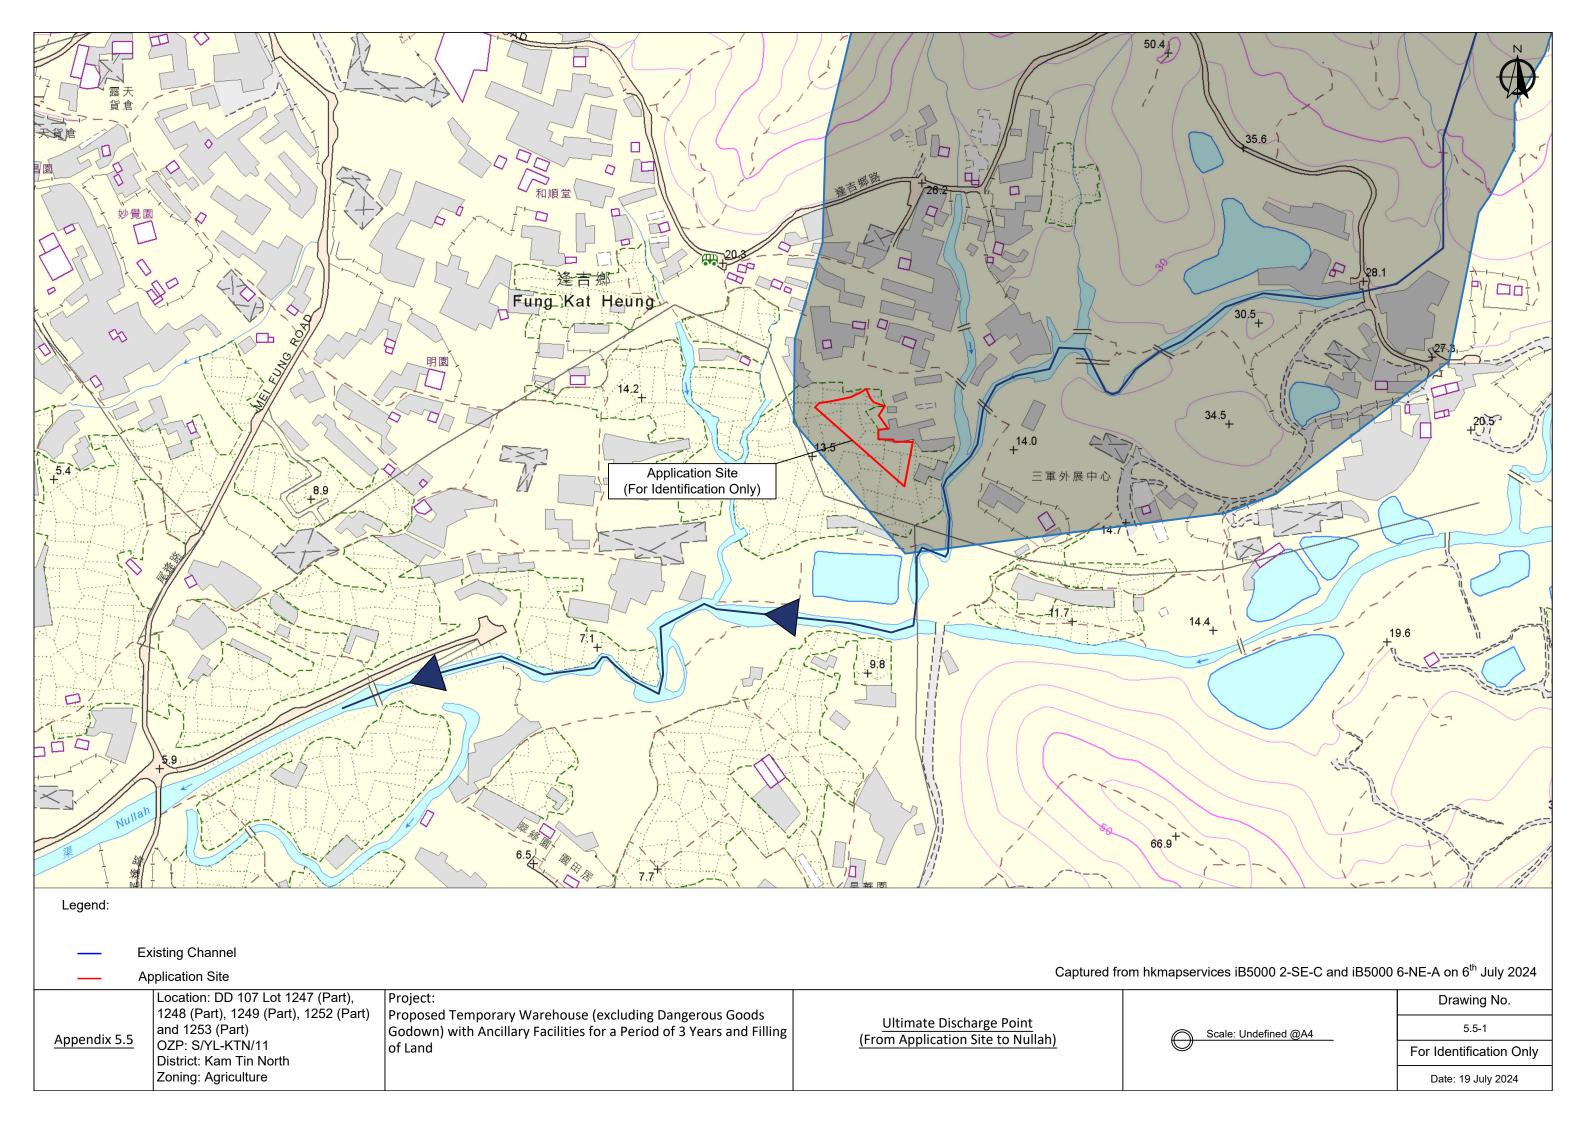









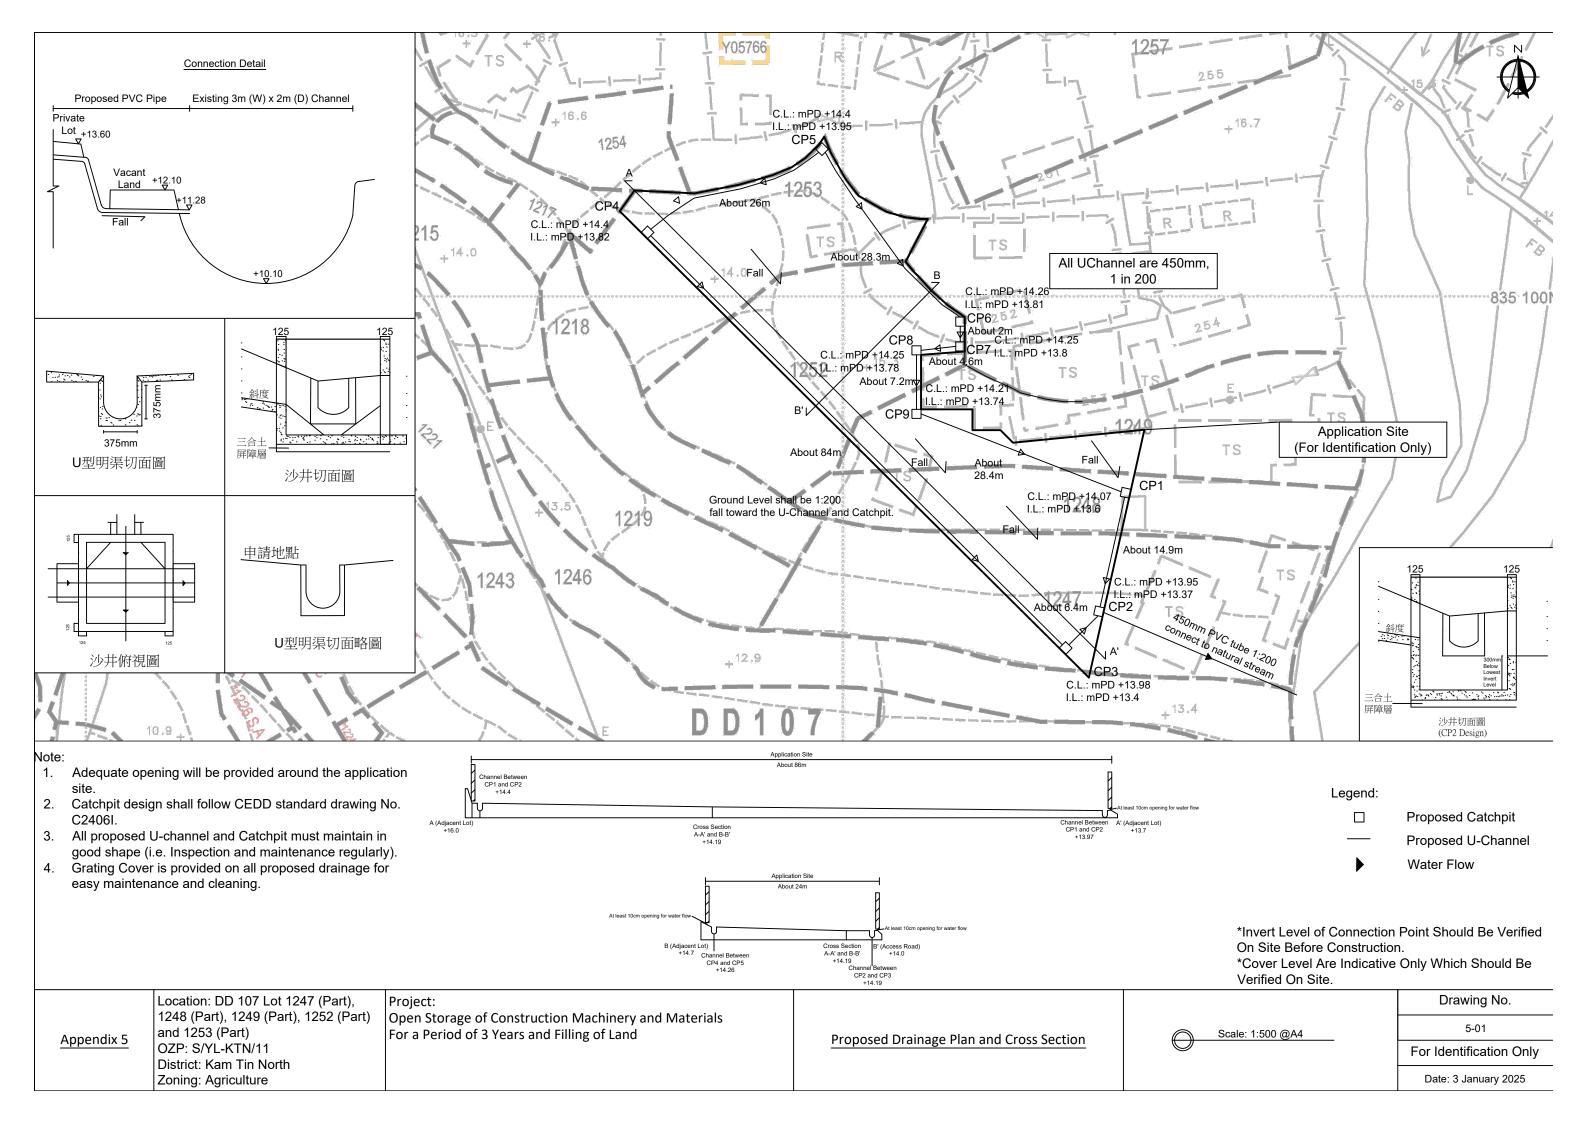

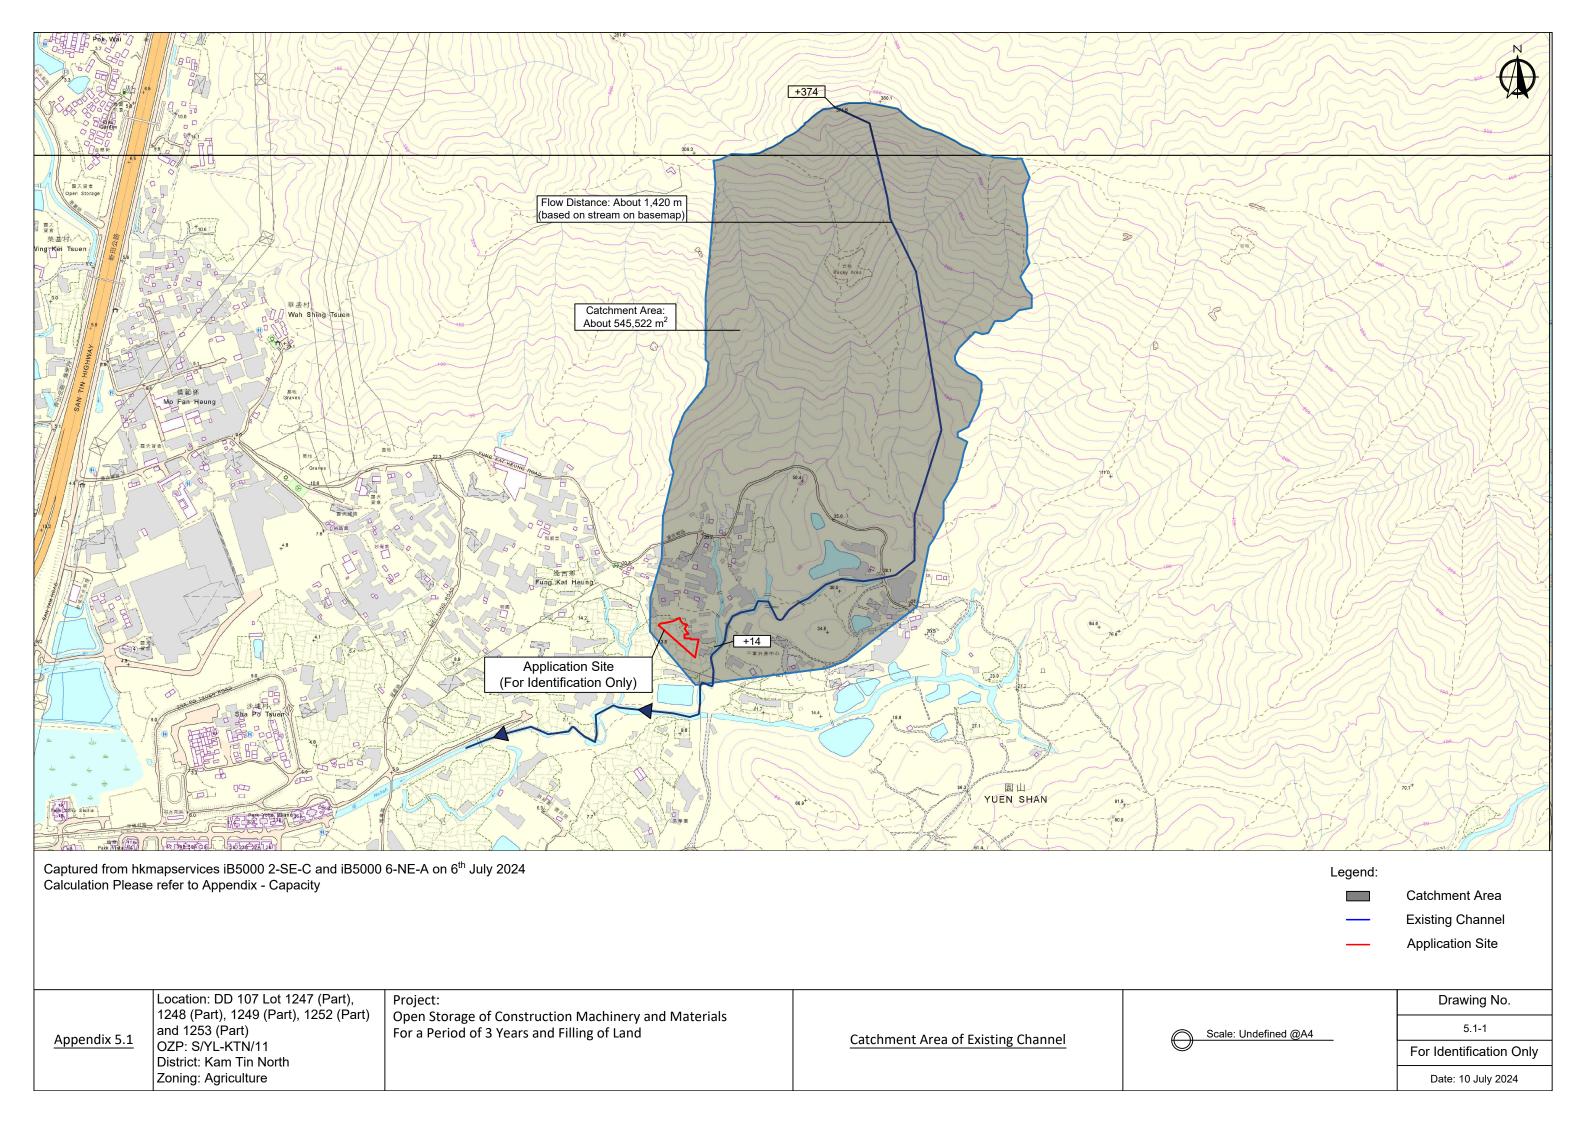

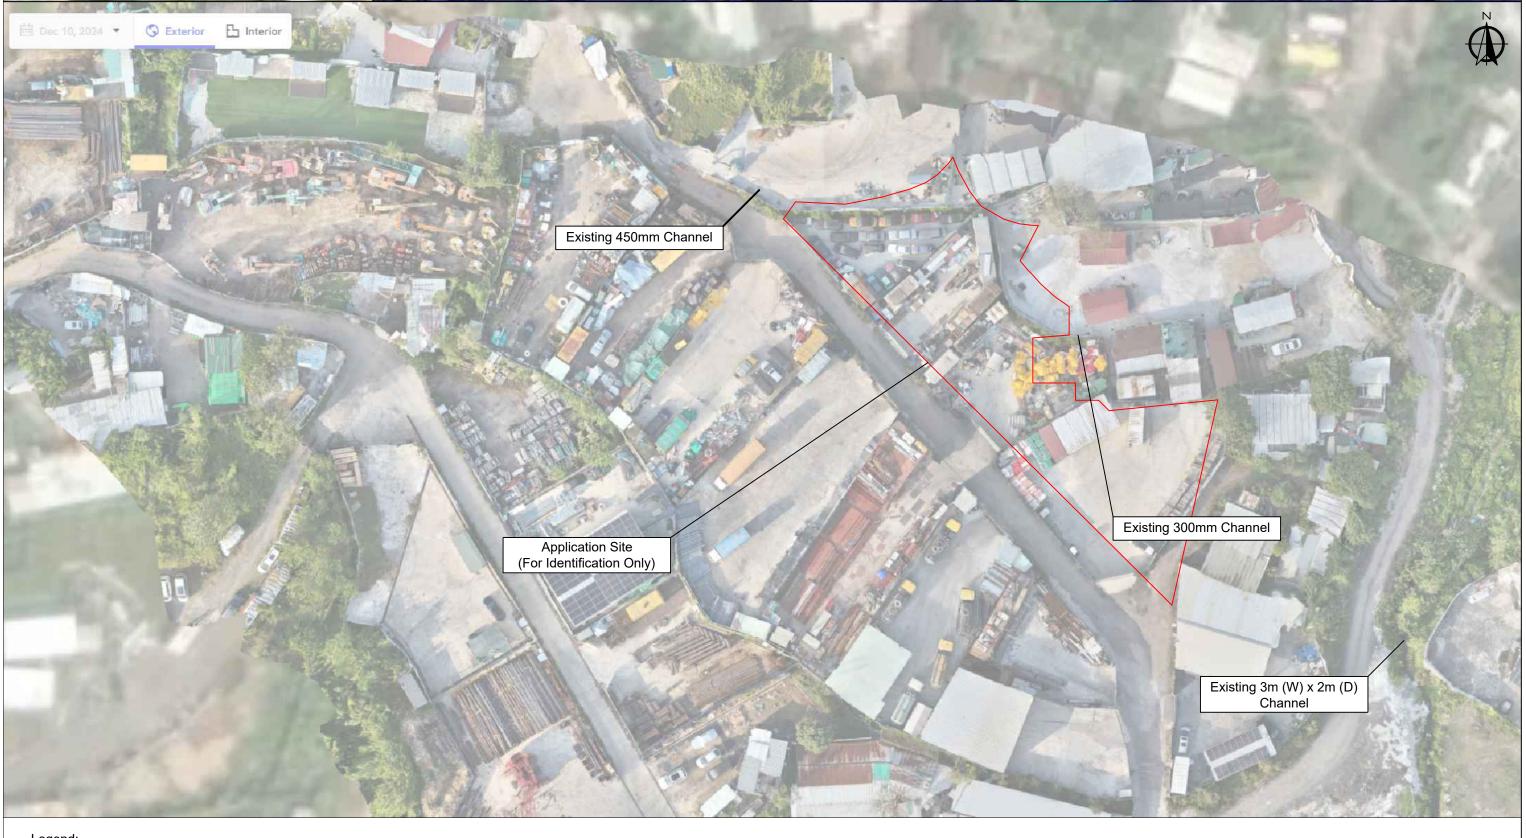



Existing Channel

Application Site

Captured on 10th December 2024

Appendix 5.6

Location: DD 107 Lot 1247 (Part), 1248 (Part), 1249 (Part), 1252 (Part) and 1253 (Part) OZP: S/YL-KTN/11 District: Kam Tin North

Zoning: Agriculture

Project:

Open Storage of Construction Machinery and Materials For a Period of 3 Years and Filling of Land

Existing Drainage Record (Drone)



Drawing No.

5.6-1

For Identification Only


Date: 3 January 2025



現場相片






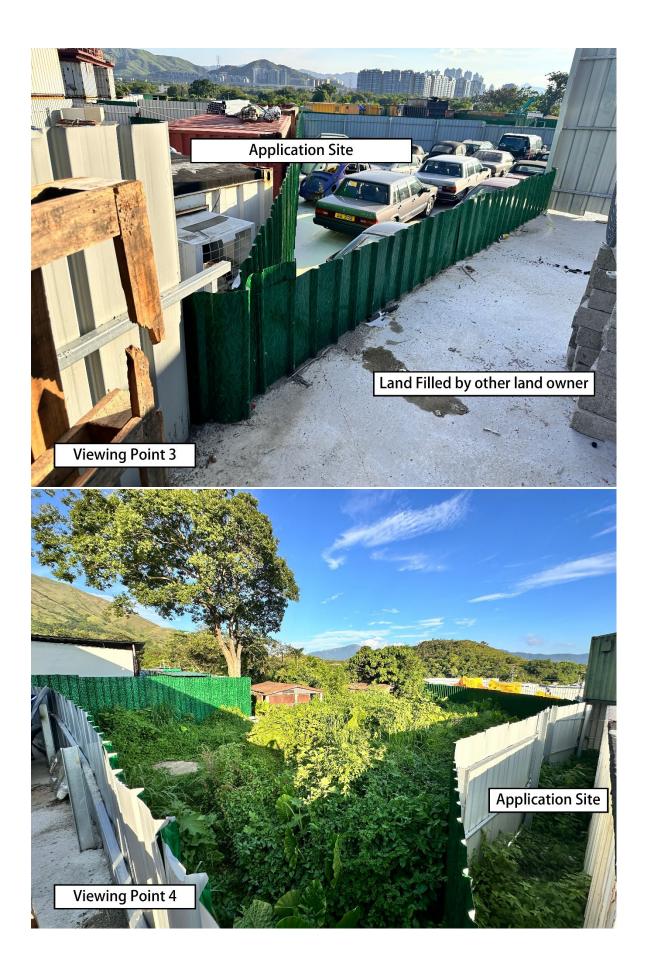









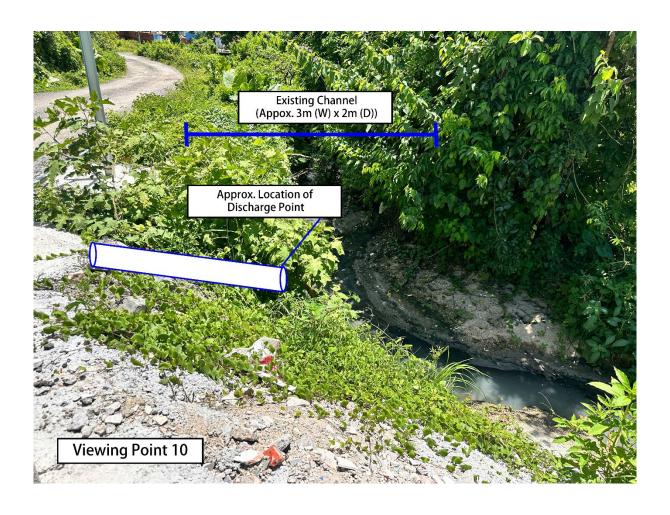

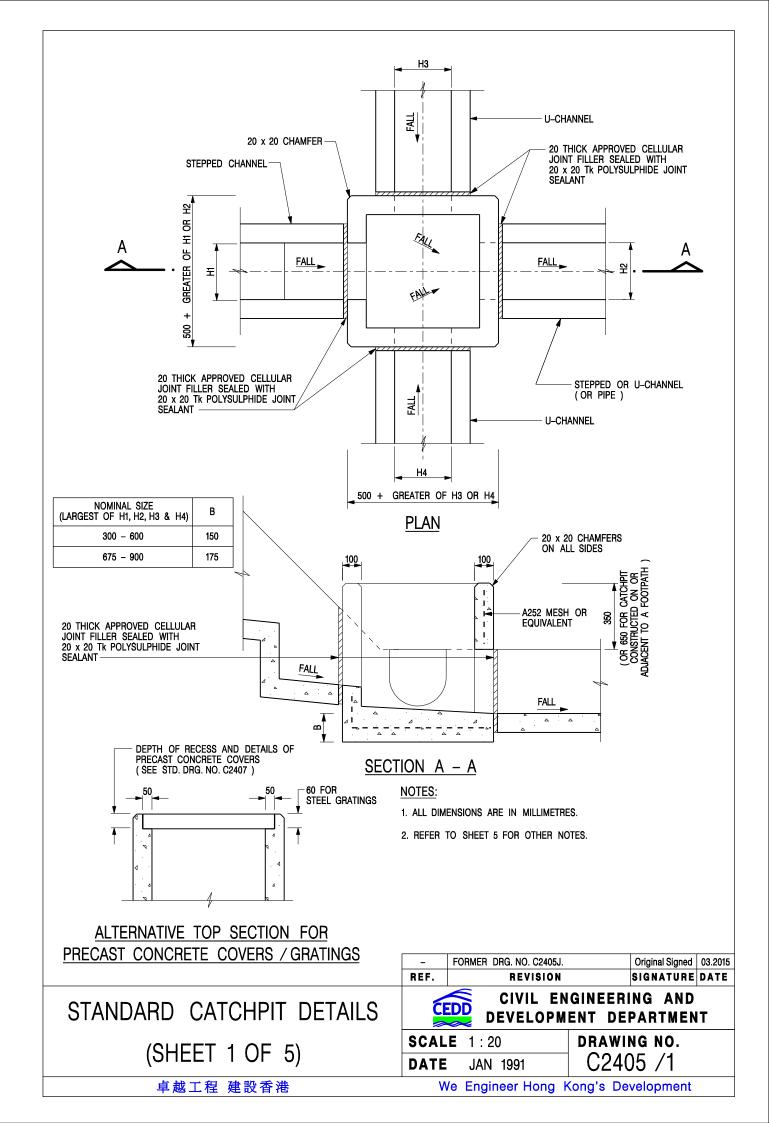

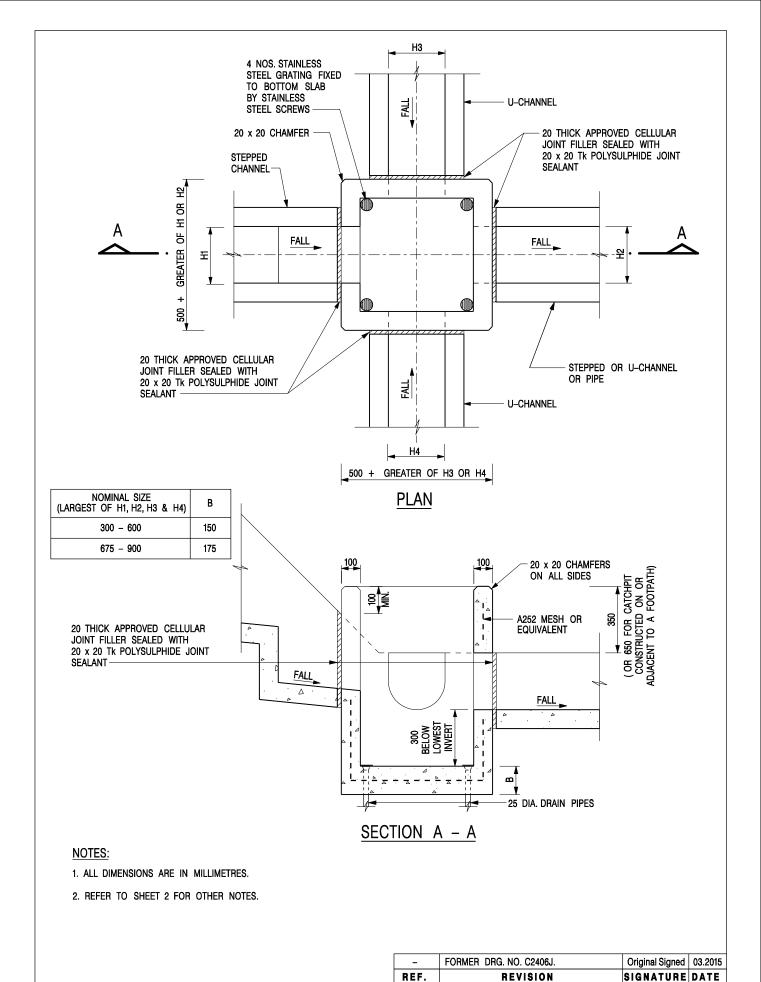

CATCHPIT WITH TRAP (SHEET 1 OF 2)


CIVIL ENGINEERING AND DEVELOPMENT DEPARTMENT

SCALE 1:20

DATE JAN 1991

C2406 /1

卓越工程 建設香港

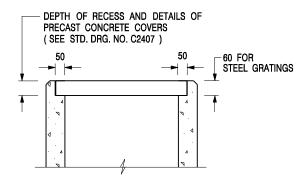

ALTERNATIVE TOP SECTION FOR PRECAST CONCRETE COVERS / GRATINGS

NOTES:

- 1. ALL DIMENSIONS ARE IN MILLIMETRES.
- 2. ALL CONCRETE SHALL BE GRADE 20 /20.
- 3. CONCRETE SURFACE FINISH SHALL BE CLASS U2 OR F2 AS APPROPRIATE.
- 4. FOR DETAILS OF JOINT, REFER TO STD. DRG. NO. C2413.
- 5. CONCRETE TO BE COLOURED AS SPECIFIED.
- 6. UNLESS REQUESTED BY THE MAINTENANCE PARTY AND AS DIRECTED BY THE ENGINEER, CATCHPIT WITH TRAP IS NORMALLY NOT PREFERRED
- 7. UPON THE REQUEST FROM MAINTENANCE PARTY, DRAIN PIPES AT CATCHPIT BASE CAN BE USED BUT THIS IS FOR CATCHPITS LOCATED AT SLOPE TOE ONLY AND AS DIRECTED BY THE ENGINEER.
- 8. FOR CATCHPITS CONSTRUCTED ON OR ADJACENT TO A FOOTPATH, STEEL GRATINGS (SEE DETAIL 'A' ON STD. DRG. NO. C2405 /2) OR CONCRETE COVERS (SEE STD. DRG. NO. C2407) SHALL BE PROVIDED AS DIRECTED BY THE ENGINEER.
- 9. IF INSTRUCTED BY THE ENGINEER, HANDRAILING (SEE DETAIL 'J' ON STD. DRG. NO. C2405 /5; EXCEPT ON THE UPSLOPE SIDE) IN LIEU OF STEEL GRATINGS OR CONCRETE COVERS CAN BE ACCEPTED AS AN ALTERNATIVE SAFETY MEASURE FOR CATCHPITS NOT ON A FOOTPATH NOR ADJACENT TO IT. TOP OF THE HANDRAILING SHALL BE 1 000 mm MIN. MEASURED FROM THE ADJACENT GROUND LEVEL.
- 10. MINIMUM INTERNAL CATCHPIT WIDTH SHALL BE 1 000 mm FOR CATCHPITS WITH A HEIGHT EXCEEDING 1 000 mm MEASURED FROM THE INVERT LEVEL TO THE ADJACENT GROUND LEVEL. AND, STEP IRONS (SEE DSD STD. DRG. NO. DS1043) AT 300 c/c STAGGERED SHALL BE PROVIDED. THICKNESS OF CATCHPIT WALL FOR INSTALLATION OF STEP IRONS SHALL BE INCREASED TO 150 mm.
- 11. FOR RETROFITTING AN EXISTING CATCHPIT WITH STEEL GRATING, SEE DETAIL 'G' ON STD. DRG. NO. C2405 /4.
- 12. SUBJECT TO THE APPROVAL OF THE ENGINEER, OTHER MATERIALS CAN ALSO BE USED AS COVERS / GRATINGS.

REF.	REVISION	SIGNATURE	DATE
-	FORMER DRG. NO. C2406J.	Original Signed	03.2015
Α	MINOR AMENDMENT.	Original Signed	04.2016

CATCHPIT WITH TRAP (SHEET 2 OF 2)


卓越工程 建設香港



CIVIL ENGINEERING AND **DEVELOPMENT DEPARTMENT**

DRAWING NO. **SCALE** 1:20 **DATE** JAN 1991

C2406 /2A

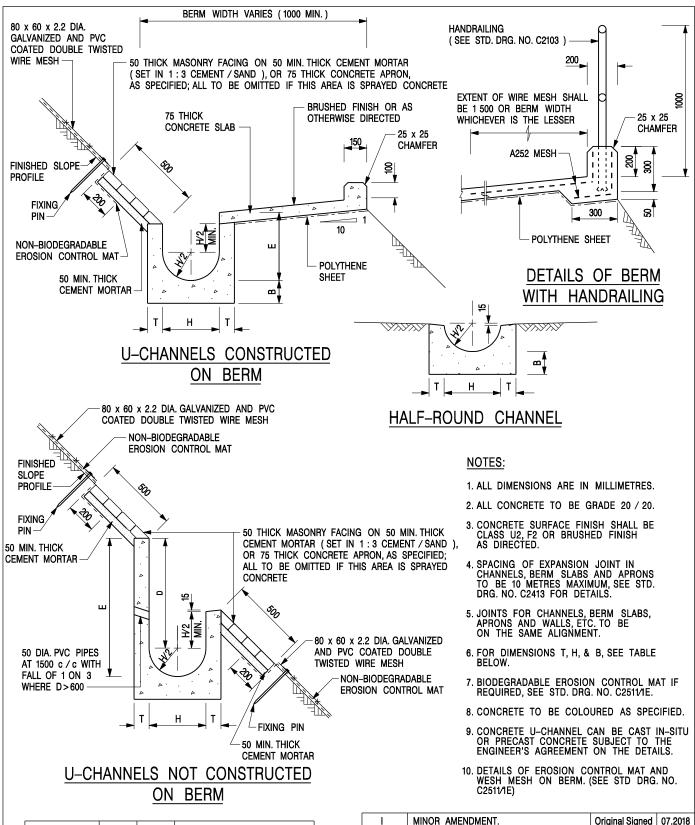

NOMINAL SIZE	Т	В	REINFORCEMENT
300	80	100	A252 MESH PLACED CENTRALLY AND T=100
375 - 600	100	150	WHEN E>650
	405	475	A252 MESH PLACED

175

675 - 900

125

REF.	REVISION	SIGNATURE	DATE
В	MINOR AMENDMENTS.	Original Signed	3.94
С	150 x 100 UPSTAND ADDED AT BERM.	Original Signed	6.99
D	MINOR AMENDMENT.	Original Signed	08.2001
E	DRAWING TITLE AMENDED.	Original Signed	11.2001
F	GENERAL REVISION.	Original Signed	12.2002
G	MINOR AMENDMENT.	Original Signed	01.2004
Н	THICKNESS OF MASONRY FACING AMENDED.	Original Signed	01.2005
ı	MINOR AMENDMENT.	Original Signed	07.2018

DETAILS OF HALF-ROUND AND U-CHANNELS (TYPE A -WITH MASONRY APRON)

卓越工程 建設香港


CENTRALLY




CIVIL ENGINEERING AND DEVELOPMENT DEPARTMENT

 SCALE
 1:25
 DRAWING NO.

 DATE
 JAN 1991
 C24091

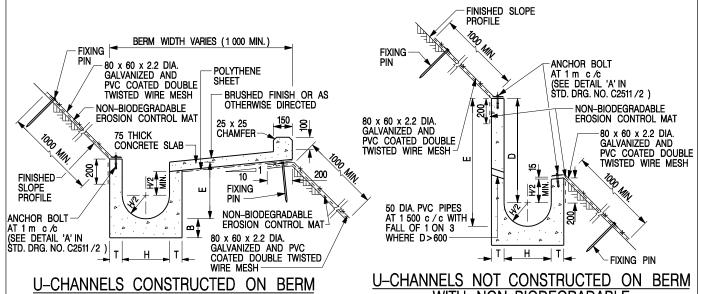

U-CHANNELS CONSTRUCTED ON BERM WITH NON-BIODEGRADABLE EROSION CONTROL MAT <u>J-CHANNELS NOT CONSTRUCTED ON BERM</u>
<u>WITH NON-BIODEGRADABLE</u>
EROSION CONTROL MAT

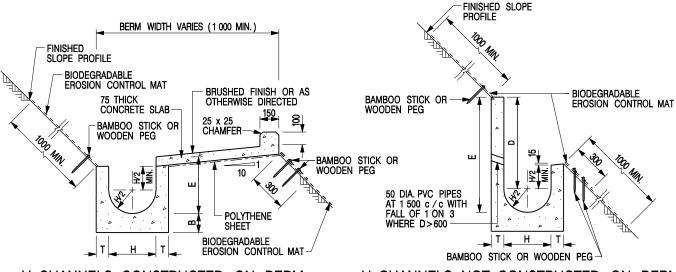

U-CHANNELS CONSTRUCTED ON BERM WITH BIODEGRADABLE EROSION CONTROL MAT

U-CHANNELS NOT CONSTRUCTED ON BERM WITH BIODEGRADABLE EROSION CONTROL MAT

NOTES:

- 1. ALL DIMENSIONS ARE IN MILLIMETRES.
- 2. ALL CONCRETE TO BE GRADE 20 /20.
- 3. CONCRETE SURFACE FINISH SHALL BE CLASS U2, F2 OR BRUSHED FINISH AS DIRECTED.
- 4. SPACING OF EXPANSION JOINT IN CHANNELS, BERM SLABS AND APRONS TO BE 10 METRES MAXIMUM, SEE STD. DRG. NO. C2413 FOR DETAILS.
- 5. JOINTS FOR CHANNELS, BERM SLABS, APRONS AND WALLS, ETC. TO BE ON THE SAME ALIGNMENT.
- 6. FOR DIMENSIONS T, H, & B, SEE TABLE BELOW.
- FOR TYPICAL FIXING PIN DETAILS, SEE STD. DRG. NO. C2511/2.
- 8. MINIMUM SIZE OF 25 x 50 x 300mm SHALL BE PROVIDED FOR WOODEN PEG.
- MINIMUM SIZE OF 10mm DIAMETER WITH 200mm LONG SHALL BE PROVIDED FOR BAMBOO STICK.
- 10. THE FIXING DETAILS OF NON-BIODEGRADABLE AND BIODEGRADABLE EROSION CONTROL MATS ON EXISTING BERM SHALL REFER TO STD. DRG. NO. C2511/1.

NOMINAL SIZE H	Т	В	REINFORCEMENT
300	80	100	A252 MESH PLACED CENTRALLY AND T=100
375 - 600	100	150	WHEN E>650
675 - 900	125	175	A252 MESH PLACED CENTRALLY

				ULIVITA	\LL!			
	ETAILS	OF	HA	\LF-I	ROUN	ID	AND	
	U-CHAN	INEL	S	(TYP	EB-	- V	VITH	
Εl	ROSION	CC	NT	ROL	MAT	AF	PRON)

1	MINOR AMENDMENT.	Original Signed	07.2018
Н	FIXING DETAILS OF BIODEGRADABLE EROSION CONTROL MAT ADDED.	Original Signed	12.2017
G	DIMENSION TABLE AMENDED.	Original Signed	01.2005
F	MINOR AMENDMENT.	Original Signed	01.2004
E	GENERAL REVISION.	Original Signed	12.2002
D	MINOR AMENDMENT.	Original Signed	08.2001
С	150 x 100 UPSTAND ADDED AT BERM.	Original Signed	6.99
В	MINOR AMENDMENT.	Original Signed	3.94
Α	MINOR AMENDMENT.	Original Signed	10.92
REF.	REVISION	SIGNATURE	DATE




CIVIL ENGINEERING AND DEVELOPMENT DEPARTMENT


SCALE DIAGRAMMATIC

DATE JAN 1991

DRAWING NO. C24101

卓越工程 建設香港

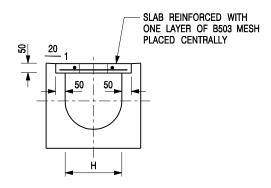

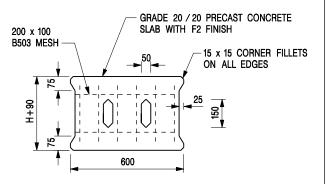



TYPICAL SECTION

PLAN OF SLAB

U-CHANNELS WITH PRECAST CONCRETE SLABS

(UP TO H OF 525)

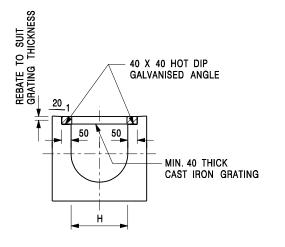

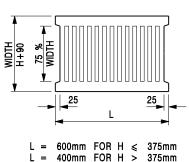

TYPICAL SECTION

CAST IRON GRATING

(DIMENSIONS ARE FOR GUIDANCE ONLY, CONTRACTOR MAY SUBMIT EQUIVALENT TYPE)

U-CHANNEL WITH CAST IRON GRATING

(UP TO H OF 525)

NOTES:

- 1. ALL DIMENSIONS ARE IN MILLIMETRES.
- 2. H=NOMINAL CHANNEL SIZE.
- 3. ALL CAST IRON FOR GRATINGS SHALL BE GRADE EN-GJL-150 COMPLYING WITH BS EN 1561.
- 4. FOR COVERED CHANNELS TO BE HANDED OVER TO HIGHWAYS DEPARTMENT FOR MAINTENANCE, THE GRATING DETAILS SHALL FOLLOW THOSE AS SHOWN ON HyD STD. DRG. NO. H3156.

REF.	REVISION	SIGNATURE	DATE
Α	CAST IRON GRATING AMENDED.	Original Signed	12.2002
В	NAME OF DEPARTMENT AMENDED.	Original Signed	01.2005
С	MINOR AMENDMENT. NOTE 3 ADDED.	Original Signed	12.2005
D	NOTE 4 ADDED.	Original Signed	06.2008
Ε	NOTES 3 & 4 AMENDED.	Original Signed	12.2014

COVER SLAB AND CAST IRON GRATING FOR CHANNELS



CIVIL ENGINEERING AND DEVELOPMENT DEPARTMENT

 SCALE 1:20
 DRAWING NO.

 DATE JAN 1991
 C2412E

卓越工程 建設香港

Table 3a – Storm Constants for Different Return Periods of HKO Headquarters

Return Period T (years)	2	5	10	20	50	100	200	500	1000
a	446.1	470.5	485.0	496.0	505.5	508.6	508.8	504.6	498.7
b	3.38	3.11	3.11	3.17	3.29	3.38	3.46	3.53	3.55
С	0.463	0.419	0.397	0.377	0.355	0.338	0.322	0.302	0.286

Table 3d – Storm Constants for Different Return Periods of North District Area

Return Period T (years)	2	5	10	20	50	100	200
a	439.1	448.1	454.9	462.3	474.6	486.6	501.4
b	4.10	3.67	3.44	3.21	2.90	2.67	2.45
С	0.484	0.437	0.412	0.392	0.371	0.358	0.348

Table 13 - Values of n to be used with the Manning equation

Source: Brater, E.F. & King, H.W. (1976)

Surface	Best	Good	Fair	Bad
Uncoated cast-iron pipe	0.012	0.013	0.014	0.015
Coated cast-iron pipe	0.011	0.012*	0.013*	
Commercial wrought-iron pipe, black	0.012	0.013	0.014	0.015
Commercial wrought-iron pipe, galvanized	0.013	0.014	0.015	0.017
Smooth brass and glass pipe	0.009	0.010	0.011	0.013
Smooth lockbar and welded "OD" pipe	0.010	0.011*	0.013*	
Riveted and spiral steel pipe	0.013	0.015*	0.017*	
Vitrified sewer pipe	0.010	0.013*	0.015	0.017
Common clay drainage tile	0.011	0.012*	0.014*	0.017
Glazed brickwork	0.011	0.012	0.013*	0.015
Brick in cement mortar; brick sewers	0.012	0.013	0.015*	0.017
Neat cement surfaces	0.010	0.011	0.012	0.013
Cement mortar surfaces	0.011	0.012	0.013*	0.015
Concrete pipe	0.012	0.013	0.015*	0.016
Wood stave pipe	0.010	0.011	0.012	0.013
Plank flumes - Planed	0.010	0.012*	0.013	0.014
- Unplaned	0.011	0.013*	0.014	0.015
- With battens	0.012	0.015*	0.016	
Concrete-lined channels	0.012	0.014*	0.016*	0.018
Cement-rubble surface	0.017	0.020	0.025	0.030
Dry-rubble surface	0.025	0.030	0.033	0.035
Dressed-ashlar surface	0.013	0.014	0.015	0.017
Semicircular metal flumes, smooth	0.011	0.012	0.013	0.015
Semicircular metal flumes, corrugated	0.0225	0.025	0.0275	0.030
Canals and ditches				
1. Earth, straight and uniform	0.017	0.020	0.0225*	0.025
2. Rock cuts, smooth and uniform	0.025	0.030	0.033*	0.035
3. Rock cuts, jagged and irregular	0.035	0.040	0.045	
4. Winding sluggish canals	0.0225	0.025*	0.0275	0.030
5. Dredged-earth channels	0.025	0.0275*	0.030	0.033
6. Canals with rough stony beds, weeds on earth banks	0.025	0.030	0.035*	0.040
7. Earth bottom, rubble sides	0.028	0.030*	0.033*	0.035
Natural-stream channels				
1. Clean, straight bank, full stage, no rifts or deep pools	0.025	0.0275	0.030	0.033
2. Same as (1) but some weeds and stones	0.030	0.033	0.035	0.040
3. Winding some pools and shoals, clean	0.033	0.035	0.040	0.045
4. Same as (3), lower stages, more ineffective slope and sections	0.040	0.045	0.050	0.055

Table 13 (Cont'd)


Surface	Best	Good	Fair	Bad
5. Same as (3) some weeds and stones	0.035	0.040	0.045	0.050
6. Same as (4) stony sections	0.045	0.050	0.055	0.060
7. Sluggish river reach, rather weedy or with very deep pools	0.050	0.060	0.070	0.080
8. Very weedy reaches	0.075	0.100	0.125	0.150

Notes: *Values commonly used for design.

LGV L/UL Space Dimension: 7m x 3.5m

Unit(s): 2



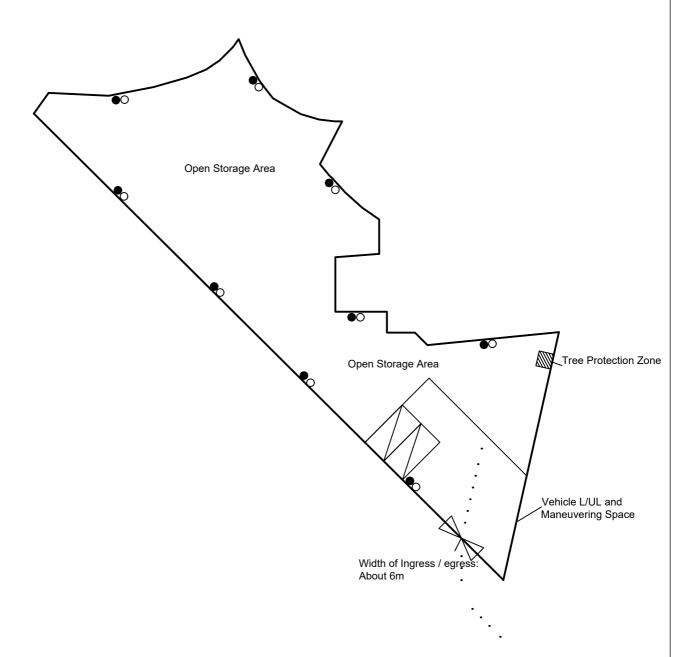

- *All FSI (includes installation/maintenance/modification/repair work) will be completed by RFSIC. For Emergency Vehicular Access, Please see Appendix 6.1
- * All Internal Access for Fire Appliances are within 4.5m
- * There will be clear width with 2m between the storage and lot boundaries.

Legend:

- O 5 kg Portable Carbon Dioxide Type Fire Extinguisher (9 in Total)
- 9 kg Portable Water Type Fire Extinguisher (9 in Total)
- Emergency Vehicular Access

Appendix 6

Location: DD 107 Lot 1247 (Part), 1248 (Part), 1249 (Part), 1252 (Part)

and 1253 (Part)

App. No.: A/YL-KTN/1018

OZP: S/YL-KTN/11 District: Kam Tin North Zoning: Agriculture Date: 11 September 2024

Proposed Fire Service Installation Plan

擬議消防設備安裝計劃圖

擬議臨時露天存放建築機械及物料 (為期3年)及填土

Proposed Temporary Open Storage of Construction Machinery and Materials For a Period of 3 Years and Filling of Land **SCALE**

1:500

@A4

For Identification Only

Drawing No.:



* The Fire Hydrant No. 12103 is within 500m of the application site.



Scale: Undefined @A4

Captured from map.gov.hk on 25th April 2024

Appendix 6.1

Location: D.D. 107 Lot 1247 (Part), 1248 (Part), 1249

(Part), 1252 (Part) and 1253 (Part)

Emergency Vehicular Access

OZP: S/YL-KTN/11 District: Kam Tin North Zoning: Agriculture Proposed Temporary Open Storage of Construction Machinery and Materials For a Period of 3 Years and Filling of Land Width of Shui Mei Road: 3-6m (About) Map Legend:

•••• Road Path
Site Boundary

Drawing No.: 6.1-1

For Identification Only

Date: 11/09/2024

FSD Ref.: 消防處檔號	Aud	9563832					
Name of 顧客姓	f Client 名	F含水的海Uis	ATTENDED TO SELECT AND ADDRESS OF THE PARTY	tallation other than			£ 3
Name of 樓宇名	f Building : DD107	LOT 1247(Part),	1248(Part),	1249(Part),1252(Part)	and 1253(Part) BMO	Aut	ta service
Street N	o./Town Lot: 數/市地段		Street/Roa 街道	ad/Estate Name: /屋苑名稱			2
Block: 座		District 分區	:	Are Cam Tin, Yuen Lon地	ncher System : se : se : se	K 九龍	NT 新界
Type of	Building 樓宇類型:□Ind	ustrial工業 Comm	nercial商業	Domestic住宅 Composit	e綜合 Licensed premis	es持牌處	所 Institutiona社團
	rt 1 Annual Inspection(一部 只適用於年檢	事項 equipr	ment which is installed n every 12 months.	on 8(b) of Fire Service (Installations a in any premises shall have such fire ser 根據消防(裝置及設備)規例第八/ K鮮商檢查該等消防裝置或設備至	vice installation or equipment inspect 條(b)款,擁有裝置在任何處所及	ed by a regis 的任何消	tered contractor at least
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			系統	MFA) 火警警報			13
					Control Centre		14
	/			m火管模测条统	Detection System	Fir	15
Part 2 第	三部 Installation / Mod	lification / Repair	/ Inspection	work 裝置/改裝/修	理/檢查工作。	Fire	- 16
Code編碼 (1-35)	Type of FSI 裝置類型	Location(s) 位置	Nature of Worl	k Carried out 完成之工作內容	Comment on Condition #	況評述 🤌	Completion Date 完成日期(DD/MM/YY)
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			DESCRIPTION OF THE PROPERTY AND ADDRESS.	固定泡沫系統	ed Foam System	Fix	20
				n 氣體偵測系統	Detection Syste	Gas	21 **
	,			m氣體排放多統	Extraction Syste	Gas	Co
	医三部 Defects 損壞事項	Į		Ţ.	e Reel 消防喉鶇	ЮН	16
Code編碼 (1-35)	Type of FSI 装置類型	Location(s) 位置	7	ng Defects 未修缺點	On no temmo Cable Fire Exting	TO CHEST	點評述
	作手提器具	可的人手操作	oliance 📆	ted Approved App	table Hand-opera	Por	25
				ircase 樓航增壓	Surization of Sta	Pre	26
	水管系統	它水泵的環狀) 裝有固?	ith Fixed Pump(s	g Main System v	Rin	27
		V	****	灑糸統	okler System 1E	Spr	28
		结	式排煙系	tion System 静態	Singke Extrac	Stat	29
working order Equipment and	ertify that the above installations/equip in accordance with the Codes of Prid Inspection, Testing and Maintenance Director of Fire Services. Defects are lis	actice for Minimum Fire S of Installations and Equipr	Service Installations ment published from	s and Signature: time 受權人簽署	ply Ink Jok áz	Sup	For FSD use only:
本人藉此語合消防處	證明以上之消防裝置及設 處長不時公佈的最低限度 会查測試及保養守則的規格	備經試驗,證明性 之消防裝置及設備	守則與裝置	# SED/RC No. : 消防處註冊號碼	Chow Kwok Wal	100	I Inspected
如言	登書涉及年檢事 ^耳 處所當眼處以供	頁,應張貼;	於大廈	Company Name: 公司名稱	ter Supply (KN)	Wa	Key-in
	is certificate should be displayed at promit for FSD's inspection if any annual	nent location of the building o	or premises	Sylender 道道市局 部電話		Str	1.5
F.S. 251 (Rev. 1	/2016)			Date:	ers # 20/12/20	Oth	Verified

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Relevant Extracts of Town Planning Board Guidelines on Application for Open Storage and Port Back-up Uses (TPB PG-No. 13G)

- 1. On 14.4.2023, the Town Planning Board Guidelines for Application for Open Storage and Port Back-up Uses under Section 16 of the Town Planning Ordinance (TPB PG-No. 13G) were promulgated, which set out the following criteria for the various categories of area:
 - (a) Category 1 areas: favourable consideration will normally be given to applications within these areas, subject to no major adverse departmental comments and local objections, or the concerns of the departments and local residents can be addressed through the implementation of approval conditions. Technical assessments should be submitted if the proposed uses may cause significant environmental and traffic concerns;
 - (b) Category 2 areas: planning permission could be granted on a temporary basis up to a maximum period of 3 years, subject to no adverse departmental comments and local objections, or the concerns of the departments and local residents can be addressed through the implementation of approval conditions. Technical assessments, where appropriate, should be submitted to demonstrate that the proposed uses would not have adverse drainage, traffic, visual, landscaping and environmental impacts on the surrounding areas;
 - (c) Category 3 areas: applications would normally not be favourably considered unless the applications are on sites with previous planning approvals (irrespective of whether the application is submitted by the applicant of previous approval or a different applicant). Sympathetic consideration may be given if genuine efforts have been demonstrated in compliance with approval conditions of the previous planning applications and/or relevant technical assessments/proposals have been included in the fresh applications, if required, to demonstrate that the proposed uses would not generate adverse drainage, traffic, visual, landscaping and environmental impacts on the surrounding areas. Planning permission could be granted on a temporary basis up to a maximum period of 3 years, subject to no adverse departmental comments and local objections, or the concerns of the departments and local residents can be addressed through the implementation of approval conditions; and
 - (d) Category 4 areas: applications would normally be rejected except under exceptional circumstances. For applications on sites with previous planning approvals (irrespective of whether the application is submitted by the applicant of previous approval or a different applicant), and subject to no adverse departmental comments and local objections, sympathetic consideration may be given if genuine efforts have been demonstrated in compliance with approval conditions of the previous planning applications and/or relevant technical assessments/proposals have been included in the fresh application, if required, to demonstrate that the proposed uses would not generate adverse drainage, traffic, visual, landscaping and environmental impacts on the surrounding areas. The intention is however to encourage the phasing out of such non-conforming uses as early as possible. A maximum period of 3 years may be allowed for an applicant to identify suitable sites for relocation. Application for renewal of approval will be assessed on its individual merits.

- 2. In assessing applications for open storage and port back-up uses, the other major relevant assessment criteria are also summarised as follows:
 - (a) port back-up sites and those types of open storage generating adverse noise, air pollution, visual intrusion and frequent heavy vehicle traffic should not be located adjacent to sensitive receivers such as residential dwellings, hospitals, schools and other community facilities;
 - (b) port back-up uses are major generators of traffic, with container trailer/tractor parks generating the highest traffic per unit area. In general, port back-up sites should have good access to the strategic road network, or be accessed by means of purpose built roads;
 - (c) adequate screening of sites through landscaping and/or fencing should be considered where sites are located adjacent to public roads or are visible from surrounding residential areas:
 - (d) there is a general presumption against conversion of active or good quality agricultural land and fish ponds to other uses on an ad-hoc basis. For flood prone areas or sites which would obstruct natural drainage channels and overland flow, advice should be sought;
 - (e) for applications involving sites with previous planning approvals, should there be no evidence to demonstrate that the applicants have made any genuine effort to comply with the approval conditions of the previous planning applications, planning permission may be refused notwithstanding other criteria set out in the Guidelines are complied with; and
 - (f) having considered that the open storage and port back-up uses have a role to play in Hong Kong's economy and provide considerable employment opportunities, and the operators/uses affected by resumption and clearance operations of the Government to make way for developments may face difficulties in finding a replacement site, sympathetic consideration could be given to such type of applications, except those involving land in Category 4 area (only minor encroachment may be allowed), if the following criteria are met:
 - (i) policy support is given by the relevant bureau(x) to the application for relocation of the affected uses/operations to the concerned sites; and
 - (ii) no adverse departmental comments and local objections, or the concerns could be addressed by approval conditions.

Previous s.16 Application covering the Application Site (the Site)

Approved Application

Application No.	Use/Development	Date of Consideration
A/YL-KTN/962	Proposed Temporary Open Storage of	8.12.2023
	Construction Machinery and Materials for	[revoked on 22.3.2024]
	a Period of Three Years and Filling of	
	Land	

<u>Similar s.16 Applications within the same "AGR" Zone on the OZP in the Vicinity of the Site in the Past Five Years</u>

Approved Applications

	Application No.	Use/Development	Date of Consideration
1.	A/YL-KTN/994	Proposed Temporary Open Storage of	7.6.2024
		Construction Materials for a Period of	
		Three Years and Associated Filling of	
		Land	
2.	A/YL-KTN/1019	Proposed Temporary Open Storage of	19.7.2024
		Construction Machineries and	
		Materials with Ancillary Facilities for a	
		Period of Three Years and Filling of	
		Land	
3.	A/YL-KTN/1040	Temporary Open Storage for	20.9.2024
		Construction Materials and Warehouse	
		for a Period of Three Years and	
		Associated Filling of Land	
4.	A/YL-KTN/1054	Proposed Temporary Warehouse and	22.11.2024
		Open Storage of Construction	
		Materials and Machineries for a Period	
		of Three Years and Associated Filling	
		of Land	

Government Departments' General Comments

1. Land Administration

Comments of the District Lands Officer/Yuen Long, Lands Department:

- no adverse comment on the application; and
- the application site (the Site) comprises five Old Schedule Agricultural Lots held under the Block Government Lease which contains the restriction that no structures are allowed to be erected without the prior approval of the Government.

2. Traffic

Comments of the Commissioner for Transport:

- no adverse comment on the application from traffic engineering perspective; and
- detailed advisory comments are at Appendix V.

Comments of the Chief Highway Engineer/New Territories West, Highways Department:

- no adverse comment on the application from highways maintenance perspective; and
- detailed advisory comments are at **Appendix V**.

3. Drainage

Comments of the Chief Engineer/Mainland North, Drainage Services Department:

- no in-principle objection to the application from public drainage point of view;
- should the application be approved, conditions should be stipulated requiring the submission of a revised drainage proposal and the implementation and maintenance of the revised drainage proposal for the development to the satisfaction of the Director of Drainage Services or of the Town Planning Board; and
- detailed advisory comments are at **Appendix V**.

4. Environment

Comments of the Director of Environmental Protection:

- no objection to the application;
- there was no environmental complaint received against the Site in the past three years; and
- detailed advisory comments are at **Appendix V**.

5. Fire Safety

Comments of the Director of Fire Services:

- no in-principle objection to the application subject to fire service installations (FSIs) being provided to his satisfaction;
- the submitted FSIs proposal is considered acceptable; and
- detailed advisory comments are at **Appendix V**.

6. <u>Landscape Aspect</u>

Comments of the Chief Town Planner/Urban Design and Landscape, Planning Department:

- no objection to the application from landscape planning perspective;
- based on the aerial photo of 2023, the Site is located in a settled valley landscape character comprising farmland, temporary structures, scattered tree groups and woodland in the "Conservation Area" zone to the northeast. The applied use is not incompatible with the landscape setting in the proximity;
- based on the site photos of 2024, the Site is fenced-off and hard paved. Storage of construction materials and some temporary structures are observed within the Site. A tree of common species is observed in the east of the Site. According to the Application Form, no tree felling is involved. Significant adverse landscape impact arising from the applied use is not anticipated; and
- detailed advisory comments are at **Appendix V**.

7. **Building Matters**

Comments of the Chief Building Surveyor/New Territories West, Buildings Department:

- no objection to the application; and
- detailed advisory comments are at **Appendix V**.

8. <u>District Officer's Comments</u>

Comments of the District Officer (Yuen Long), Home Affairs Department:

• his office has not received any local's comment on the application.

9. Other Departments

The following government departments have no objection to/no comment on the application and their advisory comments, if any, are at Appendix V:

- Project Manager (West), Civil Engineering and Development Department;
- Chief Engineer/Construction, Water Supplies Department; and
- Director of Electrical and Mechanical Services.

Recommended Advisory Clauses

- (a) failure to reinstate the application site (the Site) as required under the relevant approval condition upon expiry of the planning permission might constitute an unauthorized development under the Town Planning Ordinance and be subject to enforcement and prosecution actions;
- (b) prior planning permission should have been obtained before commencing the applied use at the Site;
- (c) the permission is given to the development and structures under application. It does not condone any other development and structures which currently occur on the Site but not covered by the application. Immediate action should be taken to discontinue such development and remove such structures not covered by the permission;
- (d) should the applicant fail to comply with any of the approval conditions again resulting in revocation of the planning permission, sympathetic consideration may not be given by the Rural and New Town Planning Committee/Town Planning Board to any further application;
- (e) to resolve any land issues relating to the applied use with the concerned owner(s);
- (f) to note the comments of the Commissioner for Transport that:
 - the Site is connected to the public road network via a section of a local access road which is not managed by the Transport Department. The land status of the local access road should be checked with the Lands Department. Moreover, the management and maintenance responsibilities of the local access road should be clarified with the relevant lands and maintenance authorities accordingly. Sufficient manoeuvring space shall be provided within the Site. No vehicle is allowed to queue back to or reverse onto/from public road at any time during the planning approval period;
- (g) to note the comments of the Chief Highway Engineer/New Territories West, Highways Department (HyD) that:
 - HyD shall not be responsible for the maintenance of proposed access connecting the Site (i.e. Shui Mei Road and the local access road). Shui Mei Road is not maintained by HyD; and
 - adequate drainage measures shall be provided to prevent surface water running from the Site to the nearby public roads and drains;
- (h) to note the comments of the Director of Environmental Protection that:
 - the applicant is advised to follow the relevant mitigation measures and requirements in the revised 'Code of Practice on Handling the Environmental Aspects of Temporary Uses and Open Storage Sites' to minimise any potential environmental nuisance caused by the applied use;

- (i) to note the comments of the Chief Engineer/Mainland North, Drainage Services Department:
 - according to the photos submitted in the drainage proposal, the existing fencing appears blocking the overland flow from the northern side of the Site, while there is no sufficient surface channel provided (e.g. viewpoint 3). Also, the existing drains do not serve to collect surface runoff effectively (e.g. viewpoints 5 to 7). Please review the drainage design in this regard;
- (j) to note the comments of the Director of Fire Services (D of FS) that:
 - the applicant is advised that the good practice guidelines for open storage (Appendix VII) shall be adhered to;
 - the installation/maintenance/modification/repair work of fire service installations shall be undertaken by a Registered Fire Service Installation Contractor (RFSIC). The RFSIC shall after completion of the installation/maintenance/modification/repair work issue to the person on whose instruction the work was undertaken a certificate (F.S. 251) and forward a copy of the certificate to D of FS; and
 - if any proposed structures are required to comply with the Buildings Ordinance (BO) (Cap. 123), detailed fire services requirements will be formulated upon receipt of formal submission of general building plans;
- (k) to note the comments of the Chief Town Planner/Urban Design and Landscape, Planning Department that:
 - the applicant is advised that approval of the application does not imply approval of tree works, if any, such as pruning, transplanting, felling and construction of tree pit. The applicant is reminded to seek comments and approval for any proposed tree works from the relevant department prior to the commencement of the works; and
 - noting that the concrete around the tree root collar will be removed, the applicant is reminded to ensure the tree safety and stability. The proposed concrete removal works within the tree protection zone should be approved by relevant department prior to commencement of works;
- (l) to note the comments of the Chief Building Surveyor/New Territories West, Buildings Department (BD) that:
 - before any new building works (including containers/open sheds as temporary buildings, demolition and land filling, etc.) are to be carried out on the Site, prior approval and consent of the Building Authority (BA) should be obtained, otherwise they are unauthorized building works (UBW) under the BO. An Authorized Person should be appointed as the co-ordinator for the proposed building works in accordance with the BO;
 - the Site shall be provided with means of obtaining access thereto from a street and emergency vehicular access in accordance with Regulations 5 and 41D of the Building (Planning) Regulations (B(P)R) respectively;
 - the Site does not abut on a specified street of not less than 4.5m wide and its permitted development intensity shall be determined under Regulation 19(3) of the B(P)R at

building plan submission stage;

- for UBW erected on leased land, enforcement action may be taken by BD to effect their removal in accordance with the prevailing enforcement policy against UBW as and when necessary. The granting of any planning approval should not be construed as an acceptance of any existing building works or UBW on the Site under the BO;
- any temporary shelters or converted containers for office, storage, washroom or other uses are considered as temporary buildings are subject to the control of Part VII of the B(P)R; and
- detailed checking under the BO will be carried out at building plan submission stage.

□Urgent □Return receipt □Expand	Group □Restricted □Prevent Copy	(
From: Sent: To: Subject:	2024-06-10 星期一 03:40:26 tpbpd/PLAND <tpbpd@pland.gov.hk> A/YL-KTN/1018 DD 107 Fung Kat Heung</tpbpd@pland.gov.hk>	
A/YL-KTN/1018		
Lots 1247 (Part), 1248 (Part), 12 Heung, Kam Tin	.49 (Part), 1252 (Part) and 1253 (Part) i	in D.D. 107, Fung Kat
Site area: About 1,559.5sq.m		
Zoning: "Agriculture"		
Applied development: Open Storof Land	rage of Construction Machinery / 2 Veh	icle Parking / Filling
Dear TPB Members,		
962 was rubber stamped on 8 Drushed through.	ec. Note that there was no discussion	on the 17 items
Applicant has not fulfilled condit	ions but is back for a larger site.	
No doubt this will again be whise look into matters as ordered by j	ked through with the members failing in udges in a number of JRs.	their duty to properly
Previous objections upheld and there are legitimate objections lo	I would remind members that streamlindged.	ning is not an option if
Mary Mulvihill	l .	•
From: To: tpbpd < tpbpd@pland.gov.l Date: Monday, 20 November 2 Subject: Re: A/YL-KTN/962 D	2023 2:53 AM HKT	
Lots 1252 (Part) and 1253	(Part) in D.D. 107, Fung Kat Heung, Ka	am Tin

Site area: About 1,013.5sq.m

□Urgent	□Return receipt	□Expand Group	□Restricted	□Prevent Copy

Zoning: "Agriculture"

Applied development: Open Storage of Construction Machinery / 2 Vehicle Parking / Filling of Land

Dear TPB Members,

Strong Objection. The application is part of a process to gradually convert the district into brownfield. No previous history of applications.

There is an outstanding application 920 for brownfield use on the adjoining lots that seems to be frozen, it does not appear on the current list of applications going through the process.

Members should question this and ask to see images of the conditions of the lots.

Much of Fung Kat Heung has been converted to brownfield, it is time to confine its expansion.

Mary Mulvihill

有關 (申請編號: A/YL-KTN/1018)意見

有關地段鄰近 CA 地及毗鄰不少住戶,雖然有政府部門對渠務及消防問題作出評估,但我們依然擔心露天存放建材會影響附近生態,而存放佔地面積,在兩季來臨時亦會影響水位上升,由於該地段太貼近民居、樹木及一堆鐵皮屋,萬一火災或水浸,必定有機會被波及,造成附近居民人命傷亡,請各位審慎考慮處理。

慽牕

附近居民字



致城市規劃委員會秘書:

專人送遞或郵遞:香港北角渣華道 333 號北角政府合署 15 樓

傅真:2877 0245 或 2522 8426

電郵: tpbpd@pland.gov.hk

To : Secretary, Town Planning Board

By hand or post: 15/F, North Point Government Offices, 333 Java Road, North Point, Hong Kong

By Fax: 2877 0245 or 2522 8426 By e-mail: tpbpd@pland.gov.hk

有關的規劃申請編號 The application no. to which the comment relates A/YL-KTN/1018Received on 16/09/2024

意見詳情 (如有需要,請另質說明)

Details of the Comment (use separate sheet if necessary)

		the street with the company
·		. William
All Marie 1988 and 1987 and 1987 and 1988	V- -	. www.contra . : CANTERIOR
••,	\$ 0.000 (200.000)	A commence of the first of the second of the second

「提意見人」姓名/名稱 Name of person/company making this commen

簽署 Signature

日期 Date

3/10/2024

元朗市中心及鄉郊東分區委員會

A/YL-KIN/ 1018

				Descript Com
∃Uraent	∐Return receipt	□Expand Group	⊔Restricted	□Prevent Copy

From:

Sent:

2024-10-15 星期二 08:00:00

To:

tpbpd/PLAND <tpbpd@pland.gov.hk>

Subject:

Comments on the Section 16 Application No. A/XI-KTN/1032

Attachment:

TPB20241015(KTN1018).pdf

Dear Sir/Madam,

Please refer to the attachment for the captioned.

Yours faithfully, Ng Hei Man (Mr.) Campaign Manager The Conservancy Association

Registered Name 註冊名稱: The Conservancy Association 長春社 (Incorporated in Hong Kong with limited liability by guarantee 於香港註冊成立的擔保有限公司)

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The Conservancy Association

15th October 2024

Town Planning Board
15/F North Point Government Offices
333 Java Road
North Point
Hong Kong

By e-mail: tpbpd@pland.gov.hk

Dear Sir/Madam,

Comments on the Section 16 Application No. A/YL-KTN/1018

The Conservancy Association (CA) OBJECTS to the captioned application.

1. Not in line with the planning intention of Agriculture (AGR) zone

According to the approved Kam Tin North Outline Zoning Plan (OZP) No. S/YL-KTN/11, the planning intention of AGR zone "is intended primarily to retain and safeguard good quality agricultural land/farm/fish ponds for agricultural purposes. It is also intended to retain fallow arable land with good potential for rehabilitation for cultivation and other agricultural purposes". While all the proposed uses are not related to agriculture, the entire site, according to the application, would be paved by concrete. We opine that this is not in line with the planning intention of AGR zone.

2. Adverse environmental impacts

We worry that there would be several potential adverse environmental impacts caused by the application:

- No plans on land recovery: As mentioned above the site would be entirely paved with concrete. However, no details are available to illustrate how the land would be recovered after the proposed temporary use.
- Potential adverse drainage impact: No sufficient details are available to justify
 that drainage impact would be properly handled. We worry that the proposed
 temporary use would largely change the hydrology of the site, and such change

The Conservancy Association

would affect the adjacent uses.

Yours faithfully, The Conservancy Association

Appendix VII of RNTPC Paper No. A/YL-KTN/1018B

Fire Services Department's Good Practice Guidelines for Open Storage Sites

		Internal Access for Fire Appliances	Lot Boundaries (Clear Width)	Distance between Storage Cluster and Temporary Structure	Cluster Size	Storage Height
1.	Open Storage of Containers		2m	4.5m		
2.	Open Storage of Non-combustibles or Limited Combustibles	4.5m	2m	4.5m		
3.	Open Storage of Combustibles	4.5m	2m	4.5m	40m x 40m	3m

Remarks: Smoking and naked flame activities shall not be allowed within the open storage/recycling site.