8 AUG 2022

The term Praving Board will formally acknowledge the date of receipt of the application only upon receipt of all the required information and documents.

<u>Form No. S16-III</u> 表格第 S16-III 號

APPLICATION FOR PERMISSION UNDER SECTION 16 OF THE TOWN PLANNING ORDINANCE (CAP.131)

根據《城市規劃條例》(第131章) 第16條遞交的許可申請

Applicable to Proposal Only Involving Temporary Use/Development of Land and/or Building Not Exceeding 3 Years in Rural Areas or Renewal of Permission for such Temporary Use or Development*

適用於祇涉及位於鄉郊地區土地上及/或建築物內進行為期不超過三年的臨時用途/發展或該等臨時用途/發展的許可續期的建議*

*Form No. S16-I should be used for other Temporary Use/Development of Land and/or Building (e.g. temporary use/developments in the Urban Area) and Renewal of Permission for such Temporary Use or Development.

*其他土地上及/或建築物內的臨時用途/發展 (例如位於市區內的臨時用途或發展)及有關該等臨時用途/發展的許可續期,應使用表格第 S16-I 號。

Applicant who would like to publish the <u>notice of application</u> in local newspapers to meet one of the Town Planning Board's requirements of taking reasonable steps to obtain consent of or give notification to the current land owner, please refer to the following link regarding publishing the notice in the designated newspapers: https://www.info.gov.hk/tpb/en/plan_application/apply.html

申請人如欲在本地報章刊登<u>申請通知</u>,以採取城市規劃委員會就取得現行土地擁有人的同意或通知現行土地擁有人所指定的其中一項合理步驟,請瀏覽以下網址有關在指定的報章刊登通知: https://www.info.gov.hk/tpb/tc/plan_application/apply.html

General Note and Annotation for the Form

填寫表格的一般指引及註解

- "Current land owner" means any person whose name is registered in the Land Registry as that of an owner of the land to which the application relates, as at 6 weeks before the application is made 「現行土地擁有人」指在提出申請前六星期,其姓名或名稱已在土地註冊處註冊為該申請所關乎的
 - 土地的擁有人的人
- & Please attach documentary proof 請夾附證明文件
- ^ Please insert number where appropriate 請在適當地方註明編號

Please fill "NA" for inapplicable item 請在不適用的項目填寫「不適用」

Please use separate sheets if the space provided is insufficient 如所提供的空間不足,請另頁說明

Please insert a 「レ」 at the appropriate box 請在適當的方格内上加上「レ」號

For Official Use Only	Application No. 申請編號	A176-KTM 857
請勿填寫此欄	Date Received 收到日期	8 AUG 2022

- 1. The completed form and supporting documents (if any) should be sent to the Secretary, Town Planning Board (the Board), 15/F, North Point Government Offices, 333 Java Road, North Point, Hong Kong. 申請人須把填妥的申請表格及其他支持申請的文件(倘有),送交香港北角渣華道 333 號北角政府合署 15 櫻城市規劃委員會(下稱「委員會」)秘書收。
- 2. Please read the "Guidance Notes" carefully before you fill in this form. The document can be downloaded from the Board's website at http://www.info.gov.hk/tpb/. It can also be obtained from the Secretariat of the Board at 15/F, North Point Government Offices, 333 Java Road, North Point, Hong Kong (Tel: 2231 4810 or 2231 4835), and the Planning Enquiry Counters of the Planning Department (Hotline: 2231 5000) (17/F, North Point Government Offices, 333 Java Road, North Point, Hong Kong and 14/F, Sha Tin Government Offices, 1 Sheung Wo Che Road, Sha Tin, New Territories). 請先細閱《申請須知》的資料單張,然後填寫此表格。該份文件可從委員會的網頁下載(網址: http://www.info.gov.hk/tpb/),亦可向委員會秘書處(香港北角渣華道 333 號北角政府合署 15 樓 電話: 2231 4810 或 2231 4835)及規劃署的規劃資料查詢處(熱線: 2231 5000) (香港北角渣華道 333 號北角政府合署 17 樓及新界沙田上禾遊路 1 號沙田政府合署 14 樓)索取。
- 3. This form can be downloaded from the Board's website, and obtained from the Secretariat of the Board and the Planning Enquiry Counters of the Planning Department. The form should be typed or completed in block letters. The processing of the application may be refused if the required information or the required copies are incomplete. 此表格可從委員會的網頁下載,亦可向委員會秘書處及規劃署的規劃資料查詢處索取。申請人須以打印方式或以正楷填寫表格。如果申請人所提交的資料或文件副本不齊全,委員會可拒絕處理有關申請。

1. Name of Applicant 申請人姓名/名稱

(□Mr. 先生 /□Mrs. 夫人 /□Miss 小姐 /□Ms. 女土 / 【Company 公司 /□ Organisation 機構)

宏力建材有限公司 POWER STEEL METAL COMPANY LIMITED

2. Name of Authorised Agent (if applicable) 獲授權代理人姓名/名稱(如適用)

(′□Mr. 先生 / □Mrs. 夫人 / □Miss 小姐 / □Ms. 女士 / ♥ Company 公司 / □ Organisation 機構)

全堅土地行政師行(香港)有限公司 ALLGAIN LAND ADMINISTRATORS(HONG KONG) LIMITED

3.	Application Site 申請地點	
(a)	Full address / location / demarcation district and lot number (if applicable) 詳細地址/地點/丈量約份及地段號碼(如適用)	新界元朗錦田丈量約份第109約第1170號餘段 Lot 1170 RP in D.D. 109, Kam Tin, Yuen Long, N.T.
(b)	Site area and/or gross floor area involved 涉及的地盤面積及/或總樓面面積	☑Site area 地盤面積 1,640 sq.m 平方米☑About 約 ☑Gross floor area 總樓面面積 300 sq.m 平方米☑About 約
(c)	Area of Government land included (if any) 所包括的政府土地面積(倘有)	N/A sq.m 平方米 □About 約

(d)	Name and number of the related statutory plan(s) 有關法定圖則的名稱及編號	錦田北分區計劃大綱核准岡編號 S/YL-KTN/9 APPROVED KAM TIN NORTH OUTLINE ZONING PLAN NO. S/YL-KTN/9
'(e)	Land use zone(s) involved 涉及的土地用途地帶	Agriculture 「農業」
(f)	Current use(s) 現時用途	現時是空置的
	·	(If there are any Government, institution or community facilities, please illustrate or plan and specify the use and gross floor area) (如有任何政府、機構或社區設施,譜在圖則上顯示,並註明用途及總樓面面積)
4.	"Current Land Owner" of A	pplication Site 申請地點的「現行土地擁有人」
The	applicant 申請人 —	
	is the sole "current land owner"#& (p 是唯一的「現行土地擁有人」#& (f	lease proceed to Part 6 and attach documentary proof of ownership). 青繼續填寫第 6 部分,並夾附業權證明文件)。
		(please attach dogumentom una f. S
\triangle	is not a "current land owner". 並不是「現行土地擁有人」"。	
	The application site is entirely on Go 申請地點完全位於政府土地上(請	vernment land (please proceed to Part 6). 纖續填寫第 6 部分)。
5.	Statement on Owner's Conse	
(a)	approation involves a total of	the Land Registry as at
(b)	The applicant 申請人 –	
	has obtained consent(s) of	"current land owner(s)".
	已取得 名「	現行土地擁有人」"的同意。
	Details of consent of "current l	and owner(s)" botained 取得「現行土地擁有人」"同意的詳情
	No. of 'Current Land Owner(s)' 「現行士物擁有	address of premises as shown in the record of the Land ere consent(s) has/have been obtained : 冊處記錄已獲得同意的地段號碼/處所地址 (日/月/年)
	·	
	(Please use separate sheets if the spa	ce of any box above is insufficient. 如上列任何方格的空間不足,請另頁說明)
		- 《

TOTAL TION OF O THE PURITY OF O THE MA

De	tails of the "cur	rent land own	er(s)" # notified	i 已獲通知	「現行土地擁有	有人」"的	詳細資料
La r	. of 'Current nd Owner(s)' 現行土地擁 人」數目	Land Registr	y where notific	cation(s) has/h	n in the record nave been given 殳號碼/處所均	of the g	Date of notification iven DD/MM/YYYY) 通知日期(日/月/年
			<u>.</u>				
		,					
			•	÷			
(Plea	se use separate s	heets if the space	e of any box abo	ove is insufficie	nt. 如上列任何	方格的空間	不足・請另頁說明
	aken reasonabl 和合理步驟以	_					
Reas	onable Steps to	Obtain Cons	ent of Owner(s) 取得土地	擁有人的同意	<u> </u>	<u>今理步驟</u>
	sent request fo	or consent to th	ne "current land 月/年)向每一	d owner(s)" or 名「現行土地	ı z擁有人 」"郵返		(DD/MM/YYYY) (書 ^{&}
Reas	Reasonable Steps to Give Notification to Owner(s) 向土地擁有人發出通知所採取的合理步驟						
] published notices in local newspapers on(DD/MM/YYYY) ^{&} 於(日/月/年)在指定報章就申請刊登一次通知 ^{&}						
	-	-	position on or		ion site/premise	es on	
	於 01/08/2	2022(白/	月/年)在申請5	地點/申請處	的或附近的關	明位置貼	出關於該申請的遊
	office(s) or run	ral committee	on 02/08	<u>3/2022</u> (DD/MM/YYY	Υ) ^{&}	mmittee(s)/manago
	處,或有關的						•
Othe	ers 其他			•			·
	others (please 其他(請指明						
-					1		
	-						
_				,			· · · · · · · · · · · · · · · · · · ·
-			•				

6. Type(s) of Application	He delt store tree	
-JP-(5) 5x 1xp prication		· · · · · · · · · · · · · · · · · · ·
证的郊外地區土地上及 (For Renewal of Permission	/或建築物內進行為期不超	elopment in Rural Areas, please proceed to Part (B))
(ションの)口になくとなったりと 日本市 中田 は () 八	720/50/00 01770 到計刊續期,請	[現爲(B)部分)
(a) Proposed use(s)/development 擬議用途/發展	Temporary Place of 臨時康體文娛場所(Recreation, Sports or Culture (Hobby Farm) 休閒農場)
	(Please illustrate the details of th	e proposal on a layout plan) (請用平面圖說明擬議詳情)
(b) Effective period of permission applied for	☑ year(s) 年 _	3
申請的許可有效期	□ month(s) 個月	
(c) <u>Development Schedule 發展</u> 經	· 	
Proposed uncovered land area	擬議露天土地面積	1490sq.m About 約
Proposed covered land area 掇	議有上蓋土地面積	150 sq.m √About ∰
Proposed number of buildings.	/structures 擬議建築物/構築	
Proposed domestic floor area		OAbout 約
Proposed non-domestic floor a		300 sq.m About 約
Proposed gross floor area 擬誵		300 sq.mv/About #9
構築物1:辦公室及接待處,2 構築物2:更衣室及洗手間,2	· separate sneets if the space bell · · · · · · · · · · · · · · · · · · ·	ires (if applicable) 建築物/構築物的擬議高度及不同樓層low is insufficient) (如以下空間不足,請另頁說明) 即
構築物4:儲物室,2層高,每	層約37.5平方米,總面積約75	平方米,高度不多於7米。
Proposed number of car parking sp	paces by types 不同種類停車化	立的擬議數目
Private Car Parking Spaces 私家国		1
Motorcycle Parking Spaces 電單	車車位	0
Light Goods Vehicle Parking Space	es 輕型貨車泊車位	0
Medium Goods Vehicle Parking S	paces 中型貨車泊車位	0
Heavy Goods Vehicle Parking Spa	ces 重型貨車泊車位	<u> </u>
Others (Please Specify) 其他 (請	列9月)	······0
Proposed number of loading/unload	ding spaces 上茲家貨車价的指	承織也 日
Taxi Spaces 的土車位	20 17 17 17 17 17 17 17 17 17 17 17 17 17	_
Coach Spaces 旅遊巴車位		0
Light Goods Vehicle Spaces 輕型	貨車車价	***************************************
Medium Goods Vehicle Spaces 中	型貨車車位	<u>0</u>
Heavy Goods Vehicle Spaces 重型	貨車車位	0
Others (Please Specify) 其他 (請	刘明)	0
<u> </u>		

					<u> </u>		
Prop	osed operating hours	擬議營運	時間		•		
鶯	業時間為星期一	至星期E	1早上9)時3	至下午6時,包括公眾假	期。	
(d)	Any vehicular accethe site/subject build是否有車路通往均有關建築物?	ess to ling? 乜盤/	/es 是 lo 否	☆	There is an existing access appropriate) 有一條現有車路。(請註明單從治河路轉入 There is a proposed access. (p有一條擬議車路。(請在圖	車路名稱(如適用)) lease illustrate on plan	and specify the width)
(a)	Impacts of Developr			苏格	展計期的影響		
(e)	(If necessary, please	use separa for not p	te sheets roviding	s to in	dicate the proposed measures measures. 如需要的話,請		
(ii)	Does the development proposal involve alteration of existing building? 擬議發展計劃是否包括現有建築物的改動? Does the development proposal involve the operation on the right? 擬議發展是否涉及右列的工程?	Yes 是 No 否 Yes 是	(Pl div (請 简	bease i i version f用地级 Div Filli Are Dep Pep Less Are Are Are	provide details 請提供詳情 Indicate on site plan the boundary of the extent of filling of land/pond(s) a BET THE THE THE THE THE THE THE THE THE T	of concerned land/pond(s), ind/or excavation of land) 以及河道改道、填塘、填土	and particulars of stream 上及/或挖土的細節及/或 一About 約 一About 約 一About 約
		No 否		Dep	tn of excavation 投工深長	······································	⊔About #ÿ
(iii)	Would the development proposal cause any, adverse impacts? 擬議發展計劃會否造成不良影響?	On envir On traffic On water On drain On slope Affected Landscap Tree Fell Visual In	onment c 對交致 supply age 對抗 s 對斜 by slope be Impac ling 砍 npact 栉	通對非皮 s t 伐成 安構樹花	:水 斜坡影響 成景觀影響 木	Yes 會 □ Yes 會 □ □ Yes 會 會 □ Yes 會 □ □ Yes 會 □ □ Yes	No N
	,	•					

Form No. S16-III 表格第 S16-III 號

· 詩註明	state measure(s) to minimise the impact(s). For tree felling, please state the number, or at breast height and species of the affected trees (if possible) 盡量減少影響的措施。如涉及砍伐樹木,謂說明受影響樹木的數目、及胸高度的樹及品種(倘可)
在申	請地點做好排水工程 2004年末
	<u> </u>
(B) Renewal of Permission for 位於鄉郊地區臨時用途/劉	r Temporary Use or Development in Rural Areas 族展的許可續期
(a) Application number to which the permission relates 與許可有關的申請編號	A//
(b) Date of approval 獲批給許可的日期	(DD 日/MM 月/YYYY 年)
(c) Date of expiry 許可屆滿日期	(DD 日/MM 月/YYYY 年)
(d) Approved use/development 已批給許可的用途/發展	
	□ The permission does not have any approval condition 許可並沒有任何附帶條件 □ Applicant has complied with all the approval conditions
	申請人已履行全部附帶條件 Applicant has not yet complied with the following approval condition(s): 申請人仍未履行下列附帶條件:
(e) Approval conditions 附帶條件	
	Reason(s) for non-compliance: 仍未履行的原因:
	(Please use separate sheets if the space above is insufficient)
(f) Renewal period sought 要求的續期期間	(如以上空間不足,請另頁說明) □ year(s) 年 □ month(s) 個月

7. Justification	ns理由			
The applicant is invi 現請申請人提供申詞	ted to provide justificat 請理由及支持其申請的	tions in support of the 内資料。如有需要,	application. Use separa 謂另頁說明)。	te sheets if necessary.
請參考附件的	的申請報告書及擬 認	義發展的計劃細領		

~	************	***************************************	********	
***************************************		***************************************		
	•••••		************************	
************************			***************************************	
		•••••		
************	•••••	• • • • • • • • • • • • • • • • • • • •		
	•••••••		· · · · · · · · · · · · · · · · · · ·	
	***************************************	,		
		***************************************	***************************************	

8. Declaration 聲明	
I hereby declare that the particulars given in this application are correct 本人謹此聲明,本人就這宗申請提交的資料,據本人所知及所信,	均屬真質無誤。
I hereby grant a permission to the Board to copy all the materials submitt to the Board's website for browsing and downloading by the public free 本人現准許委員會酌情將本人就此申請所提交的所有資料複製及/享	-oi-charge at the Board's discretion. 以上戦至委員會網站・供公眾免費瀏覽或下載。
Signature	icant 申請人 / ☑ Authorised Agent 獲授權代理人
Ms Hermose Chong	Manager
Name in Block Letters 姓名(請以正楷填寫)	Position (if applicable) 職位 (如適用)
│ │ │ │ │ │ │ │ │ │ │ │ │ │ │ │ │ │ │	HKIA 香港建築師學會 / HKIE 香港工程師學會 / HKIUD 香港城市設計學會
Others 其他 on behalf of ALLGAIN LAND ADMINISTRATORS (HONG	全型土地
☑ Company 公司 / ☐ Organisation Name and Chop (if	fapplicable)機構名稱及蓋章(如適用)
Date 日期 02/08/2022 (DD/MN	
Remark 備註	
The materials submitted in this and in this and in the same in the	·

The materials submitted in this application and the Board's decision on the application would be disclosed to the public. Such materials would also be uploaded to the Board's website for browsing and free downloading by the public where the Board considers appropriate.

委員會會向公眾披露申請人所遞交的申請資料和委員會對申請所作的決定。在委員會認為合適的情況下,有關申請 資料亦會上載至委員會網頁供公眾免費瀏覽及下載。

Warning 警告

Any person who knowingly or wilfully makes any statement or furnish any information in connection with this application, which is false in any material particular, shall be liable to an offence under the Crimes Ordinance. 任何人在明知或故意的情况下,就這宗申請提出在任何要項上是虛假的陳述或資料,即屬違反《刑事罪行條例》。

Statement on Personal Data 個人資料的聲明

- 1. The personal data submitted to the Board in this application will be used by the Secretary of the Board and Government departments for the following purposes: 委員會就這宗申請所收到的個人資料會交給委員會秘書及政府部門,以根據《城市規劃條例》及相關的城市規劃等例,以根據《城市規劃條例》及相關的城市規劃等例。
 - (a) the processing of this application which includes making available the name of the applicant for public inspection when making available this application for public inspection; and 處理這宗申請,包括公布這宗申請供公眾查閱,同時公布申請人的姓名供公眾查閱:以及
 - (b) facilitating communication between the applicant and the Secretary of the Board/Government departments. 方便申請人與委員會秘書及政府部門之間進行聯絡。
- 2. The personal data provided by the applicant in this application may also be disclosed to other persons for the purposes mentioned in paragraph 1 above. 申請人就這宗申請提供的個人資料,或亦會向其他人士披露,以作上述第 1 段提及的用途。
- 3. An applicant has a right of access and correction with respect to his/her personal data as provided under the Personal Data (Privacy) Ordinance (Cap. 486). Request for personal data access and correction should be addressed to the Secretary of the Board at 15/F, North Point Government Offices, 333 Java Road, North Point, Hong Kong. 根據《個人資料(私隱)條例》(第 486 章)的規定,申請人有權查閱及更正其個人資料。如欲查閱及更正個人資料,應向委員會秘書提出有關要求,其地址為香港北角渣華道 333 號北角政府合署 15 樓。

Gist of Applica	ation 申請摘要
consultees, uploaded available at the Plant (請 <u>盡量</u> 以英文及中	ails in both English and Chinese <u>as far as possible</u> . This part will be circulated to relevant to the Town Planning Board's Website for browsing and free downloading by the public and ning Enquiry Counters of the Planning Department for general information.) 文填寫。此部分將會發送予相關諮詢人士、上載至城市規劃委員會網頁供公眾免費瀏覽及 勘資料查詢處供一般參閱。)
Application No.	(For Official Use Only) (請勿填寫此欄)
中請編號	
,	
Location/address	
位置/地址	新界元朗錦田丈量約份第109約第1170號餘段
	Lot 1170 RP in D.D. 109, Kam Tin, Yuen Long, N.T.
Site area	1640 sq. m 平方米 ☑ About 約
地盤面積	
	(includes Government land of 包括政府土地 0 sq. m 平方米 □ About 約)
Plan	
圖則	錦田北分區計劃大綱核准圖編號 S/YL-KTN/9
	APPROVED KAM TIN NORTH OUTLINE ZONING PLAN NO. S/YL-KTN/9
Zoning	
地帶	·
	Agriculture 「農業」
Type of Application	☑ Temporary Use/Development in Rural Areas for a Period of 位於鄉郊地區的臨時用途/發展為期
申請類別	
	☑Year(s) 年 <u>3</u> □ Month(s) 月
•	
	□ Renewal of Planning Approval for Temporary Use/Development in Rural Areas for a Period of 位於鄉郊地區臨時用途/發展的規劃許可續期為期
	□ Year(s) 年 □ Month(s) 月
Applied use/	
development	
申請用途/發展	The state of the s
	Temporary Place of Recreation, Sports or Culture (Hobby Farm)
	臨時康體文娛場所 (休閒農場)

	sq.m 平方米	Plot F	Plot Ratio 地積比率	
住用	不多於	an O	□About 約 □Not more than 不多於	
非住用	☑ About 約 300 □ Not more tha 不多於	en 0.183	☑About 約 □Not more than 不多於	
住用	0			
Non-domestic 非住用	4			
Domestic 住用	. 0	□ (Not 1	m 米 more than 不多於	
	. 0	□ (Not n	Storeys(s) 層 nore than 不多於	
Non-domestic 非住用	7	☑ (Not n	m 米 ☑(Not more than 不多於	
	2	☑ (Not m	Storeys(s) 層 nore than 不多於)	
	9.15		☑ About 約	
Total no. of vehicle	parking spaces 停車位總數		1個私家車車位	
Motorcycle Parking Light Goods Vehicl Medium Goods Veh Heavy Goods Vehic Others (Please Spec	Spaces 電單車車位 e Parking Spaces 輕型貨車泊車 nicle Parking Spaces 中型貨車》 de Parking Spaces 重型貨車泊車 ify) 其他 (請列明)	5 #5 Ar	1 0 0 0 0 0	
Total no. of vehicle le 上落客貨車位/停	oading/unloading bays/lay-bys 車處總數		0	
Coach Spaces 旅遊 Light Goods Vehicle Medium Goods Vehi	巴車位 Spaces 輕型貨車車位 icle Spaces 中型貨車位 e Spaces 重型貨車車位		0 0 0 0	
	Non-domestic 非住用 Domestic 住用 Non-domestic 非住用 Domestic 住用 Domestic 住用 Non-domestic 非住用 Non-domestic 非住用 Total no. of vehicle Private Car Parking Motorcycle Parking Light Goods Vehicle Medium Goods Vehicle Neavy Goods Vehicle Private Car Parking Light Goods Vehicle Medium Go	Domestic 住用	Domestic 住用	

	Chinese 中文	English 英文
Plans and Drawings 圖則及繪圖		
Master layout plan(s)/Layout plan(s) 總綱發展藍圖/布局設計圖		\square
Block plan(s) 樓宇位置圖		
Floor plan(s) 樓宇平面圖		
Sectional plan(s) 截視圖		
Elevation(s) 立視圖		
Photomontage(s) showing the proposed development 顯示擬議發展的合成照片	□.	
Master landscape plan(s)/Landscape plan(s) 園境設計總圖/園境設計圖		
Others (please specify) 其他(請註明)		\square
Location Plan 位置圖, Site Plan 地盤平面圖		
Reports 報告書		
Planning Statement/Justifications 規劃綱領/理據	Ø	
Environmental assessment (noise, air and/or water pollutions)		
環境評估(噪音、空氣及/或水的污染)		
Traffic impact assessment (on vehicles) 就車輛的交通影響評估		
Traffic impact assessment (on pedestrians) 就行人的交通影響評估		
Visual impact assessment 視覺影響評估		
Landscape impact assessment 景觀影響評估		
Tree Survey 樹木調查	□:	
Geotechnical impact assessment 土力影響評估	· 🔲	
Drainage impact assessment 排水影響評估		
Sewerage impact assessment 排污影響評估		
Risk Assessment 風險評估		. 🗆
Others (please specify) 其他(請註明)		
<u> </u>		

Note: The information in the Gist of Application above is provided by the applicant for easy reference of the general public. Under no circumstances will the Town Planning Board accept any liabilities for the use of the information nor any inaccuracies or discrepancies of the information provided. In case of doubt, reference should always be made to the submission of the applicant. 註: 上述申請摘要的資料是由申請人提供以方便市民大眾參考。對於所載資料在使用上的問題及文義上的歧異,城市規劃委員

會概不負責。若有任何疑問,應查閱申請人提交的文件。

根據《城市規劃條例》(第131章) 第16條遞交的許可申請

新界元朗錦田丈量約份第 109 約第 1170 號餘段 擬議臨時康體文娛場所(休閒農場)(為期 3 年)

申請報告書及擬議發展的計劃細節

目 錄

1.	擬議發展細節P.1
2.	申請原因P.2
3.	擬議發展計劃的各方面影響P.3-6

擬議發展細節

- 1. 申請人現根據《城市規劃條例》(第131章)第16條,提交有關新界元朗 錦田丈量約份第109約第1170號餘段的規劃申請,擬在上述地段申請為 期三年的臨時康體文娛場所(休閒農場)。
- 2. 申請地點位於元朗錦田治河路,在《錦田北分區計劃大綱核准圖編號 S/YL-KTN/9》上劃為「農業」用途。
- 3. 申請地盤面積為約 1,640 平方米,上蓋總面積為 300 平方米,露天地方面 積為 1,490 平方米(其中包括耕種面積約 1,107 平方米;現有泥地面積約 383 平方米)。
- 4. 申請地點將設有四個構築物、總樓面面積合共約300平方米。 構築物1:辦公室及接待處、2層高、每層約37.5平方米、總面積約75平方米、高度不多於7米;構築物2:更衣室及洗手間、2層高、每層約37.5平方米、總面積約75平方米、高度不多於7米;構築物3:農業教育室及會議室、2層高、每層約37.5平方米、總面積約75平方米、高度不多於7米;構築物4:儲物室、2層高、每層約37.5平方米、總面積約75平方米、高度不多於7米;構築物4:儲物室、2層高、每層約37.5平方米、總面積約75平方米、高度不多於7米。
- 5. 擬議發展的農場預計每天最多 2 名職員及 20 名訪客。
- 6. 申請地點亦涉及一個私家車泊車位,只供職員使用,不對外開放。
- 7. 申請地點可從錦田治河路前往,擬議發展的營運時間為每天上午九時正至下午六時正,包括星期日及公眾假期。

申請原因

- 1. 申請地點是農業地帶,而擬議用途為休閒農場,申請用途屬「農業」中的 「第二欄用途」,與規劃意向相符,和周邊環境及用途協調。
- 2. 在新農業政策下,休閒農場是指營運仍以商業務農為主,並以提供與其作業有關的有限度休閒活動為輔的農場,目的是擴大農民可推廣其農業產品和介紹其務農活動的平台。擬議發展能夠推廣可持續休閒耕種,符合政府推行的新農業政策,鼓勵市民參與綠化活動及透過種植活動提高綠化環保的意識。
- 3. 擬議發展只是臨時三年的性質,不會影響農業用途地帶的長遠規劃意向。
- 4. 擬議發展不會填土,不會破壞天然環境,不會砍伐樹木,不會對周邊地區 及環境帶來負面影響。

根據以上各點,申請人誠意懇求城市規劃委員會寬大批准新界元朗錦田丈量約份第 109 約第 1170 號餘段作為期不超過三年的臨時康體文娛場所(休閒農場)。

擬議發展計劃的各方面影響


1. 土地行政

申點地點涉及一個私家地段,不涉及任何政府土地。

擬議農場涉及四個上蓋構築物,如申請獲城規會批准,申請人將會向地政 處申請短期豁免書。

2. 擬議發展的農場入口

申請地點可從錦田治河路前往,地區道路的闊度約7-8米,足夠讓私家車行駛。而農地的入口設有約5米闊的大閘讓車駛進農場,下面為相關照片。

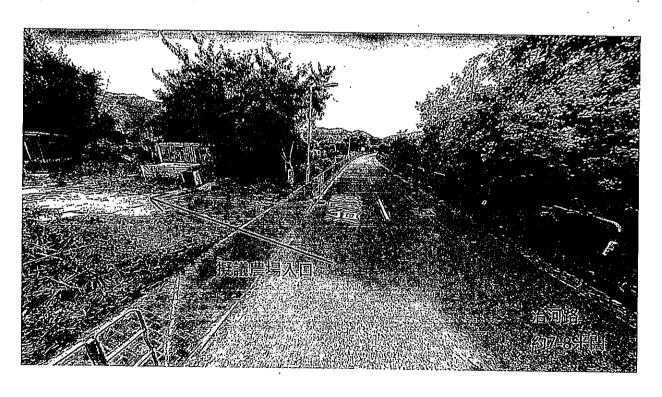


3. 農場內的交通安排

申請用途只提供一個私家車的職員泊車位,不設輕型貨車或其他車輛的上

落客或停車位,而私家車位的佔地面積約 2.5 米 x 5

4. 公共交通工具

訪客可從錦上路站,乘坐專線小巴路線 601 或 601B,在錦慶圍下車,然後步行約8分鐘,即能到達農場。

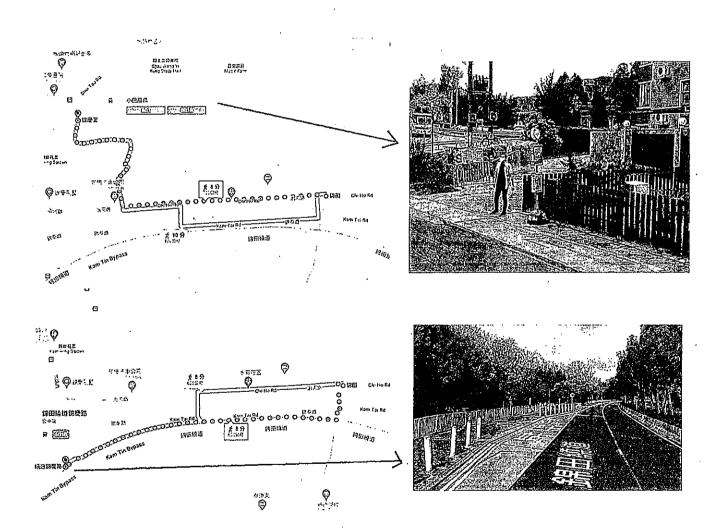

5. 預計交通流量報告

時段		星期	一至星期日,包括	舌公眾假期
		職員車輛(私家車)		
		進入(輛)	離開(輛)	 合共(輛)
繁忙時間	09:00 – 10:00	1	0	1
	17:00 - 18:00	0	1	1

6. 預計行人進出流量報告(由治河路至申請地點)

,	星期一至星期	日,包括公眾假期	
時段	行人		
·	進入(個)	離開(個)	
09:00 – 10:00	0	0	
10:00 – 11:00	4	2	
11:00 – 12:00	4	. 1	
12:00 – 13:00	3	4	
13:00 – 14:00	2	1	
14:00 – 15:00	3	3	
15:00 16:00	2	1	
16:00 – 17:00	2	4	
17:00 – 18:00	0	4	
合共(個)	20	20	

7. 環境方面

申請人會按照環保署對臨時露天農場及上蓋的技術指引,將對周邊環境的影響減到最低。

/// - -

8. 空氣方面

申請地點是一個休閒農場,不會導致任何空氣污染。

9. 噪音方面

申請地點是一個休閒農場,提供一個地點給市民享受田園樂趣,主要都是市民說話的聲音,不會導致噪音污染。

10. 排污方面

申請用途涉及一個洗手間,主要供職員及訪客使用,不會對外開放。申請人會按照環保署的規定和指引,在合適的地點上建造一個容量足夠的化業池作洗手間的排污,不會讓污水流出影響周邊環境。

11. 渠務方面

申請人會將按照渠務處的指引和要求建造排水渠,不會影響周邊環境。


12. 消防方面

申請人會將按照消防處的指引和要求放置消防裝置。


13. 綠化園景方面

申請人不會砍伐現存的樹木・並會好好打理保養它們。

申請人承諾如獲城規會批准擬議用途,將會盡力減少對周邊環境影響,並承諾在規劃許可到期後,還原申請地點,懇請城市規劃委員會寬大批准新界元朗錦田丈量約份第 109 約第 1170 號餘段作為期不超過三年的臨時康體文娛場所(休閒農場)。

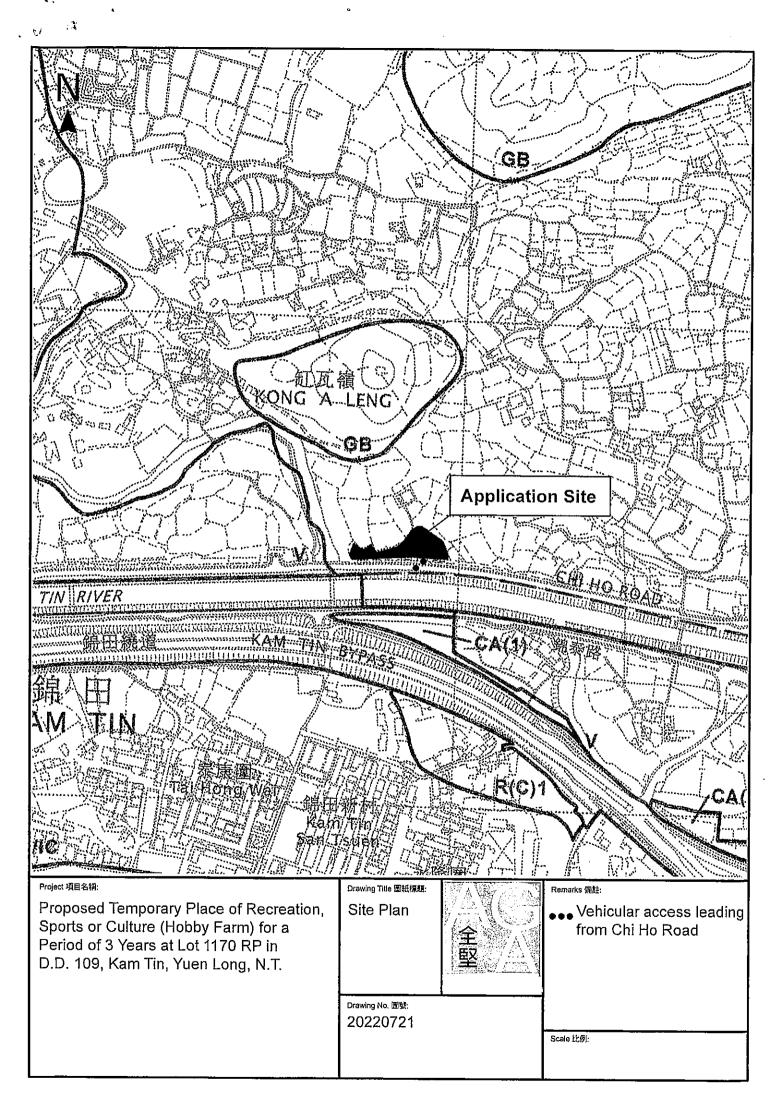



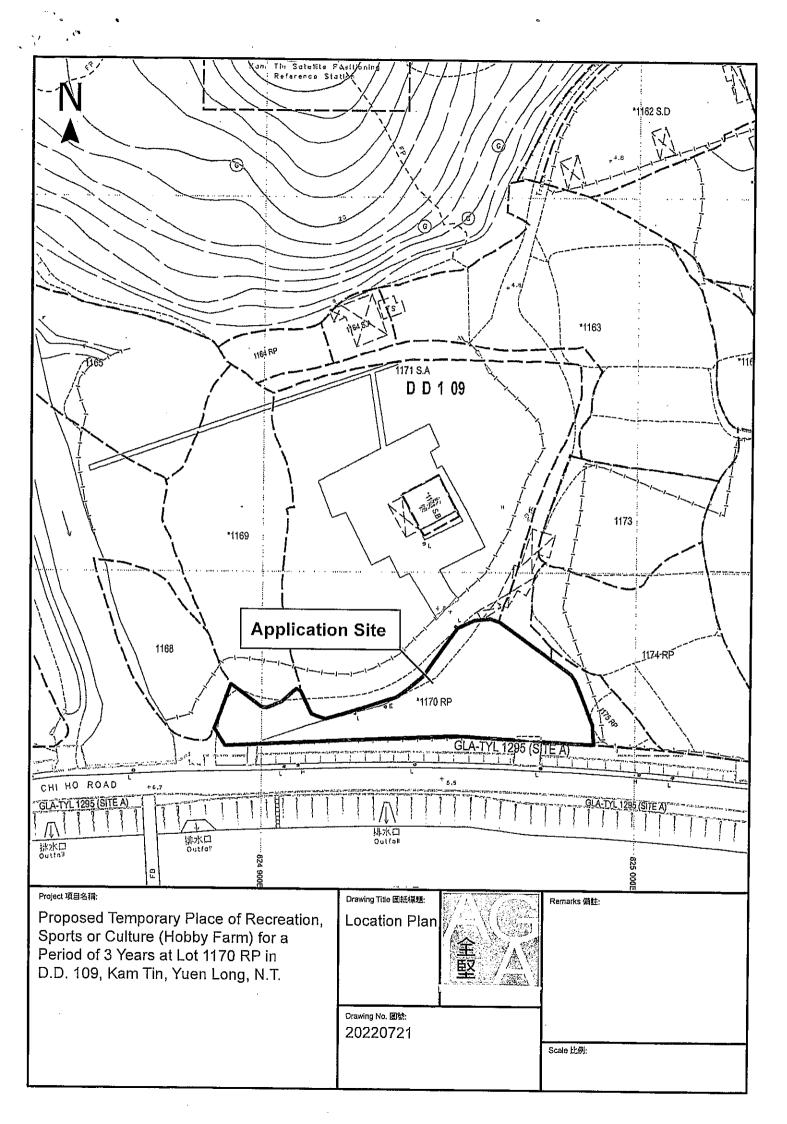

Structure 3

Education Room & Meeting Room Covered Area: 37.5m (ABOUT) GFA: Not exceeding 75m (ABOUT)

No. of storey: 2 Height: 7m (ABOUT)



Structure 4

Storage

Covered Area: 37.5m (ABOUT) GFA: Not exceeding 75m (ABOUT)

No. of storey: 2 Height: 7m (ABOUT) Structure 1

Ingress/Egress 5m

Site office, Reception

Covered Area: 37.5m (ABOUT) GFA: Not exceeding 75m (ABOUT)

No. of storey: 2 Height: 7m (ABOUT)

Structure 2

Changing Room & Toilet

Covered Area: 37.5m (ABOUT)
GFA: Not exceeding 75m (ABOUT)

No. of storey: 2 Height: 7m (ABOUT)

Project 項目名稱:

Proposed Temporary Place of Recreation, Sports or Culture (Hobby Farm) for a Period of 3 Years at Lot 1170 RP in D.D. 109, Kam Tin, Yuen Long, N.T. Drawing Title 圖紙標題:

Layout Plan



Remarks 備註:

Private car parking Space

≣≡ Farmland

Structure

Scale 比例:

Drawing No. 国際: 20220801





敬啟者:

本公司全堅土地行政師行(香港)有限公司(公司註冊號碼:

代申請人宏力建材有限公司(公司註冊號碼:

〉向城規會遞交規

劃許可:A/YL-KTN/857 回應部門的文件。



全堅土地行政師行(香港)有限公司 2022年10月18日

Planning Application No. A/YL-KTN/857


Table A: Responses to Departmental Comments (dated 14.9.2022)

	Departmental Comments	Responses
	Transport Department	
(a)	The applicant should demonstrate the	Please see Figure A.
	smooth manoeuvring of vehicles to/from	
	Chi Ho Road, along the local access and	
	within the site;	·
(b)	The applicant should note that the local	Noted.
	access between Chi Ho Road and the site	
	is not managed by this Department	
	Fire Services Department	
(a)	The applicant is required to submit	Please see Figure B.
	relevant layout plans incorporated with	
	the proposed fire service installations	
	(FSIs) to this Department. In addition,	
	the applicant should also be advised on	
,	the following points:	;
	i) The layout plans should be drawn to	
	scale and depicted with dimensions and	
	nature of occupancy; and	,
	ii) The location of where the proposed	
	FSI to be installed should be clearly	
	marked on the layout plans.	
	Drainage Services Department	
(a)	The applicant is required to submit a	Please see Figure C.
	drainage proposal including measures	,

Structure 3

Education Room & Meeting Room Covered Area: 37.5m (ABOUT) GFA: Not exceeding 75m (ABOUT)

No. of storey: 2 Height: 7m (ABOUT)

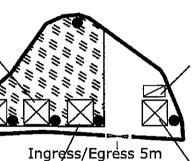

1 parking space of 5m x 2.5m for private cars

Structure 4

Storage

Covered Area: 37.5m (ABOUT)
GFA: Not exceeding 75m (ABOUT)

No. of storey: 2 Height: 7m (ABOUT) Structure 1

Site office, Reception

Covered Area: 37.5m (ABOUT)
GFA: Not exceeding 75m (ABOUT)

No. of storey: 2 Height: 7m (ABOUT)

Structure 2

Changing Room & Toilet

Covered Area: 37.5m (ABOUT)
GFA: Not exceeding 75m (ABOUT)

No. of storey: 2 Height: 7m (ABOUT)

Project 項目名稱:

Proposed Temporary Place of Recreation, Sports or Culture (Hobby Farm) for a Period of 3 Years at Lot 1170 RP in D.D. 109, Kam Tin, Yuen Long, N.T. Proposed
Fire Service
Installations
Plan

ice


Remarks 備註:



5kg Dry Powder
Type Extinguisher

Drawing No. 匯號: 20221017

Scale 比例:

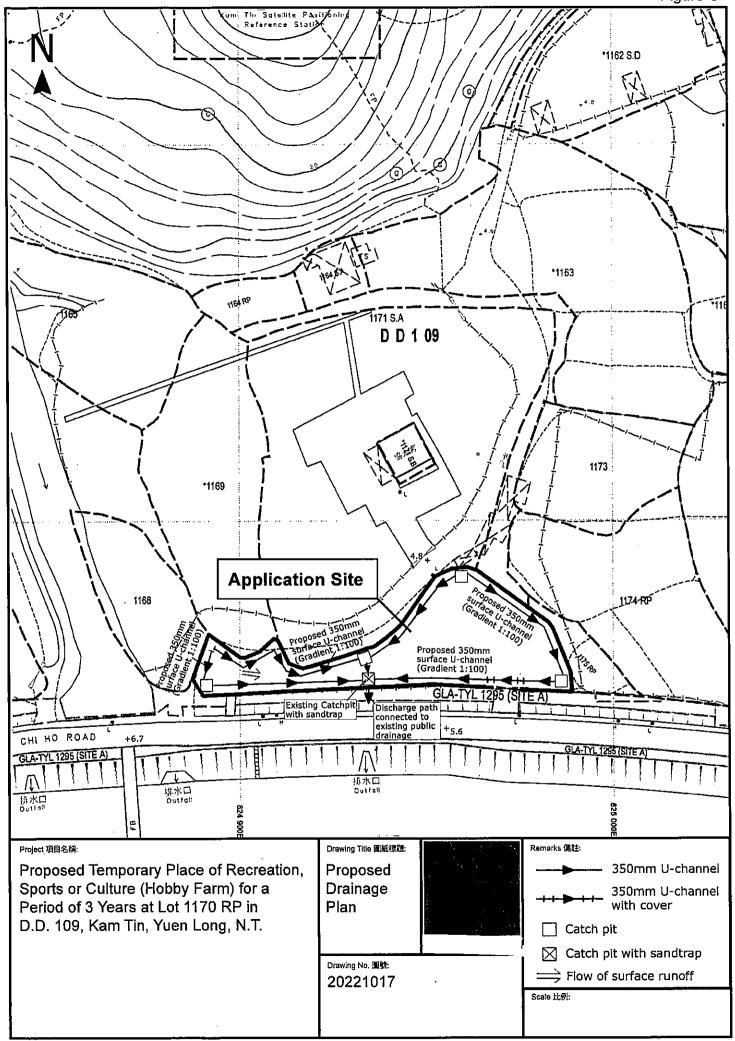

• ·

ISSUE 2

TEMPORARY DRAINAGE PROPOSAL (Final)

APPLICATION SITE OF THE PROPOSED
TEMPORARY PLACE OF RECREATION, SPORTS OR
CULTURE (HOBBY FARM) FOR A PERIOD OF 3
YEARS AT LOT 1170 RP IN D.D. 109, KAM TIN,
YUEN LONG, N.T.

PROJECT NO. AGLA/TDM/006

PREPARED FOR

APPLICATION NO. A/YL-KTN/857

12 DECEMBER 2022

Table of Contents

	-		
1		duction1	
	1.1	Background	
	1.2	Objectives of the Report	
	1.3	Report Structure1	
2		lopment Proposal1	
	2.1	Location of the Application Site1	
3	Asse	ssment Criteria2	
	3.1	Design Return Periods2	
	3.2	Calculation Methodology for Runoff2	
	3.3	Calculation Methodology for Pipe Capacity Checking3	
4	Pote	ntial Drainage Impact3	1
	4.1	Existing Site Condition3	
	4.2	Changes in Drainage Characteristics3	
	4.3	Potential Drainage Impact4	•
5	Cons	truction Stage4	•
	5.1	Temporary Drainage Arrangements4	•
6	Conc	lusions5	
	6.1	Conclusion5)
LI	ST OF	APPENDICES	
A.	Locati	on Plan	
	Layou		
		sed Drainage Plan	
		1 Calculation of the Proposed Drainage	
E. F.		al Standard Drawings Of U-Channel and Catchpit onse to Comments	
	•	TABLES	
_			
		Recommended Design Return Periods based on Flood Levels	
		Change in sub-catchment within the site	
T:	able 4-2	Design calculation of the proposed drainage work4	

1 Introduction

1.1 Background

1.1.1 This report presents the Drainage Proposal for supporting the proposed temporary place for recreation, sports or culture (hobby farm) for a period of 3 years at Lot 1170 RP in D.D. 109, Kam Tin, Yuen Long.

1.2 Objectives of the Report

- 1.2.1 This report shall be prepared to include the following:
 - Identify the potential drainage impact assessment from the proposed Application Site
 - recommend and implement all necessary measures to mitigate adverse drainage impacts arising from the application site

1.3 Report Structure

- 1.3.1 The report contains the following sections:
 - Section 1 on Introduction;
 - Section 2 on Development Proposal;
 - Section 3 on Assessment Criteria;
 - Section 4 on Potential Drainage Impact; and
 - Section 5 on Conclusion.

2 Development Proposal

2.1 Location of the Application Site

- 2.1.1 The application Site is located within the Kam Tin, Yuen Long, with an area of around 1,640m² and ground level varying between + 5.0mPD and + 5.4mPD. The layout plan is provided in **Appendix B.**
- 2.1.2 This application site is "Agriculture" zoning, the type of application is the Temporary Use/Development in Rural Areas for a Period of 3 Years.

3 Assessment Criteria

3.1 Design Return Periods

3.1.1 The drainage system in the Application site is to collect surface flows and convey to downstream village drain. The recommended design return periods based on the flood levels for the various drainage systems depend on the drainage system, land use, hazard to public safety and community expectations. The recommended design return period is reproduced in Table 3-1 below:

Table 3-1 Recommended Design Return Periods based on Flood Levels

DESCRIPTION	DESIGN RETURN PERIODS
Intensively Used Agricultural Land	2 – 5 Years
Village Drainage including internal Drainage System under a polder Scheme	10 Years
Main Rural Catchment Drainage Channels	50 Years
Urban Drainage Trunk System	200 Years
Urban Drainage Branch System	50 Years

- 3.1.2 As per Storm Drainage Manuel (SDM) Section 6.6.2 Urban Drainage Branch and Urban Drainage Trunk Systems "An 'Urban Drainage Branch System' is defined as a group or network of connecting drains collecting runoff from the urban area and conveying stormwater to a trunk drain, river or sea. For a simple definition, the largest pipe size or the equivalent diameter in case of a box culvert in a branch system will normally be less than 1.8m.
- 3.1.3 An 'Urban Drainage Trunk System' collects stormwater from branch drains and/or river inlets, and conveys the flow to outfalls in river or sea. Pipes with size or diameter equal to or larger than 1.8m are normally considered as trunk drains."
- 3.1.4 As per SDM, since the proposed U-channels are sized smaller than 1.8m, the drainage system would be defined as an urban drainage branch with recommended design return period of 50 years.
- 3.1.5 The 50 years design return period will be considered to ensure adequacy of the stormwater drainage system.

3.2 Calculation Methodology for Runoff

3.2.1 Peak instantaneous runoff values before and after the development were calculated based on the Rational Method and with recommended physical parameters including runoff coefficient (C) and storm constants for different return periods referred to the SDM, based on the following equation:

$$Q_p = 0.278 \text{ C i A}$$

where $Q_p = Peak Runoff, m^3/s$ C = Runoff Coefficient

i = Rainfall Intensity, mm/hr A = Catchment Area, km²

- 3.2.2 The paved area of the site will account for 1,640 m². For conservative, the runoff coefficient of 1.0 is assumed, such that the all the run-off would be collected from the catchment area without any infiltration as the critical scenario.
- 3.2.3 Based on the storm constants for 50-year return period recommended in the SDM, the appropriate rainfall intensities (i) are calculated as detailed in **Appendix D**

3.3 Calculation Methodology for Pipe Capacity Checking

- 3.3.1 Because the catchment areas are less than 1ha, U-channels are recommended to be constructed to collect the stormwater runoff within the site. The collected stormwater should finally be diverted to the downstream via the proposed U-channel system.
- 3.3.2 For the worst-case scenario, bad condition of concrete pipe is assumed for the Manning's roughness coefficient (coefficient value is 0.016) for calculating capacities of concrete U-channel using Manning's Equation.
- 3.3.3 Manning's Equation for calculating the channel and pipe capacities is adopted.

4 Potential Drainage Impact

4.1 Existing Site Condition

- 4.1.1 The application Site is located within the Kam Tin, Yuen Long, with an area of around 1,640m² and ground level varying between + 5.0mPD and + 5.4mPD.
- 4.1.2 There is no specific drainage provision for the current site, the collected stormwater would be discharged as surface runoff and infiltration leading to the natural stream or river.
- 4.1.3 Only the application site with a projected area of 1,640 m² is considered as part of the catchment, no external / additional catchments are required to consider.

4.2 Changes in Drainage Characteristics

- 4.2.1 The characteristics of the sub-catchment areas are remained unchanged due to the temporary development for the application site, which are paved area.
- 4.2.2 The application site would be covered by grassland and concrete surface. The change in subcatchment is summarized in Table 4-2.

Table 4-1 Change in sub-catchment within the site

	BEFORE	AFTER
Grassland (m²)	1640	0
Paved Area (m²)	0	1640
Total Catchment Area (m²)	1640	1640

4.3 Potential Drainage Impact

- 4.3.1 The details of the proposed drainage works are illustrated in **Appendix C**.
- 4.3.2 To effectively convey stormwater away from the application site and minimize the potential impact to the drainage infrastructure of the village area, drainage works consists of U-channels, are proposed to convey the stormwater runoff to the terminate catchpit with sand trap (TCP).
- 4.3.3 The runoff from the Application site is collected by 350mm U-channels along the boundary and convey to the terminate catchpit with sand trap (TCP), before discharge to the well-established public drain catchpit with Feature Number SCH1026130 at the southern of the application site, and eventually discharge to the existing river via 750mm pipe across the chi ho road.
- 4.3.4 The 350 mm U-channel receives stormwater from the surface and the upstream catchment. For Conservative, the critical scenario is considered for collecting all the flow leading to the 350mm U-channel. The design calculation of the proposed drainage is provided in **Appendix D**. The design calculation is summarized in Table 4-2.

Table 4-2 Design calculation of the proposed drainage work

DRAINAGE	ESTIMATED FLOW	CAPACITY	RESERVE CAPACITY
SYSTEM	(M³/S)	(M³/S)	
350mm UC	0.105	0.179	41%

Note:

- [1] Rainfall increase due to climate change at the end of 21st century is considered according to stormwater drainage manual Table 28.
- [2] The reserve capacity is calculated by assuming that the U-channel reach its full capacity.
- 4.3.5 The design runoff arise from the proposed Application Site is to be discharged into the proposed terminate catchpit with the runoff anticipated to be 0.105m³/s, which is within the drainage capacity of the proposed 350mm u-channel of 0.482m³/s with gradient 1:100, the reserve capacity is 41%.
- 4.3.6 It is considered that the drainage discharge from the Application Site will not cause adverse impact to the entire downstream drainage system.
- 4.3.7 All u-channels & catch pits will be constructed according to the CEDD's standard drawings, please refer to the **Appendix E.**

5 Construction Stage

5.1 Temporary Drainage Arrangements

- 5.1.1 Proper measures shall be taken to maintain the existing drainage characteristics of the catchment areas and to minimize drainage impacts associated with the construction works. The principal drainage impacts which are associated with construction of the works have been identified as follows:
 - (a) Erosion of ground materials;
 - (b) Sediment transportation to existing downstream drainage system; and
 - (c) Obstruction to drainage systems.
- 5.1.2 Regular inspections shall be carried out to ensure integrity of the works. These inspections shall cover works under construction as well as recently completed areas.

- 5.1.3 To ensure proper operation of the site drainage channels and desilting facilities, inspection of the perimeter drains shall be carried out on a weekly basis and the desilting facilities shall be cleaned on a daily basis.
- 5.1.4 If excavated materials are not possible to transport away the excavated material within the same day, the material should be covered by tarpaulin/impervious sheets. Stockpiles of construction materials (for examples aggregate, fill materials) of more than 50 m³ in an open area shall also be covered with tarpaulin or similar fabric during rainstorms.
- 5.1.5 All runoff discharged into the existing drainage system will be settled in a silt trap to ensure no sediment will be discharged into the channel. Silt traps will normally be provided along the site drainage immediately upstream of the proposed discharge point to the existing Site. The silt traps will be inspected daily and immediately after each rainstorm.
- 5.1.6 Liaison will be carried out with relevant parties regarding temporary drainage arrangements to ensure that the drainage system is functioning adequately.

6 Conclusions


6.1 Conclusion

- 6.1.1 The analysed catchment area of 1,640 m² consists of the site area of the proposed Application Site.
- 6.1.2 U-channels are proposed to convey runoff from the application site for collection. The proposed U-channels are located along the site boundary which is subject to change to suit the building layout.
- 6.1.3 The assessment reviews the drainage pipe have the sufficient capacity to cater for the drainage flow from the Application Site.
- 6.1.4 Mitigation measures are proposed during the application site proposed Application Site and to ensure that the existing drainage system within the site will not be affected during the construction stage.


END OF TEXT




. APPENDIX A SITE LAYOUT PLAN

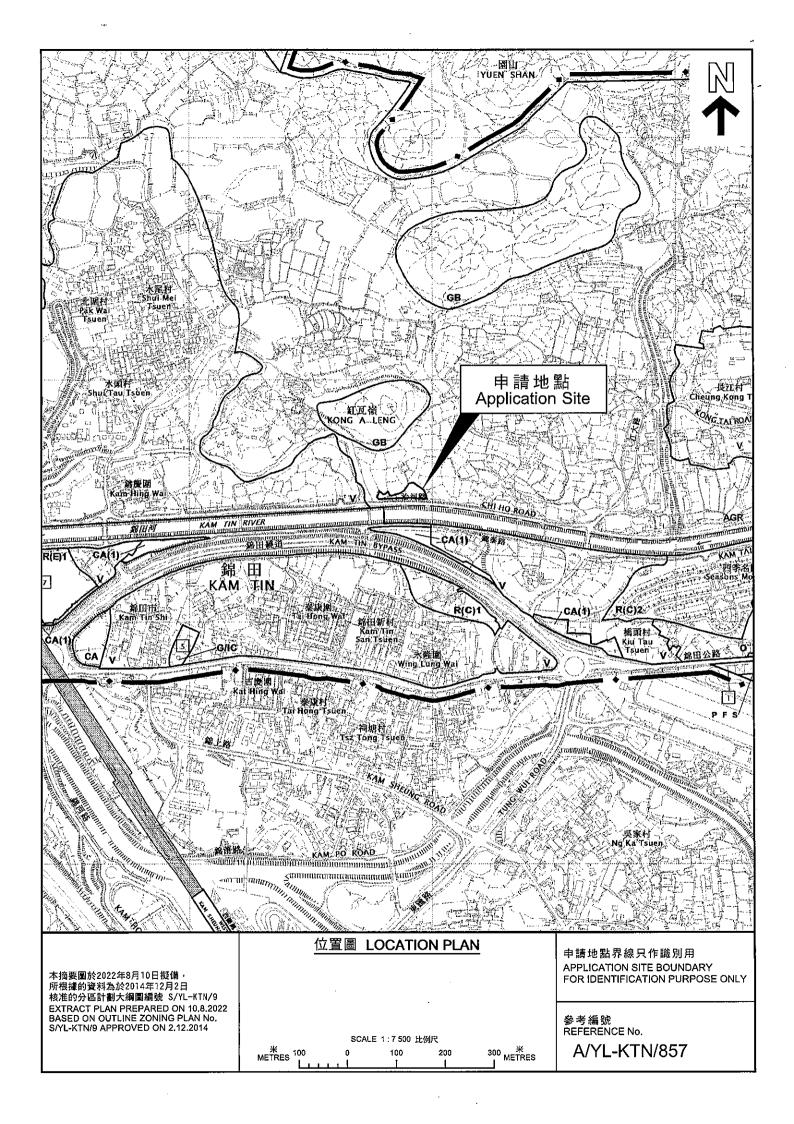

APPENDIX B

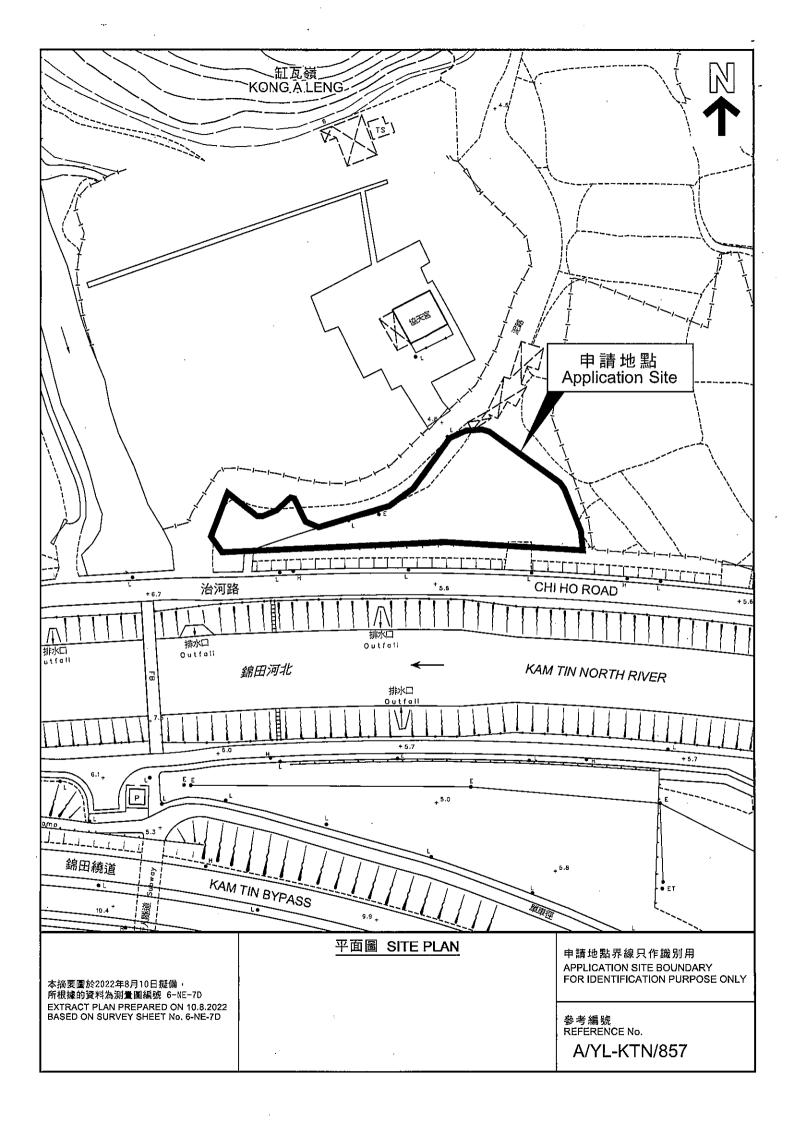


APPENDIX C
PROPOSED DRAINAGE PLAN

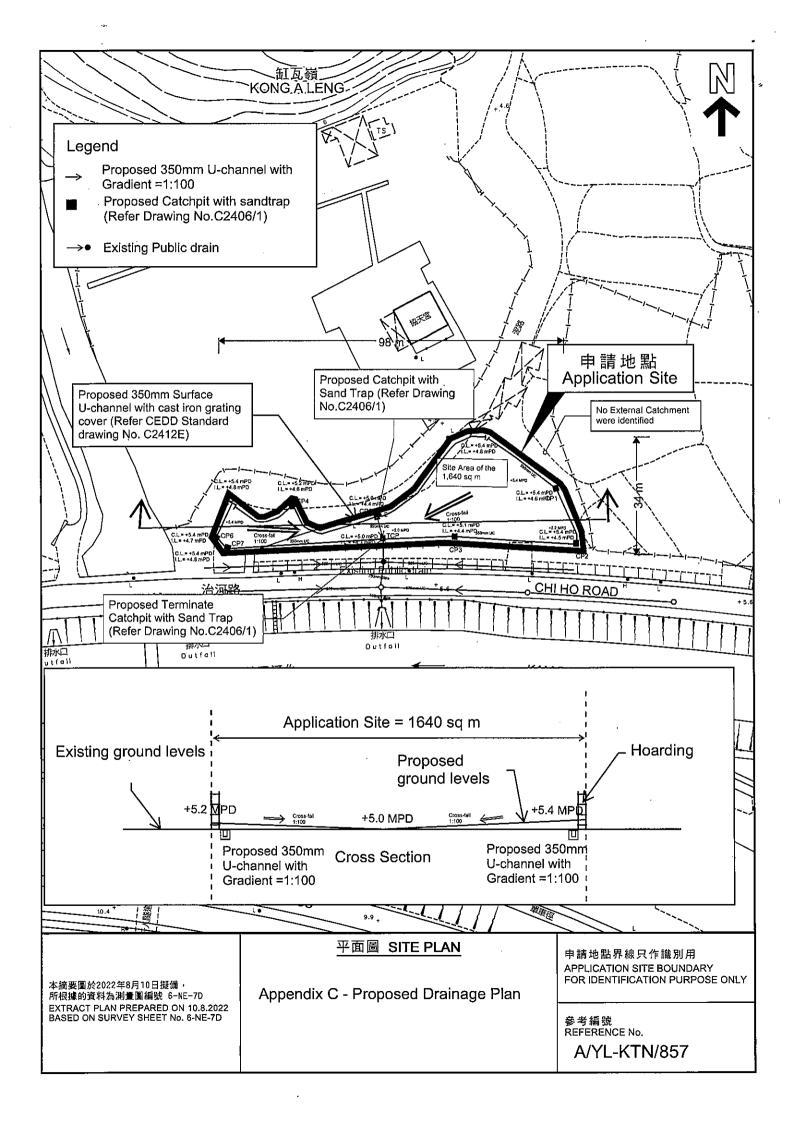





前往地圖: https://www.map.gov.hk/gm/geo:22.4434,114.0669?z=564

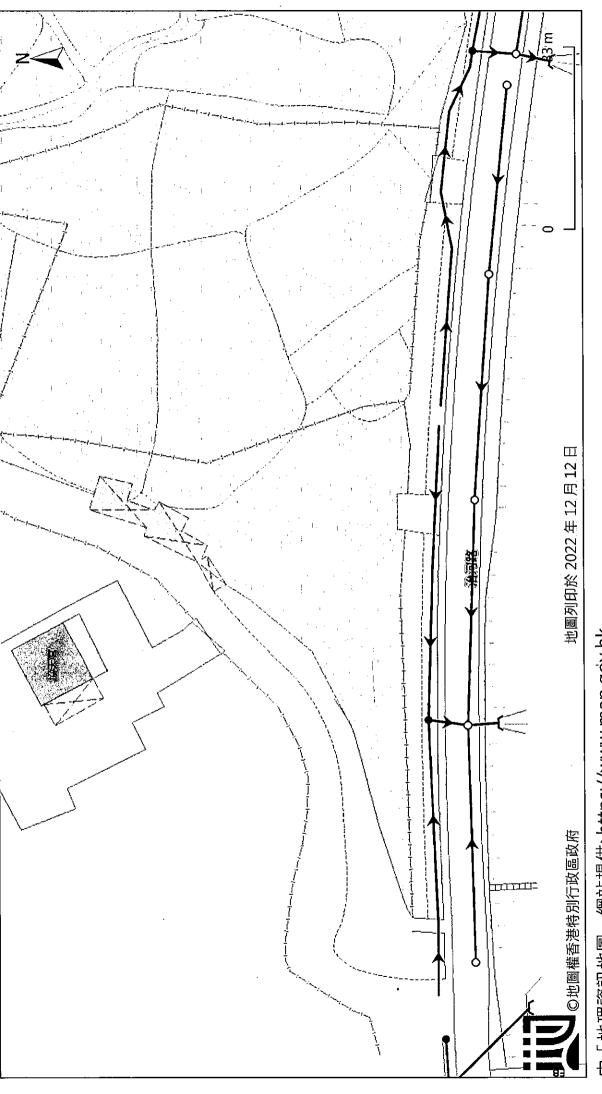

由「地理資訊地圖」網站提供: https://www.map.gov.hk

注意:使用此地圖受「地理資訊地圖」的使用條款及條件以及知識產權告示約束。

APPENDIX D
DESIGN CALCULATION OF THE PROPOSED DRAINAGE

SDM Table 3

Design Data

Runoff estimation

- 1. Design follows the Rational Method in accordance with Stormwater Drainage Manual 2018 (DSD)
- 2. Runoff coefficient for paved land is 0.95.
- 3. Design return period is 50 years.
- 4. For manning's equation coeffient n is 0.016.

Storm constants for 200-year return period:

Check for Hydraulic Capacity of 350mm U-Channel

Catchment	K	Area (A)
UC	1.0	1640.0 m ²

中期地點 Proposed Caichpit with Application Site
Proposed 350mm Subsce U-charvel with cast iron grady cover (Refer CEDD Standard drawing No. C2406/1) Said Trap (Refer Drawing No. C2406/1) Et rewell Castriers was directed
Tabana Pa
Proposed Terminate Brussell Children CAD
Crossed No. CASOUT) 3 Crossed No. CASOUT) Section 1. CASOUT No.

451,3

а

		Average slope, H	=	1 /100m
	١.	Catchment area, A	=	1640.00 m ²
		Distance between summit and point under consideration, L	=	20 m
SDM 7.5.2		Time of concentration of natural catchment, to	=	$0.14465 \times L / (H^{0.2} \times A^{0.1})$

	_	1,30 11111,
Length of drain, L _j	=	100 m
Velocity, V _j	=	1.636 m/s
Flow time, t-	=	Σ (L; / V;)

SDM 7.5.2 Flow time,
$$t_f = \sum (L_j / V_j)$$


= 1.01891127 min.

Time of concentration,
$$t_c$$
 = $t_o + t_f$ = 2.40 min.

		****	•
	Gradient	= 0	.01
Manning's Eq.	flow velocity	= 1.0	636 m/s
	Design Capacity	= 0.	179 m³/s
		> 0.1	05 m³/s OK
	Reserve canacity	= 4	1%

For conservative, all the U-channel along the site boundary shall be 350mm.


Checking only, Check Downstream 750 mm pipe				
Catchment K Area (A)				
Catchment Area by others	1.00	1266 0 m ²		

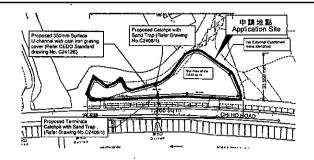

	Runoff estimation				
	Average slope, H		=	1 /100m	
	Catchment area, A	1	=	1266.00 m ²	
	Distance between summit and point under consideration, L		=	20 m	
SDM 7.5.2	Time of concentration of natural catchment, $\boldsymbol{t}_{\text{o}}$		=	0,14465 x L / (H ^{0,2} x A ⁰	^{0.1})
			=	1.42 min.	
,	Length of drain, L _j		=	100 m	
	Velocity, V _j		=	2.719 m/s	
SDM 7.5.2	Flow time, t _f		=	$\Sigma (L_j / V_j)$	
•	, , , , , , , , , , , , , , , , , , ,		=	0.6130194 min.	
	Time of concentration, t _c		=	$t_o + t_f$	
			=	2.03 min.	
SDM Table 3	Storm constants for 200-year return period:	а	=	451.3	
		b	=	2.46	
		С	=	0.337	
SDM 4.3.2	Extreme mean intensity, i _{200yr}		=	a / (t _d + b) ^c	
			=	248.060142 mm/hr	
SDM Table 28	Extreme mean intensity at the end of 21st century			•	
SDM 7.5.2	Design flow, Q2	•	=	0.278 i Σ Κ Α	
			=	0.087 m³/s	
	Total Flow, Q1+Q2		=	0.193	
	750mm pipe capacity				
	Diameter		=	750 mm	
	Cross-sectional area of 750mm U-channel		=	0.4418 m ²	
	Gradient		=	0.01	
Manning's Eq.	flow velocity		=	2.719 m/s	
	Design Capacity		=	1,201 m³/s	
			>	0.193 m³/s	ок
	Reserve capacity		=	84%	


Ì

%Reserve cap	41%	
Capacity (m3/s)	0.1789	Return Period
Run-off, Q (m3/s)	0.1055	
Design intensity, i _{zooyr}	405	- 18 18 18 18 18 18 18 18 18 18 18 18 18
Extreme mean intensity, i50 _{vr}	243.51	
Area (m2)	1640	
Preceding flow	1	
Catchment No.	Red line	(3rl/am)); , 7cl/am)); , 7cl/am)); , 7cl/am)); , 7cl/am)
Channels / Pipe No.	On	
	Extreme 'Pipe Catchment No. Preceding flow (m2) intensity, i50 _v	Area mean intensity, Q (m3/s)

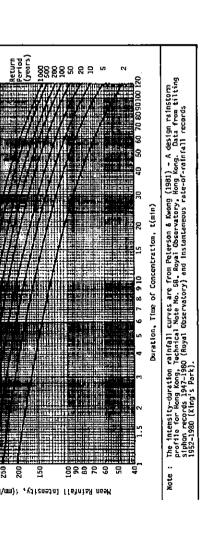

APPENDIX E

TYPICAL STANDARD DRAWINGS OF U-CHANNEL AND CATCHPIT (EXTRACTED FROM CEDD, FOR REFERNCE ONLY)

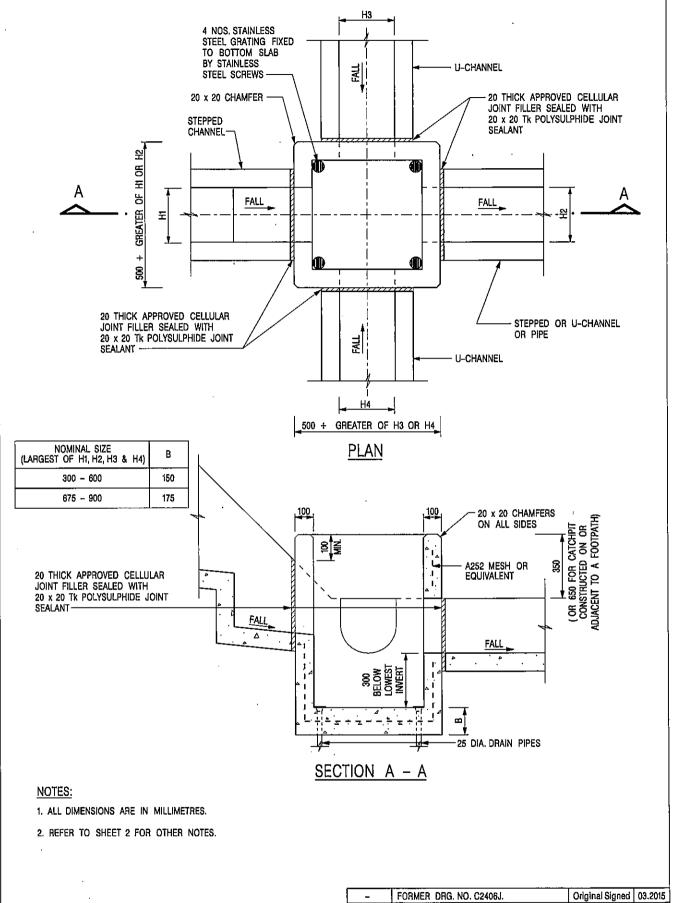

CATCHPIT WITH TRAP (SHEET 1 OF 2)

卓越工程 建設香港

- FORMER DRG. NO. C2406J. Original Signed 03.2015

REF. REVISION SIGNATURE DATE

CEDD CIVIL ENGINEERING AND


DEVELOPMENT DEPARTMENT

SCALE 1:20

JAN 1991

DATE

C2406 /1

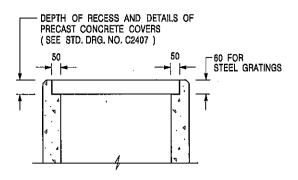

ALTERNATIVE TOP SECTION FOR PRECAST CONCRETE COVERS / GRATINGS

NOTES:

- 1. ALL DIMENSIONS ARE IN MILLIMETRES.
- 2. ALL CONCRETE SHALL BE GRADE 20 /20.
- 3. CONCRETE SURFACE FINISH SHALL BE CLASS U2 OR F2 AS APPROPRIATE.
- 4. FOR DETAILS OF JOINT, REFER TO STD. DRG. NO. C2413.
- 5. CONCRETE TO BE COLOURED AS SPECIFIED.
- 6. UNLESS REQUESTED BY THE MAINTENANCE PARTY AND AS DIRECTED BY THE ENGINEER, CATCHPIT WITH TRAP IS NORMALLY NOT PREFERRED DUE TO PONDING PROBLEM.
- 7. UPON THE REQUEST FROM MAINTENANCE PARTY, DRAIN PIPES AT CATCHPIT BASE CAN BE USED BUT THIS IS FOR CATCHPITS LOCATED AT SLOPE TOE ONLY AND AS DIRECTED BY THE ENGINEER.
- 8. FOR CATCHPITS CONSTRUCTED ON OR ADJACENT TO A FOOTPATH, STEEL GRATINGS (SEE DETAIL 'A' ON STD. DRG. NO. C2405 /2) OR CONCRETE COVERS (SEE STD. DRG. NO. C2407) SHALL BE PROVIDED AS DIRECTED BY THE ENGINEER.
- 9. IF INSTRUCTED BY THE ENGINEER, HANDRAILING (SEE DETAIL 'J'
 ON STD. DRG. NO. C2405 /5; EXCEPT ON THE UPSLOPE SIDE) IN LIEU OF
 STEEL GRATINGS OR CONCRETE COVERS CAN BE ACCEPTED AS AN ALTERNATIVE
 SAFETY MEASURE FOR CATCHPITS NOT ON A FOOTPATH NOR ADJACENT TO IT. TOP OF THE HANDRAILING SHALL BE 1 000 mm, MIN, MEASURED FROM THE ADJACENT GROUND LEVEL.
- 10. MINIMUM INTERNAL CATCHPIT WIDTH SHALL BE 1 000 mm FOR CATCHPITS WITH A HEIGHT EXCEEDING 1 000 mm MEASURED FROM THE INVERT LEVEL TO THE ADJACENT GROUND LEVEL. AND, STEP IRONS (SEE DSD STD. DRG. NO. DS1043) AT 300 c/c STAGGERED SHALL BE PROVIDED.
 THICKNESS OF CATCHPIT WALL FOR INSTALLATION OF STEP IRONS SHALL
 BE INCREASED TO 150 mm.
- FOR RETROFITTING AN EXISTING CATCHPIT WITH STEEL GRATING, SEE DETAIL 'G' ON STD. DRG. NO. C2405 /4.
- 12. SUBJECT TO THE APPROVAL OF THE ENGINEER, OTHER MATERIALS CAN ALSO BE USED AS COVERS / GRATINGS.

A	MINOR AMENDMENT.	Original Signed	04.2016
-	FORMER DRG. NO. C2406J.	Orlginal Signed	03.2015
REF.	REVISION	SIGNATURE	DATE

CATCHPIT WITH TRAP (SHEET 2 OF 2)




CIVIL ENGINEERING AND DEVELOPMENT DEPARTMENT

SCALE 1:20 DATE

JAN 1991

DRAWING NO. C2406 /2A

卓越工程 建設香港

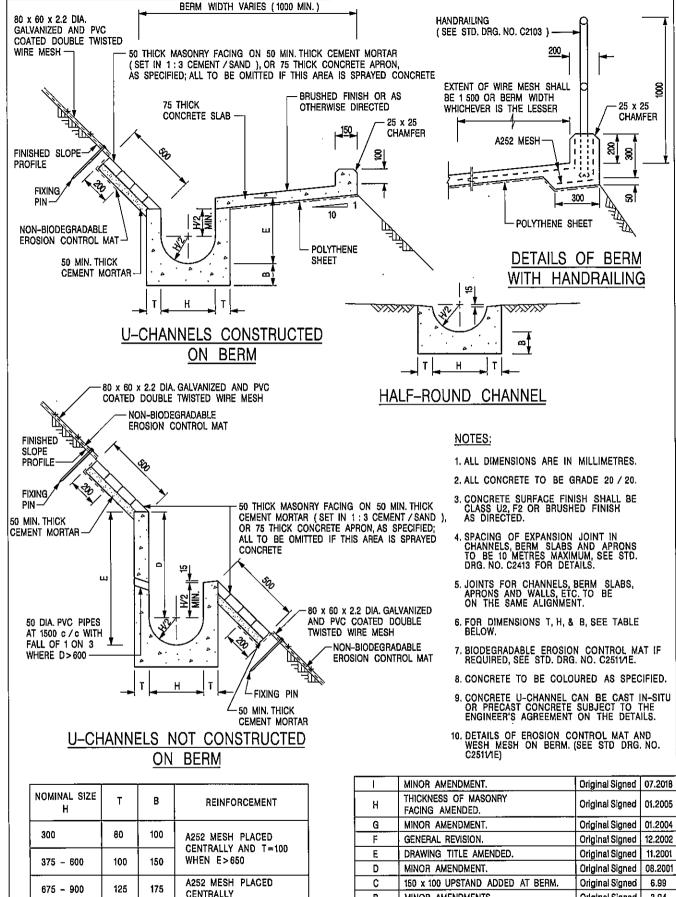

DETAILS OF HALF-ROUND AND U-CHANNELS (TYPE A -WITH MASONRY APRON


卓越工程 建設香港

MINOR AMENDMENTS. В Orlginal Signed 3.94 REF. REVISION SIGNATURE DATE

CEDD

CIVIL ENGINEERING AND DEVELOPMENT DEPARTMENT

SCALE 1:25 DATE JAN 1991 DRAWING NO. C2409I

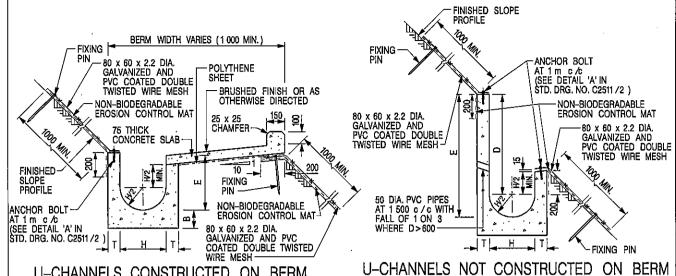


U-CHANNELS CONSTRUCTED ON BERM WITH NON-BIODEGRADABLE EROSION CONTROL MAT U-CHANNELS NOT CONSTRUCTED ON BERM WITH NON-BIODEGRADABLE EROSION CONTROL MAT

BIODEGRADABLE

EROSION CONTROL MAT

FINISHED SLOPE PROFILE

ш

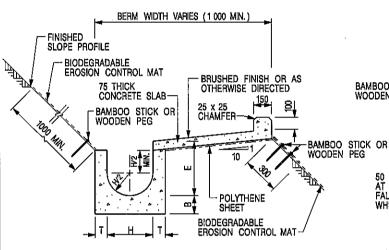

<u>U-CHANNELS CONSTRUCTED ON BERM</u>
<u>WITH BIODEGRADABLE</u>
<u>EROSION CONTROL MAT</u>

U-CHANNELS NOT CONSTRUCTED ON BERM
WITH BIODEGRADABLE
EROSION CONTROL MAT

Н

BAMBOO STICK OR WOODEN PEG-

J T [

NOTES:

- 1. ALL DIMENSIONS ARE IN MILLIMETRES.
- 2. ALL CONCRETE TO BE GRADE 20 /20.
- CONCRETE SURFACE FINISH SHALL BE CLASS U2, F2 OR BRUSHED FINISH AS DIRECTED.
- 4. SPACING OF EXPANSION JOINT IN CHANNELS, BERM SLABS AND APPONS TO BE 10 METRES MAXIMUM, SEE STD. DRG. NO. C2413 FOR DETAILS.
- 5. JOINTS FOR CHANNELS, BERM SLABS, APRONS AND WALLS, ETC. TO BE ON THE SAME ALIGNMENT.
- 6. FOR DIMENSIONS T, H, & B, SEE TABLE BELOW.
- FOR TYPICAL FIXING PIN DETAILS, SEE STD. DRG. NO. C2511/2.
- 8. MINIMUM SIZE OF 25 x 50 x 300mm SHALL BE PROVIDED FOR WOODEN PEG.
- MINIMUM SIZE OF 10mm DIAMETER WITH 200mm LONG SHALL BE PROVIDED FOR BAMBOO STICK.
- 10. THE FIXING DETAILS OF NON-BIODEGRADABLE AND BIODEGRADABLE EROSION CONTROL MATS ON EXISTING BERM SHALL REFER TO STD. DRG. NO. C2511/1.

NOMINAL SIZE H	т Т	В	REINFORGEMENT
300	80	100	A252 MESH PLACED CENTRALLY AND T=100
375 - 600	100	150	WHEN E>650
675 - 900	125	175	A252 MESH PLACED CENTRALLY

DETAILS OF HALF-ROUND AND U-CHANNELS (TYPE B - WITH EROSION CONTROL MAT APRON)

T				
RE	EF.	REVISION	SIGNATURE	DATE
	A	MINOR AMENDMENT.	Original Signed	10.92
	В	MINOR AMENDMENT.	Original Signed	3.94
	С	150 x 100 UPSTAND ADDED AT BERM.	Original Signed	6.99
	D	MINOR AMENDMENT.	Original Signed	08.2001
	Е	GENERAL REVISION.	Original Signed	12.2002
	F	MINOR AMENDMENT.	Original Signed	01.2004
	G	DIMENSION TABLE AMENDED.	Original Signed	01,2005
	Н	FIXING DETAILS OF BIODEGRADABLE EROSION CONTROL MAT ADDED.	Original Signed	12.2017
$ldsymbol{ldsymbol{ldsymbol{ldsymbol{ldsymbol{L}}}}$	<u>l</u>	MINOR AMENDMENT.	Original Signed	07.2018

CEDD

BAMBOO STICK OR WOODEN PEG

50 DIA. PVC PIPES AT 1 500 c/c WITH FALL OF 1 ON 3


WHERE D>600


CIVIL ENGINEERING AND DEVELOPMENT DEPARTMENT

SCALE DIAGRAMMATIC

drawing no. C24101

卓越工程 建設香港

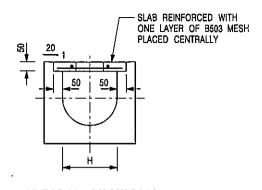

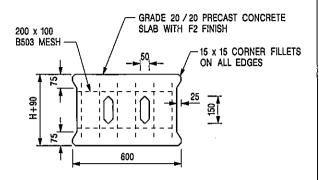



PLAN OF SLAB

TYPICAL SECTION

U-CHANNELS WITH PRECAST CONCRETE SLABS

(UP TO H OF 525)

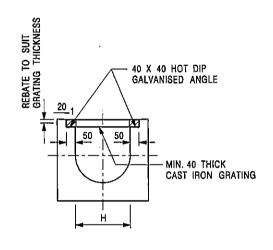

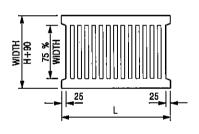

L = 600mm FOR H ≤ 375mm L = 400mm FOR H > 375mm

TYPICAL SECTION

CAST IRON GRATING

(DIMENSIONS ARE FOR GUIDANCE ONLY, CONTRACTOR MAY SUBMIT EQUIVALENT TYPE)

U-CHANNEL WITH CAST IRON GRATING

(UP TO H OF 525)

NOTES:

- 1. ALL DIMENSIONS ARE IN MILLIMETRES.
- 2. H=NOMINAL CHANNEL SIZE.
- ALL CAST IRON FOR GRATINGS SHALL BE GRADE EN-GJL-150 COMPLYING WITH BS EN 1561.
- 4. FOR COVERED CHANNELS TO BE HANDED OVER TO HIGHWAYS DEPARTMENT FOR MAINTENANCE, THE GRATING DETAILS SHALL FOLLOW THOSE AS SHOWN ON HyD STD. DRG. NO. H3156.

E	NOTES 3 & 4 AMENDED.	Original Signed	12.2014
D	NOTE 4 ADDED.	Original Signed	06.2008
С	MINOR AMENDMENT, NOTE 3 ADDED.	Orlginal Signed	12,2005
В	NAME OF DEPARTMENT AMENDED.	Original Signed	01.2005
A	CAST IRON GRATING AMENDED.	Original Signed	12.2002
REF.	REVISION	SIGNATURE	DATE

COVER SLAB AND CAST IRON GRATING FOR CHANNELS


_	
CEDD	
CLUU	
1 - 1 3	

CIVIL ENGINEERING AND DEVELOPMENT DEPARTMENT

 SCALE 1:20
 DRAWING NO.


 DATE JAN 1991
 C2412E

卓越工程 建設香港

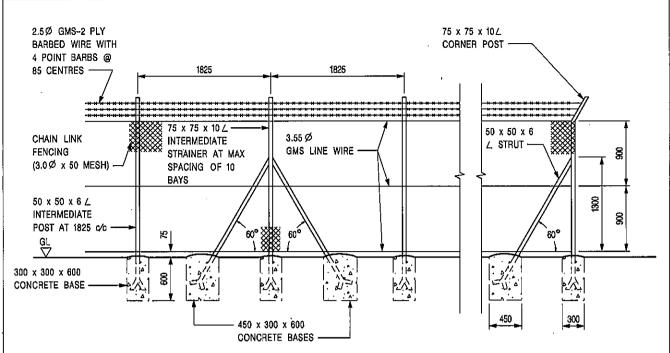

ELEVATION OF INTERMEDIATE POST INTERMEDIATE STRAINER & CORNER POST

(SCALE 1:50)

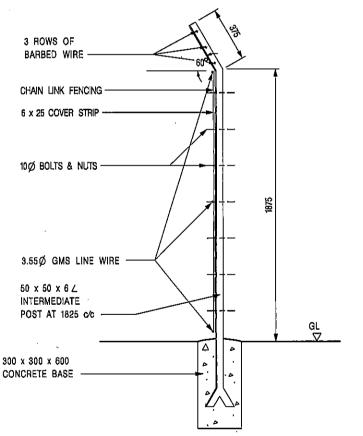

NOTATION :

GMS - GALVANIZED MILD STEEL

NOTES :

- ALL DIMENSIONS ARE IN MILLIMETRES.
- ALL CONCRETE SHALL BE GRADE 20 /20.
 THE USE OF RECYCLED AGGREGATES SHALL BE CONSIDERED.
- ALL POSTS AND FENCES SHALL BE HOT DIP GALVANIZED TO BS EN ISO 1461.
- WELDS SHALL BE WIRE BRUSHED AND PAINTED WITH TWO COATS OF ALUMINIUM MASTIC PAINT.
- ALL STEELWORK SHALL BE OF GRADE S275 TO BS EN 10025.

INTERMEDIATE POST (SCALE 1:25)

REF.	REVISION	SIGNATURE	DATE
Α	NAME OF DEPARTMENT AMENDED	Original Signed	02.2005
В	NOTE 3 AMENDED; NOTE 5 ADDED	Original Signed	03.2015
O	NOTE 5 AMENDED	Original Signed	09.2018

CHAIN LINK FENCE

CEDD CIVIL ENGINEERING AND DEVELOPMENT DEPARTMENT

SCALE AS SHOWN
DATE JAN 1991

DRAWING NO. C1006C

卓越工程 建設香港

APPENDIX F
RESPONSE TO COMMENTS

Temporary Drainage Proposal (Issue 2)	
Response to Comments on Temporary Drainage Proposal (Issue 1)	

1.

Comments from DSD/YL2

1. Comments from DSD/YL

No.	Comments	Response
Α.	Please provide calculation to justify the dimensions of the proposed u-channel.	Noted. Please refer to the Appendix D.
В.	Consideration should be given to provide catchpit at the turning points of the u-channel	Please refer to the Appendix C. Additional catchpit with Sand Trap would be provided at the turning points.
C.	The invert levels of the proposed catchpits should be shown on the drainage plan for reference.	The invert levels of the proposed catchpits are shown on the drainage plan. Please refer to the Appendix C.
D.	The proposal should indicate how the runoff (the flow direction) within the site (particularly the eastern side) would be discharged to the proposed u-channel.	Noted. Please refer to the Appendix C.
E.	The existing drainage facilities, to which the stormwater of the development from the subject site would discharge, should be indicated on plan. The relevant connection details should be provided for comment.	Please refer to the Appendix C.
F.	The applicant should check and ensure the hydraulic capacity of the existing drainage facilities would not be adversely affected by the captioned development.	Noted. Please refer to the Appendix D.
G.	The location and details of the proposed hoarding/peripheral wall should be shown on the proposed drainage plan.	The location of the hoarding (Chain Link Fence) is indicated in the Appendix C. For the details of the proposed hoarding wall, please refer to the Appendix E.
Н.	Cross sections showing the existing and proposed ground levels of the captioned site with respect to the adjacent areas should be given.	Cross section showing the existing and proposed ground levels of the captioned site is provided in Appendix C.
I.	Standard details should be provided to indicate the sectional details of the proposed u-channel, sand trap and catchpit.	Please refer to the revised Appendix E.
J.	The applicant should consult DLO/YL and seek consent from the relevant owners for any drainage works to be carried out outside his lot boundary before commencement of the drainage works.	Noted.
К.	The applicant should submit form HBP1 to this Division for application of technical audit for any proposed connection to DSD's drainage facilities.	Note with thanks. Separate submission of form HBP1 would be provided to DSD in the construction stage.

.

Similar Applications within the same "AGR" Zone in the Vicinity of the Site

Approved Applications

	Application No.	<u>Use(s)</u> / <u>Development(s)</u>	Date of Consideration
1	A/YL-KTN/609	Proposed Temporary Place of Recreation, Sports or Culture (Hobby Farm) for a Period of 3 Years	3.8.2018 [revoked on 3.2.2019]
2	A/YL-KTN/610	Proposed Temporary Place of Recreation, Sports or Culture (Hobby Farm) for a Period of 3 Years	3.8.2018 [revoked on 3.2.2020]
3	A/YL-KTN/620	Proposed Temporary Place of Recreation, Sports or Culture (Hobby Farm) for a Period of 3 Years	7.9.2018 [revoked on 7.2.2021]
4	A/YL-KTN/615	Proposed Temporary Place of Recreation, Sports or Culture (Hobby Farm) for a Period of 3 Years	16.11.2018 [revoked on 16.4.2021]
5	A/YL-KTN/636	Proposed Temporary Place of Recreation, Sports or Culture (Hobby Farm) for a Period of 3 Years	21.12.2018 [revoked on 21.5.2021]
6	A/YL-KTN/626	Proposed Temporary Place of Recreation, Sports or Culture (Hobby Farm) for a Period of 3 Years	18.1.2019 [revoked on 18.6.2021]
7	A/YL-KTN/630	Proposed Temporary Place of Recreation, Sports or Culture (Hobby Farm) for a Period of 3 Years	18.1.2019 [revoked on 18.6.2021]
8	A/YL-KTN/665	Temporary Place of Recreation, Sports or Culture (Hobby Farm and Caravan Holiday Camp) for a Period of 5 Years	5.7.2019 [revoked on 5.12.2021]
)	A/YL-KTN/649	Proposed Temporary Place of Recreation, Sports or Culture (Hobby Farm) for a Period of 5 Years	16.8.2019
10	A/YL-KTN/670	Proposed Temporary Place of Recreation, Sports or Culture (Hobby Farm) for a Period of 5 Years	16.8.2019 [revoked on 16.8.2021]
11	A/YL-KTN/660	Proposed Temporary Place of Recreation, Sports or Culture (Hobby Farm) for a Period of 3 Years	4.10.2019 [revoked on 4.9.2021]
12	A/YL-KTN/666	Proposed Temporary Place of Recreation, Sports or Culture (Hobby Farm) for a Period of 3 Years	4.10.2019 [revoked on 4.11.2021]
13	A/YL-KTN/690	Proposed Temporary Place of Recreation, Sports or Culture (Hobby Farm) for a Period of 3 Years	17.1.2020 [revoked on 17.7.2021]
14	A/YL-KTN/691	Proposed Temporary Place of Recreation, Sports or Culture (Hobby Farm) for a Period of 3 Years and Filling of Land	17.1.2020 [revoked on 17.1.2021]
15	A/YL-KTN/697	Temporary Place of Recreation, Sports or Culture (Hobby Farm) for a Period of 3 Years	24.4.2020 [revoked on 24.7.2022]
16	A/YL-KTN/693	Temporary Place of Recreation, Sports or Culture (Hobby Farm and Caravan Holiday Camp) for a Period of 3 Years and Filling of Land	15.5.2020 [revoked on 15.6.2022]
17	A/YL-KTN/705	Proposed Temporary Place of Recreation, Sports or Culture (Hobby Farm) for a Period of 3 Years	15.5.2020 [revoked on 15.11.2021]
18	A/YL-KTN/726	Proposed Temporary Place of Recreation, Sports or Culture (Hobby Farm) for a Period of 3 Years and Filling of Land	6.11.2020
19	A/YL-KTN/745	Proposed Temporary Place of Recreation, Sports or Culture (Hobby Farm) for a Period of 5 Years and Land Filling	5.2.2021 [revoked on 5.2.2022]
20	A/YL-KTN/758	Proposed Temporary Place of Recreation, Sports or Culture (Hobby Farm) for a Period of 3 Years	30.4.2021

	Application No.	<u>Use(s) / Development(s)</u>	Date of Consideration
21	A/YL-KTN/766	Temporary Place of Recreation, Sports or Culture (Hobby Farm) for a Period of 3 Years	11.6.2021 [revoked on 11.9.2022]
22	A/YL-KTN/772	Temporary Place of Recreation, Sports or Culture (Hobby Farm and Caravan Holiday Camp) with Ancillary Canteen for a Period of 3 Years and Filling of Land	9.7.2021 [revoked on 9.7.2022]
23	A/YL-KTN/782	Proposed Temporary Place of Recreation, Sports or Culture (Hobby Farm) for a Period of 3 Years and Filling of Land	10.9.2021
24	A/YL-KTN/802	Proposed Temporary Place of Recreation, Sports or Culture (Hobby Farm) for a Period of 5 Years and Filling of Land	6.5.2022
25	A/YL-KTN/806	Proposed Temporary Place of Recreation, Sports or Culture (Hobby Farm) for a Period of 5 Years and Filling of Land	20.5.2022
26	A/YL-KTN/844	Temporary Holiday Camp, Place of Recreation, Sports or Culture (Hobby Farm and Prawning Ground) and Barbecue Site with Ancillary Facilities for a Period of Years and Filling of Land	12.8.2022
27	A/YL-KTN/826	Temporary Holiday Camp, Place of Recreation, Sports or Culture (Hobby Farm and Prawning Ground) and Barbecue Site with Ancillary Facilities for a Period of Years and Filling of Land	9.9.2022
28	A/YL-KTN/838	Proposed Temporary Place of Recreation, Sports or Culture (Hobby Farm) and Holiday Camp with Ancillary Facilities for a Period of 3 Years and Filling of Land	11.11.2022
29	A/YL-KTN/853	Proposed Temporary Place of Recreation, Sports or Culture (Hobby Farm) for a Period of 5 Years and Filling of Land	13.1.2023

Government Departments' General Comments

1. Land Administration

Comments of the District Lands Officer/Yuen Long, Lands Department (DLO/YL, LandsD):

• no objection to the application.

2. Traffic

Comments of the Commissioner for Transport (C for T):

- having reviewed the FI submitted (**Appendix Ia**), he has no further comment on the application from traffic engineering perspective; and
- an approval condition on no vehicle is allowed to queue back to or reverse onto / from public road at any time during the planning approval period is required.

Comments of the Chief Highway Engineer/New Territories West, Highways Department (CHE/NTW, HyD):

no objection to the application.

3. Environment

Comments of the Director of Environmental Protection (DEP):

- there is no environmental complaint concerning the Site received by DEP in the past three years; and
- he has no objection to the application.

4. Landscape

Comments of the Chief Town Planner/Urban Design and Landscape, Planning Department (CTP/UD&L, PlanD):

- he has no objection to the application from landscape planning perspective;
- based on aerial photo, the Site is situated in an area of rural inland plains landscape character comprising of vacant lands, farmlands, temporary structures, village houses, scattered tree groups and Kam Tin River at the south of the Site. The proposed use is not incompatible with the surrounding landscape setting; and

 according to site photos taken, the Site is fenced off, vacant, partly paved with some temporary structures. No significant landscape resources is observed within the Site. Significant adverse impact on landscape resources arising from the proposed use is not anticipated.

5. Drainage

Comments of the Chief Engineer/Mainland North, Drainage Services Department (CE/MN, DSD):

- he has no objection in-principle to the development from the public drainage point of view; and
- should the application be approved, approval conditions requiring submission, implementation and maintenance of a revised drainage proposal for the proposed development to his satisfaction or of the Board should be included in the planning approval.

6. Agriculture and Nature Conservation

Comments of the Director of Agriculture, Fisheries and Conservation (DAFC):

- the Site falls within the "AGR" zone and is vacant. On the understanding that agricultural activities will be involved in the Site, he has no strong view against the application from agricultural perspective;
- the Site should be reinstated upon expiry of the planning permission; and
- he has no comment on the planning application form nature conservation perspective.

7. Fire Safety

Comments of the Director of Fire Services (D of FS):

- he has no objection in-principle to the proposal subject to FSIs being provided to his satisfaction;
- the FSIs proposal submitted in FI (Appendix Ia) is considered acceptable.

8. Building Matters

Comments of the Chief Building Surveyor/New Territories West, Buildings Department (CBS/NTW, BD):

- before any new building works are to be carried out on the Site, prior approval and consent of the BA should be obtained, otherwise they are unauthorized building works (UBW). An Authorized Person should be appointed as the co-ordinator for the proposed building works in accordance with the Buildings Ordinance (BO);
- his detailed comments on UBW, provision of access, excavation works, enforcement action, temporary or licensed structures and exemption of GFA are at Appendix IV;
 and
- detailed checking under BO will be carried out at building plan submission stage.

9. District Office's Comments

Comments of the District Officer (Yuen Long), Home Affairs Department (DO(YL), HAD):

• he has not received any comments from the locals upon close of consultation and has no particular comments on the application.

10. Other Departments

 the Project Manager (West), Civil Engineering and Development Department; Chief Engineer/Construction, Water Supplies Department; Director of Electrical and Mechanical Services; and Commissioner of Police have no adverse comment on/ no objection to the application.

Appendix IV of RNTPC Paper No. A/YL-KTN/857B

Recommended Advisory Clauses

- (a) prior planning permission should have been obtained before commencing the applied use at the Site;
- (b) the permission is given to the development/uses and structures under application. It does not condone any other development/uses and structures which currently occur on the Site but not covered by the application. Immediate action should be taken to discontinue such development/uses and remove such structures not covered by the permission;
- (c) to note the comments of the District Lands Officer/Yuen Long, Lands Department (DLO/YL, LandsD) that:
 - the Site comprises an Old Schedule Agricultural Lot held under the Block Government Lease which contains the restriction that no structures are allowed to be erected without the prior approval of the Government; and
 - should planning approval be given to the subject planning application, the lot owner(s) will need to apply to his office to permit the structure(s) to be erected or regularize any irregularities on the private lot, if any. Besides, given the proposed use is temporary in nature, only application for regularization or erection of temporary structure(s) will be considered. Applications for any of the above will be considered by LandsD acting in the capacity as the landlord or lessor at its sole discretion and there is no guarantee that such application(s) will be approved. If such application(s) is approved, it will be subject to such terms and conditions, including among others the payment of rent or fee, as may be imposed by the LandsD;
- (d) to note the comments of the Commissioner for Transport (C for T) that:
 - the Site is connected to the public road network via a section of a local access road which is not managed by Transport Department. The land status of the local access road should be checked with the Lands Department. Moreover, the management and maintenance responsibilities of the local access road should be clarified with the relevant lands and maintenance authorities accordingly;
- (e) to note the comments of the Chief Highway Engineer/New Territories West, Highways Department (CHE/NTW, HyD) that:
 - the applicant should ensure that the run-in/out on Chi Ho Road is constructed in accordance with the latest version of HyD Standard Drawings No. H1113 and

H1114, or H5133, H5134 and H5135, whichever set if appropriate to match with the existing adjacent pavement; and

- adequate drainage measures should be provided to prevent surface water running from the Site to the nearby public roads/ drains;
- (f) to note the comments of the Director of Agriculture, Fisheries and Conservation (DAFC) that:
 - the applicant should avoid polluting or disturbing the adjacent watercourse during operation (Plan A-2);
- (g) to note the comments of the Director of Environmental Protection (DEP) that:
 - the applicant is advised (i) to follow the relevant mitigation measures and requirements in the revised "Code of Practice on Handling the Environmental Aspects of Temporary Uses and Open Storage Sites" to minimize any potential environmental nuisance; (ii) to avoid the use of public announcement system or any form of audio amplification system on the Site at any time; (iii) to provide adequate supporting infrastructure / facilities for proper collection, treatment and disposal of waste / wastewater generated from the proposed use and avoid polluting the adjacent watercourse. If septic tank and soakaway system will be used in the case of unavailability of public sewer, its design and construction shall follow the requirements of EPD's Practice Note for Professional Person (ProPECC) PN 5/93 "Drainage Plans subject to Comment by the Environmental Protection Department" including percolation test and certification by Authorized Person; and (iv) to meet the statutory requirements under relevant pollution control ordinances;
- (h) to note the comments of the Chief Building Surveyor/New Territories West, Buildings Department (CBS/NTW, BD) that:
 - the Site shall be provided with means of obtaining access thereto from a street and emergency vehicular access in accordance with Regulations 5 and 41D of the Building (Planning) Regulations (B(P)R) respectively. If the Site does not abut on a specified street of not less than 4.5m wide and its permitted development intensity shall be determined under Regulation 19(3) of the B(P)R at the building plan submission stage. Before any new building works (including containers/open sheds as temporary buildings, demolition and land filling, etc.) are to be carried out on the Site, prior approval and consent of the Building Authority (BA) should be obtained, otherwise they are unauthorized building works (UBW). An Authorized Person (AP) should be appointed as the co-ordinator for the proposed building works in accordance with the Buildings Ordinance (BO). For UBW erected on leased land, enforcement action may be taken by the BD to effect their removal in accordance with BD's enforcement policy against UBW as and when necessary. The granting of any planning approval should not be construed as an acceptance of any existing building

works or UBW on the Site under the BO. Any temporary shelters or converted containers for office, storage, washroom or other uses are considered as temporary buildings are subject to the control of Part VII of the B(P)R. Detailed checking under the BO will be carried out at building plan submission stage; and

- (i) to note the comments of the Director of Fire Services (D of FS) that:
 - the installation /maintenance/ modification/ repair work of fire service installation (FSI) shall be undertaken by an Registered Fire Service Installation Contractor (RFSIC). The RFSIC shall after completion of the installation/maintenance/ modification/ repair work issue to the person on whose instruction the work was undertaken a certificate (FS 251) and forward a copy of the certificate to the D of FS.

☐ Urgent	☐ Return Receipt Requested ☐ Sign ☐ Encrypt ☐ Mark Subject Restricted ☐ Expand personal&publ
	Comments on the Section 16 Application No. A/YL-KTN/857 05/09/2022 17:37
From: To: Cc: File Ref:	"Kristy CHOW" <kristy@cahk.org.hk> <tpbpd@pland.gov.hk> "'Roy Ng'" <roy@cahk.org.hk></roy@cahk.org.hk></tpbpd@pland.gov.hk></kristy@cahk.org.hk>
1 attachm	
TPR20220905	(KTN857) ndf

Dear Sir/Madam,

Attached please find our submission on the captioned.

Yours faithfully, Chow Oi Chuen (Ms.) Campaign Officer The Conservancy Association

T: 2728 6781 D: 2272 0307 F: 2728 5538

Registered Name 註冊名稱: The Conservancy Association 長春社 (Incorporated in Hong Kong with limited liability by guarantee 於香港註冊成立的擔保有限公司)

This email is for the sole use of the intended recipient(s) and may contain confidential information.

Unauthorised use, disclosure or distribution of this email or its content is prohibited. If you have received this email in error, please delete it and notify the sender.



The Conservancy Association

香港新界葵涌貨櫃碼頭路 77-81 號 Magnet Place 一期十三樓 1305-6 室 Units 1305-6, 13/F, Tower 1, Magnet Place, 77-81 Container Port Road, 電子郵件 E-mail:cahk@cahk.org.hk Kwai Chung, New Territories, H.K. 網址 Website:www.cahk.org.hk

電話 Tel.:(852)2728 6781 傳真 Fax.:(852)2728 5538

5th September 2022

Town Planning Board 15/F North Point Government Offices 333 Java Road North Point Hong Kong

By e-mail: tpbpd@pland.gov.hk

Dear Sir/Madam,

Comments on the Section 16 Application No. A/YL-KTN/857

The Conservancy Association (CA) OBJECTS to the captioned application.

1. Not in line with the planning intention of Agriculture (AGR) zone

According to the approved Kam Tin North Outline Zoning Plan (OZP) No. S/YL-KTN/9, the planning intention of agriculture zone "is intended primarily to retain and safeguard good quality agricultural land/farm/fish ponds for agricultural purposes. It is also intended to retain fallow arable land with good potential for rehabilitation for cultivation and other agricultural purposes". From the application, however, we cannot see any details to justify that the plan would fulfill the above planning intention.

2. Undesirable precedent of "destroy first, build later"

This site has been subject to land formation and vegetation clearance (Figure 1-7) since January 2014. It is suspected that this is a case of "destroy first, build later". It is suspected that this is a case of "destroy first, build later".

Planning Department and members of Town Planning Board (TPB) should alert that TPB has announced approaches to deter "destroy first, build later" activities in 2011. It stated that "the Board is determined to conserve the rural and natural environment and will not tolerate any deliberate action to destroy the rural and natural environment in the hope that the Board would give sympathetic consideration to subsequent development



The Conservancy Association

會址: 香港新界獎涌貨櫃碼頭路 77-81 號 Magnet Place —期十三樓 1305-6 室 電話 Tel.:(852)2728 6781 傳真 Fax.:(8

Add.: Units 1305-6, 13/F, Tower 1, Magnet Place, 77-81 Container Port Road, Kwai Chung, New Territories, H.K. 網址 Website:www.cahk.org.hk 電話 Tel.:(852)2728 6781 傳真 Fax.:(852)2728 5538

on the site concerned" 1. Therefore, this application should not be given any sympathetic consideration, or it will set an undesirable precedent for similar cases in future.

Yours faithfully, Chow Oi Chuen Campaign Officer The Conservancy Association

¹ TPB Press Release. Available at: http://www.info.gov.hk/gia/general/201107/04/P201107040255.htm

Figure 1-7 According to aerial photos (Source: Google Earth), this site (marked in red) has been subject to land formation and vegetation clearance. It is suspected that this is a case of "destroy first, build later"







Since1968

The Conservancy Association 會址: 香港新界獎灣貨糧碼頭路 77-81 號 Magnet Place —期十三樓 1305-6 室 Add.: Units 1305-6, 13/F, Tower 1, Magnet Place, 77-81 Container Port Road, Kwai Chung, New Territories, H.K. 網址 Website:www.cahk.org.hk







The Conservancy Association

會址: 香港新界葵酒貨櫃礪頭路 77-81 號 Magnet Place —期十三樓 1305-6 室

Add.: Units 1305-6, 13/F, Tower 1, Magnet Place, 77-81 Container Port Road, Kwai Chung, New Territories, H.K.
網址 Website:www.cahk.org.hk







The Conservancy Association 會址: 香港新界獎滿貨櫃礪頭路 77-81 號 Magnet Place —期十三樓 1305-6 室 Add:: Units 1305-6, 13/F, Tower 1, Magnet Place, 77-81 Container Port Road, Kwai Chung, New Territories, H.K. 網址 Website:www.cahk.org.hk





☐ Urgent	Return Receipt Requested	☐ Sign ☐ Encrypt	☐ Mark Subject Restricted	☐ Expand pe	rsonal&pul
	KFBG's comments on tw 06/09/2022 16:52	o planning applicat	ions	e e	
From: To: File Ref:	EAP KFBG <eap@kfbg.org> "tpbpd@pland.gov.hk" <tpbpd@< td=""><td>@pland.gov.hk></td><td></td><td>5 × 5</td><td>**</td></tpbpd@<></eap@kfbg.org>	@pland.gov.hk>		5 × 5	**
2 attachme	ents	lf		a 3	
	# · · · · · · · · · · · · · · · · · · ·	l¥.			

Dear Sir/ Madam,

Attached please see our comments regarding two applications. There are two pdf files attached to this email. If you cannot see/ download/ open these files, please notify us through email.

Thank You and Best Regards,

Ecological Advisory Programme Kadoorie Farm and Botanic Garden

Email Disclaimer:

The information contained in this e-mail (including any attachments) is confidential and is intended solely for the addressee. If you are not the intended recipient, please notify the sender immediately and delete this e-mail from your system. Any unauthorised use, disclosure, copying, printing, forwarding or dissemination of any part of this information is prohibited. KFBG does not accept responsibility and shall not be liable for the content of any e-mail transmitted by its staff for any reason other than bona fide official purposes. There is no warranty that this e-mail is error or virus free. You should not rely on any information that is not transmitted via secure technology.



嘉道理農場暨植物園公司 Kadoorie Farm & Botanic Garden Corporation

The Secretary,
Town Planning Board,
15/F, North Point Government Offices,
333, Java Road, North Point,
Hong Kong.
(Email: tpbpd@pland.gov.hk)

6th September 2022.

By email only

Dear Sir/ Madam,

Proposed Temporary Place of Recreation, Sports or Culture (Hobby Farm) for a Period of 3 Years (A/YL-KTN/857)

- 1. We refer to the captioned.
- 2. A recent on-site photo showing the site and its surroundings is attached in **Figure 1**. We urge the Board to seriously investigate the site status with relevant authority before making a decision on this application.
- 3. Thank you for your attention.

Ecological Advisory Programme Kadoorie Farm and Botanic Garden



嘉道理農場暨植物園公司 Kadoorie Farm & Botanic Garden Corporation

Figure 1. On-site photo showing the site (approximately indicated by the arrow) and its surroundings.



香港新界大埔林錦公路 Lam Kam Road, Tai Po, New Territories, Hong Kong Email: eap@kfbg.org

☐ Urgent	Return Receipt Requested	☐ Sign ☐ Encrypt	☐ Mark Subject Restricted	Expand personal&publ
	A/YL-KTN/857 DD 109 K 06/09/2022 03:51	Cong A IENG		
From: To: File Ref:	tpbpd <tpbpd@pland.gov.hk></tpbpd@pland.gov.hk>		e e e	

A/YL-KTN/857

Lot 1170 RP in D.D. 109, Kong a Leng, Kam Tin

Site area: About 1,640sq.m

Zoning "Agriculture"

Applied use: Hobby Farm / 1 Vehicle Parking

Dear TPB Members,

Objections, this is an existing farm area and the proposed development would reduce the land under cultivation by almost 50%, see plan.

Are there no PATRIOTS left in NT? President Xi has stated that arable land must be used to cultivate food so that China – wakey wakey, yes Hong Kong is part of it – can be self-sufficient with regard to the production of food.

The site is beside the stalled 826 application for a holiday camp.

Members should inquire if there is a relationship between the applicants.

Mary Mulvihill

*,