This document is received on 5 DEC 2023.

The Town Planning Board will formally acknowledge the date of receipt of the application only upon receipt of all the required information and documents.

<u>Form No. S16-III</u> 表格第 S16-III 號

APPLICATION FOR PERMISSION UNDER SECTION 16 OF THE TOWN PLANNING ORDINANCE (CAP. 131)

根據《城市規劃條例》(第131章) 第16條遞交的許可申請

Applicable to Proposal Only Involving Temporary Use/Development of Land and/or Building Not Exceeding 3 Years in Rural Areas or Regulated Areas, or Renewal of Permission for such Temporary Use or Development*

適用於祇涉及位於鄉郊地區或受規管地區土地上及/或建築物內進行 為期不超過三年的臨時用途/發展或該等臨時用途/發展的許可續期的建議*

*Form No. S16-I should be used for other Temporary Use/Development of Land and/or Building (e.g. temporary use/developments in the Urban Area) and Renewal of Permission for such Temporary Use or Development.

*其他土地上及/或建築物內的臨時用途/發展 (例如位於市區內的臨時用途或發展)及有關該等臨時用途/發展的許可續期,應使用表格第 S16-I 號。

Applicant who would like to publish the <u>notice of application</u> in local newspapers to meet one of the Town Planning Board's requirements of taking reasonable steps to obtain consent of or give notification to the current land owner, please refer to the following link regarding publishing the notice in the designated newspapers: https://www.tpb.gov.hk/en/plan application/apply.html

General Note and Annotation for the Form

- 填寫表格的一般指引及註解
- * "Current land owner" means any person whose name is registered in the Land Registry as that of an owner of the land to which the application relates, as at 6 weeks before the application is made 「租行土地擁有人,特在提出由議前六星期,其此名或名稱已在土地計冊處計冊為該申請所屬立的
 - 「現行土地擁有人」指在提出申請前六星期,其姓名或名稱已在土地註冊處註冊為該申請所關乎的土地的擁有人的人
- & Please attach documentary proof 請夾附證明文件
- ^ Please insert number where appropriate 請在適當地方註明編號

Please fill "NA" for inapplicable item 請在不適用的項目填寫「不適用」

Please use separate sheets if the space provided is insufficient 如所提供的空間不足,請另頁說明

Please insert a 「 v 」 at the appropriate box 請在適當的方格内上加上「 v 」 號

230 2958 13/11 by hard Form No. S16-III 表格第 S16-III 號

For Official Use Only	Application No. 申請編號	ATYL-KTN/974
請勿填寫此欄	Date Received 收到日期	- 5 DEG 2023

- The completed form and supporting documents (if any) should be sent to the Secretary, Town Planning Board (the Board), 15/F, North Point Government Offices, 333 Java Road, North Point, Hong Kong.
 申請人須把填妥的申請表格及其他支持申請的文件 (倘有),送交香港北角渣華道 333 號北角政府合署 15 樓城市規劃委員會(下稱「委員會」)秘書收。
- 2. Please read the "Guidance Notes" carefully before you fill in this form. The document can be downloaded from the Board's website at http://www.tpb.gov.hk/. It can also be obtained from the Secretariat of the Board at 15/F, North Point Government Offices, 333 Java Road, North Point, Hong Kong (Tel: 2231 4810 or 2231 4835), and the Planning Enquiry Counters of the Planning Department (Hotline: 2231 5000) (17/F, North Point Government Offices, 333 Java Road, North Point, Hong Kong and 14/F, Sha Tin Government Offices, 1 Sheung Wo Che Road, Sha Tin, New Territories). 請先細閱《申請須知》的資料單張,然後填寫此表格。該份文件可從委員會的網頁下載(網址: http://www.tpb.gov.hk/),亦可向委員會秘書處 (香港北角渣華道 333 號北角政府合署 15 樓-電話:2231 4810 或2231 4835)及規劃署的規劃資料查詢處(熱線:2231 5000) (香港北角渣華道 333 號北角政府合署 17 樓及新界沙田上禾輋路 1 號沙田政府合署 14 樓)索取。
- 3. This form can be downloaded from the Board's website, and obtained from the Secretariat of the Board and the Planning Enquiry Counters of the Planning Department. The form should be typed or completed in block letters. The processing of the application may be refused if the required information or the required copies are incomplete. 此表格可從委員會的網頁下載,亦可向委員會秘書處及規劃署的規劃資料查詢處索取。申請人須以打印方式或以正楷填寫表格。如果申請人所提交的資料或文件副本不齊全,委員會可拒絕處理有關申請。

1.	Name of Applicant	申請人姓名/名稱	R
١.	Name of Applicant	中胡八灶石/石件	7

(□Mr. 先生 /□Mrs. 夫人 /□Miss 小姐 /□Ms. 女士 / ☑ Company 公司 /□ Organisation 機構)

Wing Ho Yuen Landscaping Company Limited 永豪園綠化工程有限公司

2. Name of Authorised Agent (if applicable) 獲授權代理人姓名/名稱(如適用)

(□Mr. 先生 /□Mrs. 夫人 /□Miss 小姐 /□Ms. 女士 / ☑ Company 公司 /□ Organisation 機構)

R-riches Property Consultants Limited 盈卓物業顧問有限公司

3.	Application Site 申請地點	
(a)	Full address / location / demarcation district and lot number (if applicable) 詳細地址/地點/丈量約份及地段號碼(如適用)	Lots 84 (Part), 85 S.A RP (Part), 85 S.C (Part), 86 RP (Part) and 113 (Part) in D.D. 110, Kam Tin, Yuen Long, New Territories
(b)	Site area and/or gross floor area involved 涉及的地盤面積及/或總樓面面 積	☑Site area 地盤面積 3,565 sq.m 平方米☑About 約 ☑Gross floor area 總樓面面積 332 sq.m 平方米☑About 約
(c)	Area of Government land included (if any) 所包括的政府土地面積(倘有)	N/A sq.m 平方米 □About 約

(c) Land use zonc(s) involved 涉及的土地用途地帶 Office for permitted agricuttural use (If there are any Government, institution or community facilities, please illustrate on plan and specify the use and gross floor area (如有任何政所、機構或社區設施、請在圖則上顯示、並註明用途及總樓面面積) 4. "Current Land Owner" of Application Site 申請地點的「現行土地擁有人」 The applicant 申請人 — is the sole "current land owner" (please proceed to Part 6 and attach documentary proof of ownership). 是唯一的「現行土地擁有人」 "《 (請避讚獎寫第 6 部分,並夾附業權證明文件)" is one of the "current land owner" (请读附業權證明文件)" is one of the "current land owner" (请读附業權證明文件)" is not a "current land owner" (請求附業權證明文件)" is not a "current land owner" (請求附業權證明文件)" The application site is entirely on Government land (please proceed to Part 6). 中請地點完全位於政府土地上(請繼續填寫第 6 部分) " 5. Statement on Owner's Consent/Notification 就土地擁有人的同意/通知土地擁有人的陳斌 (a) According to the record(s) of the Land Registry as at	(d)	Name and number of the related statutory plan(s) 有關法定圖則的名稱及編號					
(f) Current use(s) 現時用途 (If there are any Government, institution or community facilities, please illustrate on plan and specify the use and gross floor area) (如有任何政府、機構或社區設施、詩在圖則上顯示,並註明用途及總樓面面積) 4. "Current Land Owner" of Application Site 申請地點的「現行土地擁有人」 The applicant 申請人 — is the sole "current land owner" (please proceed to Part 6 and attach documentary proof of ownership). 是唯一的「現行土地擁有人」 ** (please attach documentary proof of ownership). 是其中一名「現行土地擁有人」 ** (please attach documentary proof of ownership). 是其中一名「現行土地擁有人」 ** (please attach documentary proof of ownership). 是其中一名「現行土地擁有人」 ** 「is not a "current land owner" ** 並不是「現行土地擁有人」 ** 「那在 application site is entirely on Government land (please proceed to Part 6). 申請地點完全位於政府土地上 (請繼續填寫第6部分)。 5. Statement on Owner's Consent/Notification 就土地擁有人的同意/通知土地擁有人的陳述 (a) According to the record(s) of the Land Registry as at	(e)	Addicator zone					
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是其中一名「現行土地擁有人」 #& (請夾附業權證明文件)。 ☑ is not a "current land owner" #. 並不是「現行土地擁有人」 #。 ☐ The application site is entirely on Government land (please proceed to Part 6). 申請地點完全位於政府土地上(請繼續填寫第 6 部分)。 5. Statement on Owner's Consent/Notification 就土地擁有人的同意/通知土地擁有人的陳述 (a) According to the record(s) of the Land Registry as at		is the sole "current land o 是唯一的「現行土地擁	owner''#& (pl 有人」 ^{#&} (訂	ease proceed to Part 6 and attach documentary proof 青繼續填寫第6部分,並夾附業權證明文件)。	of ownership).		
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就土地擁有人的同意/通知土地擁有人的陳述 (a) According to the record(s) of the Land Registry as at							
involves a total of	5.						
□ has obtained consent(s) of	(a)	According to the record(s) of the Land Registry as at					
已取得	(b)	The applicant 申請人 -					
Details of consent of "current land owner(s)" ** obtained 取得「現行土地擁有人」 **同意的詳情 No. of 'Current Lot number/address of premises as shown in the record of the Land Date of consent obtained		has obtained consen	nt(s) of	"current land owner(s)"#.			
No. of 'Current Lot number/address of premises as shown in the record of the Land Date of consent obtained		已取得					
Lot number/address of premises as shown in the record of the Land		Details of consent of "current land owner(s)" # obtained 取得「現行土地擁有人」 #同意的詳情					
Land Owner(s)' 「現行土地擁有 人」數目 Lot number/address of premises as shown that record of the Land (DD/MM/YYYY) 取得同意的日期 (日/月/年)		(DD/MM/YYYY) 取得同意的日期					
			,				
(Please use separate sheets if the space of any box above is insufficient. 如上列任何方格的空間不足,讀另頁說明)							

	Details of the "current land owner(s)" notified 已獲通知「現行土地擁有人」"的詳細資料						
	No. of 'Current Land Owner(s)' 「現行土地擁 有人」數目	Land Registry where	of premises as show e notification(s) has/h 錄已發出通知的地段		Date of notification given (DD/MM/YYYY) 通知日期(日/月/年)		
			100 (100 (100 (100 (100 (100 (100 (100				
	(Plages use sengrate s	sheets if the space of any	hay shave is insufficie	nt 加上那任何专校的:	空間不足,請另頁說明)		
V	has taken reasonabl	le steps to obtain cons 认取得土地擁有人的同	ent of or give notifica	ation to owner(s):	EIDTAC BAJJABANA		
	Reasonable Steps to Obtain Consent of Owner(s) 取得土地擁有人的同意所採取的合理步驟						
	□ sent request for consent to the "current land owner(s)" on(DD/MM/YYYY) ^{#&} 於(日/月/年)向每一名「現行土地擁有人」 [#] 郵遞要求同意書 ^{&}						
	Reasonable Steps to Give Notification to Owner(s) 向土地擁有人發出通知所採取的合理步驟						
	□ published notices in local newspapers on(DD/MM/YYYY) ^{&} 於(日/月/年)在指定報章就申請刊登一次通知 ^{&}						
		in a prominent positio		on site/premises on	•		
	方令	(日/月/年)在	在申請地點/申請處	所或附近的顯明位置	量貼出關於該申請的通知		
	office(s) or ru	ral committee on	4/12/2023 (DD/MM/YYYY)&	l committee(s)/managem		
	於 處,或有關的	(日/月/年) 勺鄉事委員會 ^{&}	把通知寄往相關的	業主立案法團/業主勢	委員會/互助委員會或管		
	Others 其他						
	□ others (please 其他(請指明	5 50			3.		
	·			0			
	9	madaman					

6. Type(s) of Applicatio	n 申請類別				
(A) Temporary Use/Development of Land and/or Building Not Exceeding 3 Years in Rural Areas or Regulated Areas 位於鄉郊地區或受規管地區土地上及/或建築物內進行為期不超過三年的臨時用途/發展 (For Renewal of Permission for Temporary Use or Development in Rural Areas or Regulated Areas, please proceed to Part (B)) (如屬位於鄉郊地區或受規管地區臨時用途/發展的規劃許可續期,請填寫(B)部分)					
		A RECORD MATERIAL CONTRACTOR			
(a) Proposed use(s)/development 擬議用途/發展	Temporary Office for Permi Associated Filling of Land	tted Agricultural Use for a Period of 3 Years and			
		roposal on a layout plan) (請用平面圖說明擬議詳情)			
(b) Effective period of permission applied for 申請的許可有效期	☑ year(s) 年 □ month(s) 個月	3			
(c) Development Schedule 發展	細節表				
Proposed uncovered land are	a 擬議露天土地面積	3,233sq.m ☑About 約			
Proposed covered land area #	疑議有上蓋土地面積	332 sq.m ☑About 約			
Proposed number of building	s/structures 擬議建築物/構築物	數目8			
Proposed domestic floor area	擬議住用樓面面積	N/A sq.m □About 約			
Proposed non-domestic floor	area 擬議非住用樓面面積	332 sq.m ☑About 約			
Proposed gross floor area 擬	義總樓面面積	332 sq.m ☑About 約			
	Proposed height and use(s) of different floors of buildings/structures (if applicable) 建築物/構築物的擬議高度及不同樓層的擬議用途 (如適用)(Please use separate sheets if the space below is insufficient) (如以下空間不足,請另頁說明)				
	spaces by types 不同種類停車位	104			
Private Car Parking Spaces 私家 Motorcycle Parking Spaces 電單		4			
Light Goods Vehicle Parking Sp					
Medium Goods Vehicle Parking	Medium Goods Vehicle Parking Spaces 中型貨車泊車位				
Heavy Goods Vehicle Parking S	THE DESCRIPTION OF THE PROPERTY AND PARTY.				
Others (Please Specify) 其他 (請列明)					
Proposed number of loading/unloading spaces 上落客貨車位的擬議數目					
Taxi Spaces 的士車位	S objects TO IT IN NOT IT IN INC.	74.3A III			
Coach Spaces 旅遊巴車位					
Light Goods Vehicle Spaces 輕	1 (LGV)				
	Medium Goods Vehicle Spaces 中型貨車車位				
Heavy Goods Vehicle Spaces 重型貨車車位 Others (Please Specify) 其他 (請列明)					
A STAN MACACAL					

Proposed operating hours 擬議營運時間 09:00 to 18:00 daily, including public holiday						
Yes 是 (d) Any vehicular access to the site/subject building? 是否有車路通往地盤/ 有關建築物?			 ✓ There is an existing access. (please indicate the street name, where appropriate) 有一條現有車路。(請註明車路名稱(如適用)) Accessible from Kong Po Road via a local access □ There is a proposed access. (please illustrate on plan and specify the width) 有一條擬議車路。(請在圖則顯示,並註明車路的闊度) 			
		No 否				
(e)	(If necessary, please u	se separate shee for not providin	議發展計劃的影響 ts to indicate the proposed measures to minimise possible adverse impacts or give g such measures. 如需要的話,請另頁註明可盡量減少可能出現不良影響的			
(ii)	Does the development proposal involve alteration of existing building? 擬議發展計劃是否包括現有建築物的改動? Does the development proposal involve the operation on the right? 擬議發展是否涉及右列的工程?	No 否 🗹 Yes 是 🗹 (Please provide details 請提供詳情 Please indicate on site plan the boundary of concerned land/pond(s), and particulars of stream tiversion, the extent of filling of land/pond(s) and/or excavation of land) 請用地盤平面圖顯示有關土地/港塘界線,以及河道改道、填塘、填土及/或挖土的細節及/或範圍) Diversion of stream 河道改道 Filling of pond 填塘 Area of filling 填塘面積			
(iii)	Would the development proposal cause any adverse impacts? 擬議發展計劃會否造成不良影響?	Landscape Imp Tree Felling Visual Impact	Yes 會 No 不會 Y 對供水 Yes 會 No 不會 対排水 Yes 會 No 不會 財故 Yes 會 No 不會 No 不會 No 不會 No 不會 Yes 會 No 不會 No 不會 Wot Yes 會 No 不會 Wot Yes 會 No 不會 Wot Yes 會 No 不會			

diameter 請註明盡 幹直徑及	ate measure(s) to minimise the impact(s). For tree felling, please state the number, at breast height and species of the affected trees (if possible) 接量減少影響的措施。如涉及砍伐樹木,請說明受影響樹木的數目、及胸高度的樹、品種(倘可)
位於鄉郊地區或受規管地區	區時用途/發展的許可續期
(a) Application number to which the permission relates 與許可有關的申請編號	A//
(b) Date of approval 獲批給許可的日期	(DD 日/MM 月/YYYY 年)
(c) Date of expiry 許可屆滿日期	(DD 日/MM 月/YYYY 年)
(d) Approved use/development 已批給許可的用途/發展	
(e) Approval conditions 附帶條件	□ The permission does not have any approval condition 許可並沒有任何附帶條件 □ Applicant has complied with all the approval conditions 申請人已履行全部附帶條件 □ Applicant has not yet complied with the following approval condition(s): 申請人仍未履行下列附帶條件: □ Reason(s) for non-compliance: 仍未履行的原因: □ (Please use separate sheets if the space above is insufficient) (如以上空間不足,請另頁說明)
(f) Renewal period sought 要求的續期期間	□ year(s) 年 □ month(s) 個月

7. Justifications 理由
The applicant is invited to provide justifications in support of the application. Use separate sheets if necessary. 現請申請人提供申請理由及支持其申請的資料。如有需要,請另頁說明)。
Please refer to the supplementary statement.
,

<u></u>

8. Declaration 聲明					
I hereby declare that the particulars given in this application are corre本人謹此聲明,本人就這宗申請提交的資料,據本人所知及所信					
I hereby grant a permission to the Board to copy all the materials subr to the Board's website for browsing and downloading by the public fi 本人現准許委員會酌情將本人就此申請所提交的所有資料複製及	ree-of-charge at the Board's discretion.				
Signature □ A _F 簽署	pplicant 申請人 / ☑ Authorised Agent 獲授權代理人				
Matthew NG Name in Block Letters	Planning and Development Manager Position (if applicable)				
姓名(請以正楷填寫) 職位(如適用) Professional Qualification(s) 專業資格 Whember 會員 / □ Fellow of 資深會員 □ HKIP 香港規劃師學會 / □ HKIA 香港建築師學會 / □ HKIS 香港測量師學會 / □ HKIE 香港工程師學會 / □ HKILA 香港園境師學會 / □ HKIUD 香港城市設計學會 □ RPP 註冊專業規劃師 Others 其他 MRTPI, MPIA, CMILT					
on behalf of 代表 R-riches Property Consultants Limited 盈卓物業顧問有限公司 【					
Date 日期	MM/YYYY 日/月/年)				

Remark 備註

The materials submitted in this application and the Board's decision on the application would be disclosed to the public. Such materials would also be uploaded to the Board's website for browsing and free downloading by the public where the Board considers appropriate.

委員會會向公眾披露申請人所遞交的申請資料和委員會對申請所作的決定。在委員會認為合適的情況下,有關申請資料亦會上載至委員會網頁供公眾免費瀏覽及下載。

Warning 警告

Any person who knowingly or wilfully makes any statement or furnish any information in connection with this application, which is false in any material particular, shall be liable to an offence under the Crimes Ordinance. 任何人在明知或故意的情況下,就這宗申請提出在任何要項上是虛假的陳述或資料,即屬違反《刑事罪行條例》。

Statement on Personal Data 個人資料的聲明

1. The personal data submitted to the Board in this application will be used by the Secretary of the Board and Government departments for the following purposes: 委員會就這宗申請所收到的個人資料會交給委員會秘書及政府部門,以根據《城市規劃條例》及相關的城市規

劃委員會規劃指引的規定作以下用途:

(a) the processing of this application which includes making available the name of the applicant for public inspection when making available this application for public inspection; and 處理這宗申請,包括公布這宗申請供公眾查閱,同時公布申請人的姓名供公眾查閱;以及

(b) facilitating communication between the applicant and the Secretary of the Board/Government departments. 方便申請人與委員會秘書及政府部門之間進行聯絡。

- 2. The personal data provided by the applicant in this application may also be disclosed to other persons for the purposes mentioned in paragraph 1 above. 申請人就這宗申請提供的個人資料,或亦會向其他人士披露,以作上述第 1 段提及的用途。
- 3. An applicant has a right of access and correction with respect to his/her personal data as provided under the Personal Data (Privacy) Ordinance (Cap. 486). Request for personal data access and correction should be addressed to the Secretary of the Board at 15/F, North Point Government Offices, 333 Java Road, North Point, Hong Kong. 根據《個人資料(私隱)條例》(第 486 章)的規定,申請人有權查閱及更正其個人資料。如欲查閱及更正個人資料,應向委員會秘書提出有關要求,其地址為香港北角渣華道 333 號北角政府合署 15 樓。

Gist of Applica	ation 申請摘要
consultees, uploaded available at the Plant (請盡量以英文及中	ails in both English and Chinese <u>as far as possible</u> . This part will be circulated to relevant to the Town Planning Board's Website for browsing and free downloading by the public and ning Enquiry Counters of the Planning Department for general information.) 文填寫。此部分將會發送予相關諮詢人士、上載至城市規劃委員會網頁供公眾免費瀏覽及劃資料查詢處供一般參閱。)
Application No. 申請編號	(For Official Use Only) (請勿填寫此欄)
Location/address 位置/地址	Lots 84 (Part), 85 S.A RP (Part), 85 S.C (Part), 86 RP (Part) and 113 (Part) in D.D. 110, Kam Tin Yuen Long, New Territories
Site area 地盤面積	3,565 sq. m 平方米 ☑ About 約
Collis and 17	(includes Government land of包括政府土地 N/A sq. m 平方米 □ About 約)
Plan 圖則	Draft Kam Tin North Outline Zoning Plan No. S/YL-KTN/10
Zoning 地帶	"Agriculture" zone
Type of Application 申請類別	 ✓ Temporary Use/Development in Rural Areas or Regulated Areas for a Period of 位於鄉郊地區或受規管地區的臨時用途/發展為期 ✓ Year(s) 年3
	Renewal of Planning Approval for Temporary Use/Development in Rural Areas or Regulated Areas for a Period of 位於鄉郊地區或受規管地區臨時用途/發展的規劃許可續期為期
	□ Year(s) 年 □ Month(s) 月
Applied use/	

Temporary Office for Permitted Agricultural Use for a Period of 3 Years and Associated Filling of Land

development

申請用途/發展

(i)	Gross floor area and/or plot ratio	sq.m 平方米 Plot Ra				ntio 地積比率
總樓面面積及/或地積比率		Domestic 住用		□ About 約 □ Not more than 不多於		□About 約 □Not more than 不多於
		Non-domestic 非住用	332	☑ About 約 □ Not more than 不多於	0.09	☑About 約 □Not more than 不多於
(ii)	No. of blocks 幢數	Domestic 住用		N/A	161	
	i w	Non-domestic 非住用		8		¥ u
(iii)	Building height/No. of storeys 建築物高度/層數	Domestic 住用		N/A	□ (Not i	m 米 nore than 不多於)
				N/A	□ (Not i	Storeys(s) 層 more than 不多於)
		Non-domestic 非住用	2.8	- 4.5 (about)	□ (Not i	m 米 more than 不多於)
¥				. 1	□ (Not i	Storeys(s) 層 nore than 不多於)
(iv)	Site coverage 上蓋面積		9.3		%	☑ About 約
(v)	No. of parking spaces and loading / unloading spaces 停車位及上落客貨車位數目	Total no. of vehicle parking spaces 停車位總數 Private Car Parking Spaces 私家車車位 Motorcycle Parking Spaces 電單車車位 Light Goods Vehicle Parking Spaces 輕型貨車泊車位 Medium Goods Vehicle Parking Spaces 中型貨車泊車位 Heavy Goods Vehicle Parking Spaces 重型貨車泊車位 Others (Please Specify) 其他 (請列明) Total no. of vehicle loading/unloading bays/lay-bys 上落客貨車位/停車處總數 Taxi Spaces 的士車位 Coach Spaces 旅遊巴車位 Light Goods Vehicle Spaces 輕型貨車車位 Medium Goods Vehicle Spaces 中型貨車位 Heavy Goods Vehicle Spaces 重型貨車車位 Others (Please Specify) 其他 (請列明)		4 4 (PC)		
,		- Culcis (1 lease 5)	~~~(胡		12	

Submitted Plans, Drawings and Documents 提交的圖則、繪圖及文件		
	<u>Chinese</u> 中文	English 英文
Plans and Drawings 圖則及繪圖		
Master layout plan(s)/Layout plan(s) 總綱發展藍圖/布局設計圖	_	\checkmark
Block plan(s) 樓宇位置圖		
Floor plan(s) 樓宇平面圖		
Sectional plan(s) 截視圖		
Elevation(s) 立視圖		
Photomontage(s) showing the proposed development 顯示擬議發展的合成照片		N
Master landscape plan(s)/Landscape plan(s) 園境設計總圖/園境設計圖		
Others (please specify) 其他(請註明)	📙 .	\checkmark
Plan showing the zoning of the Site, Plan showing filling of land area of the site, Swept pa		
Location plan, Plan showing the land status of the Site, Drainage proposal, FSIs Proposal		
Reports 報告書		
Planning Statement/Justifications 規劃綱領/理據		\mathbf{Z}
Environmental assessment (noise, air and/or water pollutions)		
環境評估(噪音、空氣及/或水的污染)		
Traffic impact assessment (on vehicles) 就車輛的交通影響評估		
Traffic impact assessment (on pedestrians) 就行人的交通影響評估		
Visual impact assessment 視覺影響評估		
Landscape impact assessment 景觀影響評估		
Tree Survey 樹木調查		
Geotechnical impact assessment 土力影響評估		
Drainage impact assessment 排水影響評估		
Sewerage impact assessment 排污影響評估		
Risk Assessment 風險評估		
Others (please specify) 其他(請註明)		
Note: May insert more than one 「レ」. 註:可在多於一個方格內加上「レ」號		

Note: The information in the Gist of Application above is provided by the applicant for easy reference of the general public. Under no circumstances will the Town Planning Board accept any liabilities for the use of the information nor any inaccuracies or discrepancies of the information provided. In case of doubt, reference should always be made to the submission of the applicant. 註: 上述申請摘要的資料是由申請人提供以方便市民大眾參考。對於所載資料在使用上的問題及文義上的歧異,城市規劃委員

會概不負責。若有任何疑問,應查閱申請人提交的文件。

Supplementary Statement

1) Background

- 1.1 The applicant seeks planning permission from the Town Planning Board (the Board) to use *Lots* 84 (Part), 85 S.A RP (Part), 85 S.C (Part), 86 RP (Part) and 113 (Part) in D.D. 110, Kam Tin, Yuen Long, New Territories (the Site) for 'Temporary Office for Permitted Agricultural Use for a Period of 3 Years and Associated Filling of Land' (proposed development) (Plan 1).
- 1.2 The applicant is a local landscaping company providing landscaping, horticultural and arboricultural services. The Site is currently used as a plant nursery and the applicant would like to continues use portion of the Site as back office to support the daily operation of the development, while the remaining area is for agricultural use, i.e. plant nursery, greenhouses, etc...

2) Planning Context

- 2.1 The Site falls within an area zoned as "Agriculture" ("AGR") on the Draft Kam Tin North Outline Zoning Plan (OZP) No.: S/YL-KTN/10 (Plan 2). According to the Notes of the OZP, 'office' use is not a column one nor column two use within the "AGR" zone, which requires planning permission from the Board. The Site is currently used as a plant nursery with the applied office. As majority of the Site is used for the always permitted agricultural use, therefore, approval of the current application on a temporary basis of 3 years would not jeopardize the long-term planning intention of the "AGR" zone.
- 2.2 Furthermore, the Site is the subject of a previous S.16 planning application (No. A/YL-KTN/760) for the same use that was submitted by the same applicant, which was approved by the Board on a temporary basis of 3 years on 14/5/2021. When compared with the previous application, the site area, covered area, gross floor area (GFA), operation mode, number of parking and loading/unloading (L/UL) spaces remain unchanged. While there is slight increase in the number of structures as to support the daily operation of the Site.
- 2.3 In support of the current application, the applicant submitted the accepted drainage proposal of the previous application (No. A/YL-KTN/760) and an updated fire service installations (FSIs) proposal to support the current application (Appendices I and II).



3) Development Proposal

3.1 The Site occupies an area of 3,565 m² (about) (Plan 3). The operation hours are from 09:00 to 18:00 daily, including public holiday. 8 single-storey structures are proposed at the Site for site office, meeting room, covered car parking spaces, portable toilet, gardener resting room, storage of fertilizers and farm tools, greenhouse and guardroom with total GFA of 332 m² (about) (Plan 4). It is estimated that 8 staff will work at the Site. As the Site is proposed for 'office' use, no visitor is anticipated at the Site. Details of development parameters are shown at Table 1 below:

Table 1 – Major Development Parameters

Application Site Area	3,565 m² (about)
Covered Area	332 m² (about)
Uncovered Area	3,233 m² (about)
Plot Ratio	0.09 (about)
Site Coverage	9.3 % (about)
Number of Structure	8
Total GFA	332 m² (about)
- Domestic GFA	Not applicable
- Non-Domestic GFA	332 m² (about)
Building Height	2.8 m – 4.5 m (about)
No. of Storey	1

- 3.2 Portion of the Site (i.e. 851 m²) has been filled with concrete of not more than 0.2 m (about) in depth for site formation of structures and circulation purposes (**Plan 5**). As heavy loading of structure and vehicle would compact the existing soiled ground and weaken the ground surface, concrete site formation is required to meet the operation needs and that has been kept to minimal for the operation of the proposed development. No further filling of land will be carried out at the Site during the planning approval period. The applicant will reinstate the Site to an amenity area after the planning approval period.
- 3.3 The Site is accessible from Kong Po Road via a local access (**Plan 1**). A total of 5 parking and L/UL spaces are provided at the Site. Details of spaces are shown at **Table 2** below:

Table 2 - Parking and L/UL Provision

Type of Space	No. of Space
Private Car Parking Space for Staff - 2.5 m (W) x 5 m (L)	4
L/UL Space for Light Goods Vehicle - 3.5 m (W) x 7 m (L)	1

3.4 Sufficient space is provided for vehicle to smoothly manoeuvre within the Site to ensure that no vehicle will turn back onto the local access (Plan 6). No medium or heavy goods vehicles including container tractors/trailers, as defined in the Road Traffic Ordinance are allowed to be parked/stored on or enter/exit the Site at any time during the planning approval period. As traffic generated and attracted by the proposed development as shown at Table 3 below is minimal, adverse traffic impact should not be anticipated.

Table 3 - Trip Generation and Attraction of the Site

Time Davied	P	C	LC	SV	2 May Total
Time Period	In	Out	In	Out	2-Way Total
Trips at <u>AM peak</u> per hour (i.e. 09:00 – 10:00)	3	0	0	0	3
Trips at <u>PM peak</u> per hour (i.e. 17:00 – 18:00)	0	3	0	0	3
Traffic trip per hour (i.e. 10:00 – 17:00)	1	1	1	1	4

3.5 The applicant will strictly follow the 'Code of Practice on Handling the Environmental Aspects of Temporary Uses and Open Storage Sites' by the EPD to minimize all possible environmental impacts on the nearby sensitive receivers. The applicant will also follow the Professional Persons Environmental Consultative Committee Practice Notes (ProPECC PNs) for sewage treatment at the Site.

4) Conclusion

- 4.1 The proposed development will not create significant nuisance to the surrounding area. Adequate mitigation measures are provided by the applicant (i.e. submission of the accepted drainage proposal of the previous application and an updated FSIs proposals) in order to mitigate any adverse impact arising from the proposed development (Appendices I and II).
- 4.2 In view of the above, the Board is hereby respectfully recommended to approve the subject

application for 'Temporary Office for Permitted Agricultural Use for a Period of 3 Years and Associated Filling of Land'.

R-riches Property Consultants Limited

October 2023



LIST OF PLANS

Plan 1	Location Plan
Plan 2	Plan Showing the Zoning of the Application Site
Plan 3	Plan Showing the Land Status of the Application Site
Plan 4	Layout Plan
Plan 5	Filling of Land Area of the Application Site
Plan 6	Swept Path Analysis

APPEDNICES

Appendix I	The Accepted Drainage Proposal of the Previous S.16 Planning Application
	No. A/YL-KTN/760

Appendix II Fire Service Installations Proposal



粉嶺、上水及元朗東規劃處 新界荃灣青山公路 388 號 中染大廈 22 棟 2202 室



Planning Department

Fanling, Sheung Shui & Yuen Long East District Planning Office Unit 2202, 22/F., CDW Building. 388 Castle Peak Road, Tsuen Wan, N.T.

來函檔號

Your Reference: DD110 Lot 84 (Part) & VL

本署檔號

Our Reference: TPB/A/YL-KTN/760

電話號碼

Tel. No. :

停真機號碼 Fax No.: APPENDIX I

By Post & Fax

9 September 2022

Dear Sir/Madam.

Submission for Compliance with Approval Condition (d) Submission of Drainage Proposal

Temporary Office for Permitted Agricultural Use for a Period of 3 Years and Filling of Land in "Agriculture" Zone, Lots 84(Part), 85 S.A RP(Part), 85 S.C(Part), 86 RP(Part) and 113(Part) in D.D. 110, Kam Tin, Yuen Long

(Application No. A/YL-KTN/760)

I refer to your submission dated 25.8.2022 for compliance with the captioned approval condition. Relevant department has been consulted on your submission. Your submission is considered:

$ \nabla$	Acceptable.	The captioned	condition	has	been	complied	with
		Contraction of the Contraction o	•				1120

- Acceptable. Since the captioned condition requires both the submission and implementation of the proposal, it has not been fully complied with. Please proceed to implement the accepted proposal for full compliance with the approval condition.
- Not acceptable. The captioned condition has not been complied with. Please find detailed departmental comments in Appendix.

Should you have any queries, please contact Mr.) of the Drainage Services Department directly.

(Tel

Yours faithfully.

(Anthony LUK)

District Planning Officer/ Fanling, Sheung Shui & Yuen Long East

Planning Department

我們的理想 - 「透過規劃工作,使香港成為世界知名的國際都市。」 Our Vision - "We plan to make Hong Kong an international city of world prominence."



- 2 -

c.c. CE/MN of DSD

Internal CTP/TPB

AL/LD/Iw



Our Ref.: DD110 Lot 84 (Part) & VL Your Ref.: TPB/A/YL-KTN/760



By Email

25 August 2022

Dear Sir,

Compliance with Approval Condition (d)

Proposed Temporary Office for Permitted Agricultural Use for a Period of 3 Years and Filling of Land in "Agriculture" Zone, Lots 84 (Part), 85 S.A RP (Part), 85 S.C (Part), 86 RP (Part) and 113 (Part) in D.D. 110, Kam Tin, Yuen Long

(S16 Planning Application No. A/YL-KTN/760)

We are writing to submit drainage proposal (**Appendix I**) for compliance with approval condition (d) of the subject application, i.e. the submission of drainage proposal. Your kind attention to the matter is much appreciated.

Should you require more information regarding the application, please contact our Ms. or the undersigned at your convenience.

Yours faithfully,

For and on behalf of

R-riches Property Consultants Limited


Órpheus LEE

Planning and Development Consultant


cc DPO/FSYLE, PlanD





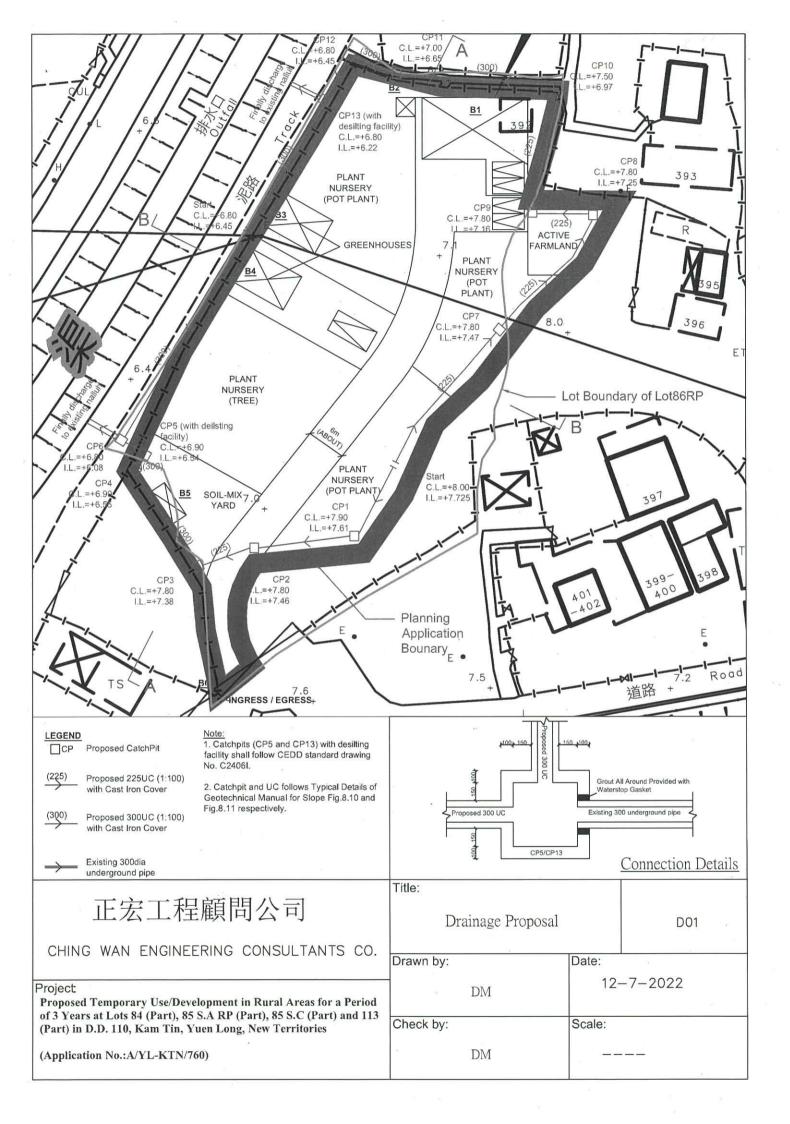



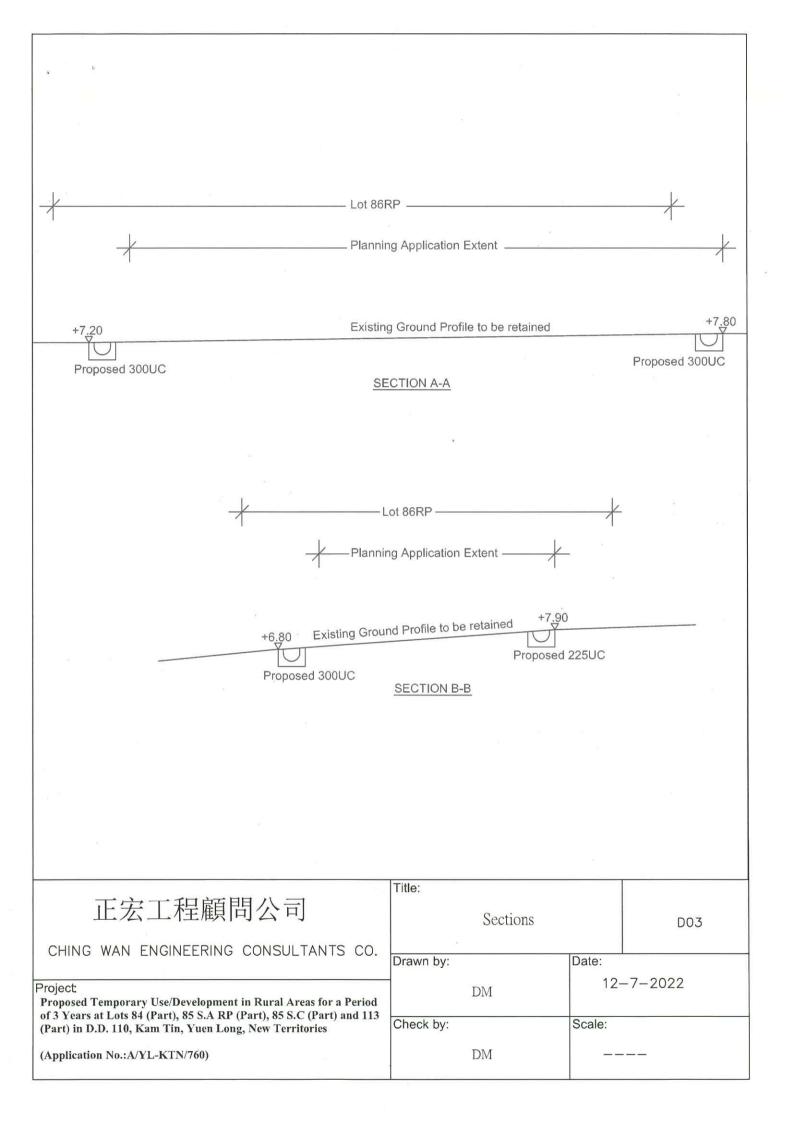

Proposed Temporary Use/Development in Rural Areas for a Period of 3 Years at Lots 84 (Part), 85 S.A RP (Part), 85 S.C (Part) and 113 (Part) in D.D. 110, Kam Tin, Yuen Long, New Territories

Project:

(Application No.:A/YL-KTN/760)

Date:

14/7/2022

Drainage Design Calculation

Catchment Area A	=	2083	m2			
Calculation of Runoff	from the Pro	posed De	evelopment,			
		Q	= 0.278 C i A		where A= 11/11*3300	
		С	= 0.44		•	
		A	= 2083 = 0.002083	m ² km ²		8
	take	i	= 250	mm/hr		
,	Therefore,	Q	= 0.278*0.95*250*0.0 = 0.064 = <u>3822</u>	018 m³/sec lit/min		
Catchment Area B	=	1547	m2			
Calculation of Runoff	from the Pro	posed De	evelopment,			
		Q	= 0.278 C i A		where A= 11/11*3300	
		С	= 0.44			
		A	= 1547 = 0.001547	m ² km ²		
	take	i	= 250	mm/hr		
, a	Therefore,	Q	= 0.278*0.95*250*0.0 = 0.047 = <u>2838</u>	018 m³/sec lit/min		

1/	Catchment Area C	=	580	m2		3
$C = 0.95 \qquad (P.42 \text{ of Stormwater Drainage Manual})$ $A = 580 \qquad m^2 \\ = 0.00058 \qquad km^2$ $take \qquad i = 250 \qquad mmnhr$ $Therefore, \qquad Q = 0.278*0.95*250*0.0018 \\ = 0.038 \qquad m^2/sec \\ = 2298 \qquad lit/min$ $Catchment Area D = 788 \qquad m2$ $Calculation of Runoff from the Proposed Development,$ $Q = 0.278 \text{ C i A} \qquad where A= 11/11*3300$ $C = 0.95 \qquad (P.42 \text{ of Stormwater Drainage Manual})$ $A = 788 \qquad m^2 \\ = 0.0000788 \qquad km^2$ $take \qquad i = 250 \qquad mm/hr$ $Therefore, \qquad Q = 0.278*0.95*250*0.0018 \\ = 0.052 \qquad m^2/sec \\ = 3122 \qquad lit/min$ $Maximum \{A+C, B+D\} \qquad = \frac{6120}{3122} \qquad lit/min \qquad (Provide 300UC(1:100) is OK)$ $Maximum (C.D) \qquad = \frac{6120}{3122} \qquad lit/min \qquad (Provide 225UC(1:100) is OK)$ $Calculation of Maximum Capacity of Existing 300mm dia. Underground pipe.$ $Manning Equation \qquad V = R^{20} s_0^{2} t_0^{2} h \qquad dia \qquad 300 \text{ mm} \\ where \qquad R = \pi r^{2} t_{2} \pi r \qquad r = 0.075 \qquad m$ $n = 0.012 \qquad s/m^{1/3} \qquad (Talbe 13 \text{ of Stormwater Drainage Manual})$ $If \qquad 100 \qquad S_f = 0.01$ $Therefore, \qquad V = 0.2625^{2/3} t_{0.01}^{0.5} t_{0.012} \qquad m/sec$ $= 1.482 \qquad m/sec$ $Maximum Capacity (Qmax) \qquad V^{*}A \qquad = 0.482^{9} \pi r^{2} \qquad m/sec$ $= 1.482^{9} \pi r^{2} \qquad 1.482^{9} \pi r^{2} \qquad 1.482^{9} \pi r^{2} \qquad 0.105 \qquad m^{3}/sec$	Calculation of Runo	off from the Prop	posed D	evelopment,		
$A = 580 \qquad m^2 \\ = 0.00058 \qquad km^2 \\ take \qquad i = 250 \qquad mm/hr \\ Therefore, \qquad Q = 0.278*0.95*250*0.0018 \\ = 0.038 \qquad m^3/sec \\ = 2298 \qquad li\(m\) li\(m\) in \\ Catchment Area D = 788 m2 \\ Calculation of Runoff from the Proposed Development, Q = 0.278 \text{ Ci A} where A= 11/11*3300 \text{ Where A= 11/11*3300} \text{ C} = 0.95 (P.42 of Stormwater Drainage Manual) A = 788 m^2 \\ = 0.000788 km^2 \text{ take} i = 250 mm\/lir \text{ Therefore, } Q = 0.278*0.95*250*0.0018 \\ = 0.052 \text{ Iii/min} \text{ (Provide 300UC(1:100) is OK)} \text{ Maximum {A+C, B+D}} = \frac{6120}{3122} \text{ li\(m\) in (Provide 225UC(1:100) is OK)} \text{ Calculation of Maximum Capacity of Existing 300mm dia. Underground pipe.} \text{ Manning Equation} \qua$	e.		Q	= 0.278 C i A		where A= 11/11*3300
$A = 580 \qquad m^2 \\ = 0.00058 \qquad km^2 \\ take \qquad i = 250 \qquad mm/hr \\ Therefore, \qquad Q = 0.278*0.95*250*0.0018 \\ = 0.038 \qquad m^3/sec \\ = 2298 \qquad li\(m\) li\(m\) in \\ Catchment Area D = 788 m2 \\ Calculation of Runoff from the Proposed Development, Q = 0.278 \text{ Ci A} where A= 11/11*3300 \text{ Where A= 11/11*3300} \text{ C} = 0.95 (P.42 of Stormwater Drainage Manual) A = 788 m^2 \\ = 0.000788 km^2 \text{ take} i = 250 mm\/lir \text{ Therefore, } Q = 0.278*0.95*250*0.0018 \\ = 0.052 \text{ Iii/min} \text{ (Provide 300UC(1:100) is OK)} \text{ Maximum {A+C, B+D}} = \frac{6120}{3122} \text{ li\(m\) in (Provide 225UC(1:100) is OK)} \text{ Calculation of Maximum Capacity of Existing 300mm dia. Underground pipe.} \text{ Manning Equation} \qua$						
take i = 250 mm/hr Therefore, Q = 0.278*0.95*250*0.0018 = 0.038 m³/sec = 2298 lit/min Catchment Area D = 788 m2 Calculation of Runoff from the Proposed Development, Q = 0.278 C i A where A= 11/11*3300 C = 0.95 (P.42 of Stormwater Drainage Manual) A = 788 m² = 0.000788 km² take i = 250 mm/hr Therefore, Q = 0.278*0.95*250*0.0018 = 0.052 m³/sec = 3122 lit/min Maximum {A+C, B+D} = 6120 lit/min (Provide 300UC(1:100) is OK) Maximum {Capacity of Existing 300mm dia. Underground pipe. Manning Equation V = $R^{278} S_0^{15} h_0$ dia 300 mm where R = $\pi r^2 / 2 \pi r$ r= 0.15 m = $r r^2 = r / 2 \pi r$ r= 0.15 m n = 0.012 s/m^{10} (Talbe 13 of Stormwater Drainage Manual) 1/ 100 S_f = 0.01 Therefore, V = $0.2625^{29} + 0.01^{6.5} / 0.012$ = 1.482* πr^2 = 0.105 m³/sec			C	= 0.95		(P.42 of Stormwater Drainage Manual)
Therefore, $Q = 0.278^{\circ}0.95^{\circ}250^{\circ}0.0018$ $= 0.038 \text{m}^{3}\text{/sec}$ $= 2298 \text{in/min}$ Catchment Area $D = 788 \text{m2}$ Calculation of Runoff from the Proposed Development. $Q = 0.278 \text{C i A}$ where $A = 11/11^{\circ}3300$ $C = 0.95 \text{(P.42 of Stormwater Drainage Manual)}$ $A = 788 \text{m}^{2}$ $= 0.000788 \text{km}^{2}$ take $i = 250 \text{mm/hr}$ Therefore, $Q = 0.278^{\circ}0.95^{\circ}250^{\circ}0.0018$ $= 0.052 \text{m}^{3}\text{/sec}$ $= 3122 \text{lit/min}$ Maximum $\{A+C, B+D\}$ $= \frac{6120}{3122} \text{lit/min}$ (Provide 300UC(1:100) is OK) Maximum CD $= \frac{12}{3122} \text{lit/min}$ dia 300 mm where $R = \pi r^{3}/2\pi r r = 0.15 \text{m}$ where $R = \pi r^{3}/2\pi r r = 0.15 \text{m}$ $= 12 \text{m}$ $= 0.075 \text{m}$ $= 0.012 \text{s/m}^{1/3} \text{(Tabe 13 of Stormwater Drainage Manual)}$ Therefore, $V = 0.2625^{2/3} (0.010^{\circ}5/0.012) \text{m/sec}$ Maximum Capacity Q_{max} $= V^{*}A \text{m/sec}$ Maximum Capacity Q_{max} $= V^{*}A \text{m/sec}$ Maximum Capacity Q_{max} $= V^{*}A \text{m/sec}$ $= 1.482^{\circ} \pi r^{2} \text{m/sec}$ $= 1.482^{\circ} \pi r^{2} \text{m/sec}$			А	= 580	m^2	
Therefore, Q = 0.278*0.95*250*0.0018				= 0.00058	km ²	
Catchment Area D = 788 m2		take	i	= 250	mm/hr	
Catchment Area D = 788 m2 Calculation of Runoff from the Proposed Development. Q = 0.278 C i A where A= 11/11*3300 C = 0.95 (P.42 of Stormwater Drainage Manual) A = 788 m² (P.42 of Stormwater Drainage Manual) A = 788 m² (P.42 of Stormwater Drainage Manual) A = 788 m² (P.42 of Stormwater Drainage Manual) Take i = 250 mm/hr Therefore, Q = 0.278*0.95*250*0.0018 = 0.052 m³/sec = 3122 lit/min Maximum (A+C, B+D) = $\frac{6120}{3122}$ lit/min (Provide 300UC(1:100) is OK) Calculation of Maximum Capacity of Existing 300mm dia. Underground pipe. Manning Equation V = $\frac{R^{25} * S_1^{0.5} / n}{1000}$ dia 300 mm where R = $\frac{\pi r^2 / 2\pi r}{\pi r^2}$ r = 0.15 m where R = $\frac{\pi r^2 / 2\pi r}{\pi r^2}$ r = 0.15 m Therefore, V = $\frac{0.2625^{278} * 0.01^{0.5} / 0.012}{1.482 m/sec}$ (Talbe 13 of Stormwater Drainage Manual) Therefore, V = $\frac{0.2625^{278} * 0.01^{0.5} / 0.012}{1.482 m/sec}$ m/sec		Therefore,	Q			
Catchment Area D = 788 m2 Calculation of Runoff from the Proposed Development, $Q = 0.278 \text{C i A} \qquad \text{where A} = 11/11*3300$ $C = 0.95 \qquad (P.42 \text{of Stormwater Drainage Manual})$ $A = 788 \qquad m^2 \\ = 0.000788 \qquad \text{km}^2$ $\text{take} \qquad \text{i} = 250 \qquad \text{mm/hr}$ $\text{Therefore,} \qquad Q = 0.278*0.95*250*0.018 \\ = 0.052 \qquad \text{m}^3/\text{sec} \\ = 3122 \qquad \text{lit/min}$ Maximum {A+C, B+D} \qquad = \frac{6120}{3122} \qquad \text{lit/min} \qquad \text{(Provide 300UC(1:100) is OK)} \qquad \text{Maximum(C,D)} \qquad \text{adia} \qquad \qquad 300 \text{mm} \qquad \text{dia} \qquad \qquad 300 \text{mm} \qquad \text{mm} \qquad \text{Calculation of Maximum Capacity of Existing 300mm dia. Underground pipe.} \qquad \text{Manning Equation} \qquad \qqqqq \qqqqq \qqqqq \qqqqq \qqqqq \qqqqq \qqqqq \qqqqq \qqqqq \qqqq \qqqqq \qqqqq \qqqqq \qqqqq \qqqq \qqqq \qqqq \qqqqq \qqqq \qqq \qqqq \qqq \qqqq \qqq						· **
Calculation of Runoff from the Proposed Development. $Q = 0.278 \text{ C i A} \qquad \text{where A} = 11/11*3300$ $C = 0.95 \qquad (P.42 \text{ of Stormwater Drainage Manual})$ $A = 788 \qquad m^2 \\ = 0.000788 \qquad \text{km}^2$ $\text{take} \qquad \text{i} = 250 \qquad \text{mm/hr}$ $\text{Therefore,} \qquad Q = 0.278*0.95*250*0.0018 \\ = 0.052 \qquad \text{m}^3/\text{sec} \\ = 3122 \qquad \text{lit/min}$ Maximum {A+C, B+D} $= \frac{6120}{3122} \qquad \text{lit/min} \qquad \text{(Provide 300UC(1:100) is OK)}$ $\text{Maximum}(C,D) \qquad = \frac{6120}{3122} \qquad \text{lit/min} \qquad \text{(Provide 225UC(1:100) is OK)}$ Calculation of Maximum Capacity of Existing 300mm dia. Underground pipe. Manning Equation $V = R^{2/3} \text{ s,}^{0.5} \text{ /n} \qquad \text{dia} \qquad 300 \text{ mm}$ $\text{where} \qquad R = \pi r^2 / 2 / \pi r \qquad r = 0.15 \text{ m}$ $= r / 2 \qquad = 0.075 \qquad \text{m}$ $\text{n} = 0.012 \qquad \text{s/m}^{1/3} \qquad \text{(Talbe 13 of Stormwater Drainage Manual}$ $1/ \qquad 100 \qquad \text{S}_f = 0.01$ $\text{Therefore,} \qquad V = 0.2625^{2/3} \text{ s,} 0.01^{0.5} / 0.012 \\ = 1.482 \qquad \text{m/sec}$ $\text{Maximum Capacity } (Q_{\text{max}}) \qquad = V^* A \\ = 1.482 ^* \pi r^2 \\ = 0.105 \qquad \text{m}^3/\text{sec}$	Catchment Area D	_	788			
$Q = 0.278 \text{C i A} \qquad \text{where A} = 11/11*3300$ $C = 0.95 \qquad (P.42 \text{of Stormwater Drainage Manual})$ $A = 788 \qquad m^2 \\ = 0.000788 \qquad \text{km}^2$ $\text{take} \qquad \text{i} = 250 \qquad \text{mm/hr}$ $\text{Therefore,} \qquad Q = 0.278*0.95*250*0.0018 \\ = 0.052 \qquad \text{m}^3/\text{sec} \\ = 3122 \qquad \text{lit/min}$ $\text{Maximum {A+C, B+D}} \qquad = \frac{6120}{3122} \qquad \text{lit/min} \qquad \text{(Provide 300UC(1:100) is OK)}$ $\text{Calculation of Maximum Capacity of Existing 300mm dia. Underground pipe.}$ $\text{Manning Equation} \qquad V = R^{2/3}*S_f^{0.5}/n \qquad \text{dia} \qquad 300 \text{mm}$ $\text{where} \qquad R = \pi r^2/2 \pi r \qquad r = \qquad 0.15 \text{m}$ $= r/2 \qquad = 0.075 \qquad m$ $n = 0.012 \qquad s/m^{1/3} \qquad \text{(Talbe 13 of Stormwater Drainage Manual)}$ $1/ \qquad 100 S_f = 0.01$ $\text{Therefore,} \qquad V = 0.2625^{2/3}*0.01^{0.5}/0.012 \qquad \text{m/sec}$ $\text{Maximum Capacity } (Q_{\text{max}}) \qquad = V^*A \qquad \text{m/sec}$ $= 1.482* \pi r^2 \qquad = 0.105 \qquad \text{m}^3/\text{sec}$						
$C = 0.95 \qquad (P.42 \text{ of Stormwater Drainage Manual})$ $A = 788 \qquad m^2 \\ = 0.000788 \qquad km^2$ $take \qquad i = 250 \qquad mmn/nr$ $Therefore, \qquad Q = 0.278*0.95*250*0.0018 \\ = 0.052 \qquad m^3/sec \\ = 3122 \qquad lit/min$ $Maximum \{A+C, B+D\} \qquad = \frac{6120}{3122} \qquad lit/min \qquad (Provide 300UC(1:100) is OK)$ $Maximum(C,D) \qquad = \frac{3122}{3122} \qquad lit/min \qquad (Provide 225UC(1:100) is OK)$ $Calculation of Maximum Capacity of Existing 300mm dia. Underground pipe.$ $Manning Equation \qquad V = R^{2/3}*S_0^{10}/n \qquad dia \qquad 300 \text{ mm}$ $where \qquad R = \pi r^2/2\pi r \qquad r= \qquad 0.15 \text{ m}$ $= r/2 \qquad = 0.075 \qquad m$ $n = 0.012 \qquad s/m^{1/3} \qquad (Talbe 13 \text{ of Stormwater Drainage Manual})$ $1/ \qquad 100 \qquad S_t = 0.01$ $Therefore, \qquad V = 0.2625^{2/3}*0.01^{0.5}/0.012 \\ = 1.482 \qquad m/sec$ $Maximum Capacity (Q_{max}) \qquad = V*A \\ = 1.482*\pi r^2 \\ = 0.105 \qquad m^3/sec$	Calculation of Kuno	II from the Proj				
$A = 788 \qquad m^2 \\ = 0.000788 \qquad km^2$ $take \qquad i = 250 \qquad mm/hr$ $Therefore, \qquad Q = 0.278*0.95*250*0.0018 \\ = 0.052 \qquad m^3/sec \\ = 3122 \qquad lit/min$ $Maximum \{A+C, B+D\} \qquad = \frac{6120}{3122} \qquad lit/min \qquad (Provide 300UC(1:100) is OK)$ $Maximum \{C,D\} \qquad = \frac{6120}{3122} \qquad lit/min \qquad (Provide 225UC(1:100) is OK)$ $Calculation of Maximum Capacity of Existing 300mm dia. Underground pipe.$ $Manning Equation \qquad V = R^{2/3}*S_1^{0.5}/n \qquad dia \qquad 300 mm \\ where \qquad R = \pi r^2/2\pi r \qquad r= \qquad 0.15 m$ $= r/2 \qquad \qquad 0.075 \qquad m$ $n = 0.012 \qquad s/m^{1/3} \qquad (Talbe 13 of Stormwater Drainage Manual)$ $1/ \qquad 100 \qquad S_f = 0.01$ $Therefore, \qquad V = 0.2625^{2/5}*0.01^{0.5}/0.012 \\ = 1.482 \qquad m/sec$ $Maximum Capacity (Qmax) \qquad = V*A \\ = 1.482*\pi r^2 \\ = 0.105 \qquad m^3/sec$			Q	= 0.278 C i A		where A= 11/11*3300
take i = 250 mm/hr Therefore, Q = 0.278*0.95*250*0.0018 = 0.052 m³/sec = 3122 lit/min Maximum {A+C, B+D} = $\frac{6120}{3122}$ lit/min (Provide 300UC(1:100) is OK) Maximum{C,D} = $\frac{6120}{3122}$ lit/min (Provide 225UC(1:100) is OK) Calculation of Maximum Capacity of Existing 300mm dia. Underground pipe. Manning Equation V = $R^{2/3} * S_1^{0.5} / n$ dia 300 mm where R = $\pi r^2 / 2 \pi r$ r= 0.15 m = $r/2$ = 0.075 m n = 0.012 $s/m^{1/3}$ (Talbe 13 of Stormwater Drainage Manual) 1/ 100 S_1 = 0.01 Therefore, V = 0.2625 $^{2/3} * 0.01^{0.5} / 0.012$ = 1.482 m/sec Maximum Capacity (Q_{max}) = V^*A = 1.482* πr^2 = 0.105 m³/sec			С	= 0.95		(P.42 of Stormwater Drainage Manual)
take i = 250 mm/hr Therefore, Q = 0.278*0.95*250*0.0018 = 0.052 m³/sec = 3122 lit/min Maximum {A+C, B+D} = $\frac{6120}{3122}$ lit/min (Provide 300UC(1:100) is OK) Maximum{C,D} = $\frac{6120}{3122}$ lit/min (Provide 225UC(1:100) is OK) Calculation of Maximum Capacity of Existing 300mm dia. Underground pipe. Manning Equation V = $R^{2/3} * S_1^{0.5} / n$ dia 300 mm where R = $\pi r^2 / 2 \pi r$ r= 0.15 m = $r/2$ = 0.075 m n = 0.012 $s/m^{1/3}$ (Talbe 13 of Stormwater Drainage Manual) 1/ 100 S_1 = 0.01 Therefore, V = 0.2625 $^{2/3} * 0.01^{0.5} / 0.012$ = 1.482 m/sec Maximum Capacity (Q_{max}) = V^*A = 1.482* πr^2 = 0.105 m³/sec			А	= 788	m ²	
Therefore, $Q = 0.278*0.95*250*0.0018$ $= 0.052 m^3/sec$ $= 3122 lit/min$ Maximum {A+C, B+D} $= \frac{6120}{3122} lit/min$ (Provide 300UC(1:100) is OK) Maximum{C,D} $= \frac{6120}{3122} lit/min$ (Provide 225UC(1:100) is OK) Calculation of Maximum Capacity of Existing 300mm dia. Underground pipe. Manning Equation $V = R^{2/3}*S_1^{0.5}/n$ where $R = \pi r^2/2\pi r r= 0.15 \text{ m}$ $= r/2$ $= 0.075 m$ $= r/2 m/2 m/2 $			•			
		take	i	= 250	mm/hr	
		Therefore,	Q	= 0.278*0.95*250*0	0.0018	
Maximum {A+C, B+D} = $\frac{6120}{3122}$ lit/min (Provide 300UC(1:100) is OK) Maximum{C,D} = $\frac{6120}{3122}$ lit/min (Provide 300UC(1:100) is OK) Calculation of Maximum Capacity of Existing 300mm dia. Underground pipe. Manning Equation $V = R^{2/3} * S_1^{0.5} / n$ dia 300 mm where $R = \pi r^2 / 2 \pi r$ $r = 0.15$ m $r = r/2 = 0.075$ m $r = 0.012$ $r = 0.012$ $r = 0.01$ Therefore, $r = 0.012$ $r = 0.01$ Therefore, $r = 0.012$ $r = 0.01$ Therefore, $r = 0.012$ $r = 0$						
Maximum{C,D} = 3122 lit/min (Provide 225UC(1:100) is OK) Calculation of Maximum Capacity of Existing 300mm dia. Underground pipe. Manning Equation V = $R^{2/3}*S_0^{0.5}/n$ dia 300 mm where R = $\pi r^2/2 \pi r$ r= 0.15 m = $r/2$ = 0.075 m n = 0.012 s/m ^{1/3} (Talbe 13 of Stormwater Drainage Manual 1/ 100 S _f = 0.01 Therefore, V = 0.2625 ^{2/3} *0.01 ^{0.5} /0.012 = = 1.482 m/sec Maximum Capacity (Q_{max}) = V*A = = 1.482* π r ² = 0.105 m³/sec				= 3122	livmin	
Calculation of Maximum Capacity of Existing 300mm dia. Underground pipe. Manning Equation $V = R^{2/3} * S_f^{0.5} / n$ $\text{dia} 300 \text{ mm}$ $\text{where} R = \pi r^2 / 2 \pi r r = 0.15 \text{ m}$ $= r / 2$ $= 0.075 m$ $n = 0.012 s / m^{1/3} \text{(Talbe 13 of Stormwater Drainage Manual}$ $1/ 100 S_f = 0.01$ $\text{Therefore,} V = 0.2625^{2/3} * 0.01^{0.5} / 0.012$ $= 1.482 m / \text{sec}$ $\text{Maximum Capacity } (Q_{\text{max}}) = V * A$ $= 1.482 * \pi r^2$ $= 0.105 m^3 / \text{sec}$	Maximum {A+C, B	3+D}			lit/min	(Provide 300UC(1:100) is OK)
Manning Equation $V = R^{2/3}*S_r^{0.5}/n$ dia 300 mm where $R = \pi r^2/2 \pi r$ r= 0.15 m = $r/2 = 0.075$ m $= 0.012$ s/m ^{1/3} (Talbe 13 of Stormwater Drainage Manual 1/ 100 $S_r = 0.012$ s/m ^{1/3} (Talbe 13 of Stormwater Drainage Manual 1/ Therefore, $V = 0.2625^{2/3}*0.01^{0.5}/0.012$ = 1.482 m/sec $V^*A = 1.482*\pi r^2 = 0.105$ m ³ /sec	Maximum{C,D}			= 3122	lit/min	(Provide 225UC(1:100) is OK)
where $R = \pi r^2/2 \pi r$ $r = 0.15 \text{ m}$ $r = 0.15 \text{ m}$ $r = 0.015 \text{ m}$ $r = 0.015 \text{ m}$ $r = 0.012$ $r = 0.$	Calculation of Max	imum Capacity	of Exis	sting 300mm dia. Under	ground pipe.	•
where $R = \pi r^2/2 \pi r$ $r= 0.15 \text{ m}$ $= r/2$ $= 0.075$ m $= 0.012$ $s/m^{1/3}$ (Talbe 13 of Stormwater Drainage Manual 1/ $100 S_f = 0.01$ $= 0.2625^{2/3}*0.01^{0.5}/0.012$ $= 1.482$ $= 1.482*\pi r^2$ $= 0.105$ $= 0.105$ $= 0.15$		4	**	$= R^{2/3} * S_f^{0.5} / n$		
$= r/2 \\ = 0.075 \qquad m$ $n = 0.012 \qquad s/m^{1/3} \qquad \text{(Talbe 13 of Stormwater Drainage Manual}$ $1/ \qquad 100 \qquad S_f = 0.01$ $\text{Therefore,} \qquad V = 0.2625^{2/3} * 0.01^{0.5} / 0.012 \\ = 1.482 \qquad m/\text{sec}$ $\text{Maximum Capacity (Q_{max})} \qquad = V*A \\ = 1.482* \pi \ r^2 \\ = 0.105 \qquad m^3/\text{sec}$	Manning Equation		V		24	
$n = 0.012 \qquad s/m^{1/3} \qquad \text{(Talbe 13 of Stormwater Drainage Manual}$ $1/ \qquad 100 \qquad S_f = 0.01$ $Therefore, \qquad V = 0.2625^{2/3}*0.01^{0.5}/0.012 \\ = 1.482 \qquad m/sec$ $Maximum Capacity (Q_{max}) \qquad = V*A \\ = 1.482*\pi \ r^2 \\ = 0.105 \qquad m^3/sec$	Manning Equation	where				
1/	Manning Equation	where		$= \pi r^2/2 \pi r$ $= r/2$		
1/	Manning Equation	where		$= \pi r^2/2 \pi r$ $= r/2$	r=	
Therefore, $V = 0.2625^{2/3}*0.01^{0.5}/0.012$ = 1.482 m/sec Maximum Capacity (Q_{max}) = $V*A$ = 1.482* π r ² = 0.105 m ³ /sec	Manning Equation	where	R	$= \pi r^{2}/2 \pi r$ $= r/2$ $= 0.075$	r= m	
$= 1.482 m/sec$ Maximum Capacity (Q _{max}) $= V*A$ $= 1.482* \pi r^2$ $= 0.105 m^3/sec$			R	$= \pi r^{2}/2 \pi r$ $= r/2$ $= 0.075$ $= 0.012$	r= m	0.15 m
$= 1.482* \pi r^{2}$ = 0.105 m ³ /sec		100	$R \\ \\ n \\ \\ S_f$	$= \pi r^{2}/2 \pi r$ $= r/2$ $= 0.075$ $= 0.012$ $= 0.01$	r= m s/m ^{1/3}	0.15 m
$= 1.482* \pi r^{2}$ = 0.105 m ³ /sec		100	$R \\ \\ n \\ \\ S_f$	$= \pi r^{2}/2 \pi r$ $= r/2$ $= 0.075$ $= 0.012$ $= 0.2625^{2/3} * 0.01^{0.5}/0$	r= m s/m ^{1/3}	0.15 m
= 0.105 m ³ /sec	1/	100 Therefore,	$\begin{matrix} R \\ \\ n \\ \\ S_f \\ \\ V \end{matrix}$	$= \pi r^{2}/2 \pi r$ $= r/2$ $= 0.075$ $= 0.012$ $= 0.2625^{2/3} * 0.01^{0.5}/0$ $= 1.482$	r= m s/m ^{1/3}	0.15 m
	1/	100 Therefore,	$\begin{matrix} R \\ \\ n \\ \\ S_f \\ \\ V \end{matrix}$	$= \pi r^{2}/2 \pi r$ $= r/2$ $= 0.075$ $= 0.012$ $= 0.2625^{2/3} * 0.01^{0.5}/0$ $= 1.482$ $= V*A$	r= m s/m ^{1/3}	0.15 m
	1/	100 Therefore,	$\begin{matrix} R \\ \\ n \\ \\ S_f \\ \\ V \end{matrix}$	$= \pi r^{2}/2 \pi r$ $= r/2$ $= 0.075$ $= 0.012$ $= 0.2625^{2/3}*0.01^{0.5}/0$ $= 1.482$ $= V*A$ $= 1.482*\pi r^{2}$	r= m s/m ^{1/3} 0.012 m/sec	0.15 m
	Maximum	100 Therefore,	$\begin{matrix} R \\ \\ n \\ \\ S_f \\ \\ V \end{matrix}$	$= \pi r^{2}/2 \pi r$ $= r/2$ $= 0.075$ $= 0.012$ $= 0.2625^{2/3}*0.01^{0.5}/0$ $= 1.482$ $= V*A$ $= 1.482*\pi r^{2}$	r= m s/m ^{1/3} 0.012 m/sec	0.15 m



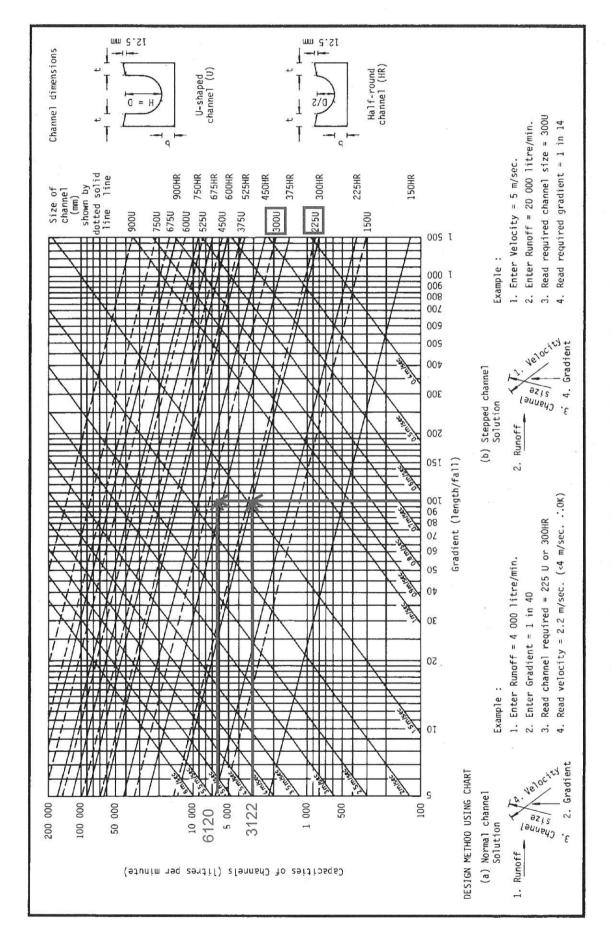


Figure 8.7 - Chart for the Rapid Design of Channels

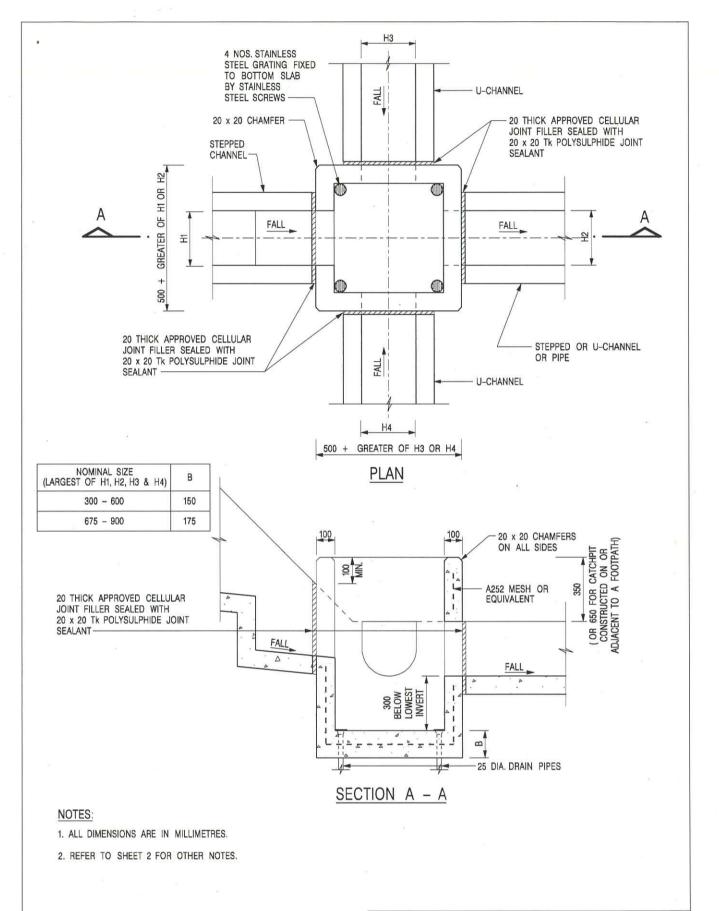

	- FC	RMER DRG. NO. C2406J.	Original Signed	03.2015
,	REF.	REVISION	SIGNATURE	DATE
CATCHPIT WITH TRAP	CED	CIVIL EN	GINEERING AND ENT DEPARTMEN	Т
(CHEET 1 OF 2)	SCALE	1:20	DRAWING NO.	
(SHEET 1 OF 2)	DATE	JAN 1991	C2406 /1	
卓越工程 建設香港	We	Engineer Hong	(ong's Development	

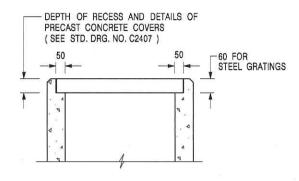

ALTERNATIVE TOP SECTION FOR PRECAST CONCRETE COVERS / GRATINGS

NOTES:

- 1. ALL DIMENSIONS ARE IN MILLIMETRES.
- 2. ALL CONCRETE SHALL BE GRADE 20 /20.
- 3. CONCRETE SURFACE FINISH SHALL BE CLASS U2 OR F2 AS APPROPRIATE.
- 4. FOR DETAILS OF JOINT, REFER TO STD. DRG. NO. C2413.
- 5. CONCRETE TO BE COLOURED AS SPECIFIED.
- UNLESS REQUESTED BY THE MAINTENANCE PARTY AND AS DIRECTED BY THE ENGINEER, CATCHPIT WITH TRAP IS NORMALLY NOT PREFERRED DUE TO PONDING PROBLEM.
- 7. UPON THE REQUEST FROM MAINTENANCE PARTY, DRAIN PIPES AT CATCHPIT BASE CAN BE USED BUT THIS IS FOR CATCHPITS LOCATED AT SLOPE TOE ONLY AND AS DIRECTED BY THE ENGINEER.
- 8. FOR CATCHPITS CONSTRUCTED ON OR ADJACENT TO A FOOTPATH, STEEL GRATINGS (SEE DETAIL 'A' ON STD. DRG. NO. C2405) OR CONCRETE COVERS (SEE STD. DRG. NO. C2407) SHALL BE PROVIDED AS DIRECTED BY THE ENGINEER.
- 9. IF INSTRUCTED BY THE ENGINEER, HANDRAILING (SEE DETAIL 'G' ON STD. DRG. NO. C2405; EXCEPT ON THE UPSLOPE SIDE) IN LIEU OF STEEL GRATINGS OR CONCRETE COVERS CAN BE ACCEPTED AS AN ALTERNATIVE SAFETY MEASURE FOR CATCHPITS NOT ON A FOOTPATH NOR ADJACENT TO IT. TOP OF THE HANDRAILING SHALL BE 1 000 mm MIN. MEASURED FROM THE ADJACENT GROUND LEVEL.
- 10. MINIMUM INTERNAL CATCHPIT WIDTH SHALL BE 1 000 mm FOR CATCHPITS WITH A HEIGHT EXCEEDING 1 000 mm MEASURED FROM THE INVERT LEVEL TO THE ADJACENT GROUND LEVEL. AND, STEP IRONS (SEE DSD STD. DRG. NO. DS1043) AT 300 66 STAGGERED SHALL BE PROVIDED. THICKNESS OF CATCHPIT WALL FOR INSTALLATION OF STEP IRONS SHALL BE INCREASED TO 150 mm.
- FOR RETROFITTING AN EXISTING CATCHPIT WITH STEEL GRATING, SEE DETAIL 'F' ON STD. DRG. NO. C2405.
- SUBJECT TO THE APPROVAL OF THE ENGINEER, OTHER MATERIALS CAN ALSO BE USED AS COVERS / GRATINGS.

_		CIVIL	ENGINEER	ING	AND	
REF.		REVIS	ION	SIGN	ATURE	DATE
-	FORMER	DRG. NO. C2	406J.	Origin	al Signed	03.2015

CATCHPIT WITH TRAP (SHEET 2 OF 2) CEDD

DATE

CIVIL ENGINEERING AND DEVELOPMENT DEPARTMENT

SCALE 1:20

JAN 1991

DRAWING NO. C2406 /2

卓越工程 建設香港

We Engineer Hong Kong's Development

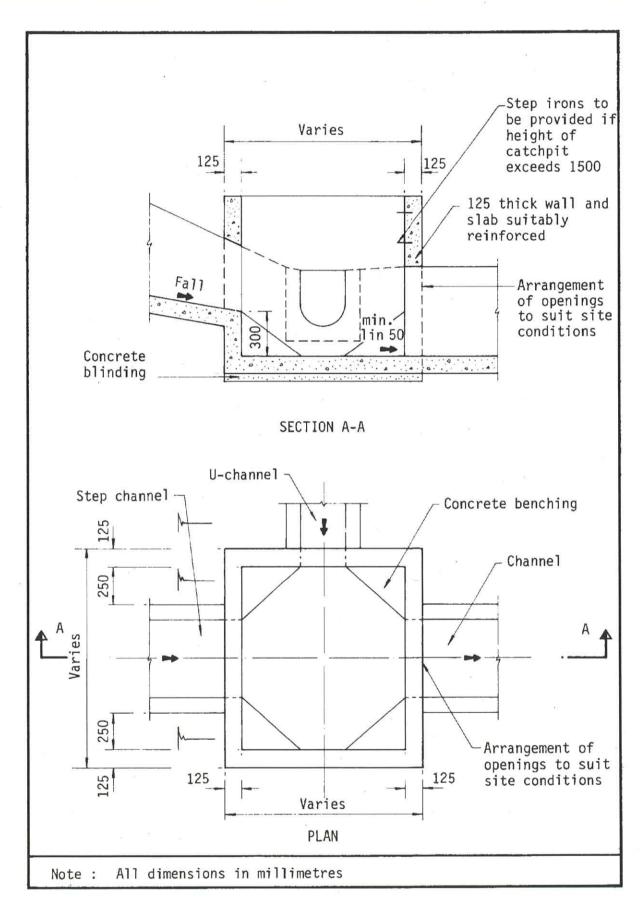


Figure 8.10 - Typical Details of Catchpits


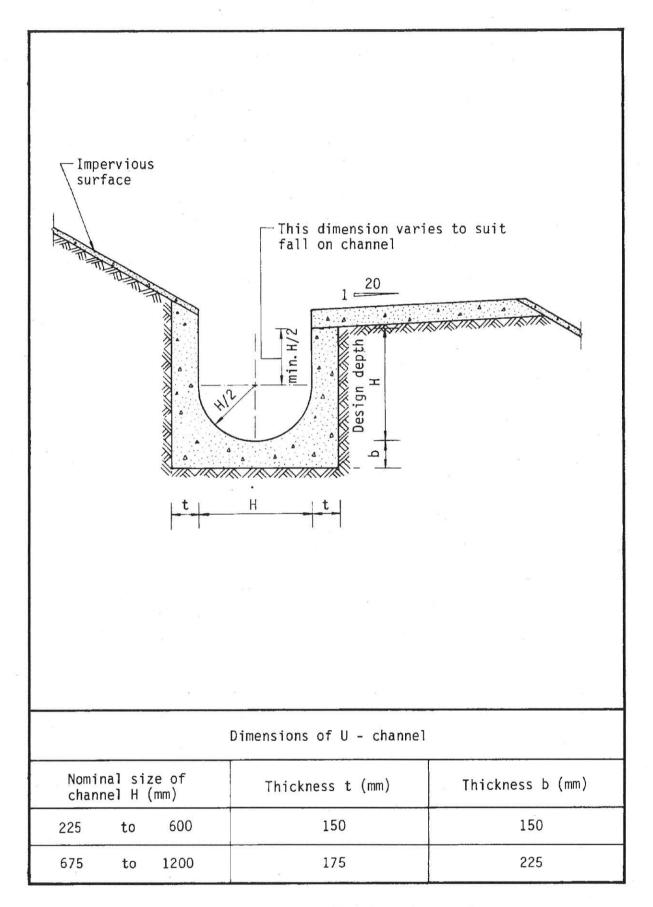


Figure 8.11 - Typical U-channel Details

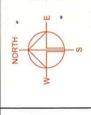

(ABOUT) (ABOUT) (ABOUT)

: 3,565 m² : 332 m² : 3,233 m²

DEVELOPMENT PARAMETERS APPLICATION SITE AREA COVERED AREA UNCOVERED AREA (ABOUT)

9.3 %

PLOT RATIO SITE COVERAGE


(ABOUT) (ABOUT) (ABOUT)

: 8 : NOT APPLICABLE : 332 m² (AB : 332 m² (AB

NO. OF STRUCTURE DOMESTIC GFA NON-DOMESTIC GFA TOTAL GFA

2.8 m - 4.5 m

BUILDING HEIGHT NO. OF STOREY

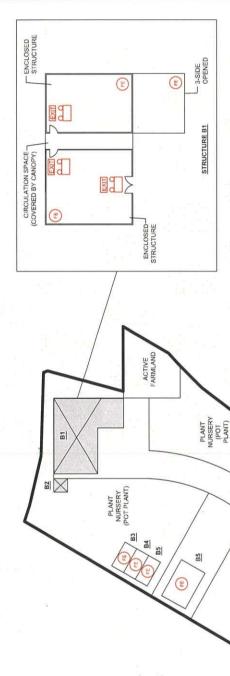

FIRE SERVICE INSTALLATIONS

STRUCTURE B1

3 x EXIT SIGN

PLANT NURSERY (POT PLANT)

SOIL-MIX

B6

PLANT NURSERY (TREE)

E

3 x EMERGENCY LIGHT

9 x 4.5 KG GAS-TYPE FIRE EXTINGUISHER

FS NOTES:

APPLICATION SITE

SUFFICIENT EMERGENCY LIGHTING SHALL BE PROVIDED THROUGHOUT THE ENTIRE BUILDING IN ACCORDANCE. WITH BS5266: PART1 AND BS EN1838

TEMPORARY OFFICE FOR PERMITTED AGRICULTURAL USE FOR A PERIOD OF 3 YEARS AND ASSOCIATED FILLING OF LAND

R-Riches

- SUFFICIENT DIRECTIONAL AND EXIT SIGN SHALL BE PROVIDED IN ACCORDANCE WITH BS5268: PART 1 AND FSD CIRCULAR LETTER \$/2008.
- POTABLE HAND-OPERATED APPROVED APPLIANCE SHALL BE PROVIDED AS REQUIRED BY OCCUPANCY.

INGRESS / EGRESS 5m (ABOUT)(W)

VARIOUS LOTS IN D.D. 110, KAM TIN, YUEN LONG, NEW TERRITORIES

ACCESS IS PROVIDED FOR EMERGENCY VEHICLE TO REACH 30m OF ALL PART OF STRUCTURES. 4


FSIs PROPOSAL 1:800 @ A4 APPENDIX II MN APPLICATION SITE
STRUCTURE
INGRESS / EGRESS LEGEND

27,10,2023


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STRUCTURE	USE	COVERED AREA	GFA	BUILDING
81	SITE OFFICE, MEETING ROOM AND COVERED CAR PARKING SPACES	197 m² (ABOUT)	197 m² (ABOUT)	4.5 m (ABOUT)(1-STOREY)
B2	PORTABLE TOILET	9 m ² (ABOUT)	9 m ² (ABOUT)	3 m (ABOUT)(1-STOREY)
B3*	GARDENER RESTING ROOM	18 m ² (ABOUT)	18 m ² (ABOUT)	2.8 m (ABOUT)(1-STOREY)
B4*	STORAGE OF FARM TOOLS	18 m ² (ABOUT)	18 m ² (ABOUT)	2.8 m (ABOUT)(1-STOREY)
B5*	STORAGE OF FARM TOOLS	18 m ² (ABOUT)	18 m ² (ABOUT)	2.8 m (ABOUT)(1-STOREY)
98	GREENHOUSE	54 m² (ABOUT)	54 m² (ABOUT)	3 m (ABOUT)(1-STOREY)
B7*	STORAGE OF FERTILIZER & FARM TOOLS	15 m² (ABOUT)	15 m² (ABOUT)	2.8 m (ABOUT)(1-STOREY)
88	GUARDROOM	3 m² (ABOUT)	3 m² (ABOUT)	2.8 m (ABOUT)(1-STOREY)
	TOTAL	332 m ² (ABOUT)	332 m ² (ABOUT)	

*STRUCTURES B3 TO B5 AND B7 ARE CONTAINER-CONVERTED STRUCTURES



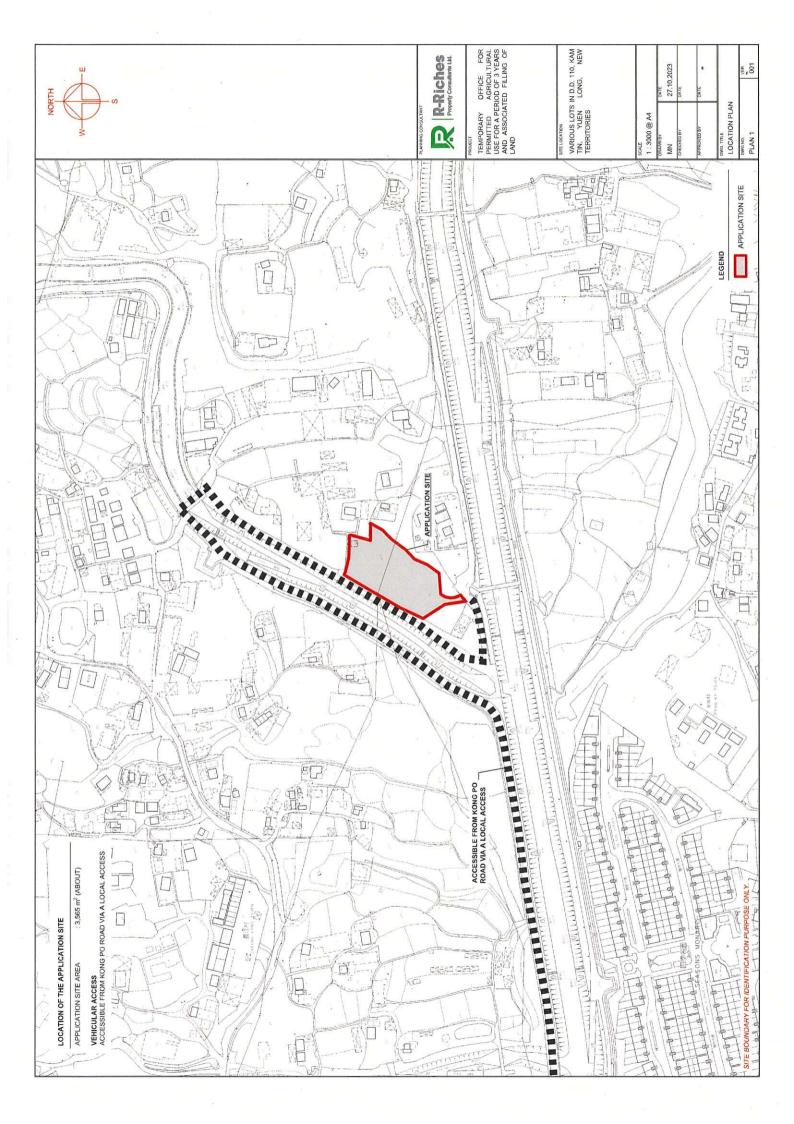

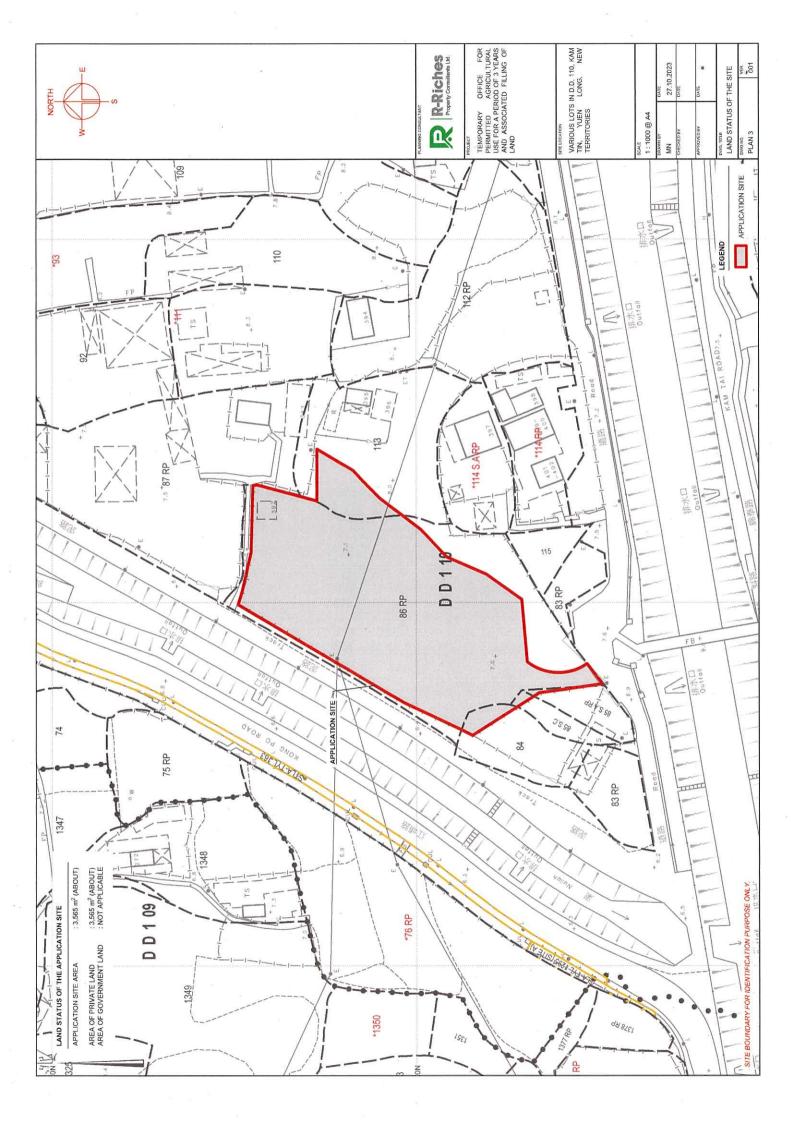

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NORTH			— v

STRUCTURE	USE	COVERED AREA	GFA	BUILDING
B1	SITE OFFICE, MEETING ROOM AND COVERED CAR PARKING SPACES	197 m² (ABOUT)	197 m² (ABOUT)	4.5 m (ABOUT)(1-STOREY)
B2	PORTABLE TOILET	9 m ² (ABOUT)	9 m² (ABOUT)	3 m (ABOUT)(1-STOREY)
B3*	GARDENER RESTING ROOM	18 m ² (ABOUT)	18 m ² (ABOUT)	2.8 m (ABOUT)(1-STOREY)
B4*	STORAGE OF FARM TOOLS	18 m ² (ABOUT)	18 m² (ABOUT)	2.8 m (ABOUT)(1-STOREY)
B5*	STORAGE OF FARM TOOLS	18 m ² (ABOUT)	18 m ² (ABOUT)	2.8 m (ABOUT)(1-STOREY)
B6	GREENHOUSE	54 m ² (ABOUT)	54 m ² (ABOUT)	3 m (ABOUT)(1-STOREY)
B7*	STORAGE OF FERTILIZER & FARM TOOLS	15 m ² (ABOUT)	15 m² (ABOUT)	2.8 m (ABOUT)(1-STOREY)
B8	GUARDROOM	3 m² (ABOUT)	3 m ² (ABOUT)	2.8 m (ABOUT)(1-STOREY)
	TOTAL	332 m² (AROUT)	332 m² (ABOUT)	

(ABOUT) (ABOUT) (ABOUT)

: 3,565 m² : 332 m² : 3,233 m²

APPLICATION SITE AREA COVERED AREA UNCOVERED AREA

DEVELOPMENT PARAMETERS

(ABOUT) (ABOUT)

9.3 %

PLOT RATIO SITE COVERAGE

(ABOUT) (ABOUT) (ABOUT)

.2.8 m - 4.5 m


BUILDING HEIGHT NO. OF STOREY

: 8 : NOT APPLICABLE : 332 m² (AB : 332 m² (AB

NO. OF STRUCTURE DOMESTIC GFA NON-DOMESTIC GFA TOTAL GFA

*STRUCTURES B3 TO B5 AND B7 ARE CONTAINER-CONVERTED STRUCTURES



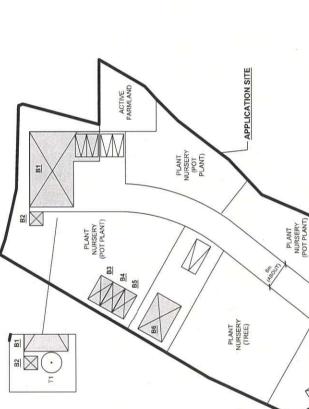

ALL THE EXISTING TREES WITHIN THE SITE WILL BE WELL-MAINTAINED BY THE APPLICANT DURING THE PLANNING APPROVAL PERIOD.

T3 - MACARANGA TANARIUS 5 m (H) × 4 m (SP)

T2 - CELTIS SINENSIS 6 m (H) x 7 m (SP)

:3 (T1-T3) :T1- MORUS ALBA 5 m (H) x 6 m (SP)

NO. OF EXISTING TREES DETAILS OF TREES

PRESERVATION OF EXISTING TREES

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TEMPORARY OFFICE FOR PERMITTED AGRICULTURAL USE FOR A PERIOD OF 3 YEARS AND ASSOCIATED FILLING OF LAND

R-Riches
Property Consultants Ltd.

VARIOUS LOTS IN D.D. 110, KAM TIN. YUEN LONG, NEW TERRITORIES

PARKING AND LOADING / UNLOADING PROVISIONS

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	DATE	DATE	-	
	CHECKED BY	APPROVED BY	DWG, TILE LAYOUT PLAN	PLAN 4

	DRAWN BY	DATE
APPLICATION SITE	W	27,10,2023
STRUCTURE	CHECKED BY	DATE
PARKING SPACE (PC)	APPROVED BY	DATE
LOADING / UNLOADING SPACE (LGV)		
INGRESS / EGRESS	LAYOUT PLAN	
	DWG NO	VER


STRUCTURE


LEGEND

NGRESS / EGRESS

EXISTING TREES

3CALE 1:800 @ A4

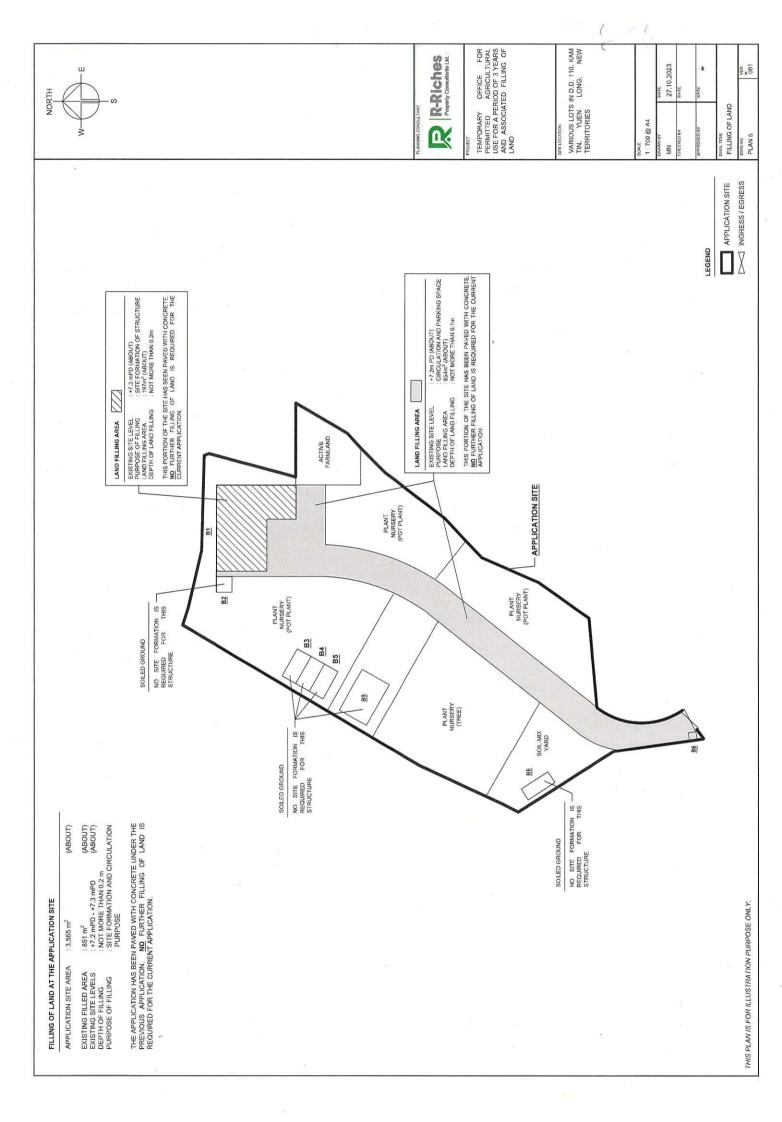

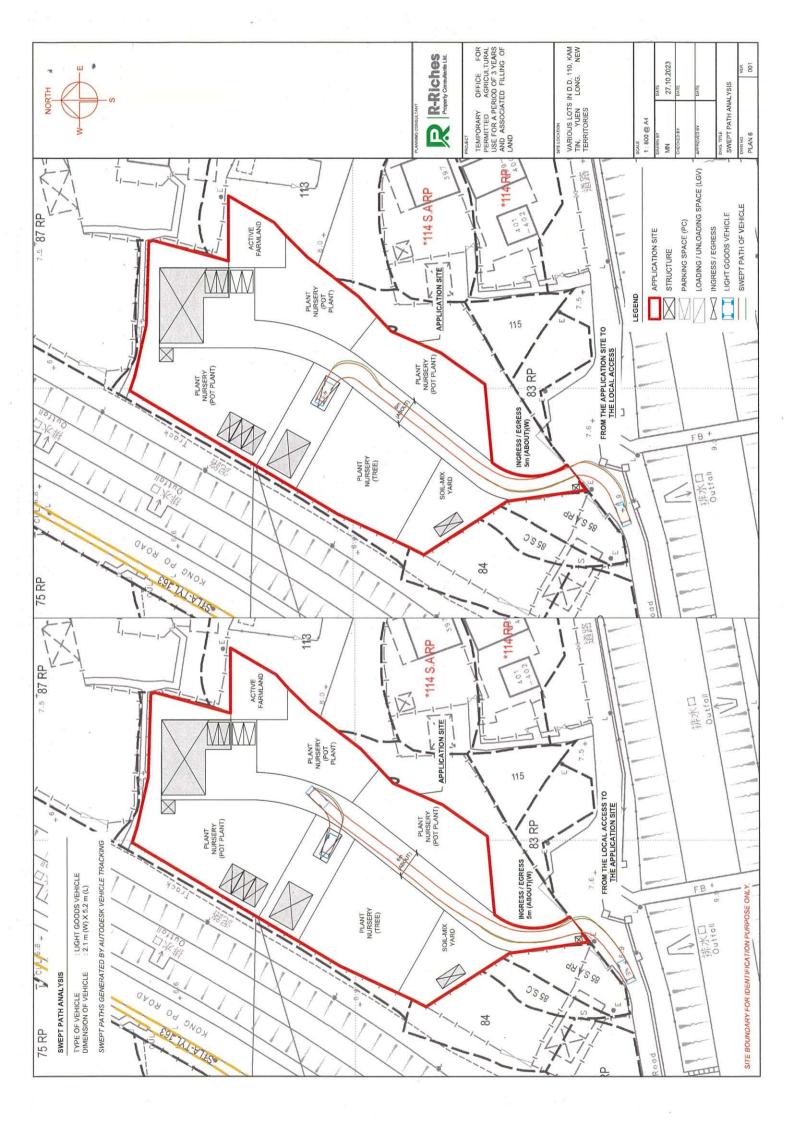



Our Ref.

: DD110 Lot 86 RP (Pt)

Your Ref.

: TPB/A/YL-KTN/974

The Secretary **Town Planning Board** 15/F, North Point Government office

North Point, Hong Kong

333 Java Road

Dear Sir,

Appendix Ia of RNTPC Paper No. A/YL-KTN/974



By Email

11 January 2024

1st Further Information

Proposed Temporary Office for a Period of 3 Years and Associated Filling of Land in "Agriculture" and "Village Type Development" Zones, Various Lots in in D.D. 109 and Adjoining Government Land, Kam Tin, Yuen Long, New Territories

(S.16 Planning Application No. A/YL-KTN/974)

We are writing to submit further information to address departmental comments of the subject application (Appendix I).

Should you require more information regarding the application, please contact our Mr. Orpheus LEE at or the undersigned at your convenience. Your kind attention to the matter is much appreciated.

Yours faithfully,

For and on behalf of

R-riches Property Consultants Limited

Louis TSE Town Planner

cc DPO/FSYLE, PlanD

(Attn.: Ms. Andrea YAN

(Attn.: Ms. Olivia NG



Responses-to-Comments

Temporary Office for Permitted Agricultural Use for a Period of 3 Years and Associated Filling of Land in "Agriculture" Zone, Various Lots in in D.D. 110, Kam Tin, Yuen Long, New Territories

(Application No. A/YL-KTN/974)

- (i) The applicant is a local landscaping company providing a series of landscaping services for the public and private sectors in Kam Tin, including horticultural services, arboricultural services and lawn care services to their clients. The application site (the Site) is currently used as a plant nursery. The proposed structure B1 (for site office, meeting room and covered car parking spaces) is to provide indoor working space for administrative staff to manage tasks related to landscape project planning and design. It also provides office spaces for agricultural technicians to support and maintain the on-site agricultural works (i.e. plant and tree nursery), as well as to execute the appointed landscape works and plant nursery projects outside the Site (i.e. hard & soft landscape design, landscape maintenance services, planting and transplanting, tree surveys and consultancy, lawn renovation and restoration, etc) to facilitate the operation of the company (Plan 1). A gardener resting room is proposed at structure B3 as an indoor shelter for farmers to rest and offer protection from adverse weather conditions during the operation of the applied use. The remaining area is for agricultural use, i.e. plant nursery, greenhouses, etc.
- (ii) The revised paved ratio plan and fire service installations proposal are provided (Plan 2 and Appendix I).
- (iii) A RtoC Table:

	Departmental Comments	Applicant's Responses
1.	Comments of District Lands Officer/Yuen Long, L	ands Department (DLO/YL, LandsD)
	(Contact Person: Ms. Sofia CHENG; Tel: 2443 107	2)
(a)	LandsD has reservation on the planning application since there are unauthorized structure(s) or uses on Lot Nos. 84, 85 S.A, 85 S.C and 86 RP all in D.D. 110 which are already subject to lease enforcement actions according to case priority. The lot owner(s) should rectify/apply for regulation on the lease breaches as demanded by LandsD.	Noted. The applicant will submit Short Term Waiver application to LandsD to make way for erection of the proposed structures at the Site after planning approval has been obtained from the Town Planning Board. No structure is proposed for domestic use.
(b)	If the planning application is approved, the lot owner(s) shall apply to this office for a Short Term Waiver (STW) to permit the structure(s) erected within the said private lots. The	



applications for STW will be considered by the Government in its capacity as a landlord and there is no guarantee that it will be approved. The STW, if approved, will be subject to such terms and conditions including the payment of waiver fee and administrative fee as considered appropriate by LandsD. Besides, given the proposed use is temporary in nature, only erection of temporary structure(s) will be considered.

(c) It is noticed that gardener resting was proposed. According to the established practice, application for STW application of structures for domestic / residential uses on private agricultural land will not be entertained. Hence, even if TPB approves the subject planning application, his office will not consider approving / regularizing any structure(s) erected / to be erected on the lots for domestic / residential uses.

The proposed structure B3 (i.e. gardener resting room) is intended to support the operation of the plant nursery by providing an indoor shelter for farmers to rest and offering protection from adverse weather conditions. The Site will be closed out of the operation hours (i.e. from 09:00 to 18:00 daily, including public holidays). No structure is proposed for domestic/residential uses.

NORTH S

STRUCTURE	USE	COVERED	GFA	BUILDING HEIGHT
181	SITE OFFICE, MEETING ROOM AND COVERED CAR PARKING SPACES	197 m² (ABOUT)	197 m² (ABOUT)	4.5 m (ABOUT)(1-STOREY)
B2	PORTABLE TOILET	9 m² (ABOUT)	9 m² (ABOUT)	3 m (ABOUT)(1-STOREY)
33,	GARDENER RESTING ROOM	18 m ² (ABOUT)	18 m ² (ABOUT)	2.8 m (ABOUT)(1-STOREY)
8 4.	STORAGE OF FARM TOOLS	18 m² (ABOUT)	18 m² (ABOUT)	2.8 m (ABOUT)(1-STOREY)
32,	STORAGE OF FARM TOOLS	18 m² (ABOUT)	18 m² (ABOUT)	2.8 m (ABOUT)(1-STOREY)
36	GREENHOUSE	54 m² (ABOUT)	54 m² (ABOUT)	3 m (ABOUT)(1-STOREY)
97*	STORAGE OF FERTILIZER & FARM TOOLS	15 m ² (ABOUT)	15 m² (ABOUT)	2.8 m (ABOUT)(1-STOREY)
. 88	GUARDROOM	3 m² (ABOUT)	3 m² (ABOUT)	2.8 m (ABOUT)(1-STOREY)
	TOTAL	332 m² (ABOUT)	332 m² (ABOUT)	

(ABOUT)

: 0.09

PLOT RATIO SITE COVERAGE

3,565 m² 332 m² 3,233 m²

APPLICATION SITE AREA COVERED AREA UNCOVERED AREA

DEVELOPMENT PARAMETERS

(ABOUT) (ABOUT)


: 8 : NOT APPLICABLE : 332 m² (AB: : 332 m² (AB

NO. OF STRUCTURE DOMESTIC GFA NON-DOMESTIC GFA TOTAL GFA

:2.8 m - 4.5 m

BUILDING HEIGHT NO. OF STOREY

*STRUCTURES B3 TO B5 AND B7 ARE CONTAINER-CONVERTED STRUCTURES

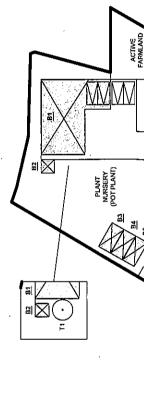

ALL THE EXISTING TREES WITHIN THE SITE WILL BE WELL-MAINTAINED BY THE APPLICANT DURING THE PLANNING APPROVAL PERIOD.

T3 - MACARANGA TANARIUS 5 m (H) × 4 m (SP)

T2 - CELTIS SINENSIS 6 m (H) x 7 m (SP)

:3 (T1 - T3) :T1 - MORUS ALBA 5 m (H) x 6 m (SP)

NO. OF EXISTING TREES DETAILS OF TREES

PRESERVATION OF EXISTING TREES



- APPLICATION SITE

PLANT NURSERY (TREE)

PLANT NURSERY (POT PLANT)

BT SOIL-MIX

PLANT NURSERY (POT PLANT)

TEMPORARY OFFICE FOR PERMITTED AGRICULTURAL USE FOR A PERIOD OF 3 YEARS AND ASSOCIATED FILLING OF LAND

VARIOUS LOTS IN D.D. 110, KAM TIN, YUEN LONG, NEW TERRITORIES

	DATE	27,10,2023	DATE	DATE	x #
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LEGEND

INGRESS / EGRESS 5m (ABOUT)(W)

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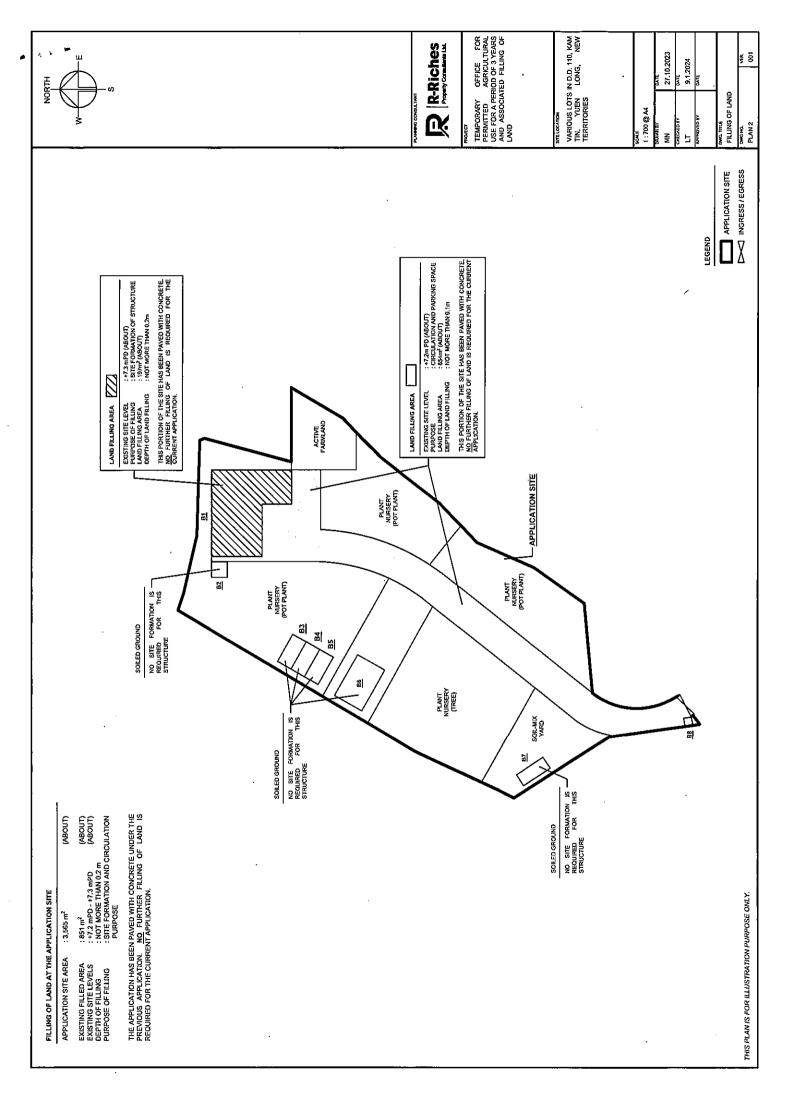
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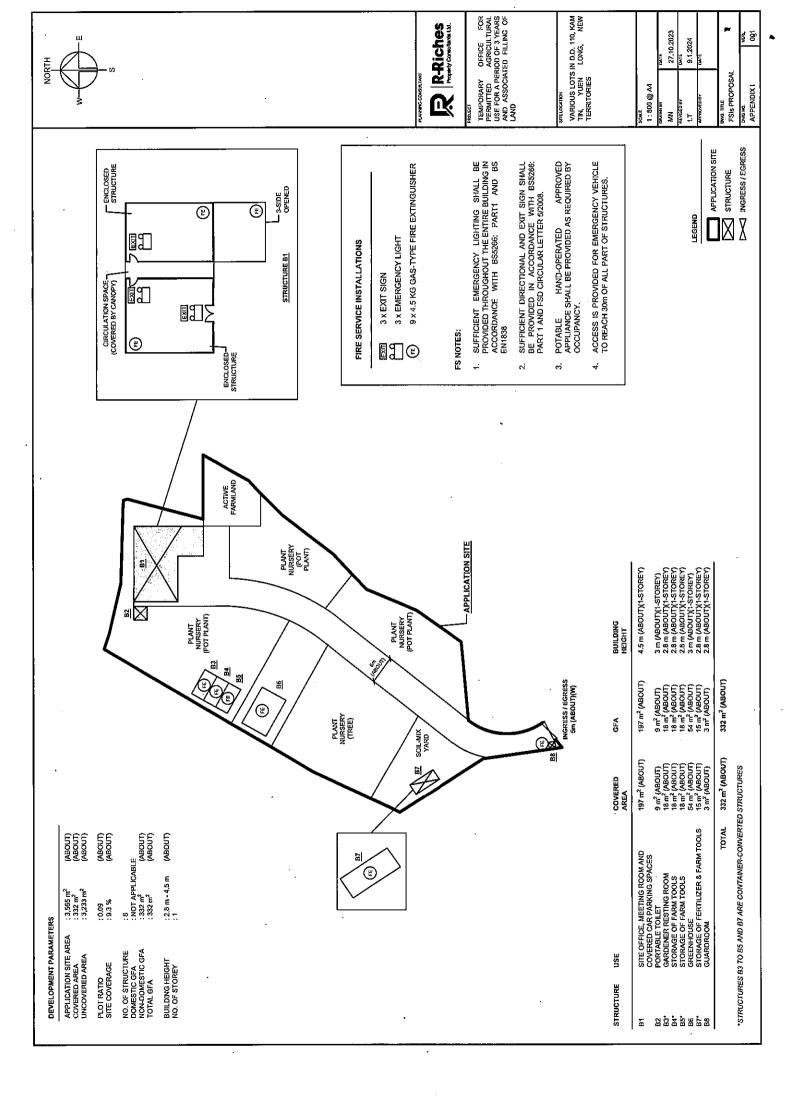
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NO. OF PRIVATE CAR PARKING SPACE DIMENSIONS OF PARKING SPACE	NO, OF LOADING / UNLOADING SPACE FOR LIGHT GOODS VEHICLE DIMENSIONS OF LOADING / UNLOADING SPACE

PARKING AND LOADING / UNLOADING PROVISIONS

NO. OF PRIVATE CAR PARKING SPACE DIMENSIONS OF PARKING SPACE

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Previous s.16 Applications covering the Application Site

Approved Application

Application No.	Use/Development	Date of Consideration
A/YL-KTN/760	Proposed Temporary Office for Permitted	14.5.2021
	Agricultural Use for a Period of 3 Years and	[revoked on 14.10.2023]
	Filling of Land	

Rejected Application

Application No.	Use/Development	Date of	Rejection
		Consideration	Reasons
A/YL-KTN/552	Temporary Open Storage of Waste	7.4.2017	(1) to (4)
	Metals, Construction Materials and		
	Vehicle Maintenance Workshop for a	,	
	Period of 3 Years		

Rejection Reasons:

- (1) The development was not in line with the planning intention of the "Agriculture" ("AGR")" zone.
- (2) The development did not comply with the relevant Town Planning Guidelines for application for open storage and port back-up uses.
- No sufficient information to demonstrate that the development would not cause adverse environmental, landscape and drainage impacts.
- (4) Approval of the application would set an undesirable precedent for similar applications.



Government Departments' General Comments

1. Traffic

Comments of the Commissioner for Transport (C for T):

• no adverse comment on the application from traffic engineering perspective.

Comments of the Chief Highway Engineer/New Territories West, Highways Department (CHE/NTW, HyD):

• no adverse comment on the application from highways maintenance perspective.

2. Drainage

Comments of the Chief Engineer/Mainland North, Drainage Services Department (CE/MN, DSD):

- no objection in-principle to the application from public drainage point of view; and
- should the application be approved, approval conditions requiring the implementation and maintenance of the accepted drainage proposal for the development to the satisfaction of his department or of the Town Planning Board should be imposed.

3. Environment

Comments of the Director of Environmental Protection (DEP):

- no objection to the application; and
- there was no environmental complaint received against the application site (the Site) in the past three years.

4. Water Supplies

Comments of the Chief Engineer/Construction, Water Supplies Department (CE/C, WSD):

• no objection to the application.

5. Fire Safety

Comments of the Director of Fire Services (D of FS):

• no in-principle objection to the application subject to fire service installations being provided to the satisfaction of his department.

6. Landscape Aspect

Comments of the Chief Town Planner/Urban Design and Landscape, Planning Department (CTP/UD&L, PlanD):

- no objection to the application from landscape planning perspective;
- the Site is situated in an area of rural inland plains landscape character comprising scattered temporary structures, farmland, open storage and scattered tree groups. Comparing with the aerial photos of 2022 and 2020, there is no significant change to the landscape character to the surrounding area since the last application was approved; and
- the Site is partly hard paved with some temporary structures. Some existing trees of common species are observed. According to the layout, there is no significant change in the layout and the existing trees within the Site will be maintained. Further significant adverse landscape impact within the Site arising from the applied use is not anticipated.

7. Building Matters

Comments of the Chief Building Surveyor/New Territories West, Buildings Department (CES/NTW, BD):

no objection to the application.

8. District Officer's Comments

Comments of the District Officer (Yuen Long), Home Affairs Department (DO(YL), HAD):

• his office has not received any local's comment on the application and he has no comment on the application.

9. Other Departments

The following government departments have no objection to/no adverse comment/no comment on the application:

- Project Manager (West), Civil Engineering and Development Department (PM(W), CEDD); and
- Director of Electrical and Mechanical Services (DEMS).

Recommended Advisory Clauses

- (a) prior planning permission should have been obtained before commencing the applied use;
- (b) should the applicant fail to comply with approval conditions again resulting in revocation of the planning permission, sympathetic consideration may not be given by the Rural and New Town Planning Committee/Town Planning Board to any further application;
- (c) the permission is given to the development and structures under application. It does not condone any other development and structures which currently occur on the application site (the Site) but not covered by the applicant. Immediate action should be taken to discontinue such development and remove such structures not covered by the permission;
- (d) to resolve any land issues relating to the development with the concerned owner(s) of the Site;
- (e) to note the comments of the District Lands Officer/Yuen Long, Lands Department (DLO/YL, LandsD) that:
 - the lot owner(s) shall apply to his office for a Short Term Waiver (STW) to permit the structure(s) erected within the private lots. The applications for STW will be considered by the Government in its capacity as a landlord and there is no guarantee that it will be approved. The STW, if approved, will be subject to such terms and conditions including the payment of waiver fee and administrative fee as considered appropriate by LandsD. Besides, given the applied use is temporary in nature, only
 - erection of temporary structure(s) will be considered; and
 - there are unauthorised structure(s) or use(s) on Lot Nos. 84, 85 S.A RP, 85 S.C and 86 RP all in D.D. 110 which are already subject to lease enforcement actions according to case priority. The lot owner(s) should rectify/apply for regulation on the lease breaches as demanded by LandsD;
- (f) to note the comments of the Chief Engineer/Construction, Water Supplies Department (CE/C, WSD) that:
 - existing water mains will be affected and the cost of any necessary diversion shall be borne by the proposed development;
 - in case it is not feasible to divert the affected water mains, a waterworks reserve within 1.5 metres from the center line of the water main shall be provided to WSD. No structure shall be built or materials stored within this waterworks reserve. Free access shall be made available at all times for staff of the Director of Water Supplies or their contractor to carry out construction, inspection, operation, maintenance and repair works;
 - no trees or shrubs with penetrating roots shall be planted within the Waterworks Reserve or in the vicinity of the water mains; and
 - government shall not be liable to any damage whatsoever and howsoever caused arising from burst or leakage of the public water mains within and in close vicinity of the Site;

- (g) to note the comments of the Commissioner for Transport that:
 - the Site is connected to the public road network via a section of a local access road which is not managed by Transport Department. The land status of the local access road should be checked with the LandsD. Moreover, the management and maintenance responsibilities of the local access road should be clarified with the relevant lands and maintenance authorities accordingly. Sufficient manoeuvring space shall be provided within the Site. No vehicle is allowed to queue back to or reverse onto/from public road at any time during the planning approval period;
- (h) to note the comments of the Chief Highway Engineer/New Territories West, Highways Department (CHE/NTW, HyD):
 - HyD shall not be responsible for the maintenance of any access connecting the Site and the section of Kong Po Road; and
 - adequate drainage measures should be provided to prevent surface water running from the Site to nearby public road and drains;
- (i) to note the comments of the Chief Building Surveyor/New Territories West, Buildings Department (CBS/NTW, BD) that:
 - the Site shall be provided with means of obtaining access thereto from a street and emergency vehicular access in accordance with Regulations 5 and 41D of the Building (Planning) Regulations (B(P)R) respectively;
 - the Site does not abut on a specified street of not less than 4.5 m wide and its permitted development intensity shall be determined under Regulation 19(3) of the B(P)R at building plan submission stage;
 - if the existing structure (not being a New Territories Exempted House) is erected on leased land without the approval of the Building Authority (BA), they are unauthorised building works (UBW) under the Buildings Ordinance (BO) and should be designated for any proposed use under the captioned application;
 - for UBW erected on leased land, enforcement action may be taken by BD to effect their removal in accordance with the prevailing enforcement policy against UBW as and when necessary. The granting of any planning approval should not be construed as an acceptance of any existing building works or UBW on the Site under the BO;
 - before any new building works (including containers/open sheds as temporary buildings, demolition and land filling, etc.) are to be carried out on the Site, prior approval and consent of the BA should be obtained, otherwise they are unauthorised building works. An Authorised Person should be appointed as the co-ordinator for the proposed building works in accordance with the BO;
 - any temporary shelters or converted containers for office, storage, washroom or other uses are considered as temporary buildings are subject to the control of Part VII of the B(P)R; and
 - detailed checking under the BO will be carried out at building plan submission stage;

- (j) to note the comments of the Director of Fire Services (D of FS) that:
 - the applicant is advised on the following points:
 - i. The standards and specification of the proposed emergency lighting shall be revised to 'BS 5266-1:2016, BS EN 1838:2013 and the FSD Circular Letter No. 4/2021'.
 - ii. the layout plans should be drawn to scale and depicted with dimensions and nature of occupancy; and
 - iii. the location of where the proposed fire service installations to be installed should be clearly marked on the layout plans.
 - the applicant shall be reminded that if the proposed structure(s) is required to comply with the BO (Cap. 123), detailed fire safety requirements will be formulated upon receipt of formal submission of general building plans;
- (k) to note the comments of the Director of Electrical and Mechanical Services (DEMS) that:
 - the applicant shall be advised that there is no particular comment on the document from electricity supply safety aspect. However, in the interests of public safety and ensuring the continuity of electricity supply, the parties concerned with planning, designing, organizing and supervising any activity near the underground cable or overhead line under the mentioned document should approach the electricity supplier (i.e. CLP Power) for the requisition of cable plans (and overhead line alignment drawings, where applicable) to find out whether there is any underground cable and/or overhead line within and/or in the vicinity of the concerned site. They should also be reminded to observe the Electricity Supply Lines (Protection) Regulation and the "Code of Practice on Working near Electricity Supply Lines" established under the Regulation when carrying out works in the vicinity of the electricity supply lines; and
- (l) to note the comments of the Chief Town Planner/Urban Design and Landscape, Planning Department (CTP/UD&L, PlanD) that:
 - the applicant is advised that approval of the application does not imply approval of tree works, if any, such as pruning, transplanting and felling. The applicant is reminded to seek comments and approval for any proposed tree works from relevant department prior to the commencement of the works.



☐ Urgent	☐ Return Receipt Requested	☐ Sign ☐ Encrypt ☐ Mark Subject Restricted	Expand personal&publi
	A/YL-KTN/974 DD 110, F 01/01/2024 02:57	Kong Po Road, Kam Tin	
From: To: Sent by: File Ref:	"tpbpd" <tpbpd@pland.gov.hk> tpbpd@pland.gov.hk</tpbpd@pland.gov.hk>	· .	

Dear TPB Members,

Despite the dodgy history, approval was given in May 2021 but conditions were never fulfilled.

Again the Assistant Director of Planning has abrogated his duty to ensure that rules and regulations are implemented by his department and has effectively colluded with what is obviously a brownfield operation to flaunt the law by granting excessive extension of time.

Conditions were promulgated in order to ensure that the safety and good health of the community are protected.

I would remind members that "The Town Planning Board (the Board) is a statutory body established under section 2 of the Town Planning Ordinance (the Ordinance) with a view to promoting the health, safety, convenience and general welfare of the community.

Your obligation is towards the community not the interests of the applicant.

The application should be rejected.

Mary Mulivhill

From:

To: tpbpd <tpbpd@pland.gov.hk>

Date: Tuesday, 13 April 2021 4:24 AM HKT

Subject: A/YL-KTN/760 DD 110, Kong Po Road, Kam Tin

A/YL-KTN/760

Lots 84 (Part), 85 S.A RP (Part), 85 S.C (Part), 86 RP (Part) and 113 (Part) in D.D.

110, Kong Po Road, Kam Tin, Yuen Long

Site area: About 3,565sq.m

Zoning: "Agriculture"

Applied use: Office / 5 Vehicle Parking / Filling of Land

Dear TPB Members,

Application 552 was reject in 2017.

PlanD: The application did not comply with the TPB PG-No. 13E in that there was no previous approval granted at the site and there were adverse departmental and public comments

But the operation proceeded and no enforcement action taken.

The site area is about 3,565m2, to be occupied by 6 one-storey structures (with building height not more than 4.5 m) and a total floor area of about 332 m2 for site office, meeting room, greenhouse, storage of fertilizer and farm tools, guardroom and portable toilet.

But the site is 3,500+sq.m so something does not added up as much of the site has been paved over.

Questions please.

Mary Mulvihill

From:

To: "tpbpd" <tpbpd@pland.gov.hk>

Sent: Friday, March 17, 2017 1:20:55 AM Subject: A/YL-KTN/552 DD 110 Kam Tin

A/YL-KTN/552

Lots 86RP and 113 in D.D. 110, Kam Tin, Yuen Long

Site area : About 5,507m² Zoning : "Agriculture"

Applied Use: Open Storage Waste Materials / Vehicle storage

Dear TPB Members,

There is no previous history of applications. Has this site been used for similar activities without going through the process?

Regrettably no information or images are provided in the Gist. Could members please push for more transparency and the provision of essential information to assist members of the public to make an intelligent appraisal of plans?

These facilities represent a most inefficient form of land use, whereby a large surface area is used to accommodate a relatively small enterprise. Operations of this nature should be accommodated in custom built high rise industrial parks that incorporate appropriate support facilities such as fire equipment, EVA, canteens for the workers, toilets, shared parking, a variety of lifts and hydraulic equipment, etc..

The applied use is not in line with the planning intention of the "Agriculture" zone which is to retain and safeguard good agricultural land for agricultural purposes.

This zone is also intended to retain fallow arable land with good potential for rehabilitation. No strong planning justification has been given in the submission for a departure from the planning intention.

Approval of the applications would set an undesirable precedent of perpetuating inappropriate use of Agriculture zoned land. According to the Policy Address

126: The Government proactively supports the development of local agriculture and will explore ways to optimise use of quality agricultural land through planning and land management.

TPB must play its part in ensuring that the Policy is implemented. Approval would encourage the proliferation of brownfield sites at a time when the general public is very concerned about abuse of zoning and degrading of sites.

The application must be rejected.

Mary Mulvihill

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