This decument is received on The Town Planning Board will fearely consoniedge the date of receipt of the application only upon receipt of all the required information and documents.



APPLICATION FOR PERMISSION **UNDER SECTION 16 OF** THE TOWN PLANNING ORDINANCE (CAP. 131)

《城市規劃條例》(第131章) 根據 第 16 條 遞 交 的 許 可

Applicable to Proposal Only Involving Temporary Use/Development of Land and/or Building Not Exceeding 3 Years in Rural Areas or Regulated Areas. or Renewal of Permission for such Temporary Use or Development*

適用於祇涉及位於鄉郊地區或受規管地區土地上及/或建築物內進行 為期不超過三年的臨時用途/發展或該等臨時用途/發展的許可續期的建議*

*Form No. S16-I should be used for other Temporary Use/Development of Land and/or Building (e.g. temporary use/developments in the Urban Area) and Renewal of Permission for such Temporary Use or Development. *其他土地上及/或建築物內的臨時用途/發展(例如位於市區內的臨時用途或發展)及有關該等臨時用途/發 展的許可續期,應使用表格第S16-I 號。

Applicant who would like to publish the notice of application in local newspapers to meet one of the Town Planning Board's requirements of taking reasonable steps to obtain consent of or give notification to the current land owner, please refer to the following link regarding publishing the notice in the designated newspapers: https://www.tpb.gov.hk/en/plan_application/apply.html

申請人如欲在本地報章刊登申請通知,以採取城市規劃委員會就取得現行土地擁有人的同意或通知現行 土地擁有人所指定的其中一項合理步驟,請瀏覽以下網址有關在指定的報章刊登通知: https://www.tpb.gov.hk/tc/plan_application/apply.html

General Note and Annotation for the Form

填寫表格的一般指引及註解

- "Current land owner" means any person whose name is registered in the Land Registry as that of an owner of the land to which the application relates, as at 6 weeks before the application is made
 - 「現行土地擁有人」指在提出申請前六星期,其姓名或名稱已在土地註冊處註冊為該申請所關乎的 土地的擁有人的人
- * Please attach documentary proof 請夾附證明文件
- ^ Please insert number where appropriate 請在適當地方註明編號

Please fill "NA" for inapplicable item 請在不適用的項目填寫「不適用」

Please use separate sheets if the space provided is insufficient 如所提供的空間不足,請另頁說明

Please insert a 「レ」 at the appropriate box 請在適當的方格内上加上「レ」號

2303146 4/12 by harrol

Form No. S16-III 表格第 S16-III 號

*	· · · · · · · · · · · · · · · · · · ·	 	
For Official Use Only	Application No. 申請編號	A/YL-KAN/979	
請勿填寫此欄	Date Received 收到日期	' - 4 JAN 2024	

- The completed form and supporting documents (if any) should be sent to the Secretary, Town Planning Board (the Board), 15/F, North Point Government Offices, 333 Java Road, North Point, Hong Kong.
 申請人須把填妥的申請表格及其他支持申請的文件 (倘有),送交香港北角渣華道 333 號北角政府合署 15 樓城市規劃委員會(下稱「委員會」)秘書收。
- 2. Please read the "Guidance Notes" carefully before you fill in this form. The document can be downloaded from the Board's website at http://www.tpb.gov.hk/. It can also be obtained from the Secretariat of the Board at 15/F, North Point Government Offices, 333 Java Road, North Point, Hong Kong (Tel: 2231 4810 or 2231 4835), and the Planning Enquiry Counters of the Planning Department (Hotline: 2231 5000) (17/F, North Point Government Offices, 333 Java Road, North Point, Hong Kong and 14/F, Sha Tin Government Offices, I Sheung Wo Che Road, Sha Tin, New Territories). 請先細閱《申請須知》的資料單張,然後填寫此表格。該份文件可從委員會的網頁下載(網址: http://www.tpb.gov.hk/),亦可向委員會秘書處(香港北角渣華道 333 號北角政府合署 15 樓-電話:2231 4810 或 2231 4835)及規劃署的規劃資料查詢處(熱線:2231 5000) (香港北角渣華道 333 號北角政府合署 17 樓及新界沙田上禾輋路 1 號沙田政府合署 14 樓)索取。
- 3. This form can be downloaded from the Board's website, and obtained from the Secretariat of the Board and the Planning Enquiry Counters of the Planning Department. The form should be typed or completed in block letters. The processing of the application may be refused if the required information or the required copies are incomplete. 此表格可從委員會的網頁下載,亦可向委員會秘書處及規劃署的規劃資料查詢處索取。申請人須以打印方式或以正楷填寫表格。如果申請人所提交的資料或文件副本不齊全,委員會可拒絕處理有關申請。

1.	Name of Applicant	由諸人姓名/名稱
١.	Maine of Applicant	

(☑Mr. 先生 /口Mrs. 夫人 /口Miss 小姐 /口Ms. 女士 /口Company 公司 /口Organisation 機構)

2. Name of Authorised Agent (if applicable) 獲授權代理人姓名/名稱(如適用)

(□Mr. 先生 /□Mrs. 夫人 /□Miss 小姐 /□Ms. 女士 / ☑ Company 公司 /□Organisation 機構)

R-riches Property Consultants Limited 盈卓物業顧問有限公司

3.	Application Site 申請地點	,
(a)	Full address / location / demarcation district and lot number (if applicable) 詳細地址/地點/丈量約份及地段號碼(如適用)	Lot 1434 (Part) in D.D. 107 in Kam Tin, Yuen Long, New Territories
(b)	Site area and/or gross floor area involved 涉及的地盤面積及/或總樓面面 積	☑Site area 地盤面積 498 sq.m 平方米☑About 約 ☑Gross floor area 總樓面面積 379 sq.m 平方米☑About 約
(c)	Area of Government land included (if any) 所包括的政府土地面積(倘有)	N/A sq.m 平方米 □About 約

1					
(d)	statı	ne and number of utory plan(s) 引法定圖則的名稱及		Draft Kam Tin North Outline Zoning Plan No. S/YL-KTN/11	
(e)		d use zone(s) involv 文的土地用途地帶	red	"Agriculture" Zone	
(f)		rent use(s) 5用途	i	Vacant	
	->Eur			(If there are any Government, institution or community facilities, please illustrate on plan and specify the use and gross floor area) (如有任何政府、機構或社區設施,請在圖則上顯示,並註明用途及總樓面面積)	
4.	"Cı	urrent Land Ow	ner" of A	pplication Site 申請地點的「現行土地擁有人」	
The	applic	ant 申請人 —			
	is the 是唯	e sole "current land 一的「現行土地挧	owner"#& (pl 有人」#& (部	eáse proceed to Part 6 and attach documentary proof of ownership). 骨繼續填寫第 6 部分,並夾附業權證明文件)。	
	is on 是其	e of the "current lan 中一名「現行土地	id owners"# & z擁有人」#&	(please attach documentary proof of ownership). (請夾附業權證明文件)。	
Ø		t a "current land ow 是「現行土地擁有			
				vernment land (please proceed to Part 6). 繼續填寫第 6 部分)。	
5.	. Statement on Owner's Consent/Notification 就土地擁有人的同意/通知土地擁有人的陳述				
(a)	invo	lves a total of	"c	nd Registry as at(DD/MM/YYYY), this application current land owner(s) "# 年	
	涉,	名	占「現行土地	年 月 日的記錄,這宗申請共牽 !擁有人」*。	
(b)	The	applicant 申請人 -			
		has obtained conser	nt(s) of	"current land owner(s)".	
		已取得	名「	現行土地擁有人」"的同意。	
		Details of consent	of "current l	and owner(s)" * obtained 取得「現行土地擁有人」 * 同意的詳情	
		No. of 'Current	Lot number/	address of premises as shown in the record of the Land	
		Land Owner(s)' 「現行土地擁有 人」數目	Registry wh	ere consent(s) has/have been obtained	
		2 - 2 - 2 - 2 - 2 - 1 - 1 - 1 - 1 - 1 -		(11737-7)	
		(Please use senarate s	heets if the sp		

		"current land owner(s)"# 名「現行土地擁有人」#。						
	Details of the "c	urrent land owner(s)" # notified 已獲通知「現行土地擁有人」	的詳細資料					
	No. of 'Curren Land Owner(s)' 「現行土地扬 有人」數目	Lot number/address of premises as shown in the record of the	Date of notification given (DD/MM/YYYY) 通知日期(日/月/年)					
	·							
	(Please use separate	e sheets if the space of any box above is insufficient. 如上列任何方格的	空間不足,請另頁說明)					
. Z	已採取合理步驟	ble steps to obtain consent of or give notification to owner(s):以取得土地擁有人的同意或向該人發給通知。詳情如下:						
		to Obtain Consent of Owner(s) 取得土地擁有人的同意所採取	•					
		for consent to the "current land owner(s)" on(日/月/年)向每一名「現行土地擁有人」"郵遞要求						
	Reasonable Steps	Reasonable Steps to Give Notification to Owner(s) 向土地擁有人發出通知所採取的合理步驟						
		otices in local newspapers on(DD/MM/Y (日/月/年)在指定報章就申請刊登一次通知&	YYY) ^{&}					
		te in a prominent position on or near application site/premises on 01/11/2023 (DD/MM/YYYY).						
•	於	(日/月/年)在申請地點/申請處所或附近的顯明位置	置貼出關於該申請的通知					
•	office(s) or	to relevant owners' corporation(s)/owners' committee(s)/mutual aid rural committee on24/11/2023(DD/MM/YYYY)&						
	•	(日/月/年)把通知寄往相關的業主立案法團/業主領的鄉事委員會 ^{&}	委員會/互助委員會或管地					
	Others 其他	•						
	□ others (plea 其他(請指		•					
	-	· · · · · · · · · · · · · · · · · · ·						
Note: Ma	ay insert more than of	one $\lceil \boldsymbol{\vee} \rfloor$. provided on the basis of each and every lot (if applicable) and prem	ises (if any) in respect of t					
ap	plication.	加上「 ✓ 」號 物(な一) から(高適用)及處所(倘有)分別提供資料	~~ ···· /					

6 Type(s) of Application	n 申請類別			
Regulated Areas 位於舞郊地區或受規管	地區土地上及/或建第	於物內進行為	期不超過三年的	4. 1. 1. 1. 1. 1. 1. 1. 1. 1. 1. 1. 1. 1.
(For Renewal of Permiss proceed to Part (B)) (如屬位於鄉郊地區或受券				s or Regulated Areas, please
CAPTION THAN TO PERSON.	B DE VIEWERMAN OF PRINCE AND ADDRESS OF THE PERSON OF THE	Н <i>ЭРУ</i> ГЦ ин ам з <u>горого</u>	ODA . DOSTORANS (TO POLICE)	J. Charles of the Control of the Con
(a) Proposed use(s)/development 擬議用途/發展				gerous Goods Godown) I Associated Filling of Land
	(Please illustrate the deta	ils of the propos	sal on a layout plan) (諸	用平面圖說明擬議詳情)
(b) Effective period of permission applied for	☑ year(s) 年	۴ .	3	/
申請的許可有效期	☐ month(s)	個月 . 	*****************	***********
(c) Development Schedule 發展網	細節表			
Proposed uncovered land area	1 擬議露天土地面積		119	sq.m 🗹 About 約
Proposed covered land area 携	建議有上蓋土地面積		379	sq.m ☑About 紛
Proposed number of buildings	s/structures 擬議建築物	/構築物數目	2	
Proposed domestic floor area	擬議住用樓面面積		N/A	sq.m 口About 約
Proposed non-domestic floor	area 擬議非住用樓面面	ゴ積	379	sq.m ☑About 約
Proposed gross floor area 擬語	義總 樓面面積		379	sg.m About 約
Proposed height and use(s) of diff		:/structures (if	applicable) 建築物/	機築物的擬議高度及不同樓層
Proposed height and use(s) of diff 的擬議用途 (如適用) (Please use STRUCTURE USE	ferent floors of buildings			
的擬議用途 (如適用) (Please us structure use 	ferent floors of buildings e separate sheets if the sp	pace below is i covered	insufficient) (如以下 GFA	空間不足,請另頁說明) BUILDING
的擬議用途 (如適用) (Please us structure use 	ferent floors of buildings e separate sheets if the sp culping D.G.G.) AND G/UNLOADING AREA	pace below is i covered area	insufficient) (如以下 GFA 191 m² (ABOUT)	空間不足,請另頁說明) BUILDING HEIGHT
的擬議用途 (如適用) (Please us structure use B1 WAREHOUSE (EXC COVERED LOADING WAREHOUSE (EXC	ferent floors of buildings e separate sheets if the sp clubing D.G.G.) AND G/UNLOADING AREA clubing D.G.G.)	pace below is i COVERED AREA 191 m² (ABOUT)	insufficient) (如以下 GFA 191 m² (ABOUT) 188 m² (ABOUT)	空間不足,請另頁說明) BUILDING HEIGHT 7 m (ABOUT)(1-STOREY) 7 m (ABOUT)(1-STOREY)
的擬議用途 (如適用) (Please us structure use B1 WAREHOUSE (EXC COVERED LOADING	Ferent floors of buildings e separate sheets if the specific process of buildings e separate sheets if the specific process of	pace below is i COVERED AREA 191 m² (ABOUT) 188 m² (ABOUT) 379 m² (ABOUT)	insufficient) (如以下 GFA 191 m² (ASOUT) 188 m² (ASOUT) 378 m² (ASOUT)	空間不足,請另頁說明) BUILDING HEIGHT 7m (ABOUT)(1-STOREY)
的擬議用途 (如適用) (Please us structure use B1 WAREHOUSE (EXC COVERED LOADING WAREHOUSE (EXC *D.G.G DANGEROUS GOODS GODD	TOTAL spaces by types 不同種類	pace below is i COVERED AREA 191 m² (ABOUT) 188 m² (ABOUT) 379 m² (ABOUT)	insufficient) (如以下 GFA 191 m² (ASOUT) 188 m² (ASOUT) 378 m² (ASOUT)	空間不足,請另頁說明) BUILDING HEIGHT 7 m (ABOUT)(1-STOREY) 7 m (ABOUT)(1-STOREY)
的擬議用途 (如適用) (Please us structure use B1 WAREHOUSE (EXC COVERED LOADING B2 WAREHOUSE (EXC WAREHOUSE (EXC Proposed number of car parking structure)	TOTAL Total Total Total Total Total Total	pace below is i COVERED AREA 191 m² (ABOUT) 188 m² (ABOUT) 379 m² (ABOUT)	insufficient) (如以下 GFA 191 m² (ASOUT) 188 m² (ASOUT) 378 m² (ASOUT)	空間不足,請另頁說明) BUILDING HEIGHT 7 m (ABOUT)(1-STOREY) 7 m (ABOUT)(1-STOREY)
的擬議用途 (如適用) (Please us structure use B1 WAREHOUSE (EXC COVERED LOADING WAREHOUSE (EXC COVERED LOADING WAREHOUSE (EXC COVERED LOADING WAREHOUSE (EXC COVERED LOADING STATE OF COVERED LOADING	TOTAL Total Tep 位 Tep 在 Tep	pace below is i COVERED AREA 191 m² (ABOUT) 188 m² (ABOUT) 379 m² (ABOUT)	insufficient) (如以下 GFA 191 m² (ASOUT) 188 m² (ASOUT) 378 m² (ASOUT)	空間不足,請另頁說明) BUILDING HEIGHT 7 m (ABOUT)(1-STOREY) 7 m (ABOUT)(1-STOREY)
的擬議用途(如適用)(Please us structure use B1 WAREHOUSE (EXC COVERED LOADING WAREHOUSE (EXC COVERED	TOTAL Spaces 較型貨車泊車位 Spaces 中型貨車泊車位 Spaces 中型貨車泊車位	pace below is i COVERED AREA 191 m² (ABOUT) 188 m² (ABOUT) 379 m² (ABOUT)	insufficient) (如以下 GFA 191 m² (ASOUT) 188 m² (ASOUT) 378 m² (ASOUT)	空間不足,請另頁說明) BUILDING HEIGHT 7 m (ABOUT)(1-STOREY) 7 m (ABOUT)(1-STOREY)
的擬議用途 (如適用) (Please us structure use use use use use use use use use us	TOTAL T	pace below is i COVERED AREA 191 m² (ABOUT) 188 m² (ABOUT) 379 m² (ABOUT)	insufficient) (如以下 GFA 191 m² (ASOUT) 188 m² (ASOUT) 378 m² (ASOUT)	空間不足,請另頁說明) BUILDING HEIGHT 7 m (ABOUT)(1-STOREY) 7 m (ABOUT)(1-STOREY)
的擬議用途(如適用)(Please us structure use B1 WAREHOUSE (EXC COVERED LOADING WAREHOUSE (EXC COVERED	TOTAL T	pace below is i COVERED AREA 191 m² (ABOUT) 188 m² (ABOUT) 379 m² (ABOUT)	insufficient) (如以下 GFA 191 m² (ASOUT) 188 m² (ASOUT) 378 m² (ASOUT)	空間不足,請另頁說明) BUILDING HEIGHT 7 m (ABOUT)(1-STOREY) 7 m (ABOUT)(1-STOREY)
的擬議用途(如適用)(Please us structure use use use use use use use use use us	TOTAL T	pace below is in COVERED AREA 191 m² (ABOUT) 188 m² (ABOUT) 379 m² (ABOUT) 類停車位的擬	insufficient) (如以下 GFA 191 m² (ABOUT) 188 m² (ABOUT) 378 m² (ABOUT) 議數目	空間不足,請另頁說明) BUILDING HEIGHT 7 m (ABOUT)(1-STOREY) 7 m (ABOUT)(1-STOREY)
的擬議用途(如適用)(Please us structure use B1 WAREHOUSE (EXC COVERED LOADING STRUCKER) Proposed number of car parking spaces 和家 Motoroycle Parking Spaces 和家 Light Goods Vehicle Parking Space Medium Goods Vehicle Parking Space Medium Goods Vehicle Parking Space Medium Goods Vehicle Parking Space Specify)其他(記 Proposed number of loading/unloading/	TOTAL T	pace below is in COVERED AREA 191 m² (ABOUT) 188 m² (ABOUT) 379 m² (ABOUT) 類停車位的擬	insufficient) (如以下 GFA 191 m² (ABOUT) 188 m² (ABOUT) 378 m² (ABOUT) 議數目	空間不足,請另頁說明) BUILDING HEIGHT 7m (ABOUT)(1-STOREY) 7m (ABOUT)(1-STOREY)
的擬議用途(如適用)(Please us structure use use structure use use use use use use use use use us	TOTAL T	pace below is in COVERED AREA 191 m² (ABOUT) 188 m² (ABOUT) 379 m² (ABOUT) 類停車位的擬	insufficient) (如以下 GFA 191 m² (ABOUT) 188 m² (ABOUT) 378 m² (ABOUT) 議數目	空間不足,請另頁說明) BUILDING HEIGHT 7 m (ABOUT)(1-STOREY) 7 m (ABOUT)(1-STOREY)
的擬議用途(如適用)(Please us structure use B1 WAREHOUSE (EXC COVERED LOADING STRUCKER) Proposed number of car parking spaces 和家 Motoroycle Parking Spaces 和家 Light Goods Vehicle Parking Space Medium Goods Vehicle Parking Space Medium Goods Vehicle Parking Space Medium Goods Vehicle Parking Space Specify)其他(記 Proposed number of loading/unloading/	TOTAL Spaces by types 不同種的 Total	pace below is in COVERED AREA 191 m² (ABOUT) 188 m² (ABOUT) 379 m² (ABOUT) 類停車位的擬	insufficient) (如以下 GFA 191 m² (ABOUT) 188 m² (ABOUT) 378 m² (ABOUT) 議數目	空間不足,請另頁說明) BUILDING HEIGHT 7m (ABOUT)(1-STOREY) 7m (ABOUT)(1-STOREY)
的擬議用途(如適用)(Please us structure use B1 WAREHOUSE (EXC COVERED LOADING B2 WAREHOUSE (EXC WAREHOUSE) *D.G.G DANGEROUS GOODS GOOD Proposed number of car parking SP Private Car Parking Spaces 私家 Motorcycle Parking Spaces 歷單 Light Goods Vehicle Parking Spaceing Medium Goods Vehicle Parking Spaceing Heavy Goods Vehicle Parking Spaceing Chers (Please Specify) 其他(訂 Proposed number of loading/unlo Taxi Spaces 的士車位 Coach Spaces 旅遊巴車位	TOTAL Spaces by types 不同種就事中位 Aces 輕型貨車泊車位 Spaces 重型貨車泊車位 Aces 重型貨車車位	pace below is in COVERED AREA 191 m² (ABOUT) 188 m² (ABOUT) 379 m² (ABOUT) 類停車位的擬	insufficient) (如以下 GFA 191 m² (ABOUT) 188 m² (ABOUT) 378 m² (ABOUT) 議數目	空間不足,請另頁說明) BUILDING HEIGHT 7m (ABOUT)(1-STOREY) 7m (ABOUT)(1-STOREY)
的擬議用途(如適用)(Please us structure use B1 WAREHOUSE (EXC COVERED LOADING WAREHOUSE (EXC C	TOTAL Spaces by types 不同種 Total T	pace below is in COVERED AREA 191 m² (ABOUT) 188 m² (ABOUT) 379 m² (ABOUT) 類停車位的擬	insufficient) (如以下 GFA 191 m² (ABOUT) 188 m² (ABOUT) 378 m² (ABOUT) 議數目	空間不足,請另頁說明) BUILDING HEIGHT 7m (ABOUT)(1-STOREY) 7m (ABOUT)(1-STOREY)
的擬議用途(如適用)(Please us structure use B1 WAREHOUSE (EXC COVERED LOADING STRUCTURE) Proposed number of car parking SP Private Car Parking Spaces 電單 Light Goods Vehicle Parking SP Medium Goods Vehicle Parking SP Others (Please Specify) 其他(訂 Proposed number of loading/unlo Taxi Spaces 的士車位 Coach Spaces 旅遊巴車位 Light Goods Vehicle Spaces 輕型 Medium Goods Vehicle Spaces 輕型 Medium Goods Vehicle Spaces 「輕型 Medium Goods Vehicle Spaces 「如 Medium Goods Vehicle Spaces 「 Medium Goods Vehicle Spaces 「 Medium Goods Vehicle Spaces 「 Medium Goods Vehicle Spac	TOTAL Spaces by types 不同種就 Total Total Spaces 野型貨車泊車位 Spaces 中型貨車泊車位 Spaces 重型貨車泊車位 Acces 重型貨車車位 Acces 重型貨車車位 Acces 重型貨車車位 Acces 重型貨車車位 Acces 重型貨車車位 Acces 重型貨車車位	pace below is in COVERED AREA 191 m² (ABOUT) 188 m² (ABOUT) 379 m² (ABOUT) 類停車位的擬	insufficient) (如以下 GFA 191 m² (ABOUT) 188 m² (ABOUT) 378 m² (ABOUT) 議數目	空間不足,請另頁說明) BUILDING HEIGHT 7m (ABOUT)(1-STOREY) 7m (ABOUT)(1-STOREY)

Proposed operating hours 擬議營運時間 Monday to Saturday from 09:00 to 18:00, no operation on Sunday and public holiday					
(d)	Any vehicular access the site/subject buildis 是否有車路通往地有關建築物?	ng?	 ✓ There is an existing access. (please indicate the street name, where appropriate) 有一條現有車路。(請註明車路名稱(如適用)) Accessible from Shui Mei Road via a local access □ There is a proposed access. (please illustrate on plan and specify the width) 有一條擬議車路。(請在圖則顯示,並註明車路的闊度) 		
		No 否			
(e)	(If necessary, please u	se separate shee for not providir	E 議發展計劃的影響 ets to indicate the proposed measures to minimise possible adverse impacts or give ng such measures. 如需要的話,請另頁註明可盡量減少可能出現不良影響的		
(i)	Does the development proposal involve alteration of existing building? 擬議發展計劃是否包括現有建築	Yes 是 □ No 否 ☑	Please provide details 請提供詳情		
(ii)	Does the development proposal involve the operation on the right? 接議發展是否涉及右列的工程?		(Please indicate on site plan the boundary of concerned land/pond(s), and particulars of stream diversion, the extent of filling of land/pond(s) and/or excavation of land) (簡用地盤平面圓顯示有關土地/池塘界線・以及河道改道、填塘、填土及/或挖土的細節及/或範圍) □ Diversion of stream 河道改道 ☑ Filling of pond 填塘		
		No否 □	□ Excavation of land 挖土 Area of excavation 挖土面積sq.m 平方米 □About 約 Depth of excavation 挖土深度m 米 □About 約		
(iii)	Would the development proposal cause any adverse impacts? 接議發展計劃會否造成不良影響?	Landscape Imp Tree Felling Visual Impact	交通 Yes 會 □ No 不會 ☑ ly 對供水 Yes 會 □ No 不會 ☑ 討排水 Yes 會 □ No 不會 ☑ 対坡 Yes 會 □ No 不會 ☑ opes 受斜坡影響 Yes 會 □ No 不會 ☑ pact 構成景觀影響 Yes 會 □ No 不會 ☑		

Please state measure(s) to minimise the impact(s). For tree felling, please state the number, diameter at breast height and species of the affected trees (if possible) in				
	Temporary Use or Development in Rural Areas or Regulated Areas 區路時用途/發展的許可續期			
(a) Application number to which the permission relates 與許可有關的申請編號	A//			
(b) Date of approval 獲批給許可的日期	(DD 日AVIM 月/YYYY 年)			
(c) Date of expiry 許可屆滿日期	(DD 月/MM 月/YYYY 年)			
(d) Approved use/development 已批給許可的用途/發展				
(e) Approval conditions 附帶條件	□ The permission does not have any approval condition 許可並沒有任何附帶條件 □ Applicant has complied with all the approval conditions 申請人已履行全部附帶條件 □ Applicant has not yet complied with the following approval condition(s): 申請人仍未履行下列附帶條件: □ Reason(s) for non-compliance:			
(f) Renewal period sought 要求的續期期間	□ year(s) 年			

7.	Justifications 理由
The 現謂	applicant is invited to provide justifications in support of the application. Use separate sheets if necessary. 申請人提供申請理由及支持其申請的資料。如有需要,請另頁說明)。
Ple	ase refer to the supplementary statement.
•••••	

•••••	
••••	
••••	
44144	
*****	······································
••••	

•••••	•
7	
,,,,,	
•••••	
•••••	
••••	

8. Declaration 聲明
I hereby declare that the particulars given in this application are correct and true to the best of my knowledge and belief. 本人謹此聲明,本人就這宗申請提交的資料,據本人所知及所信,均屬真實無誤。
I hereby grant a permission to the Board to copy all the materials submitted in this application and/or to upload such materials to the Board's website for browsing and downloading by the public free-of-charge at the Board's discretion. 本人現准許委員會酌情將本人就此申請所提交的所有資料複製及/或上載至委員會網站,供公眾免費瀏覽或下載。
Signature
Michael WONG
Name in Block Letters Position (if applicable) 姓名(請以正楷填寫) 職位 (如適用)
Professional Qualification(s) □ Member 會員 / □ Fellow of 資深會員 □ HKIP 香港規劃師學會 / □ HKIA 香港建築師學會 / □ HKIS 香港測量師學會 / □ HKIE 香港工程師學會 / □ HKILA 香港園境師學會 / □ HKIUD 香港城市設計學會 □ RPP 註冊專業規劃師 Others 其他
on behalf of R-riches Property Consultants Limited 盈卓物業顧問有限公司
☑ Company 公司 / ☐ Organisation Name and Chop (if applicable) 機構名稱及蓋草(如適用)
Date 日期 28/11/2023 (DD/MM/YYYY 日/月/年)
Remark 備註
The materials submitted in this application and the Board's decision on the application would be disclosed to the public.

The materials submitted in this application and the Board's decision on the application would be disclosed to the public. Such materials would also be uploaded to the Board's website for browsing and free downloading by the public where the Board considers appropriate.

委員會會向公眾披露申請人所遞交的申請資料和委員會對申請所作的決定。在委員會認為合適的情況下,有關申請 資料亦會上載至委員會網頁供公眾免費瀏覽及下載。

Warning 警告

Any person who knowingly or wilfully makes any statement or furnish any information in connection with this application, which is false in any material particular, shall be liable to an offence under the Crimes Ordinance. 任何人在明知或故意的情况下,就追宗申請提出在任何要項上是虛假的陳述或資料,即屬違反《刑事罪行條例》。

Statement on Personal Data 個人資料的聲明

- The personal data submitted to the Board in this application will be used by the Secretary of the Board and Government departments for the following purposes:
 委員會就這宗申請所收到的個人資料會交給委員會秘書及政府部門,以根據《城市規劃條例》及相關的城市規劃委員會規劃指引的規定作以下用途:
 - (a) the processing of this application which includes making available the name of the applicant for public inspection when making available this application for public inspection; and 處理這宗申請,包括公布這宗申請供公眾查閱,同時公布申請人的姓名供公眾查閱;以及
 - (b) facilitating communication between the applicant and the Secretary of the Board/Government departments. 方便申請人與委員會秘書及政府部門之間進行聯絡。
- 2. The personal data provided by the applicant in this application may also be disclosed to other persons for the purposes mentioned in paragraph 1 above.

 申請人就這宗申請提供的個人資料,或亦會向其他人士披露,以作上述第 1 段提及的用途。
- 3. An applicant has a right of access and correction with respect to his/her personal data as provided under the Personal Data (Privacy) Ordinance (Cap. 486). Request for personal data access and correction should be addressed to the Secretary of the Board at 15/F, North Point Government Offices, 333 Java Road, North Point, Hong Kong. 根據《個人資料(私隱)條例》(第 486 章)的規定,申請人有權查閱及更正其個人資料。如欲查閱及更正個人資料,應向委員會秘書提出有關要求,其地址為香港北角渣華道 333 號北角政府合署 15 樓。

Gist of Applica	tion 申請摘要
consultees, uploaded available at the Planr (譜 素量以英文及中	ils in both English and Chinese <u>as far as possible</u> . This part will be circulated to relevant to the Town Planning Board's Website for browsing and free downloading by the public and ting Enquiry Counters of the Planning Department for general information.) 文填寫。此部分將會發送予相關諮詢人士、上載至城市規劃委員會網頁供公眾免費瀏覽及對資料查詢處供一般參閱。)
Application No.	(For Official Use Only) (請勿填寫此欄)
申請編號	
Location/address	
位置/地址	Lot 1434 (Part) in D.D. 107, Kam Tin, Yuen Long, New Territories
Site area 地盤面積	498 sq. m 平方米 🛭 About 約
	(includes Government land of 包括政府土地 N/A sq. m 平方米 □ About 約)
Plan 圖則	Draft Kam Tin North Outline Zoning Plan No. S/YL-KTN/11
Zoning 地帶	"Agriculture" Zone
Type of Application 申請類別	☑ Temporary Use/Development in Rural Areas or Regulated Areas for a Period of 位於鄉郊地區或受規管地區的臨時用途/發展為期
H-max(),1	☑ Year(s) 年 <u>3</u> □ Month(s) 月
	□ Renewal of Planning Approval for Temporary Use/Development in Rural Areas or Regulated Areas for a Period of 位於鄉郊地區或受規管地區臨時用途/發展的規劃許可續期為期
	□ Year(s) 年 □ Month(s) 月
Applied use/ development 申請用途/發展	Proposed Temporary Warehouse (Excluding Dangerous Goods Godown) with Ancillary Facilities for a Period of 3 Years and Associated Filling of Land and Pond

積比率
oout 約 ot more than 多於
out 約 of more than 多於
m 米 han 不多於)
preys(s) 層 nan 不多於)
m 米 nan 不多於)
oreys(s) 層 nan 不多於)
About 約
1 (LGV)

	<u>Chinese</u> 中文	English 英文
Plans and Drawings 圖則及繪圖		
Master layout plan(s)/Layout plan(s) 總綱發展藍圖/布局設計圖		Ø
Block plan(s) 樓宇位置圖		
Floor plan(s) 樓宇平面圖		
Sectional plan(s) 截視圖		
Elevation(s) 立視圖		
Photomontage(s) showing the proposed development 顯示擬議發展的合成照片		
Master landscape plan(s)/Landscape plan(s) 園境設計總圖/園境設計圖		3 0 0 0 0
Others (please specify) 其他(請註明) Plan showing the zoning of the Site, Plan showing the land status of the Site,		Ø
Location Plan, Plan showing the filling of land and pond area of the Site, Swept path and	alysis	
Reports 報告書		
Planning Statement/Justifications 規劃綱領/理據		Ø
Environmental assessment (noise, air and/or water pollutions)		
環境評估(噪音、空氣及/或水的污染)		
Traffic impact assessment (on vehicles) 就車輛的交通影響評估		
Traffic impact assessment (on pedestrians) 就行人的交通影響評估		
Visual impact assessment 視覺影響評估		
Landscape impact assessment 景觀影響評估		
Tree Survey 樹木調査		
Geotechnical impact assessment 土力影響評估		
Drainage impact assessment 排水影響評估		
Sewerage impact assessment 排污影響評估		
Risk Assessment 風險評估		
Others (please specify) 其他(請註明)		
	-	

Note: The information in the Gist of Application above is provided by the applicant for easy reference of the general public. Under no circumstances will the Town Planning Board accept any liabilities for the use of the information nor any inaccuracies or discrepancies of the information provided. In case of doubt, reference should always be made to the submission of the applicant. 注:上述申請摘要的資料是由申請人提供以方便市民大眾參考。對於所載資料在使用上的問題及文義上的歧異,城市規劃委員

會概不負責。若有任何疑問、應查閱申請人提交的文件。

Supplementary Statement

1) Background

- 1.1 The applicant seeks planning permission from the Town Planning Board (the Board) to use *Lot* 1434 (part) in D.D. 107, Kam Tin, Yuen Long, New Territories (the Site) for 'Proposed Temporary Warehouse (Excluding Dangerous Goods Godown) with Ancillary Facilities for a Period of 3 Years and Associated Filling of Land and Pond' (proposed development) (Plan 1).
- 1.2 In view of the pressing demand for indoor storage space in recent years, the applicant would like to use the Site for warehouse in order to support the local warehousing and storage industry.

2) Planning Context

- 2.1 The Site currently falls within an area zoned as "Agriculture" ("AGR") on the Approved Kam Tin North Outline Zoning Plan (OZP) No.: S/YL-KTN/11. According to the Notes of the OZP, the applied use is neither a column one nor column two use within the "AGR" zone, which requires planning permission from the Board (Plan 2).
- 2.2 Although the Site falls within area zoned as "AGR", there is no active agricultural use within the Site. The Site is also surrounded by temporary structures for warehouse use and vacant land, the proposed development is considered not incompatible with the surrounding area. Therefore, the approval of the current application on a temporary basis of 3 year would better utilize deserted agricultural land in the New Territories without jeopardizing the long-term planning intention of the "AGR" zone.
- 2.3 Furthermore, several similar S.16 planning applications (Nos. A/NE-KTN/937, 938, 939, 940, 955, 957 etc.) for 'warehouse' use within the same "AGR" zone were approved by the Board previously. The most recent S.16 planning application (Nos. A/YL-KTN/957) for 'warehouse' use within the same "AGR" zone was approved by the Board for a temporary basis in 2023. Therefore, approval of the current application is in line with the Board's previous decision and would not set undesirable precedent within the "AGR" zone.

3) Development Proposal

3.1 The Site occupied an area of 498 m² (about) (Plan 3). The operation hours of Site are Monday



to Saturday from 09:00 to 18:00. No operation on Sunday and public holiday. Two structures are proposed at the Site for warehouses (excluding dangerous goods godown) and covered loading/unloading (L/UL) area with total GFA of 379 m² (about) (Plan 4). It is estimated that the Site would be able to accommodate 3 staff. As the Site is proposed for 'warehouse' use with no shopfront, no visitor is anticipated at the Site. Details of development parameters are shown at **Table 1** below:

Table 1 - Major Development Parameters

Application Site Area	498 m² (about)	
Covered Area	379 m² (about)	
Uncovered Area	119 m² (about)	
Plot Ratio	0.76 (about)	
Site Coverage	76% (about)	
Number of Structure	2	
Total GFA	379 m² (about)	
- Domestic GFA	Not applicable	
- Non-Domestic GFA	379 m² (about)	
Building Height	7 m (about)	
No. of Storey	1	

- 3.2 The proposed warehouse is intended for storage of miscellaneous goods (i.e. packaged food, apparel, footwear, electronic goods, furniture etc). No dangerous goods and workshop activities will be stored/conducted at the Site at any time during the planning approval period.
- 3.3 The Site is proposed to be filled wholly with concrete of not more than 0.2m (about) in depth for site formation of structures and circulation area (Plan 5). Furthermore, an existing dried pond within the Site is also proposed to be filled to the surrounding site levels (i.e. +9.8mPD), in order to facilitate a flat ground surface (Plan 5). As heavy loading of structures and vehicles would compact the existing soiled ground and weaken the ground surface, concrete site formation is required to meet the operation needs and that has been kept to minimal for the operation of the proposed development. The applicant will reinstate the Site to an amenity area after the planning approval period.
- 3.4 The Site is accessible from Shui Mei Road via a local access (Plan 1). One L/UL space is



provided at the Site, details are shown at Table 2 below:

Table 2 – Parking and L/UL Provisions

Type of Space	No. of Space
L/UL Space for Light Goods Vehicle (LGV)	. 1
- 3.5 m (W) x 7 m (L)	

3.5 LGV is deployed for transportation of goods to be stored at the Site, hence, L/UL space for the aforesaid vehicles is provided (Plan 4). Sufficient space is also provided for vehicle to smoothly manoeuvre within the Site to ensure that no vehicle will turn back onto the local access (Plan 6). No medium or heavy goods vehicles including container tractors/trailers, as defined in the *Road Traffic Ordinance* are allowed to be parked/stored on or enter/exit the Site at any time during the planning approval period. As traffic generated and attracted by the proposed development is minimal (as shown at Table 3 below), adverse traffic impact to the nearby road network should not be anticipated.

Table 3 – Trip Generation and Attractions of the Site

Time Period	LGV		2-Way Total
Time Feriod	ln	Out	2-way lotal
Trips at <u>AM peak</u> per hour (09:00 – 10:00)	1	0	1
Trips at <u>PM peak</u> per hour (17:00 – 18:00)	0	1	1
Traffic trip per hour (average) (10:00 – 17:00)	0.5	0.5	1

3.6 The applicant will strictly follow the 'Code of Practice on Handling the Environmental Aspects of Temporary Uses and Open Storage Sites' issued by Environmental Protection Department (EPD) to minimize adverse environmental impacts and nuisance to the surrounding area. The applicant will follow the Professional Persons Environmental Consultative Committee Practice Notes (ProPECCPNs) for sewage treatment at the Site.

4) Conclusion

4.1 The proposed development will not create significant nuisance to the surrounding areas. Adequate mitigation measures will be provided, i.e. submission of drainage and fire service installations proposals to mitigate any adverse impact arising from the proposed development after planning approval has been granted by the Board.



4.2 In view of the above, the Board is hereby respectfully recommended to <u>approve</u> the subject application for 'Proposed Temporary Warehouse (Excluding Dangerous Goods Godown) with Ancillary Facilities for a Period of 3 Years and Associated Filling of Land and Pond'.


R-riches Property Consultants Limited
November 2023





LIST OF PLANS

Plan 1	Location Plan
Plan 2	Plan Showing the Zoning of the Application Site
Plan 3	Plan Showing the Land Status of the Application Site
Plan 4	Layout Pian
Plan 5	Plan Showing the Filling of Pond and Land Area of the Application Site
Plan 6	Swept Path Analysis




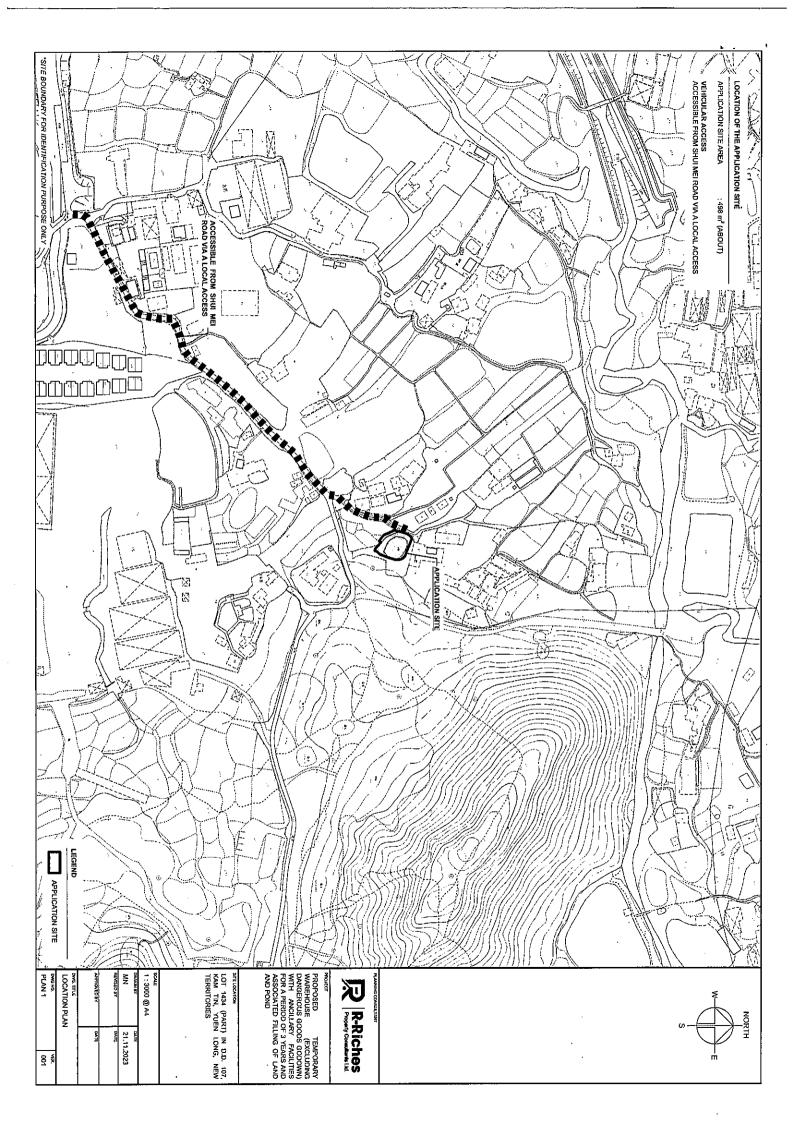


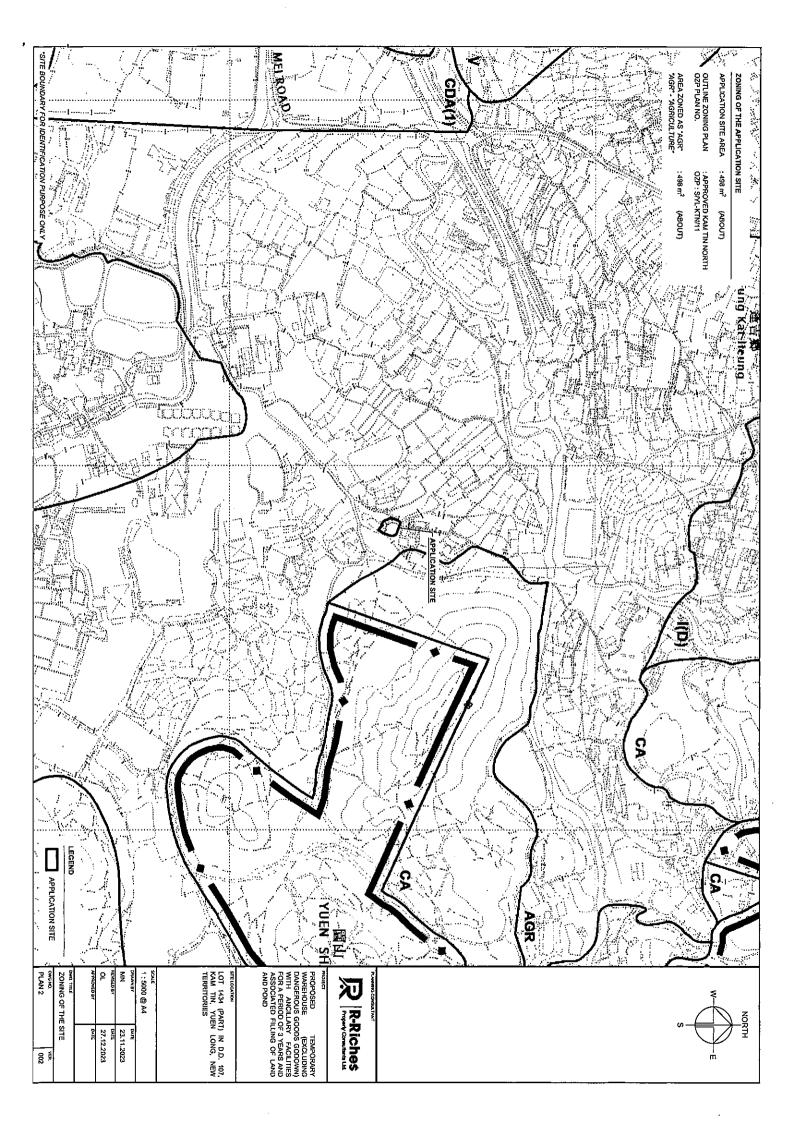

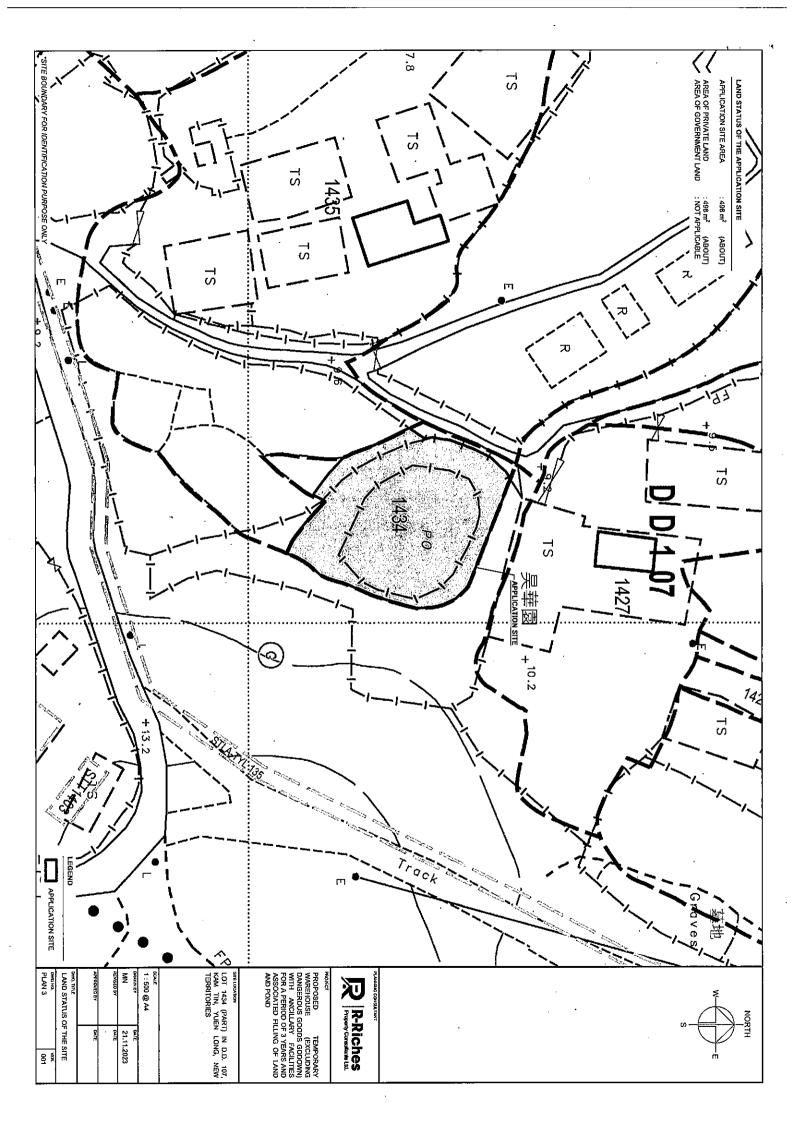

NO, OF L/UL SPACE FOR LIGHT GOODS VEHICLE :1 DIMENSION OF L/UL SPACE :7 m (L) \times 3.5 m (W) LOADING / UNLOADING PROVISIONS NO. OF STRUCTURE
DOMESTIC GFA
NON-DOMESTIC GFA
TOTAL GFA BUILDING HEIGHT NO. OF STOREY PLOT RATIO SITE COVERAGE APPLICATION SITE AREA COVERED AREA UNCOVERED AREA DEVELOPMENT PARAMETERS : NOT APPLICABLE : 379 m² (AE : 379 m² (AE : 0.76 : 76 % : 498 m² : 379 m² : 119 m² (ABOUT) (ABOUT) (ABOUT) (ABOUT) (ABOUT) COVERED LOADING / UNLOADING SPACE FOR LIGHT GOODS VEHICLE INGRESS / EGRESS 7.3 m (ABOUT)(W) *D.G.G. - DANGEROUS GOODS GODOWN B2 STRUCTURE (ABOUT) 므 ESD. WAREHOUSE (EXCLUDING D.G.G.) AND COVERED LOADING / UNLOADING AREA WAREHOUSE (EXCLUDING D.G.G.) 많 -APPLICATION SITE TOTAL 379 m² (ABOUT) 188 m² (ABOUT) COVERED AREA 191 m² (ABOUT) 188 m² (ABOUT) 379 m² (ABOUT) 191 m² (ABOUT) GFA LEGEND INGRESS / EGRESS LOADING / UNLOADING SPACE STRUCTURE APPLICATION SITE BUILDING HEIGHT 7 m (ABOUT)(1-STOREY) 7 m (ABOUT)(1-STOREY) PROPOSED TEMPORARY WAREHOUSE (EXCLUDING DANGEROUS GOODS GOODWI) WITH ANCILLARY FACILITIES FOR A PERIOD OF 3 YEARS AND ASSOCIATED FILING OF LAND AND POND PLAN 4 ş LOT 1434 (PART) IN D.D. 107, KAM TIN, YUEN LONG, NEW TERRITORIES LAYOUT PLAN 1:300 @ A4 R-Riches 21.11.2023 8 8

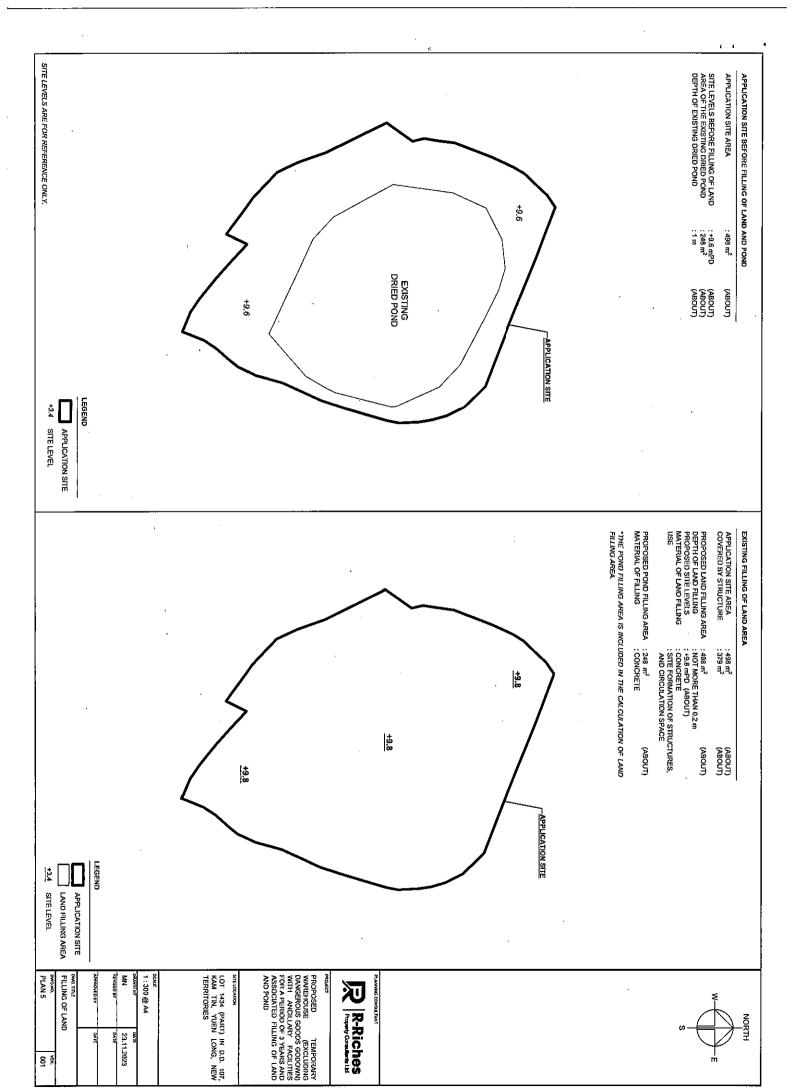

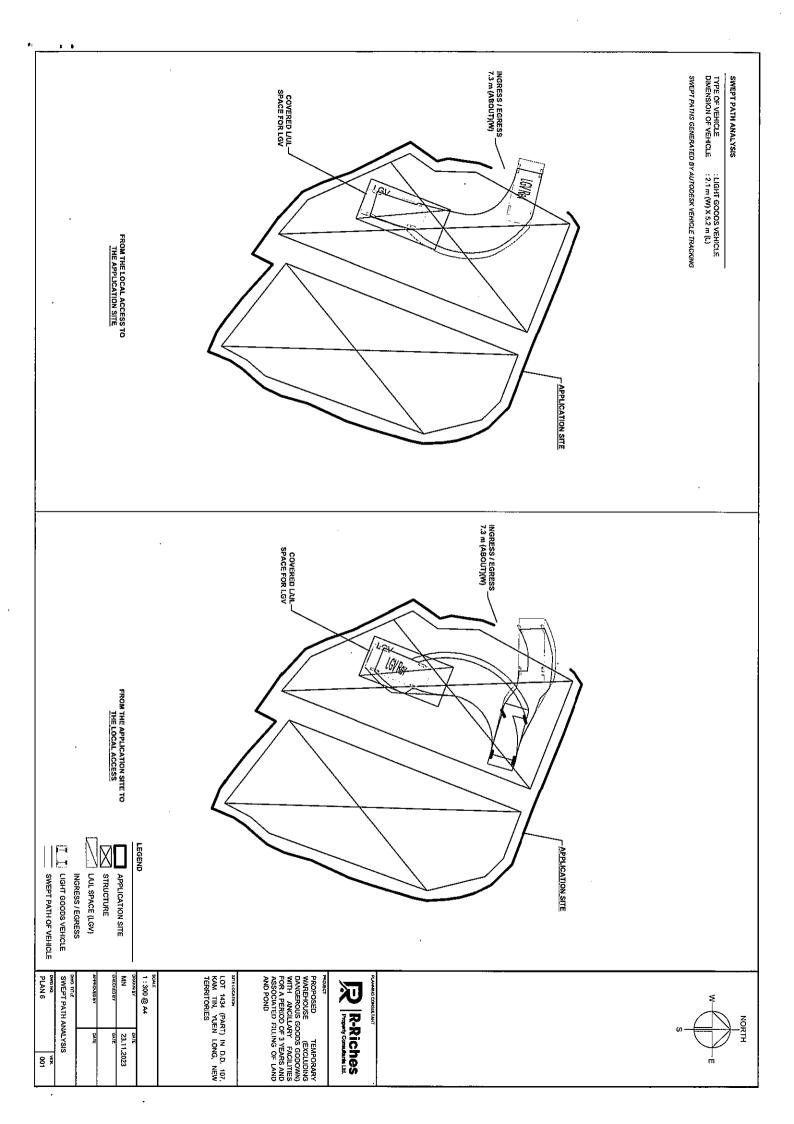

. •



Appendix Ia of RNTPC
Paper No. A/YL-KTN/979B



Our Ref.

: DD107 Lot 1434

Your Ref.

: TPB/A/YL-KTN/979

The Secretary
Town Planning Board
15/F, North Point Government office
333 Java Road
North Point, Hong Kong

By Email

22 March 2024

Dear Sir,

1st Further Information

Proposed Temporary Warehouse (Excluding Dangerous Goods Godown) with Ancillary Facilities for a Period of 3 Years and Associated Filling of Land and Pond in "Agriculture" Zone,

<u>Lot 1434 (Part) in D.D. 107, Kam Tin, Yuen Long, New Territories</u>

(S.16 Planning Application No. A/YL-KTN/979)

We are writing to submit further information to address departmental comments of the subject application (Appendix I).

Should you require more information regarding the application, please contact our Mr.

Orpheus LEE at or the undersigned at your convenience. Your kind attention to the matter is much appreciated.

Yours faithfully,

For and on behalf of R-riches Property Consultant's Limited

Louis TSE

Town Planner

Departmental Comments

Responses-to-Comments

Proposed Temporary Warehouse (Excluding Dangerous Goods Godown) with Ancillary Facilities for a Period of 3 Years and Associated Filling of Land and Pond in "Agriculture" Zone,

Lot 1434 (Part) in D.D. 107, Kam Tin, Yuen Long, New Territories

(Application No. A/YL-KTN/979)

Applicant's Responses

(i) A RtoC Table:

1. Comments of the Chief Engineer/Mainland North, Drainage Services Department (CE/MN, DSD) (Contact Person: Mr. Terence TANG; Tel.: 2300 1257) A drainage proposal, with provision of (a) I have reservation on the subject development as there as proposed pond peripheral u-channel and catchpits is provided and land filling works and appears covering mitigate potential drainage impact the whole application site but there is no generated by the proposed development (Annex I). The applicant will implement the substantiation show how the overland flow from adjacent areas would not be proposed drainage facilities at the application site (the Site) once the drainage proposal is interrupted by the proposed works. accepted by CE/MN, DSD / Town Planning Board. 2. Comments of the Director of Agriculture, Fisheries and Conservation (DAFC) (Contact Person: Ms. WONG Cheuk-ling; Tel: 2150 6933) Please be noted that the Site is currently vacant The agricultural activities are active in the vicinity, and agricultural infrastructures and there is no active agricultural use within such as road access and water source are the Site. The Site is also surrounded by also available. The subject site can be used temporary structures for warehouse use and vacant land. As the proposed development is for agricultural activities such as open-field cultivation, greenhouses, plant nurseries, intended to support the warehousing and etc. As the subject site possesses potential storage industry, approval of the application on for agricultural rehabilitation, the proposed a temporary basis of 3 years would not development is not supported from frustrate the long term planning intention of the "Agriculture" zone and better utilize agricultural perspective. deserted agricultural land. The applicant will reinstate the Site to a state that is suitable for agricultural use after the planning approval period. Please be informed that the fish pond is dried Pond filling is generally not recommended from a fisheries viewpoint. Although the for decades. The applicant submitted a fish pond is currently of unknown status, it drainage proposal in accordance with



has the potential to be used for fish culture operations in the future. As such, the application is not supported from a fisheries viewpoint."

requirements from DSD, including the provision of peripheral u-channels and catchpits to mitigate the potential adverse drainage impact generated by the proposed development. Therefore, direct impact to the fish pond should not be anticipated.



Proposed Temporary Warehouse (Excluding Dangerous Goods Godown) with Ancillary Facilities for a Period of 3 Years and Associated Filling of Land and Pond in "Agriculture" Zone, Lot 1434 (part) in D.D. 107, Kam Tin, Yuen Long, New Territories

Drainage Appraisal

March 2024

Table of Content

1.	Intr	oduction	1
	1.1	Background	
	1.2	The Site	1
2.	Dev	velopment Proposal	2
	2.1	The Proposed Development	2
3,	Ass	essment Criteria	2
4.	Pro	posed Drainage System	5
5.	Cor	nclusion	5
Lis	st of	Table	
		Key Development Parameters	
Tal	ole 2–	Design Return Periods under SDM	2

List of Figure

Figure 1 - Site Location Plan

Figure 2 - Existing Drainage Plan

Figure 3 – Proposed Drainage System

List of Appendix

Appendix A - Design Calculation

Appendix B - Development Layout Plan

Appendix C – Reference Drawings for UChannel, Catchpit and Manhole

1.Introduction

1.1 Background

- 1.1.1 The applicant seeks planning permission from the Town Planning Board (the Board) to use Lot 1434 (part) in D.D. 107, Kam Tin, Yuen Long, New Territories (the Site) for 'Proposed Temporary Warehouse (Excluding Dangerous Goods Godown) with Ancillary Facilities for a Period of 3 Years and Associated Filling of Land and Pond' (Proposed Development).
- 1.1.2 This Drainage Proposal is to support the planning application for the proposed use.

1.2 The Site

- 1.2.1 The Application Site area is about 498m², and it situates beside local tracks at the west, south and east. Those local track connect the site to Shui Mei Road in the South of the Proposed Development. The site is partly occupied by existing structures, abandoned dried pond and grassland.
- 1.2.2 The Application Site is surrounded by grassland, temporary structures and local track. It is generally flat with existing ground level of approx. +9.6 mPD and it is proposed to be filled up to +9.8 mPD after the Proposed Development.
- 1.2.3 The site location plan is shown in Figure 1.
- 1.2.4 Existing Drainage Plan is shown in Figure 2 for reference.
- 1.2.5 Proposed Development Layout plan is shown in Appendix B for reference.

2. Development Proposal

2.1 The Proposed Development

2.1.1 The total site area is approximately 498m². The indicative development schedule is summarized in **Table 1** below for technical assessment purpose.

Proposed Development	
Total Site Area (m²)	498
Assume all proposed site area as paved	498
area after development for assessment	
purpose (m²)	•

Table 1 - Key Development Parameters

3. Assessment Criteria

3.1.1 The Recommended Design Return Period based on Flood Level from SDM (Table 10) is adopted for this DIA. The recommendation is summarized in **Table 2** below.

Description	Design Return Periods
Intensively Used Agricultural Land	2 – 5 Years
Village Drainage Including Internal	10 Years
Drainage System under a polder	
Scheme	
Main Rural Catchment Drainage	50 Years
Channels	
Urban Drainage Trunk System	200 Years
Urban Drainage Branch System	50 Years

Table 2- Design Return Periods under SDM

3.1.2 The site and the surrounding are generally flat. The proposed village drainage system intended to collect runoff from the internal site and discharge to existing nearby public drainage system. 1 in 10 years return period is adopted for the drainage design.

- 3.1.3 stormwater drainage design will be carried out in accordance with the criteria set out in the Stormwater Drainage Manual published by DSD. The proposed design criteria to be adopted for design of this stormwater drainage system and factors which have been considered are summarised below.
 - 1. Intensity-Duration-Frequency Relationship The Recommended Intensity-Duration-Frequency relationship is used to estimate the intensity of rainfall. It can be expressed by the following algebraic equation.

$$i = \frac{a}{(t_d + b)^c}$$

The site is located within the HKO Headquarters Rainfall Zone. Therefore, for 10 years return period, the following values are adopted.

a =
$$471.9$$

b = 3.02
c = 0.397

2. The peak runoff is calculated by the Rational Method i.e. $Q_p = 0.278 \text{CiA}$

where
$$Q_p$$
 = peak runoff in m^3/s
 C = runoff coefficient (dimensionless)
 i = rainfall intensity in mm/hr
 A = catchment area in km^2

3. The run-off coefficient (C) of surface runoff are taken as follows:

Paved Area: C = 0.95
 Unpaved Area: C = 0.35

4. Manning's Equation is used for calculation of velocity of flow inside the channels:

Manning's Equation:
$$v = \frac{R^{\frac{1}{6}}}{n} R^{\frac{1}{2}} S_f^{\frac{1}{2}}$$

Where,

V = velocity of the pipe flow (m/s)

S_f = hydraulic gradient

n = manning's coefficient

R = hydraulic radius (m)

5. Colebrook-White Equation is used for calculation of velocity of flow inside the pipes:

$$\overline{v} = -\sqrt{32gRS}\log(\frac{k_s}{14.8R} + \frac{1.255v}{R\sqrt{32gRS_f}})$$

where,

V = velocity of the pipe flow (m/s)

S_f = hydraulic gradient k_f = roughness value (m)

v = kinematics viscosity of fluid

D = pipe diameter (m) R = hydraulic radius (m)

4. Proposed Drainage System


- 4.1.1 The Application Site and the surrounding areas are generally flat. Internal drainage system is proposed to collect the runoff from the application site and discharge to the existing drainage system under the local tracks at the south. The alignment, size and gradient of the proposed drains are shown in **Figure 3**.
- 4.1.2 The design calculations of proposed channels are shown in Appendix A.


5. Conclusion


- 5.1.1 A drainage appraisal has been conducted for the Proposed Development. The surface runoff from the Application Site will be collected by the proposed perimeter Uchannel/drains and discharge to the existing drainage system under the southern local track.
- 5.1.2 With the proposed drainage system, it is anticipated that there will be no significant drainage impact to the area after the implementation of the development.

End of text -

FIGURES

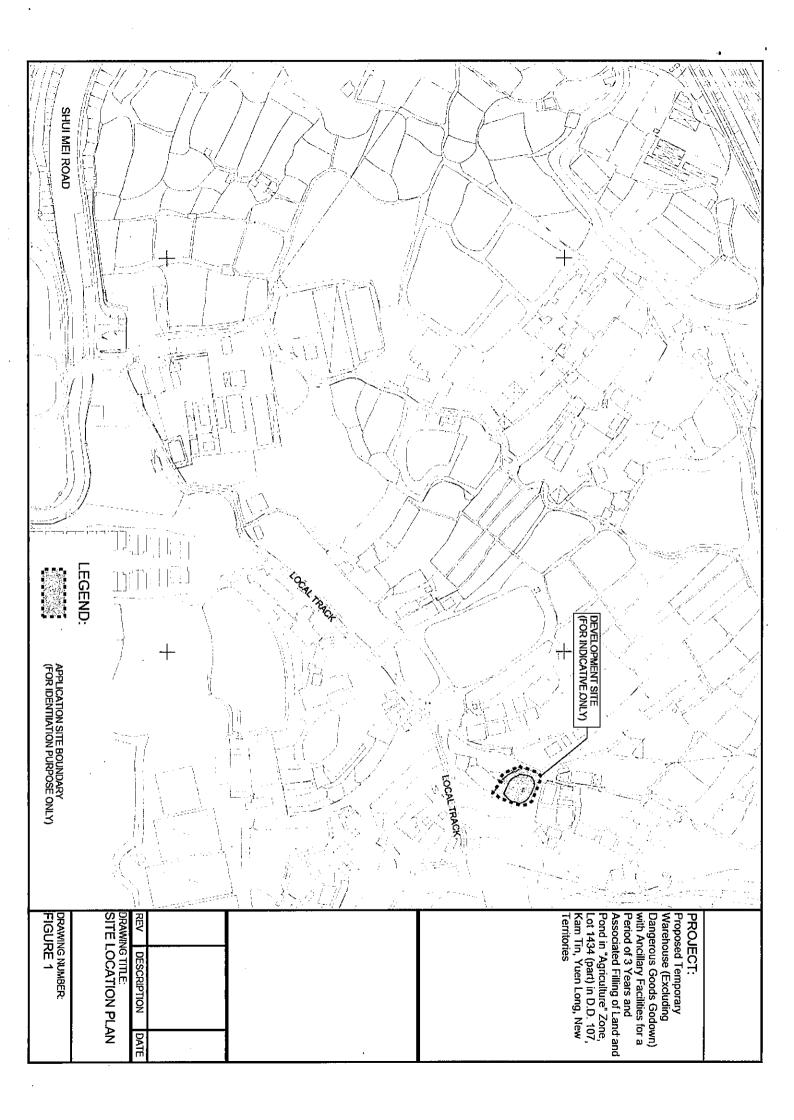

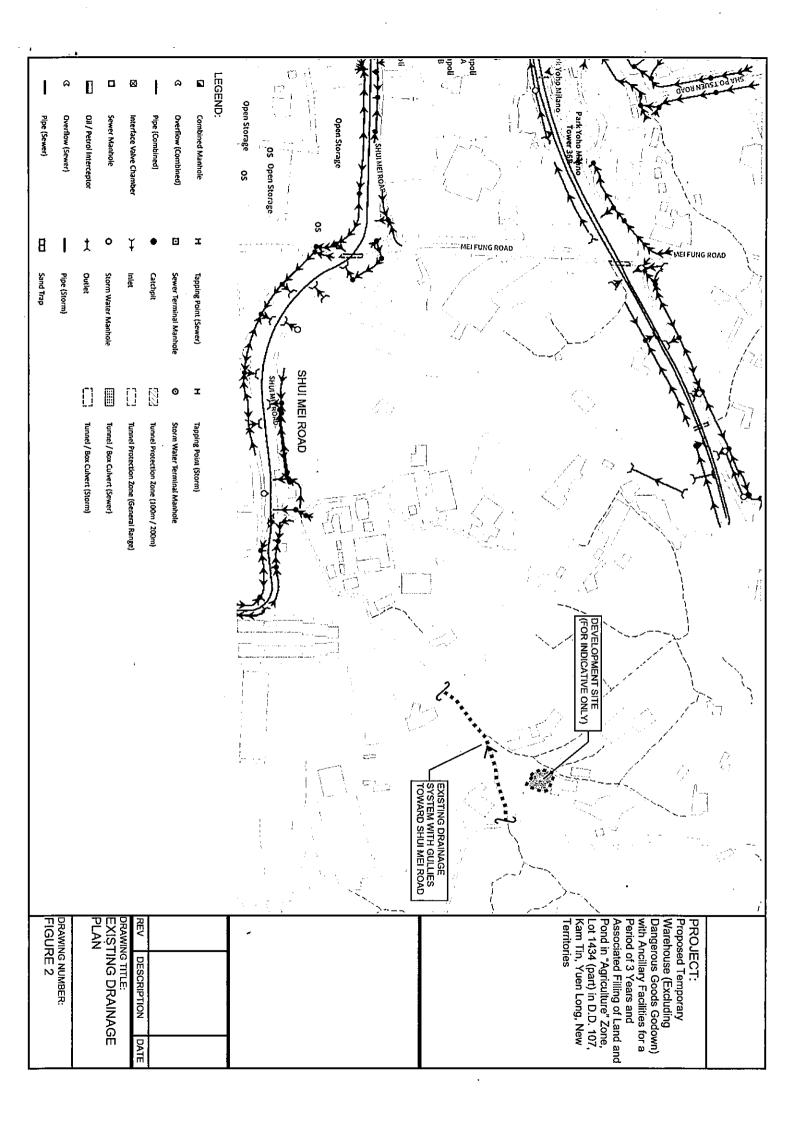

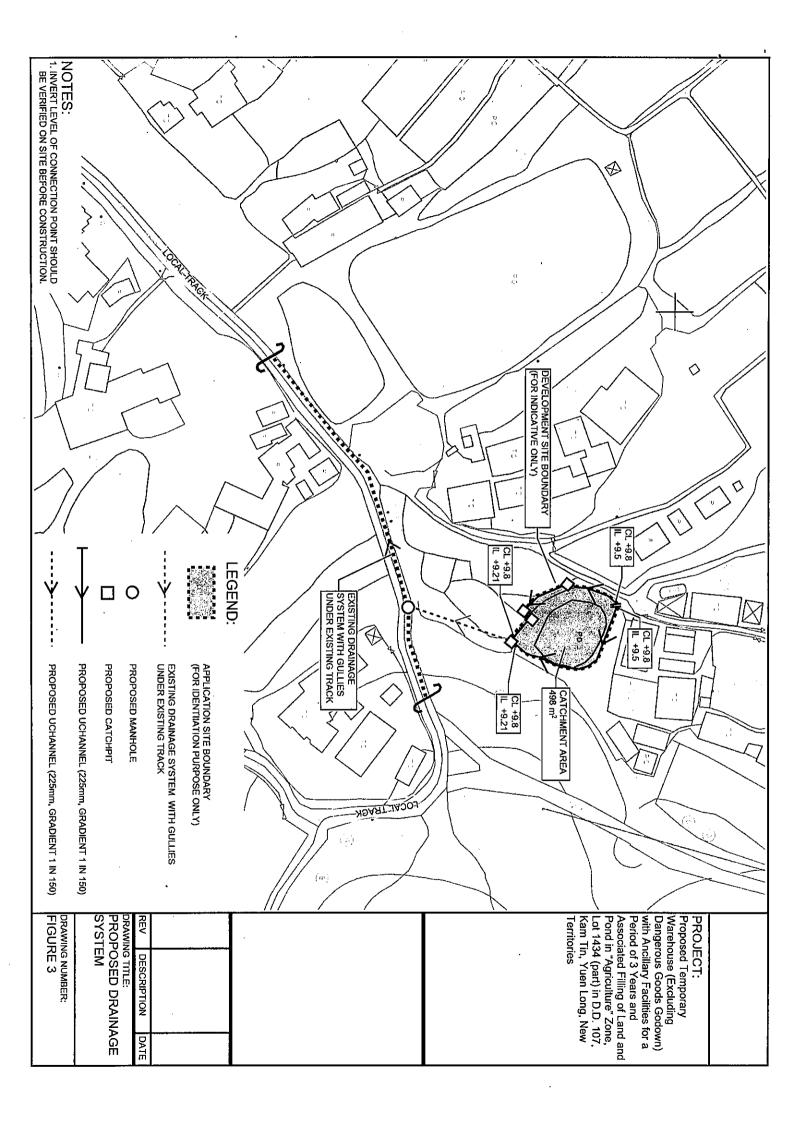

Appendix

Appendix A - Design Calculation

Channel Design

U Channel - Internal

Runoff Estimation			
Design Return Period	1 in	10	years
Paved Area*		498	(T) (2)
Unpaved Area*		0	(m2)
Total Equivalent Area		473	(m2)
Rainfall Intensity, I **		206	mm/hr
Design Discharge Rate, Q***		0.027	m3/s

Assume all the site area is paved for assessment purpose

$$i = \frac{a}{(t_d + b)^c}$$

*** $Q = 0.278 \times 473 \times 206 / 1000000$


		=	2	
		-	č	
	_			
Velocity			1.07	m/s
: '			1	
Capacity	_		0.048 m3/s	m3/s
Utilization	0.027 / 0.048	Iŧ	56.38	¥.
			1	i

PipeWorks Design


Runoff Estimation		
Design Return Period	1 in 10	years
Paved Area*	498	
Unpaved Area*	٥	m2
Total Equivalent Area	473	己
Time of Concentration	Ų,	
Rainfall Intensity	206	_
Design Discharge Rate	0.02	0.027 m3/s


Pipe Design		
Pipe Size	. 225 n	mm
Gradient	1 in 150	
Velocity		쿲
Capacity	0.049 п	m3/s
Utilization	= 55.42	%

^85%

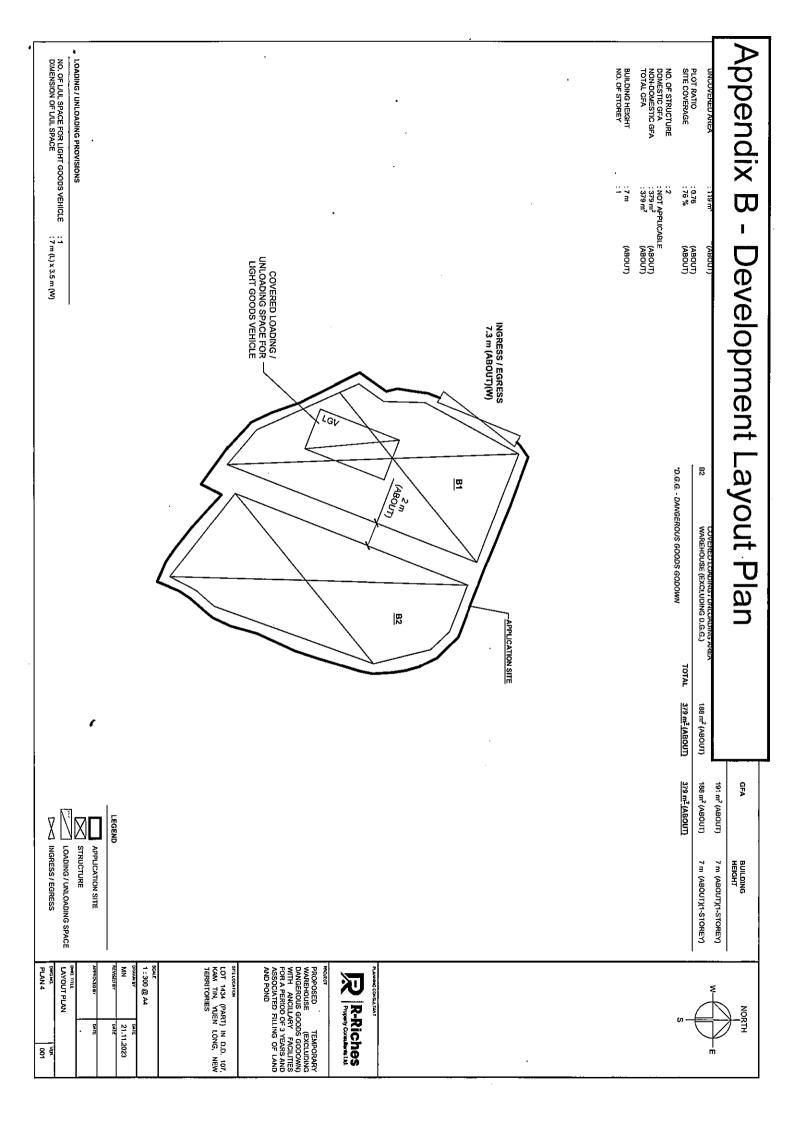

Appendix C - Reference Drawings

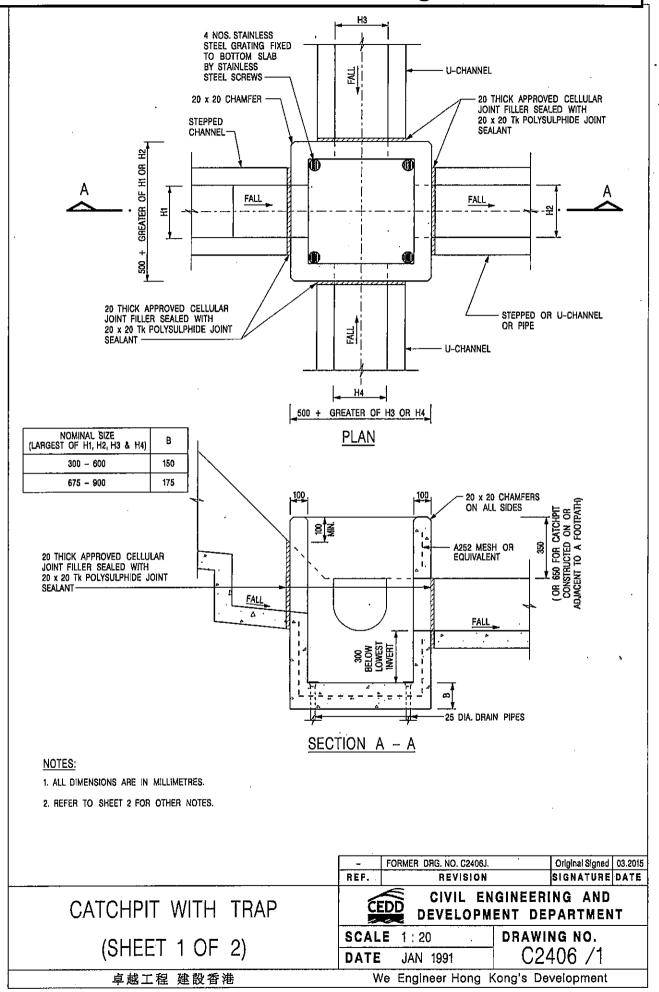

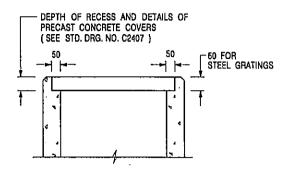

ALTERNATIVE TOP SECTION FOR PRECAST CONCRETE COVERS / GRATINGS

NOTES:

- 1. ALL DIMENSIONS ARE IN MILLIMETRES.
- 2. ALL CONCRETE SHALL BE GRADE 20 /20.
- 3. CONCRETE SURFACE FINISH SHALL BE CLASS U2 OR F2 AS APPROPRIATE.
- 4. FOR DETAILS OF JOINT, REFER TO STD. DRG. NO. C2413.
- 5. CONCRETE TO BE COLOURED AS SPECIFIED.
- UNLESS REQUESTED BY THE MAINTENANCE PARTY AND AS DIRECTED BY THE ENGINEER, CATCHPIT WITH TRAP IS NORMALLY NOT PREFERRED DUE TO PONDING PROBLEM.
- UPON THE REQUEST FROM MAINTENANCE PARTY, DRAIN PIPES AT CATCHPIT BASE CAN BE USED BUT THIS IS FOR CATCHPITS LOCATED AT SLOPE TOE ONLY AND AS DIRECTED BY THE ENGINEER.
- FOR CATCHPITS CONSTRUCTED ON OR ADJACENT TO A FOOTPATH, STEEL GRATINGS (SEE DETAIL 'A' ON STD. DRG. NO. C2405 /2) OR CONCRETE COVERS (SEE STD. DRG. NO. C2407) SHALL BE PROVIDED AS DIRECTED BY THE ENGINEER.
- 9. IF INSTRUCTED BY THE ENGINEER, HANDRAILING (SEE DETAIL 'J' ON STD. DRG. NO. C2405 /5; EXCEPT ON THE UPSLOPE SIDE) IN LIEU OF STEEL GRATINGS OR CONCRETE COVERS CAN BE ACCEPTED AS AN ALTERNATIVE SAFETY MEASURE FOR CATCHPITS NOT ON A FOOTPATH NOR ADJACENT TO IT. TOP OF THE HANDRAILING SHALL BE 1 000 mm MIN. MEASURED FROM THE ADJACENT GROUND LEVEL.
- 10. MINIMUM INTERNAL CATCHPIT WIDTH SHALL BE 1 000 mm FOR CATCHPITS WITH A HEIGHT EXCEEDING 1 000 mm MEASURED FROM THE INVERT LEVEL TO THE ADJACENT GROUND LEVEL. AND, STEP IRONS (SEE DSD STD. DRG. NO. DS1043) AT 300 c/c STAGGERED SHALL BE PROVIDED. THICKNESS OF CATCHPIT WALL FOR INSTALLATION OF STEP IRONS SHALL BE INCREASED TO 150 mm.
- FOR RETROFITTING AN EXISTING CATCHPIT WITH STEEL GRATING, SEE DETAIL 'G' ON STD. DRG. NO. C2405 /4.
- SUBJECT TO THE APPROVAL OF THE ENGINEER, OTHER MATERIALS CAN ALSO BE USED AS COVERS / GRATINGS.

Α	MINOR AMENDMENT.	Original Signed	04.2016
-	FORMER DRG. NO. C2406J.	Original Signed	03.2015
REF.	REVISION	SIGNATURE	DATE

CIVIL ENGINEERING AND

CATCHPIT WITH TRAP


(SHEET 2 OF 2)

SCALE 1:20 DRAWING NO.

DATE JAN 1991

drawing no. C2406 /2A

卓越工程 建散香港

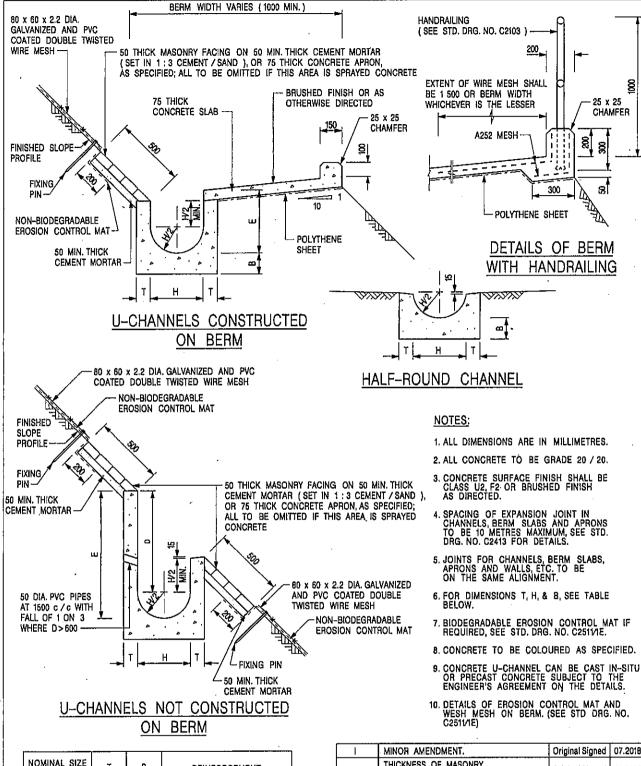

NOMINAL SIZE H	T	В	REINFORCEMENT
300	80	100	A252 MESH PLACED CENTRALLY AND T=100
375 - 600	100	150	WHEN E>650
675 - 900	125	175	A252 MESH PLACED CENTRALLY

LS OF HALF-ROUND	DETA
CHANNELS (TYPE A -	AND U
MASONRY APRON)	WITH


直	叔	丁程	建設香港	港	

1	MINOR AMENDMENT.	Original Signed	07.2018
н	THICKNESS OF MASONRY FACING AMENDED.	Orlginal Signed	01.2005
G	MINOR AMENDMENT.	Original Signed	01.2004
F	GENERAL REVISION.	Original Signed	12.2002
Е	DRAWING TITLE AMENDED.	Original Signed	11.2001
D	MINOR AMENDMENT.	Original Signed	08.2001
C	150 x 100 UPSTAND ADDED AT BERM.	Original Signed	6.99
В	MINOR AMENDMENTS.	Orlginal Signed	3.94
REF.	REVISION	SIGNATURE	DATE

CIVIL ENGINEERING AND DEVELOPMENT DEPARTMENT

 SCALE 1:25
 DRAWING NO.


 DATE JAN 1991
 C24091

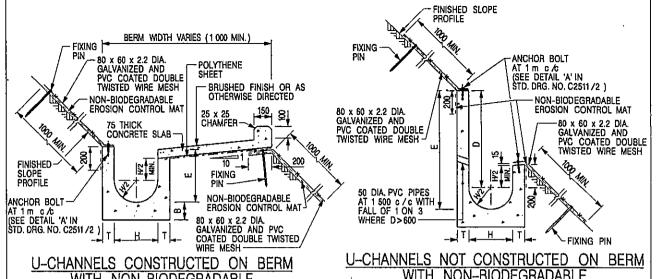

WITH NON-BIODEGRADABLE EROSION CONTROL MAT

WITH NON-BIODEGRADABLE EROSION CONTROL MAT

FINISHED SLOPE PROFILE

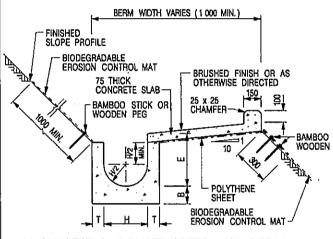

BIODEGRADABLE EROSION CONTROL MAT BAMBOO STICK OR WOODEN PEG BAMBOO STICK OR WOODEN PEG 50 DIA. PVC PIPES AT 1 500 c/c WITH FALL OF 1 ON 3 WHERE D>600 BAMBOO STICK OR WOODEN PEG.

U-CHANNELS CONSTRUCTED ON BERM WITH BIODEGRADABLE EROSION CONTROL MAT

U-CHANNELS NOT CONSTRUCTED ON BERM WITH BIODEGRADABLE EROSION CONTROL MAT

NOTES:

- 1. ALL DIMENSIONS ARE IN MILLIMETRES.
- 2. ALL CONCRETE TO BE GRADE 20 /20.
- 3. CONCRETE SURFACE FINISH SHALL BE CLASS U2, F2 OR BRUSHED FINISH AS DIRECTED.
- 4. SPACING OF EXPANSION JOINT IN CHANNELS, BERM SLABS AND APRONS TO BE 10 METRES MAXIMUM, SEE STD. DRG. NO. C2413 FOR DETAILS.
- 5. JOINTS FOR CHANNELS, BERM SLABS, APRONS AND WALLS, ETC. TO BE ON THE SAME ALIGNMENT.
- 6. FOR DIMENSIONS T, H, & B, SEE TABLE BELOW.
- 7. FOR TYPICAL FIXING PIN DETAILS, SEE STD. DRG. NO. C2511/2.
- 8. MINIMUM SIZE OF 25 x 50 x 300mm SHALL BE PROVIDED FOR WOODEN PEG.
- MINIMUM SIZE OF 10mm DIAMETER WITH 200mm LONG SHALL BE PROVIDED FOR BAMBOO STICK.
- 10. THE FIXING DETAILS OF NON-BIODEGRADABLE AND BIODEGRADABLE EROSION CONTROL MATS ON EXISTING BERM SHALL REFER TO STD. DRG. NO. C2511/1.

NOMINAL SIZE	T	В	REINFORCEMENT
300	80	100	A252 MESH PLACED CENTRALLY AND T=100
375 - 600	100	150	WHEN E>650
675 - 900	125	175	A252 MESH PLACED CENTRALLY

DETAILS OF HALF-ROUND AND U-CHANNELS (TYPE B - WITH EROSION CONTROL MAT APRON)

卓越工程 建設香港

HEF.	REVISION	SIGNATURE	DATE
A	MINOR AMENDMENT.	Original Signed	10.92
8	MINOR AMENDMENT.	Original Signed	3.94
C	150 x 100 UPSTAND ADDED AT BERM.	Original Signed	6.99
D	MINOR AMENDMENT.	Original Signed	08.2001
Ę	GENERAL REVISION.	Original Signed	12.2002
F	MINOR AMENDMENT.	Original Signed	01.2004
G	DIMENSION TABLE AMENDED.	Original Signed	01.2005
Н.	FIXING DETAILS OF BIODEGRADABLE EROSION CONTROL MAT ADDED.	Original Signed	12.2017
	MINOR AMENDMENT.	Oliginal Signed	07.2010




CIVIL ENGINEERING AND DEVELOPMENT DEPARTMENT


SCALE DIAGRAMMATIC

MINOR AMENDMENT

DATE JAN 1991 DRAWING NO. C2410I

Original Signed 07 2018

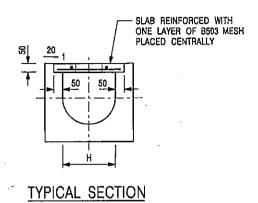


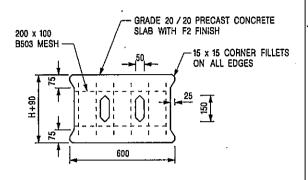


PLAN OF SLAB

U-CHANNELS WITH PRECAST CONCRETE SLABS

(UP TO H OF 525)

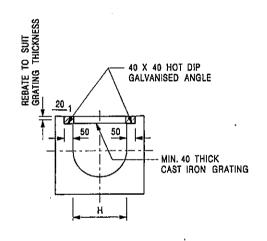

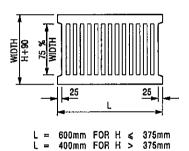

TYPICAL SECTION

CAST IRON GRATING

(DIMENSIONS ARE FOR GUIDANCE ONLY, CONTRACTOR MAY SUBMIT EQUIVALENT TYPE)

U-CHANNEL WITH CAST IRON GRATING

(UP TO H OF 525)

NOTES:

- 1. ALL DIMENSIONS ARE IN MILLIMETRES.
- 2. H=NOMINAL CHANNEL SIZE.
- 3. ALL CAST IRON FOR GRATINGS SHALL BE GRADE EN-GJL-150 COMPLYING WITH BS EN 1561.
- 4. FOR COVERED CHANNELS TO BE HANDED OVER TO HIGHWAYS DEPARTMENT FOR MAINTENANCE, THE GRATING DETAILS SHALL FOLLOW THOSE AS SHOWN ON HyD STD. DRG. NO. H3156.

REF.	REVISION	SIGNATURE	DATE
A	CAST IRON GRATING AMENDED.	Orlginal Signed	12.2002
В	NAME OF DEPARTMENT AMENDED.	Original Signed	01.2005
С	MINOR AMENDMENT, NOTE 3 ADDED.	Original Signed	12.2005
D	NOTE 4 ADDED.	Original Signed	06.2008
E	NOTES 3 & 4 AMENDED.	Original Signed	12.2014

COVER SLAB AND CAST IRON GRATING FOR CHANNELS


CEDD
1000

CIVIL ENGINEERING AND DEVELOPMENT DEPARTMENT

 SCALE 1:20
 DRAWING NO.

 DATE JAN 1991
 C2412E

卓越工程 建設香港

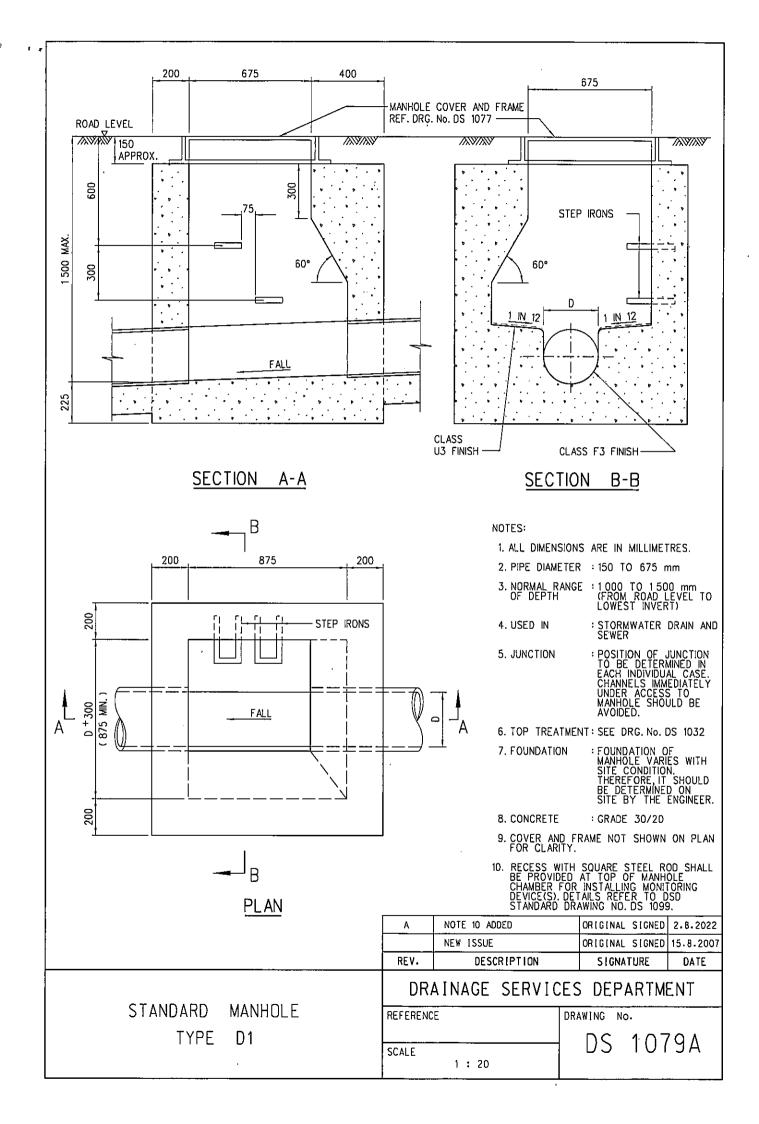





Appendix Ib of RNTPC Paper No. A/YL-KTN/979B

問有限公司

Our Ref. Your Ref. : DD107 Lot 1434 : TPB/A/YL-KTN/979

The Secretary
Town Planning Board
15/F, North Point Government office
333 Java Road
North Point, Hong Kong

By Email

15 April 2024

Dear Sir,

2nd Further Information

Proposed Temporary Warehouse (Excluding Dangerous Goods Godown) with Ancillary Facilities for a Period of 3 Years and Associated Filling of Land and Pond in "Agriculture" Zone,

<u>Lot 1434 (Part) in D.D. 107, Kam Tin, Yuen Long, New Territories</u>

(S.16 Planning Application No. A/YL-KTN/979)

We are writing to submit further information to address departmental comments of the subject application (Appendix I).

Should you require more information regarding the application, please contact our Mr. Louis
TSE at or the undersigned at your convenience. Thank
you for your kind attention.

Yours faithfully,

For and on behalf of R-riches Property Consultants Limited

Matthew NG

Planning and Development Manager

cc DPO/FSYLE, PlanD

Responses-to-Comments

and Associated Filling of Land and Pond in "Agriculture" Zone, Lot 1434 (Part) in D.D. 107, Kam Tin, Yuen Long, New Territories Proposed Temporary Warehouse (Excluding Dangerous Goods Godown) with Ancillary Facilities for a Period of 3 Years

(Application No. A/YL-KTN/979)

(i) A RtoC Table:

(5)	(4)	(3)	(2)	(1)	. 1	
Please indicate clearly the full alignment of the discharge path from the application site all the way down to the ultimate discharge point (e.g. a well-established stream course/public drainage system).	The proposal should indicate how the runoff (the flow direction) within the site would be discharged to the proposed u-channel.	The cover and invert levels of all catchpits should be shown on the drainage plan.	Consideration should be given to provide catchpit at the turning points of the u-channel.	Please provide catchment plan for comment. The surface runoff from adjacent areas should be considered.	Comments of the Chief Engineer/Mainland North, Drainage Services Department (CE/MN, DSD) (Contact Person: Mr. Terence TANG; Tel.: 2300 1257)	Departmental Comments
Noted. The ultimate discharge point is the existing nullah near Shui Mei Road. Please refer to Appendix D and updated Figure 2 of the revised drainage proposal (Annex I).	Noted. Please refer to Figure 4 of the revised drainage proposal (Annex I).	Noted. Please refer to revised'Figure 3 of the revised drainage proposal (Annex I).	Noted. Please refer to revised Figure 3 of the revised drainage proposal (Annex I).	Noted Please refer to Figure 4 of the revised drainage proposal (Annex I).	artment (CE/MN, DSD)	Applicant's Responses



Noted. Corrugated sheet fence would be erected. 50mm dia. opening to be provided near ground level at 3m center to center spacing.	Please clarify whether any walls or hoarding would be erected along the site boundary. Where walls or hoarding are erected are laid along the site boundary, adequate opening should be provided to intercept the existing overland flow passing through the site.	(8)
Noted. Please refer to the calculation in Appendix A and site photos in Appendix D of the revised drainage proposal (Annex I). The utilization of existing drainage facilities is about 38%. It is anticipated that there is no significant drainage impact to existing drainage facilities.	The applicant should check and ensure the hydraulic capacity of the existing drainage facilities would not be adversely affected by the captioned development. Please provide site photos to show existing condition of the existing drainage facilities which receives the discharge from the application site, and demonstrate the existing drainage facilities have spare capacity to cater for the additional discharge from the proposed development.	(7)
There are existing drainage pipes/pits/channel along the village road. Drainage construction works could be made to the existing drainage pit for discharge from the application site. Please find site photos in Appendix D and proposed connection detail in updated Figure 3 of the revised drainage proposal for your perusal (Annex I).	The existing drainage facilities, to which the stormwater of the development from the subject site would discharge, are not maintained by this office. The applicant should identify the owner of the existing drainage facilities to which the proposed connection will be made. The applicant shall demonstrate that the proposed drainage construction / improvement / modification works and the operation of the drainage can be practicably implemented.	(6)

R-Riches
Property Consultants Ltd.

(14) Please provide relevant connection details of proposed manhole Noted. The proposed connection detail is shown in Figure 3 of the revised including the cover and invert levels. drainage proposal (Annex I).

Proposed Temporary Warehouse (Excluding Dangerous Goods Godown) with Ancillary Facilities for a Period of 3 Years and Associated Filling of Land and Pond in "Agriculture" Zone, Lot 1434 (part) in D.D. 107, Kam Tin, Yuen Long, New Territories

Drainage Appraisal

April 2024

		Drainage Appraisal

Table of Content	
1. Introduction	
1.1 Background	1
1.2 The Site	1
2. Development Proposal	2
2.1 The Proposed Development	2
3. Assessment Criteria	2
4. Proposed Drainage System	5
5. Conclusion	5

List of Table

Table 1 - Key Development Parameters2Table 2- Design Return Periods under SDM2

List of Figure

Figure 1 – Site Location Plan

Figure 2 - Existing Drainage Plan

Figure 3 - Proposed Drainage System

Figure 4 – Catchment Plan

List of Appendix

Appendix A - Design Calculation

Appendix B - Development Layout Plan

Appendix C – Reference Drawings for UChannel, Catchpit

Appendix D – Photos Record of Surrounding

Appendix E - Sections

1. Introduction

1.1 Background

- 1.1.1 The applicant seeks planning permission from the Town Planning Board (the Board) to use Lot 1434 (part) in D.D. 107, Kam Tin, Yuen Long, New Territories (the Site) for 'Proposed Temporary Warehouse (Excluding Dangerous Goods Godown) with Ancillary Facilities for a Period of 3 Years and Associated Filling of Land and Pond' (Proposed Development).
- 1.1.2 This Drainage Proposal is to support the planning application for the proposed use.

1.2 The Site

- 1.2.1 The Application Site area is about 498m², and it situates beside local tracks at the west, south and east. Those local track connect the site to Shui Mei Road in the South of the Proposed Development. The site is partly occupied by existing structures, abandoned dried pond and grassland.
- 1.2.2 The Application Site is surrounded by grassland, temporary structures and local track. It is generally flat with existing ground level of approx. +9.6 mPD and it is proposed to be filled up to +9.8 mPD after the Proposed Development.
- 1.2.3 The site location plan is shown in Figure 1.
- 1.2.4 Existing Drainage Plan is shown in Figure 2 for reference.
- 1.2.5 Proposed Development Layout plan is shown in Appendix B for reference.

2. Development Proposal

2.1 The Proposed Development

2.1.1 The total site area is approximately 498m². The indicative development schedule is summarized in Table 1 below for technical assessment purpose.

Proposed Development	
Total Site Area (m²)	498
Assume all proposed site area as paved area after development for assessment purpose (m²)	498

Table 1 - Key Development Parameters

3. Assessment Criteria

3.1.1 The Recommended Design Return Period based on Flood Level from SDM (Table 10) is adopted for this DIA. The recommendation is summarized in **Table 2** below.

Description	Design Return Periods
Intensively Used 'Agricultural Land	2 – 5 Years
Village Drainage Including Internal Drainage System under a polder Scheme	10 Years
Main Rural Catchment Drainage Channels	50 Years
Urban Drainage Trunk System	200 Years
Urban Drainage Branch System	50 Years

Table 2- Design Return Periods under SDM

3.1.2 The site to the east is generally higher. The proposed village drainage system intended to collect runoff from the internal site as well as from the external eastern area. It is proposed to be discharged to existing nearby public drainage system which would discharge to existing nullah at Shui Mei Road. 1 in 10 years return period is adopted for the drainage design. Catchments plan is shown in Figure 4.

- 3.1.3 Stormwater drainage design will be carried out in accordance with the criteria set out in the Stormwater Drainage Manual published by DSD. The proposed design criteria to be adopted for design of this stormwater drainage system and factors which have been considered are summarised below.
 - 1. Intensity-Duration-Frequency Relationship The Recommended Intensity-Duration-Frequency relationship is used to estimate the intensity of rainfall. It can be expressed by the following algebraic equation.

$$i = \frac{a}{(t_d + b)^c}$$

The site is located within the HKO Headquarters Rainfall Zone. Therefore, for 10 years return period, the following values are adopted.

a =
$$471.9$$

b = 3.02
c = 0.397

2. The peak runoff is calculated by the Rational Method i.e. $Q_p = 0.278CiA$

where Q_p = peak runoff in m³/s
C = runoff coefficient (dimensionless)
i = rainfall intensity in mm/hr
A = catchment area in km²

3. The run-off coefficient (C) of surface runoff are taken as follows:

Paved Area:

C = 0.95

Unpaved Area:

C = 0.35

4. Manning's Equation is used for calculation of velocity of flow inside the channels:

Manning's Equation:
$$v = \frac{R^{\frac{1}{6}}}{n} R^{\frac{1}{2}} S_f^{\frac{1}{2}}$$

Where,

V = velocity of the pipe flow (m/s)

S_f = hydraulic gradient

n = manning's coefficient

R = hydraulic radius (m)

5. Colebrook-White Equation is used for calculation of velocity of flow inside the pipes:

$$\underline{v} = -\sqrt{32gRS} \log \log \left(\frac{k_s}{14.8R} + \frac{1.255v}{R\sqrt{32gRS_f}} \right)$$

where,

V = velocity of the pipe flow (m/s)

 S_f = hydraulic gradient k_f = roughness value (m)

v = kinematics viscosity of fluid

D = pipe diameter (m) R = hydraulic radius (m)

4. Proposed Drainage System


- 4.1.1 A drainage system is proposed to collect the runoff from the application site as well as runoff from the eastern site. It is proposed to be discharged to the existing drainage system under the local tracks at the south. The alignment, size and gradient of the proposed drains are shown in **Figure** 3
- 4.1.2 The design calculations of proposed channels and checking of existing drains are shown in **Appendix A**.
- 4.1.3 The reference drawings of proposed drains are shown in Appendix C.


5. Conclusion


- 5.1.1 A drainage appraisal has been conducted for the Proposed Development. The surface runoff from the Application Site and runoff from eastern area will be collected by the proposed perimeter Uchannel/drains and discharged to the existing drainage system under the southern local track.
- 5.1.2 The utilization of existing drain is approx.. 38% only.
- 5.1.3 With the proposed drainage system, it is anticipated that there will be no significant drainage impact to the area after the implementation of the development.


End of text -

FIGURES

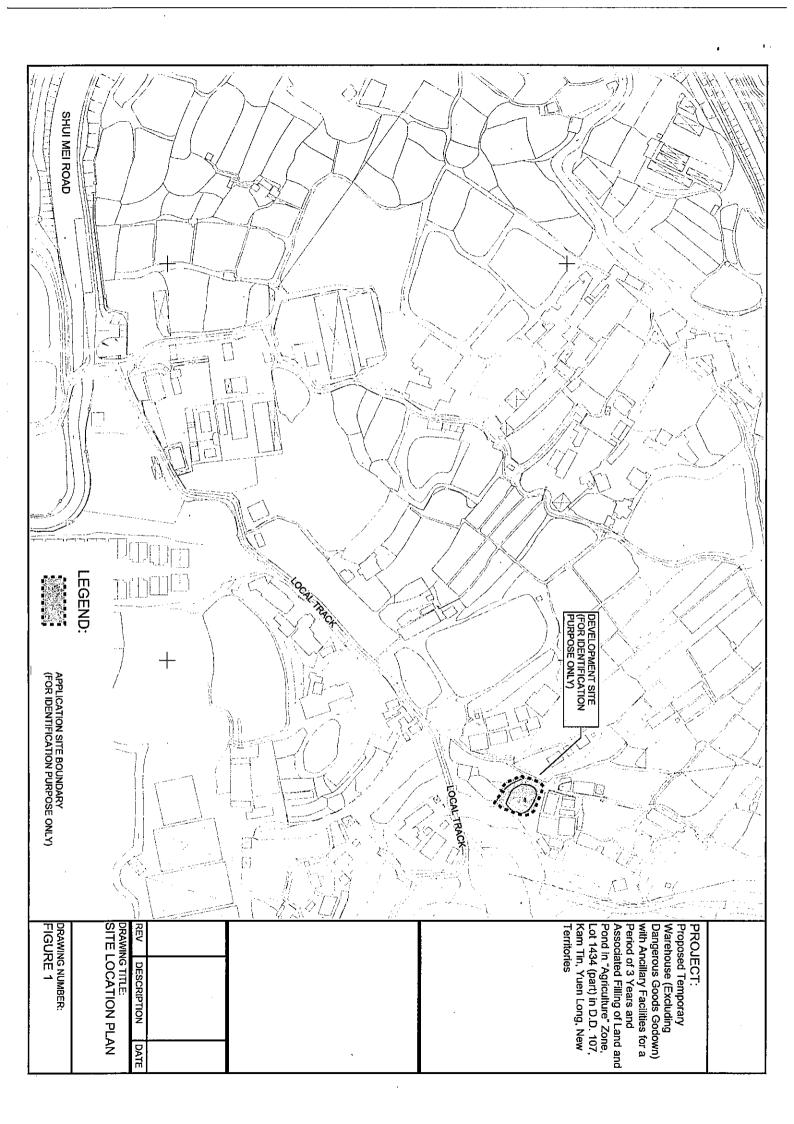

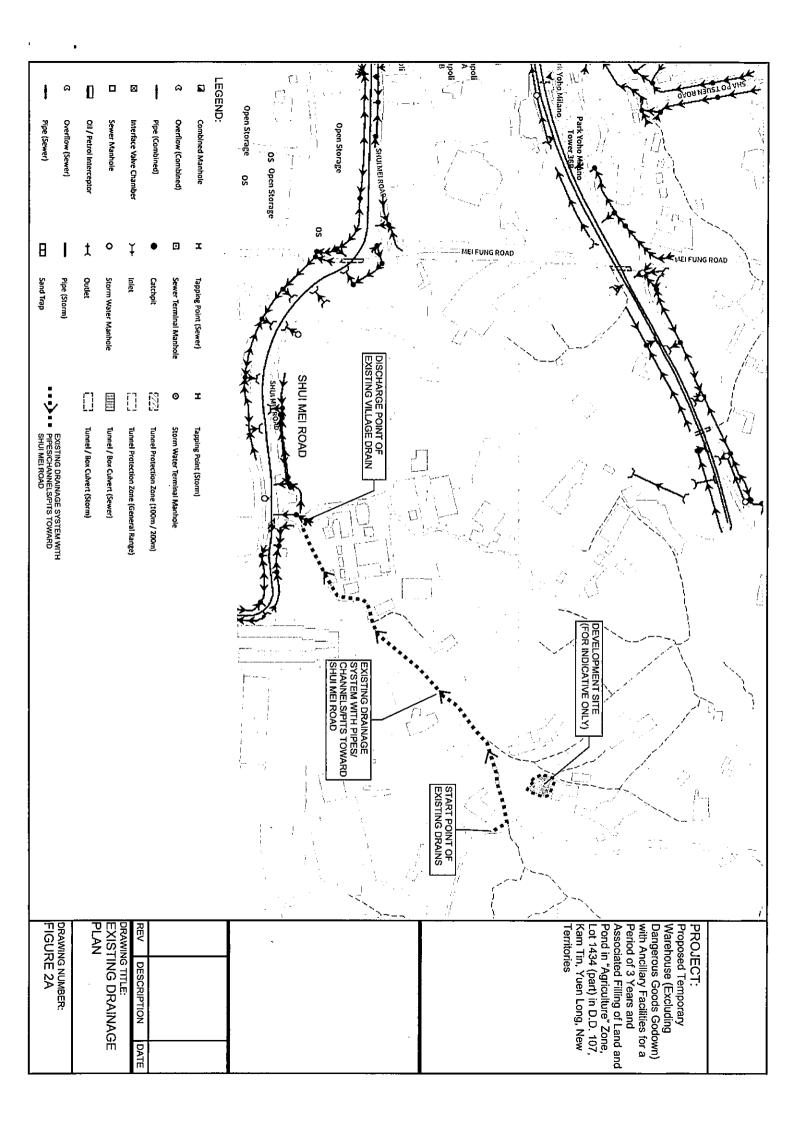

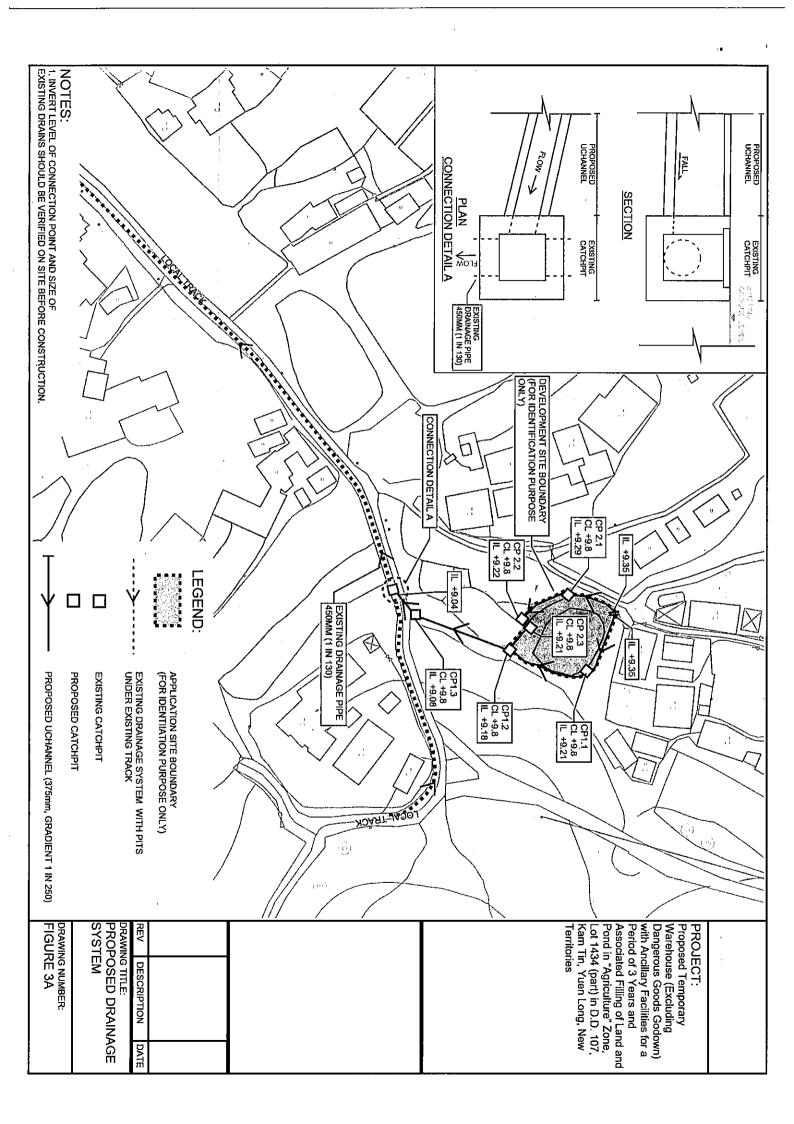

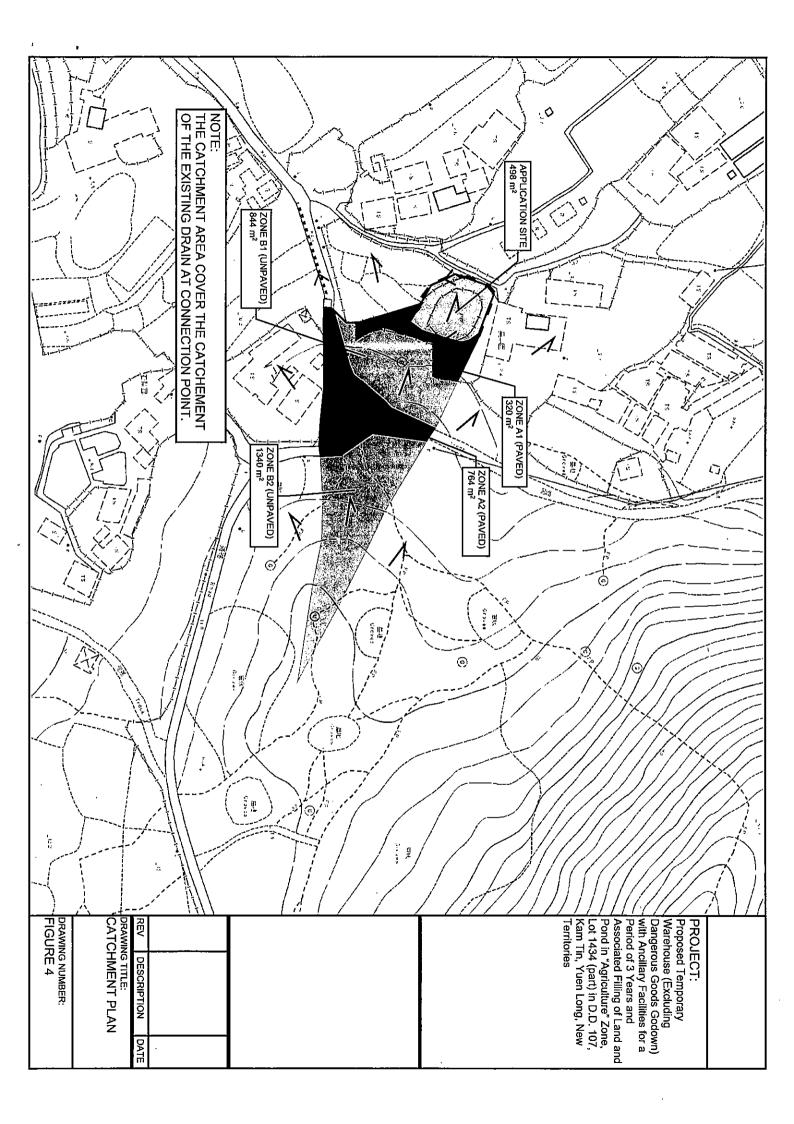

Appendix

Appendix A - Design Calculation

U Channel - Site Area + Zone A1 + A2 + B1 + B2

Runoff Estimation			
Design Return Period	1 in	10	years
Paved Area		1556	(m2)
Unpaved Area		2183	(m2)
Total Equivalent Area		2242	(m2)
Rainfall Intensity, J **		200	mm/h
Design Discharge Rate, Q***		0.125	m3/s

(498+320+738) (1340+843)

*** Q = 0.278 x 2242 x 200 / 1000000

U Channel	
Channel Size	375 (mm)
Gradient	1 in 250
Velocity	1.16 m/s
Capacity	0,146 m3/s

0.125 / 0.146 = 85.78 % < 90 % (10% allow for sittation) Utilization

Checking of Existing 450mm Drain Pipe at Local Village Road

Runoff Estimation		
Design Return Period	1 in 10	years
Paved Area*	1556	m2
Unpaved Area*	2183	m2
Total Equivalent Area	2242	m2
Rainfall Intensity	200	mm/br
Design Discharge Rate	0.125	m3/s


mm Drain Pipe		
	450	mm
1 in	130	
	2.06	m/s
	0.328	m3/s
		450 1 in 130 2.06

<90% Utilization **= 38.10 %**


(existing gradient is approx 1 in 125, use 1 in 130 for checking)


Time of Concentration

Catchment	Flow Distance	Highest Level		Gradient (per 100m) = (H1-H2)/L x 100	to (min) = 0.14465L/ (H ^{0.2} A ^{0.1})	tc = to + tf
Α	, L ,			H		
(m2)	(m)	(mPD)	(mPD)		(min)	(min)
3739	135	21	9.8	8.296	5.618	5,618

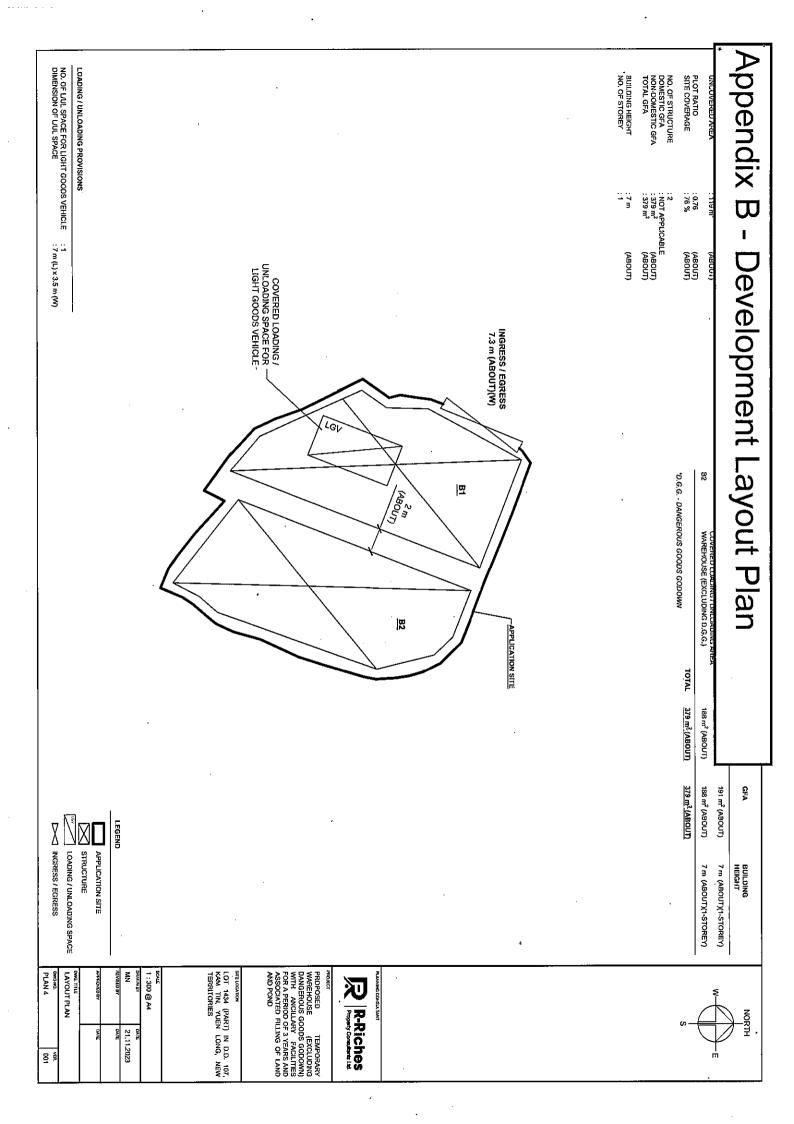

Appendix C - Reference Drawings

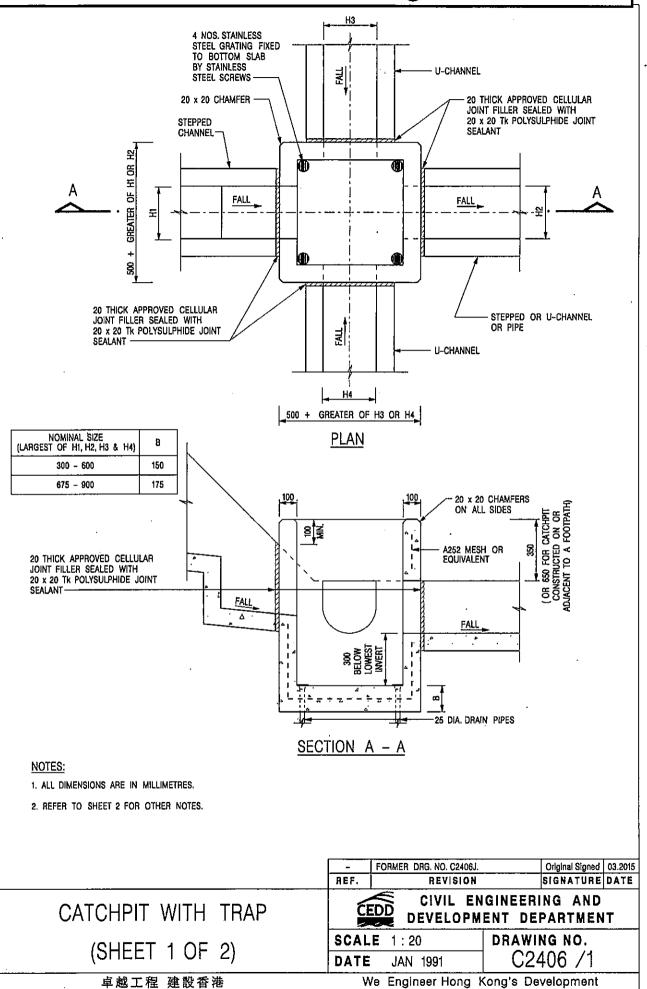

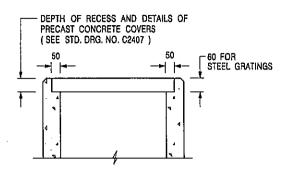

ALTERNATIVE TOP SECTION FOR PRECAST CONCRETE COVERS / GRATINGS

NOTES:

- 1. ALL DIMENSIONS ARE IN MILLIMETRES.
- 2. ALL CONCRETE SHALL BE GRADE 20 /20.
- 3. CONCRETE SURFACE FINISH SHALL BE CLASS U2 OR F2 AS APPROPRIATE.
- 4. FOR DETAILS OF JOINT, REFER TO STD. DRG. NO. C2413.
- 5. CONCRETE TO BE COLOURED AS SPECIFIED.
- UNLESS REQUESTED BY THE MAINTENANCE PARTY AND AS DIRECTED BY THE ENGINEER, CATCHPIT WITH TRAP IS NORMALLY NOT PREFERRED DUE TO PONDING PROBLEM.
- 7. UPON THE REQUEST FROM MAINTENANCE PARTY, DRAIN PIPES AT CATCHPIT BASE CAN BE USED BUT THIS IS FOR CATCHPITS LOCATED AT SLOPE TOE ONLY AND AS DIRECTED BY THE ENGINEER.
- 8. FOR CATCHPITS CONSTRUCTED ON OR ADJACENT TO A FOOTPATH, STEEL GRATINGS (SEE DETAIL 'A' ON STD. DRG. NO. C2405 /2) OR CONCRETE COVERS (SEE STD. DRG. NO. C2407) SHALL BE PROVIDED AS DIRECTED BY THE ENGINEER.
- 9. IF INSTRUCTED BY THE ENGINEER, HANDRAILING (SEE DETAIL 'J' ON STD. DRG. NO. C2405 /5; EXCEPT ON THE UPSLOPE SIDE) IN LIEU OF STEEL GRATINGS OR CONCRETE COVERS CAN BE ACCEPTED AS AN ALTERNATIVE SAFETY MEASURE FOR CATCHPITS NOT ON A FOOTPATH NOR ADJACENT TO IT. TOP OF THE HANDRAILING SHALL BE 1 000 mm MIN. MEASURED FROM THE ADJACENT GROUND LEVEL.
- 10. MINIMUM INTERNAL CATCHPIT WIDTH SHALL BE 1 000 mm FOR CATCHPITS WITH A HEIGHT EXCEEDING 1 000 mm MEASURED FROM THE INVERT LEVEL TO THE ADJACENT GROUND LEVEL. AND, STEP IRONS (SEE DSD STD, DRG. NO. DS1043) AT 300 c/c STAGGERED SHALL BE PROVIDED. THICKNESS OF CATCHPIT WALL FOR INSTALLATION OF STEP IRONS SHALL BE INCREASED TO 150 mm.
- FOR RETROFITING AN EXISTING CATCHPIT WITH STEEL GRATING, SEE DETAIL 'G' ON STD. DRG. NO. C2405 /4.
- SUBJECT TO THE APPROVAL OF THE ENGINEER, OTHER MATERIALS CAN ALSO BE USED AS COVERS / GRATINGS.

REF.	REVISION	SIGNATURE	DATE
-	FORMER DRG. NO. C2406J.	Original Signed	03.2015
A	MINOR AMENDMENT.	Original Signed	04.2016

CATCHPIT WITH TRAP (SHEET 2 OF 2)


卓越工程 建設香港

CEDD

CIVIL ENGINEERING AND DEVELOPMENT DEPARTMENT

SCALE 1:20 **DATE** JAN 1991

drawing no. C2406 /2A

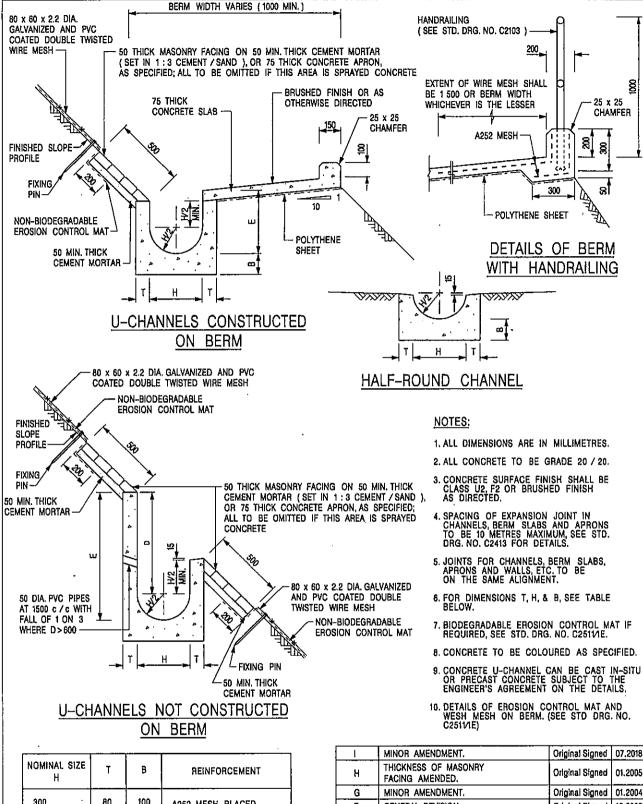

NOMINAL SIZE H	Т	В	REINFORCEMENT
300	80	100	A252 MESH PLACED CENTRALLY AND T=100
375 ~ 600	100	150	WHEN E>650
675 - 900	125	175	A252 MESH PLACED CENTRALLY

l	MINOR AMENDMENT.	Original Signed	07.2018
Н	THICKNESS OF MASONRY FACING AMENDED.	Original Signed	01.2005
G	MINOR AMENDMENT.	Original Signed	01.2004
F	GENERAL REVISION.	Orlginal Signed	12.2002
Ε	DRAWING TITLE AMENDED.	Orlginal Signed	11.2001
D	MINOR AMENDMENT.	Orlginal Signed	08.2001
С	150 x 100 UPSTAND ADDED AT BERM.	Original Signed	6.99
В	MINÒR AMENDMENTS.	Original Signed	3.94
REF.	REVISION	SIGNATURE	DATE

DETAILS OF HALF-ROUND AND U-CHANNELS (TYPE A -WITH MASONRY APRON)


卓越工程 建設香港

CEDD

CIVIL ENGINEERING AND DEVELOPMENT DEPARTMENT


 SCALE 1:25
 DRAWING NO.

 DATE JAN 1991
 C24091

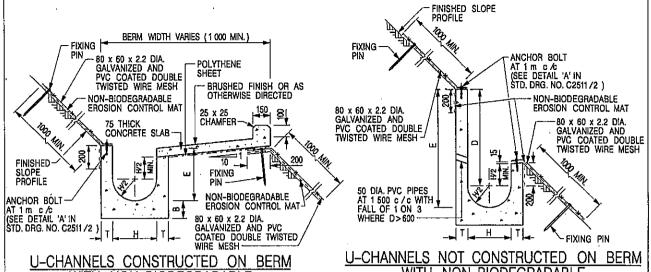

<u> WITH NON-BIODEGRADABLE</u> EROSION CONTROL MAT

WITH NON-BIODEGRADABLE EROSION CONTROL MAT

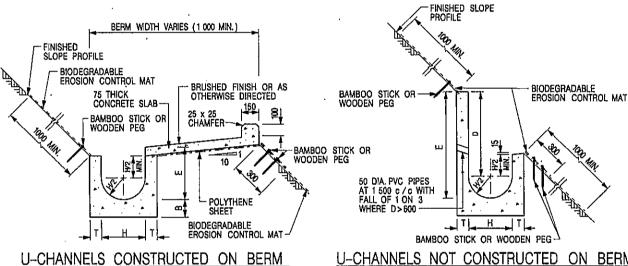

NOTES:

- 1. ALL DIMENSIONS ARE IN MILLIMETRES.
- 2. ALL CONCRETE TO BE GRADE 20 /20.
- 3. CONCRETE SURFACE FINISH SHALL BE CLASS U2, F2 OR BRUSHED FINISH AS DIRECTED.
- SPACING OF EXPANSION JOINT IN CHANNELS, BERM SLABS AND APRONS TO BE 10 METRES MAXIMUM, SEE STD. DRG. NO. C2413 FOR DETAILS.
- JOINTS FOR CHANNELS, BERM SLABS, APRONS AND WALLS, ETC. TO BE ON THE SAME ALIGNMENT.
- 6. FOR DIMENSIONS T, H, & B, SEE TABLE BELOW.
- 7. FOR TYPICAL FIXING PIN DETAILS, SEE STD. DRG. NO. C2511/2.
- 8. MINIMUM SIZE OF 25 x 50 x 300mm SHALL BE PROVIDED FOR WOODEN PEG.
- U-CHANNELS NOT CONSTRUCTED ON BERM WITH BIODEGRADABLE EROSION CONTROL MAT
 - MINIMUM SIZE OF 10mm DIAMETER WITH 200mm LONG SHALL BE PROVIDED FOR BAMBOO STICK.
 - 10. THE FIXING DETAILS OF NON-BIODEGRADABLE AND BIODEGRADABLE EROSION CONTROL MATS ON EXISTING BERM SHALL REFER TO STD. DRG. NO. C2511/1.

NOMINAL SIZE	Т	В	REINFORCEMENT
300	80	100	A252 MESH PLACED CENTRALLY AND T=100
375 - 60Ó	100	150	WHEN E>650
675 - 900	125	175	A252 MESH PLACED CENTRALLY

WITH BIODEGRADABLE

EROSION CONTROL MAT

DETAILS OF HALF-ROUND AND U-CHANNELS (TYPE B - WITH EROSION CONTROL MAT APRON)

虛	ĦΣ	丁程	建	铅	吞	排


REF.	REVISION	SIGNATURE	DATE
A	MINOR AMENDMENT.	Original Signed	10.92
8	MINOR AMENDMENT.	Original Signed	3.94
С	150 x 100 UPSTAND ADDED AT BERM.	Original Signed	6.99
D	MINOR AMENDMENT.	Original Signed	08.2001
E	GENERAL REVISION.	Original Signed	12.2002
F	MINOR AMENDMENT.	Original Signed	01.2004
G	DIMENSION TABLE AMENDED.	Original Signed	01.2005
н	FIXING DETAILS OF BIODEGRADABLE EROSION CONTROL MAT ADDED.	Original Signed	12.2017
	MINOR AMENDMENT.	Original Signed	07.2018




CIVIL ENGINEERING AND DEVELOPMENT DEPARTMENT

SCALE DIAGRAMMATIC DATE JAN 1991

DRAWING NO. C2410I

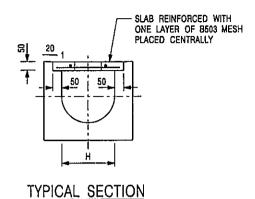


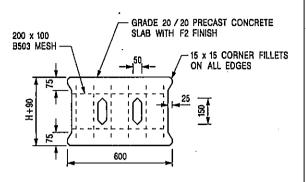


PLAN OF SLAB

U-CHANNELS WITH PRECAST CONCRETE SLABS

(UP TO H OF 525)

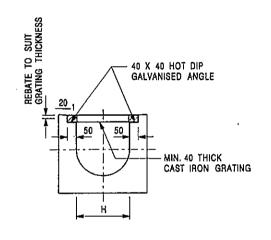

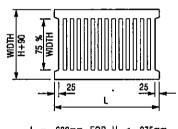

L = 600mm FOR H ≤ 375mm L = 400mm FOR H > 375mm

TYPICAL SECTION

CAST IRON GRATING

(DIMENSIONS ARE FOR GUIDANCE ONLY, CONTRACTOR MAY SUBMIT EQUIVALENT TYPE)

U-CHANNEL WITH CAST IRON GRATING

(UP TO H OF 525)

NOTES:

- 1. ALL DIMENSIONS ARE IN MILLIMETRES.
- 2. H=NOMINAL CHANNEL SIZE.
- 3. ALL CAST IRON FOR GRATINGS SHALL BE GRADE EN-GJL-150 COMPLYING WITH BS EN 1561.
- 4. FOR COVERED CHANNELS TO BE HANDED OVER TO HIGHWAYS DEPARTMENT FOR MAINTENANCE, THE GRATING DETAILS SHALL FOLLOW THOSE AS SHOWN ON HyD STD. DRG. NO. H3156.

A REF.	REVISION	SIGNATURE	
A	CAST IRON GRATING AMENDED.	Original Signed	12 2002
В	NAME OF DEPARTMENT AMENDED.	Original Signed	01.2005
С	MINOR AMENDMENT. NOTE 3 ADDED.	Original Signed	12.2005
D	NOTE 4 ADDED.	Original Signed	06.2008
E	NOTES 3 & 4 AMENDED.	Original Signed	

COVER SLAB AND CAST IRON GRATING FOR CHANNELS

CEDD


CIVIL ENGINEERING AND DEVELOPMENT DEPARTMENT


 SCALE 1:20
 DRAWING NO.

 DATE JAN 1991
 C2412E

卓越工程 建設香港

We Engineer Hong Kong's Development

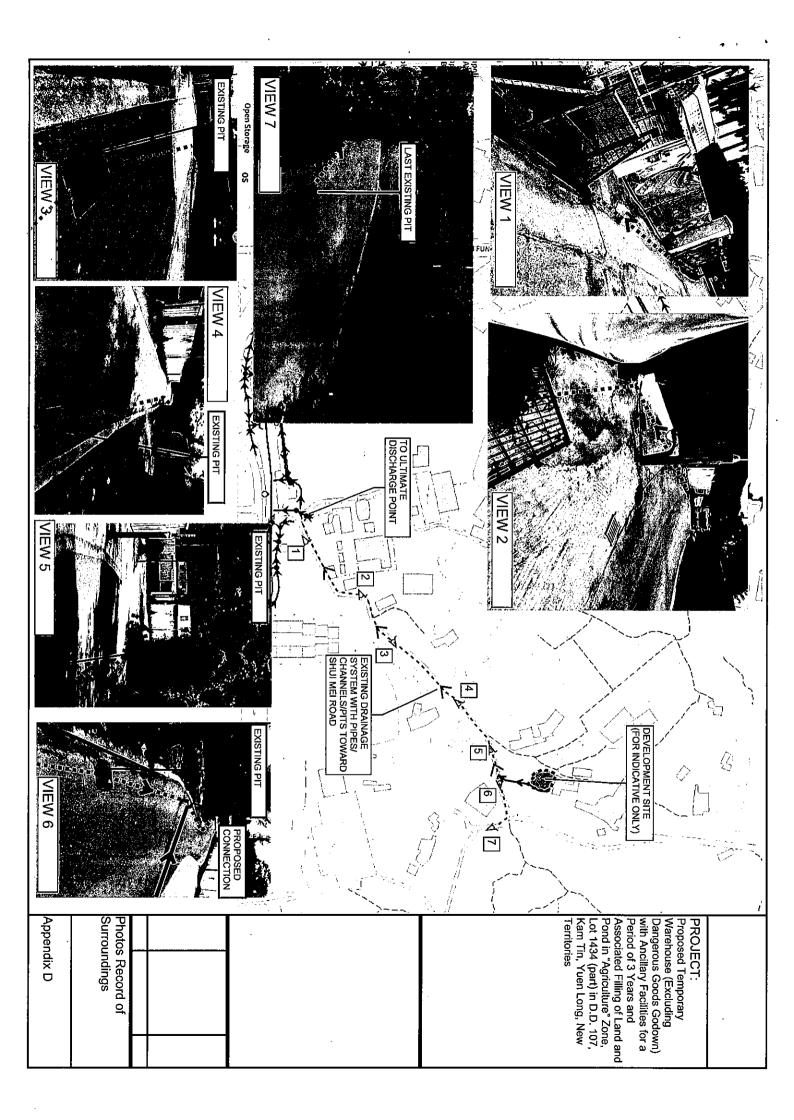

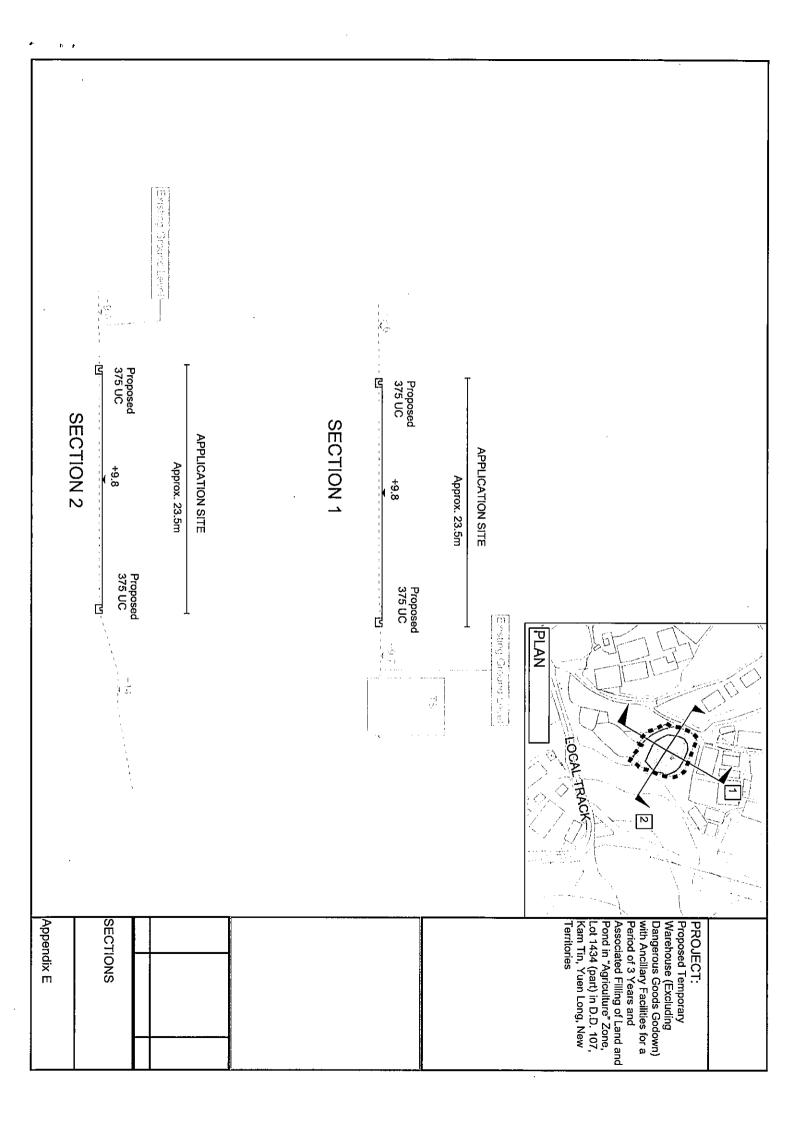



Our Ref.

: DD107 Lot 1434

Your Ref.

: TPB/A/YL-KTN/979

The Secretary **Town Planning Board** 15/F, North Point Government Offices 333 Java Road North Point, Hong Kong

뱸

Appendix Ic of RNTPC Paper No. A/YL-KTN/979B

By Email

22 April 2024

Dear Sir,

3rd Further Information

Proposed Temporary Warehouse (Excluding Dangerous Goods Godown) with Ancillary Facilities for a Period of 3 Years and Associated Filling of Land and Pond in "Agriculture" Zone, Lot 1434 (Part) in D.D. 107, Kam Tin, Yuen Long, New Territories

(S.16 Planning Application No. A/YL-KTN/979)

We are writing to submit further information to provide clarifications of the subject application, details are as follows:

- A replacement page of application form (Appendix I).
- (ii) A revised plan showing the filling of land and pond of the application site (Plan 1).

Should you require more information regarding the application, please contact our Ms. Ron LEUNG at or the undersigned at your convenience. Your kind attention to the matter is much appreciated.

Yours faithfully,

For and on behalf of

R-riches Property Consultants Limited

Louis TSE Town Planner

cc DPO/FSYLE, PlanD

(Attn.: Ms. Andrea YAN

(Attn.: Ms. Olivia NG


).

)

(i)	Gross floor area		sq.r	n 平方米	Plot R	atio 地積比率
	and/or plot ratio 總樓面面積及/或 地積比率	Domestic 住用	N/A	□ About 約 □ Not more than 不多於	N/A	□About 約 □Not more than 不多於
		Non-domestic 非住用	379	☑ About 約 □ Not more than 不多於	0.76	☑About 約 □Not more than 不多於
(ii)	No. of blocks 幢數	Domestic 住用		N/A		
		Non-domestic 非住用		2		
(iii)	Building height/No. of storeys 建築物高度/層數	Domestic 住用		N/A	□ (Not	m 米 more than 不多於)
		,		N/A	□ (Not	Storeys(s) 層 more than 不多於)
		Non-domestic 非住用		7 (about)	□ (Not	m 米 more than 不多於)
				1	□ (Not	Storeys(s) 層 more than 不多於)
(iv)	Site coverage 上蓋面積		76	·	%	☑ About 約
(v)	No. of parking spaces and loading / unloading spaces 停車位及上落客貨車位數目	Medium Goods Veravy Goods Veravy Goods Veravy Goods Verave Others (Please Spanish Total no. of vehicle 上落客貨車位/	ng Spaces 私家ng Spaces 電写icle Parking Spaces 管理Vehicle Parking Spaceify) 其他(interpretable parking Spaceify)其他(interpretable parking)	R車車位 單車車位 Paces 輕型貨車泊車 Spaces 中型貨車注 paces 重型貨車泊車 請列明)	車位	N/A
		Taxi Spaces 的出 Coach Spaces 旅 Light Goods Veh Medium Goods Veh Heavy Goods Veh Others (Please Sp	遊巴車位 icle Spaces 輕 'ehicle Spaces hicle Spaces 重	中型貨車位 型貨車車位	:	1 (LGV)

APPLICATION SITE BEFORE FILLING OF LAND AND POND	ND AND POND	
APPLICATION SITE AREA	: 498 m²	(ABOU
SITE LEVELS BEFORE FILLING OF LAND AREA OF THE EXISTING DRIED FOND DEPTH OF EXISTING DRIED POND	: +9.6 mPD : 248 m² : 1 m	(ABOU (ABOU (ABOU

1	6	Ę.	£	E		
AND AND POINT	: 498 m² (ABOUT)		: 248 m² (ABOU		•	

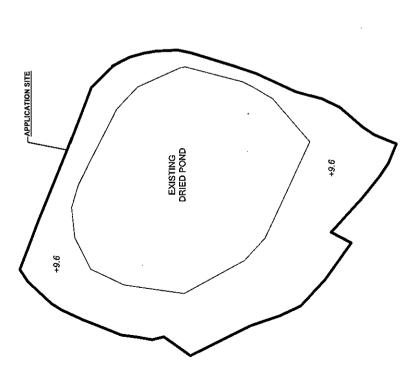

EXISTING FILLING OF LAND AND POND AREA

APPLICATION SITE AREA COVERED BY STRUCTURE	: 379 m² (ABOUT)
EXISTING LAND FILLING AREA DEPTH OF LAND FILLING STEELEVELS	: 498 m² : NOT MORE THAN 0.2 m : +9.8 mPD (ABOUT)
USE	SITE FORMATION OF STRUCTURES,

AND CIRCULATION SPACE

"THE POND FILLING AREA IS INCLUDED IN THE CALCULATION OF LAND FILLING AREA. (ABOUT) : 248 m² : CONCRETE EXISTING POND FILLING AREA MATERIAL OF FILLING

-APPLICATION SITE

+0.8 1

+9.8



R-Riches

PROPOSED TEMPORARY
WAREHOUSE (EXCLUDING
DANGEROUS GOODS GODOWN)
WITH ANCILLARY FACILITIES
FOR A PERIOD OF 3 YEARS AND
ASSCIATED FILLING OF 1AND
AND POND

STELOCATION			
LOT 1434	(PART)	N.	101
KAM TIN YUEN LONG.	YUEN	LONG,	ě
TERRITORIES	ES		

49.8

SCALE	
1:300 @ A4	
DRAWN BY	DATE
MN	23.11,2023
REVISED BY	DATE
1	22.04.2024
APPROVED BY	DATE

CHANNA BY	DATE
N.	23.11,2023
REVISED BY	DATE
רב	22.04.2024
APPROVED BY	ÖATE
DWG. TITLE	

	REVISED BY	DATE	
	11	22.04.202	205
	AP CONCROVED	owte	
<u> </u>			ı
	DWG. TITLE		
គ្គ	FILLING OF LAND AND PON	AND P	õ
	DWD MO.		NER.
	PLAN1		8

WN	REVISED BY	1	APPROVED BY		DWC. TITLE	FILLING OF LAND	DWG HO,
				CATION SITE	1	FILLING AREA	į

LEGEND

APPLICATION SITE	LAND FILLING ARE	SITE LEVEL
		+9.8

A3.4 SITE LEVEL

SITE LEVELS ARE FOR REFERENCE ONLY.

LEGEND

APPLICATION SITE	LAND FILLING ARE	STELEVEL
		+9.8

DAG. TITLE	FILLING OF LAND AN	DMG NO. PLAN 1
	FILLING AREA	LEVEL

4, 1 3 74

Appendix Id of RNTPC Paper No. A/YL-KT/979B

問有限公司

Our Ref.

: DD107 Lot 1434

Your Ref.

: TPB/A/YL-KTN/979

The Secretary
Town Planning Board
15/F, North Point Government Offices
333 Java Road
North Point, Hong Kong

By Email

16 May 2024

Dear Sir,

4th Further Information

Proposed Temporary Warehouse (Excluding Dangerous Goods Godown) with Ancillary Facilities for a Period of 3 Years and Associated Filling of Land and Pond in "Agriculture" Zone,

<u>Lot 1434 (Part) in D.D. 107, Kam Tin, Yuen Long, New Territories</u>

(S.16 Planning Application No. A/YL-KTN/979)

We are writing to submit further information to address departmental comments of the subject application (**Appendix I**). The current submission is intended to facilitate an earlier meeting for the Town Planning Board's consideration.

Should you require more information regarding the application, please contact our Ms. Ron LEUNG at or the undersigned at your convenience. Your kind attention to the matter is much appreciated.

Yours faithfully,

For and on behalf of

R-riches Property Consultants Limited

Louis TSE
Town Planner

cc DPO/FSYLE, PlanD

(Attn.: Ms. Andrea YAN

(Attn.: Ms. Olivia NG

email:

email:

Responses-to-Comments

and Associated Filling of Land and Pond in "Agriculture" Zone, Lot 1434 (Part) in D.D. 107, Kam Tin, Yuen Long, New Territories Proposed Temporary Warehouse (Excluding Dangerous Goods Godown) with Ancillary Facilities for a Period of 3 Years

(Application No. A/YL-KTN/979)

(i) A RtoC Table:

	Departmental Comments		Applicant's Responses
- i	 Comments of the Chief Engineer/Mainland North, Drainage Services Department (CE/MN, DSD) (Contact Person: Mr. Terence TANG; Tel.: 2300 1257) 	artment (CE/MN, D	(as
(1)	Appendix A: Please clarify how does the tota	Noted. Please refe	r to the updated Appendix A of Annex I. As presented
	ent to be adopted shou	in report section 3.	Ild be well justified and in report section 3.1.3, the runoff coefficient for paved area and unpaved
	provided for comment.	area are 0.95 and 0	area are 0.95 and 0.35 respectively for your perusal.
(2)	Appendix A: Please justify the proposed rainfall intensity.	Noted. Please refer	Noted. Please refer to updated Appendix A of Annex I.
		$i = \frac{a}{(t_d + b)^c}$	
		Where	
		II W	471.9
		= q	3.02
		II O	0.397
		as per Table 3a of S	as per Table 3a of SDM (1 in 10 year for HKO rainfall zone)

(3)	Appendix A: For 375UC, please review the proposed gradient as it is considered too flat.	Please note the velocity of flow = 1.16 m/s is larger than 1.0 m/s and therefore the gradient is considered sufficient.
(4)	Response item 8: The proposed 50mm dia. opening is not acceptable. Adequate opening means at least 100mm separation should be provided from ground level.	Noted. 100mm dia. opening would be provided with 100mm separation from ground level.
(2)	Cross sections: The proposed u-channels cannot intercept the overland flow from adjacent areas, please review and revise.	Please note the u-channel cover level is updated for intercept of overland flow.
(9)	The details of existing manhole to be connected with are still missing.	Noted. Please refer to the cover and invert level of existing manhole in Figure 3 for your reference. Please note there is no more proposed manhole in the revised proposal as compare to the original proposal.



Appendix A - Design Calculation

U Channel - Site Area + Zone A1 + A2 + B1 + B2


Runoff Estimation				-
Design Return Period		1 in	10	years
Paved Area			1556	(m2)
Unpaved Area			2183	(m2)
Total Equivalent Area	ļ		2242	(m2)
Rainfall Intensity, I **	l .		200	mm/hr
Design Discharge Rate, Q***			0.125	m3/s


U Channel		
Channel Size	375	(mm)
Gradient	1 in : 250	
Velocity	1.16	m/s
Capacity	0.146	m3/s

0.125 / 0.146 = 85.78 %

Utilization

90 % (10% allow for siltation)

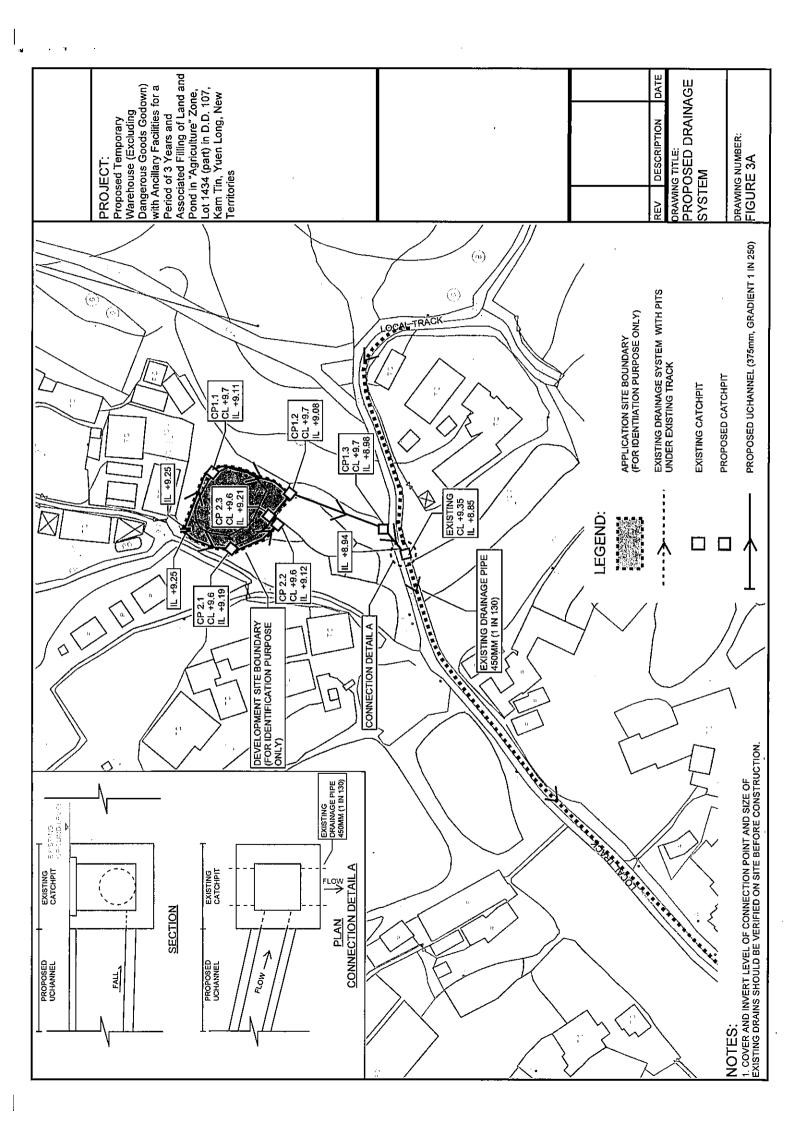

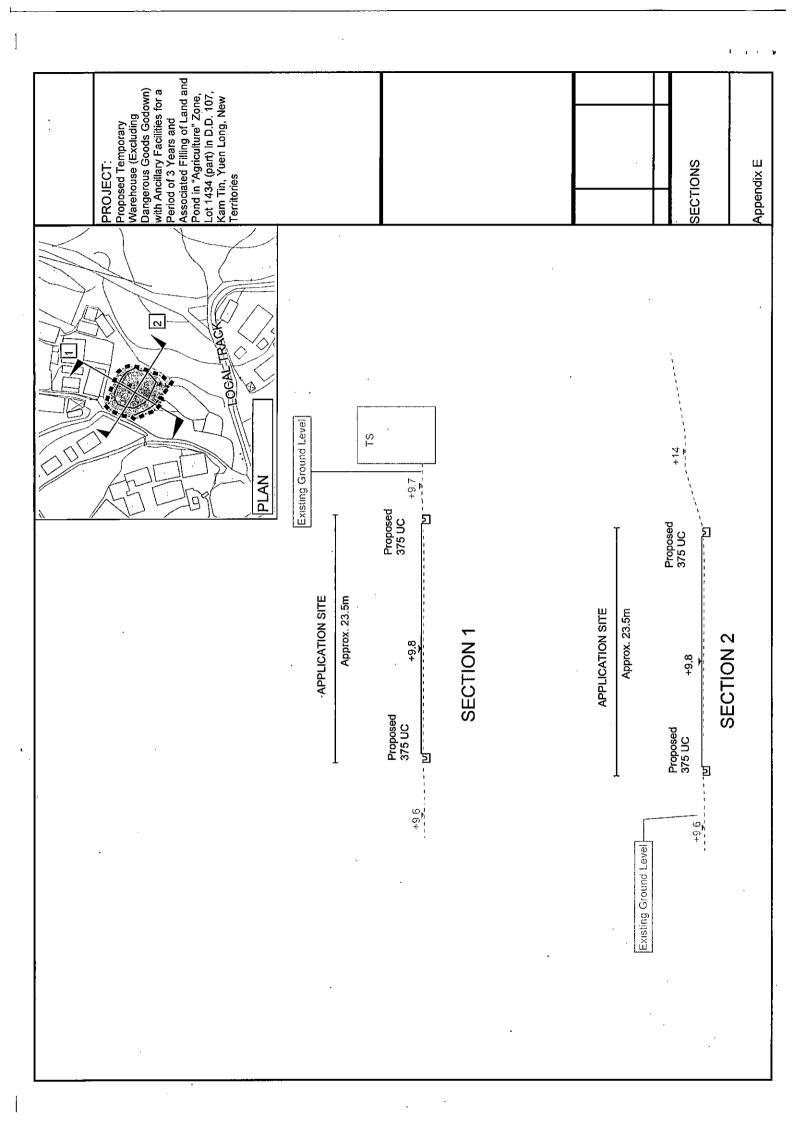



Appendix Ie of RNTPC
Paper No. A/YL-KTN/979B

問有限公司

Our Ref.

: DD107 Lot 1434

Your Ref.

: TPB/A/YL-KTN/979

The Secretary,
Town Planning Board,
15/F, North Point Government Offices,
333 Java Road,
North Point, Hong Kong

By Email

31 May 2024

Dear Sir,

5th Further Information

Proposed Temporary Warehouse (Excluding Dangerous Goods Godown) with Ancillary Facilities for a Period of 3 Years and Associated Filling of Land and Pond in "Agriculture" Zone,

<u>Lot 1434 (Part) in D.D. 107</u>, Kam Tin, Yuen Long, New Territories

(S.16 Planning Application No. A/YL-KTN/979)

We are writing to submit further information to address departmental comments of the subject application (Appendix I).

Should you require more information regarding the application, please contact our Mr. Louis TSE at or the undersigned at your convenience.

Your kind attention to the matter is much appreciated.

Yours faithfully,

For and on behalf of R-riches Property Consultants Limited

A (1) 1

Matthew NG

Planning and Development Manager

cc DPO/FSYLE, PlanD

(Attn.: Ms. Andrea YAN

(Attn.: Ms. Olivia NG

email:

email:


)

Responses-to-Comments

and Associated Filling of Land and Pond in "Agriculture" Zone, Lot 1434 (Part) in D.D. 107, Kam Tin, Yuen Long, New Territories Proposed Temporary Warehouse (Excluding Dangerous Goods Godown) with Ancillary Facilities for a Period of 3 Years

(Application No. A/YL-KTN/979)

(i) A RtoC Table:

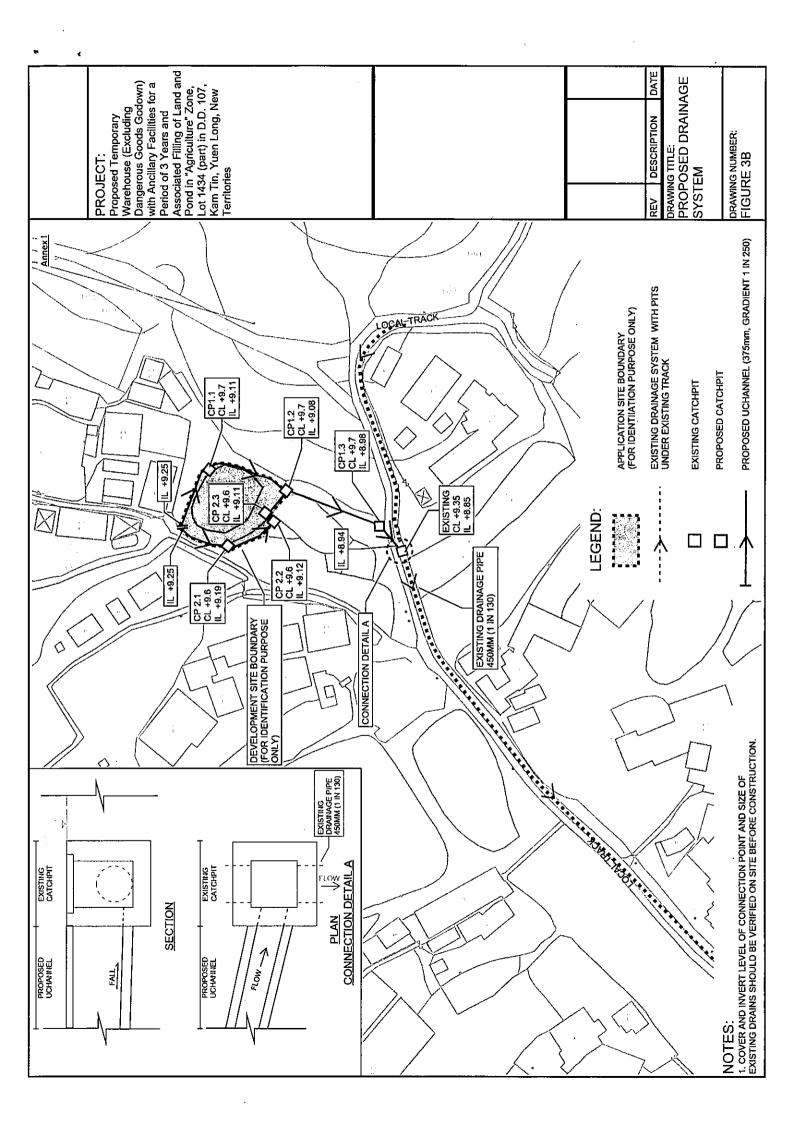

1

Similar s.16 Applications in the Vicinity of the Site within the same "AGR" Zone in the Past 5 Years

Approved Applications

	Application No.	Use/Development	Date of Consideration
1.	A/YL-KTN/824	Proposed Temporary Warehouse	6.5.2022
	,	(excluding Dangerous Goods Godown)	[revoked on 6.2.2024]
		for a Period of 3 Years and Filling of Land	
2.	A/YL-KTN/852	Proposed Temporary Warehouse	23.9.2022
		(excluding Dangerous Goods Godown)	[revoked on 23.3.2024]
		for a Period of 3 Years and Filling of Land	
3.	A/YL-KTN/890	Proposed Temporary Warehouse	31.3.2023
		(excluding Dangerous Goods Godown)	
		for a Period of 3 Years and Filling of Land	
4.	A/YL-KTN/898	Proposed Temporary Warehouse	21.4.2023
		(excluding Dangerous Goods Godown)	[revoked on 21.1.2024]
		for a Period of 3 Years and Filling of Land	
5.	A/YL-KTN/904	Proposed Temporary Warehouse	19.5.2023
		(excluding Dangerous Goods Godown)	
		with Ancillary Facilities for a Period of 3	
		Years and Filling of Land	
6.	A/YL-KTN/905	Proposed Temporary Warehouse	19.5.2023
		(excluding Dangerous Goods Godown)	
		for a Period of 3 Years and Filling of Land	
7.	A/YL-KTN/907	Proposed Temporary Warehouse	13.10.2023
		(excluding Dangerous Goods Godown)	
	,	with Ancillary Facilities for a Period of 3	
	4 /TTT TTTT 1/200	Years and Filling of Land	20.77.202
8.	A/YL-KTN/920	Proposed Temporary Warehouse	28.7.2023
		(excluding Dangerous Goods Godown)	
		with Ancillary Facilities for a Period of 3	
	A /SZT TZTD I /OOT	Years and Filling of Land	05.0.000
9.	A/YL-KTN/937	Proposed Temporary Warehouse	25.8.2023
		(excluding Dangerous Goods Godown)	
		with Ancillary Facilities for a Period of 3	
10	A/YL-KTN/938	Years and Filling of Land Proposed Temporary Warehouse	25 8 2022
10.	A/ 1 L-K 1 N/938	1	25.8.2023
		(excluding Dangerous Goods Godown)	
		with Ancillary Facilities for a Period of 3	
		Years and Filling of Land	

11.	A/YL-KTN/951	Proposed Temporary Warehouse (excluding Dangerous Goods Godown) with Ancillary Facilities for a Period of 3 Years and Filling of Land	8.12.2023
12.	A/YL-KTN/953	Proposed Temporary Warehouse (excluding Dangerous Goods Godown) with Ancillary Facilities for a Period of 3 Years and Filling of Land	8.12.2023
13.	A/YL-KTN/955	Proposed Temporary Warehouse (excluding Dangerous Goods Godown) with Ancillary Facilities for a Period of 3 Years and Filling of Land	27.10.2023
14.	A/YL-KTN/957	Proposed Temporary Warehouse (excluding Dangerous Goods Godown) with Ancillary Facilities for a Period of 3 Years and Filling of Land	27.10.2023
15.	A/YL-KTN/963	Proposed Temporary Warehouse (excluding Dangerous Goods Godown) with Ancillary Facilities for a Period of 3 Years and Filling of Land	8.12.2023
16.	A/YL-KTN/970	Proposed Temporary Warehouse (excluding Dangerous Goods Godown) with Ancillary Facilities for a Period of 3 Years and Filling of Land	19.4.2024
17.	A/YL-KTN/975	Proposed Temporary Warehouse (excluding Dangerous Goods Godown) with Ancillary Facilities for a Period of 3 Years and Filling of Land	26.1.2024
18.	A/YL-KTN/992	Proposed Temporary Warehouse (excluding Dangerous Goods Godown) with Ancillary Facilities for a Period of 3 Years and Filling of Land	5.4.2024
19.	A/YL-KTN/993	Proposed Temporary Warehouse (excluding Dangerous Goods Godown) with Ancillary Facilities for a Period of 3 Years and Associated Filling of Land	5.4.2024
20.	A/YL-KTN/995	Proposed Temporary Warehouse (excluding Dangerous Goods Godown) with Ancillary Facilities for a Period of 3 Years and Associated Filling of Land	5.4.2024
21.	A/YL-KTN/996	Proposed Temporary Warehouse (excluding Dangerous Goods Godown) with Ancillary Facilities for a Period of 3 Years and Associated Filling of Land	19.4.2024

Government Departments' General Comments

1. Land Administration

Comments of the District Lands Officer/ Yuen Long, Lands Department (DLO/YL, LandsD):

- no adverse comment on the application; and
- the application site (the Site) comprises Old Schedule Agricultural Lot No. 1434 in D.D. 107 held under the Block Government Lease which contains the restriction that no structures are allowed to be erected without the prior approval of the Government.

2. Traffic

Comments of the Commissioner for Transport (C for T):

• no adverse comment on the application from traffic engineering perspective.

Comments of the Chief Highway Engineer/New Territories West, Highways Department (CHE/NTW, HyD):

• no adverse comment on the application from highways maintenance perspective.

3. Drainage

Comments of the Chief Engineer/Mainland North, Drainage Services Department (CE/MN, DSD):

- no objection in principle to the application; and
- should the application be approved, approval conditions should be stipulated requiring the implementation and maintenance of the accepted drainage proposal for the proposed use to the satisfaction of his department or of the Town Planning Board.

4. Fire Safety

Comments of the Director of Fire Services (D of FS):

• no in-principle objection to the application subject to fire service installations being provided to the satisfaction of his department.

5. Environment

Comments of the Director of Environmental Protection (DEP):

- no objection to the application; and
- there was no environmental complaint concerning the Site received in the past three years.

6. Landscape

Comments of the Chief Town Planner/ Urban Design and Landscape, Planning Department (CTP/UD&L, PlanD):

- no objection to the application from landscape planning perspective;
- the Site is located in a rural inland plains landscape character comprising farmlands, vacant lands, open storage, scattered temporary structures, tree groups and woodland within "Conservation Area" zone to the east of the Site. The proposed use is not incompatible with the planned landscape character of the proximity; and
- the Site is fenced-off, hard paved and occupied by storage of construction material. The
 dried pond as indicated in the submission has been filled and hard paved. No existing
 tree is observed within the Site. Significant adverse landscape impact on landscape
 resources arising from the proposed use is not anticipated.

7. Building Matters

Comments of the Chief Building Surveyor/New Territories West, Buildings Department (CBS/NTW, BD):

• no objection to the application.

8. District Officer's Comments

Comments of the District Officer (Yuen Long), Home Affairs Department (DO(YL), HAD):

• his office has not received any local's comment on the application.

9. Other Departments

The following government departments have no objection to/no adverse comment/no comment on the application:

- Project Manager (West), Civil Engineering and Development Department (PM(W), CEDD); and
- Chief Engineer/Construction, Water Supplies Department (CE/C, WSD).

Recommended Advisory Clauses

- (a) prior planning permission should have been obtained before commencing the proposed use at the application site (the Site);
- (b) the permission is given to the proposed use under application. It does not condone any other development currently exists on the Site which are not covered by the application. Immediate action should be taken to discontinue such development not covered by the permission;
- (c) to note the comments of the District Lands Officer/Yuen Long, Lands Department (DLO/YL, LandsD) that:
 - the lots owner(s) shall apply to his office for a Short Term Waiver (STW) to permit the structure(s) erected within the private lot. The application for STW will be considered by the Government in its capacity as a landlord and there is no guarantee that it will be approved. The STW, if approved, will be subject to such terms and conditions including the payment of waiver fee and administrative fee as considered appropriate by LandsD. Besides, given the proposed use is temporary in nature, only erection of temporary structure(s) will be considered;
- (d) to note the comments of the Director of Fire Services (D of FS) that:
 - the applicant is advised on the following points:
 - i. the layout plans should be drawn to scale and depicted with dimensions and nature of occupancy;
 - ii. the location of where the proposed fire service installations to be installed should be clearly marked on the layout plans; and
 - the applicant shall be reminded that if the proposed structure(s) is required to comply with the Buildings Ordinance (BO) (Cap. 123), detailed fire safety requirements will be formulated upon receipt of formal submission of general building plans;
- (e) to note the comments of the Commissioner for Transport (C for T) that:
 - the Site is connected to the public road network via a section of a local access road which is not managed by Transport Department. The land status of the local access road should be checked with the LandsD. Moreover, the management and maintenance responsibilities of the local access road should be clarified with the relevant lands and maintenance authorities accordingly. Sufficient manoeuvring space shall be provided within the Site. No vehicle is allowed to queue back to or reverse onto / from public road at any time during the planning approval period;
- (f) to note the comments of the Chief Highway Engineer/New Territories West, Highways Department (CHE/NTW, HyD):
 - the proposed vehicular access to the Site, i.e. from Shui Mei Road via a local access, is not maintained by HyD; and

- adequate drainage measures should be provided to prevent surface water running from the Site to nearby public road and drains;
- (g) to note the comments of the Chief Building Surveyor/New Territories West, Buildings Department (CBS/NTW, BD) that:
 - for unauthorised building works (UBW) erected on leased land, enforcement action may be taken by BD to effect their removal in accordance with the prevailing enforcement policy against UBW as and when necessary. The granting of any planning approval should not be construed as an acceptance of any existing building works or UBW on the Site under the BO;
 - any temporary shelters or converted containers for office, storage, washroom or other uses are considered as temporary buildings are subject to the control of Part VII of the Building (Planning) Regulations (B(P)R);
 - before any new building works (including containers/open sheds as temporary buildings) are to be carried out on the Site, prior approval and consent of the Building Authority should be obtained, otherwise they are UBW under the BO. An Authorised Person should be appointed as the coordinator for the proposed building works in accordance with the BO;
 - the Site shall be provided with means of obtaining access thereto from a street and emergency vehicular access in accordance with Regulations 5 and 41D of the B(P)R respectively;
 - the Site does not abut on a specified street of not less than 4.5m wide and its permitted development intensity shall be determined under Regulation 19(3) of the B(P)R at building plan submission stage; and
 - detailed checking under the BO will be carried out at building plan submission stage;
- (h) to note the comments of the Director of Environmental Protection (DEP) that:
 - the applicant is advised:
 - i. to follow the requirements stipulated in the revised "Code of Practice on Handling the Environmental Aspects of Temporary Uses and Open Storage Sites";
 - ii. that no construction waste should be used for land and pond filling;
 - iii. to provide adequate supporting infrastructure/facilities for proper collection, treatment and disposal of waste/wastewater generated from the proposed use. If septic tank and soakaway system will be used in case of unavailability of public sewer, its design and construction shall follow the requirements of EPD's Practice Note for Professional Person (ProPECC) PN 1/23 "Drainage Plans subject to Comment by the Environmental Protection Department" including completion of percolation test and certification by Authorized Person; and
 - iv. to meet the statutory requirements under relevant pollution control ordinances; and

- (i) to note the comments of the Director of Electrical and Mechanical Services (DEMS) that:
 - in the interests of public safety and ensuring the continuity of electricity supply, the parties concerned with planning, designing, organizing and supervising any activity near the underground cable or overhead line under the mentioned document should approach the electricity supplier (i.e. CLP Power) for the requisition of cable plans (and overhead line alignment drawings, where applicable) to find out whether there is any underground cable and/or overhead line within and/or in the vicinity of the concerned site. They should also be reminded to observe the Electricity Supply Lines (Protection) Regulation and the "Code of Practice on Working near Electricity Supply Lines" established under the Regulation when carrying out works in the vicinity of the electricity supply lines.

. ☐ Urgent	Return Receipt Requested	Sign	☐ Encrypt	☐ Mark Subject Restricted	Expand personal&publi
	A/YL-KTN/979 DD 107 K 30/01/2024 02:38	am Tin			
From: To: Sent by:	"tpbpd" <tpbpd@pland.gov.hk> tpbpd@pland.gov.hk</tpbpd@pland.gov.hk>		·		

A/YL-KTN/979

Lot 1434 (Part) in D.D. 107, Kam Tin, Yuen Long

Site area: About 498sq.m

· Zoning: "Agriculture"

Applied use: Warehouse / 1 Vehicle Parking / Filling of Land and Pond

Dear TPB Members,

Strong Objections. The lot is close to Conservation Area and the pond is art of the buffer zone.

The elimination of this and the remaining ponds in the district is contrary to the need to protect natural drainage to combat the challenges of climate change.

No previous application, no justification for approval.

Mary Mulvihill

• ·