申請的日期

1 2 OCT 2023

This document is received on The Town Planning Board will formally acknowledge the date of receipt of the application only upon receipt of all the required information and documents.



APPLICATION FOR PERMISSION UNDER SECTION 16 OF THE TOWN PLANNING ORDINANCE (CAP. 131)

根據《城市規劃條例》(第131章) 第16條號交的許可申請

Applicable to proposals not involving or not only involving: 適用於建議不涉及或不祇涉及:

- (i) Construction of "New Territories Exempted House(s)"; 興建「新界豁免管制屋宇」;
- (ii) Temporary use/development of land and/or building not exceeding 3 years in rural areas or Regulated Areas; and 位於鄉郊地區或受規管地區土地上及/或建築物內進行為期不超過三年的臨時用途/發展;及
- (iii) Renewal of permission for temporary use or development in rural areas or Regulated Areas 位於鄉郊地區或受規管地區的臨時用途或發展的許可續期

Applicant who would like to publish the <u>notice of application</u> in local newspapers to meet one of the Town Planning Board's requirements of taking reasonable steps to obtain consent of or give notification to the current land owner, please refer to the following link regarding publishing the notice in the designated newspapers: https://www.tpb.gov.hk/en/plan application/apply.html

申請人如欲在本地報章刊登<u>申請通知</u>,以採取城市規劃委員會就取得現行土地擁有人的同意或通知現行土地擁有人所指定的其中一項合理步驟,請瀏覽以下網址有關在指定的報章刊登通知:https://www.tpb.gov.hk/tc/plan application/apply.html

General Note and Annotation for the Form 填寫表格的一般指引及註解

- * "Current land owner" means any person whose name is registered in the Land Registry as that of an owner of the land to which the application relates, as at 6 weeks before the application is made 「現行土地擁有人」指在提出申請前六星期,其姓名或名稱已在土地註冊處註冊為該申請所關乎的土地的擁有人的人
- & Please attach documentary proof 請夾附證明文件
- ^ Please insert number where appropriate 請在適當地方註明編號

Please fill "NA" for inapplicable item 請在不適用的項目填寫「不適用」

Please use separate sheets if the space provided is insufficient 如所提供的空間不足,請另頁說明

Please insert a 「✔」 at the appropriate box 請在適當的方格內上加上「✔」號

		3 \
For Official Use Only	Application No. 申請編號	A/TL-LFS/495
請勿填寫此欄	Date Received 收到日期	1 2 OCT 2023

- The completed form and supporting documents (if any) should be sent to the Secretary, Town Planning Board (the Board), 15/F, North Point Government Offices, 333 Java Road, North Point, Hong Kong.
 申請人須把填妥的申請表格及其他支持申請的文件 (倘有),送交香港北角渣華道 333 號北角政府合署 15 樓城市規劃委員會(下稱「委員會」)秘書收。
- 2. Please read the "Guidance Notes" carefully before you fill in this form. The document can be downloaded from the Board's website at http://www.tpb.gov.hk/. It can also be obtained from the Secretariat of the Board at 15/F, North Point Government Offices, 333 Java Road, North Point, Hong Kong (Tel: 2231 4810 or 2231 4835), and the Planning Enquiry Counters of the Planning Department (Hotline: 2231 5000) (17/F, North Point Government Offices, 333 Java Road, North Point, Hong Kong and 14/F, Sha Tin Government Offices, 1 Sheung Wo Che Road, Sha Tin, New Territories). 請先細閱《申請須知》的資料單張,然後填寫此表格。該份文件可從委員會的網頁下載(網址: http://www.tpb.gov.hk/),亦可向委員會秘書處 (香港北角渣華道 333 號北角政府合署 15 樓-電話: 2231 4810 或 2231 4835)及規劃署的規劃資料查詢處(熱線: 2231 5000) (香港北角渣華道 333 號北角政府合署 17 樓及新界沙田上禾鲞路 1 號沙田政府合署 14 樓)索取。
- 3. This form can be downloaded from the Board's website, and obtained from the Secretariat of the Board and the Planning Enquiry Counters of the Planning Department. The form should be typed or completed in block letters. The processing of the application may be refused if the required information or the required copies are incomplete. 此表格可從委員會的網頁下載,亦可向委員會秘書處及規劃署的規劃資料查詢處索取。申請人須以打印方式或以正楷填寫表格。如果申請人所提交的資料或文件副本不齊全,委員會可拒絕處理有關申請。

2	77 0 1 74 1	
	Name of Annlicant	申請人姓名/名稱
	Maine of Applicant	中明八年一一一

(□Mr. 先生 /□Mrs. 夫人 /□Miss 小姐 /□Ms. 女士 /Ѿ Company 公司 /□Organisation 機構)

凱富萬豐吊船有限公司

HOI FU MAN FUNG GONDOLA COMPANY LIMITED

2.	Name of Authorised Agent (if applicable)	獲授權代理人姓名/名稱(如	適用)
	Traine of Trainer Bearing (in appreciate)		10/11/

(☑Mr. 先生 /□Mrs. 夫人 /□Miss 小姐 /□Ms. 女士 /□Company 公司 /□Organisation 機構)

盖新和

WONG SUN WO WILLIAM

3.	Application Site 申請地點	
(a)	Full address / location / demarcation district and lot number (if applicable) 詳細地址/地點/丈量約份及地段號碼(如適用)	元朗流浮山深灣路即D.D129 Lot No,s 1796,1797,1798,1800,1801,1802及毗連政府土地.
(b)	Site area and/or gross floor area involved 涉及的地盤面積及/或總樓面面 積	□Site area 地盤面積 3355 sq.m 平方米□About 約 □Gross floor area 總樓面面積 1090 sq.m 平方米□About 約
(c)	Area of Government land included (if any) 所包括的政府土地面積(倘有)	370 sq.m 平方米 □About 約

(d)	Name and number of th statutory plan(s) 有關法定圖則的名稱及緣		流浮山及尖鼻咀分區計劃大綱核准圖編 S/YL-LFS/11	號				
(e)	Land use zone(s) involved 涉及的土地用途地帶	1	REC					
(f)	Current use(s) 現時用途		閒置土地 (If there are any Government, institution or community plan and specify the use and gross floor area) (如有任何政府、機構或社區設施,請在圖則上顯示	· -				
4.	"Current Land Own	er" of A	oplication Site 申請地點的「現行土均	 也擁有人 」				
The	applicant 申請人 -							
	is the sole "current land ow		ease proceed to Part 6 and attach documentary proof 鑑續填寫第 6 部分,並夾附業權證明文件)。	of ownership).				
	is one of the "current land 是其中一名「現行土地挧	owners"#& 維有人」#&	(please attach documentary proof of ownership). (請夾附業權證明文件)。					
₩	is not a "current land owner". 並不是「現行土地擁有人」#。							
	The application site is entirely on Government land (please proceed to Part 6). 申請地點完全位於政府土地上(請繼續填寫第 6 部分)。							
5.	Statement on Owner	la Congo	nt/Notification					
5.			T上地擁有人的陳述					
(a)	According to the record(s) of the Land Registry as at							
(b)	The applicant 申請人 -							
	•		"current land owner(s)" [#] . 現行土地擁有人」 [#] 的同意。					
	Details of consent of "current land owner(s)" obtained 取得「現行土地擁有人」 "同意的詳情							
	Land Owner(s) [1]	Registry wh	address of premises as shown in the record of the Land ere consent(s) has/have been obtained 語一處記錄已獲得同意的地段號碼/處所地址	Date of consent obtained (DD/MM/YYYY) 取得同意的日期 (日/月/年)				
	1	D.D129 Lot	No 1796 • 1797 • 1798 • 1800 • 1801 • 1802	15-09-2023				
	(Please use sengrate she	eeto if the on	ace of any box above is insufficient. 如上列任何方格的?	 				

Land Owner(s), 「現行土地擁」 Lot number/address of premises as shown in the record of the Land Registry where notification(s) has/have been given (DD/MM/YYYY)	L		rent land owner(s)" # notified 已獲通知「現行土地擁有人」 # l						
has taken reasonable steps to obtain consent of or give notification to owner(s): 已採取合理步驟以取得土地擁有人的同意或向該人發給通知。詳情如下: Reasonable Steps to Obtain Consent of Owner(s) 取得土地擁有人的同意所採取的合理步驟 sent request for consent to the "current land owner(s)" on		Land Owner(s)' 「現行土地擁	Land Registry where notification(s) has/have been given						
□ has taken reasonable steps to obtain consent of or give notification to owner(s): □ 上採取合理步驟以取得土地擁有人的同意或向該人發給通知。詳情如下: Reasonable Steps to Obtain Consent of Owner(s) 取得土地擁有人的同意所採取的合理步驟 □ sent request for consent to the "current land owner(s)" on									
has taken reasonable steps to obtain consent of or give notification to owner(s): 已採取合理步驟以取得土地擁有人的同意或向該人發給通知。詳情如下: Reasonable Steps to Obtain Consent of Owner(s) 取得土地擁有人的同意所採取的合理步驟 sent request for consent to the "current land owner(s)" on									
has taken reasonable steps to obtain consent of or give notification to owner(s): 已採取合理步驟以取得土地擁有人的同意或向該人發給通知。詳情如下: Reasonable Steps to Obtain Consent of Owner(s) 取得土地擁有人的同意所採取的合理步驟 sent request for consent to the "current land owner(s)" on	_	Please use separate s	heets if the space of any box above is insufficient. 如上列任何方格的空	·間不足,譜另頁說明)					
於	Ē	已採取合理步驟以	取得土地擁有人的同意或向該人發給通知。詳情如下:	<u>均合理步驟</u>					
□ published notices in local newspapers on									
於	<u>R</u>								
				YY) ^{&}					
□ sent notice to relevant owners' corporation(s)/owners' committee(s)/mutual aid committee(s)/managonffice(s) or rural committee on(DD/MM/YYYY) ^{&} 於(日/月/年)把通知寄往相關的業主立案法團/業主委員會/互助委員會可處,或有關的鄉事委員會 ^{&} Others 其他 □ others (please specify)									
office(s) or rural committee on(DD/MM/YYYY) ^{&} 於(日/月/年)把通知寄往相關的業主立案法團/業主委員會/互助委員會或處,或有關的鄉事委員會 ^{&} Others 其他 others (please specify)		於	(日/月/年)在申請地點/申請處所或附近的顯明位置	貼出關於該申請的通					
others (please specify)	C	office(s) or ru 於	ral committee on(DD/MM/YYYY)& (日/月/年)把通知寄往相關的業主立案法團/業主委						
		Others 其他							
	<u>C</u>		* *						
	<u>C</u>								
	<u>C</u>								
	<u>C</u>								

6.	Type(s)	of Application 申請類別
	Type (i) 第(i)類	Change of use within existing building or part thereof 更改現有建築物或其部分內的用途
	Type (ii) 第(ii)類	Diversion of stream / excavation of land / filling of land / filling of pond as required under Notes of Statutory Plan(s) 根據法定圖則《註釋》內所要求的河道改道/挖土/填土/填塘工程
	Type (iii) 第(iii)類	Public utility installation / Utility installation for private project 公用事業設施裝置/私人發展計劃的公用設施裝置
	Type (iv) 第(iv)類	Minor relaxation of stated development restriction(s) as provided under Notes of Statutory Plan(s) 略為放寬於法定圖則《註釋》內列明的發展限制
12	Type (v) 第(v)類	Use / development other than (i) to (iii) above 上述的(i)至(iii)項以外的用途/發展
註 1 Note	: 可在多於 2: For Develop	t more than one「✓」. 一個方格內加上「✓」號 oment involving columbarium use, please complete the table in the Appendix. 及靈灰安置所用途,請填妥於附件的表格。
пиначени	HA DE PER LETA CONTRACTOR DE	

(0)	For Lype (1) applicati	on 供第(i) 類申請 。			
(a)	Total floor area involved 涉及的總樓面面積				sq.m 平方	7米
(b)	Proposed use(s)/development 擬議用途/發展	the use and	gross floor area)	nstitution or community f 設施,請在圖則上顯示	_	llustrate on plan and specify 及總樓面面穳)
(c)	Number of storeys involved 涉及層數			Number of units inv 涉及單位數目	olved	
		Domestic p	art 住用部分		sq.m 平方米	□About 約
(d)	Proposed floor area 擬議樓面面積	Non-domes	stic part 非住用語	部分	sq.m 平方米	□About 約
		Total 總計	•••••		sq.m 平方米	□About 約
(e)	Proposed uses of different	Floor(s) 樓層	Current u	se(s) 現時用途	Propose	ed use(s) 擬議用途
	floors (if applicable) 不同樓層的擬議用途(如適					
	用) (Please use separate sheets if the space provided is insufficient)					
	(如所提供的空間不足,讀另頁說 明)					1441-14-14-14-14-14-14-14-14-14-14-14-14
		l	1		1	

(ii) Kor Type (ii) applie	ation:供第(ii)類申讀					
	Diversion of stream 河道改道					
	□ Filling of pond 填塘 Area of filling 填塘面積					
(a) Operation involved 涉及工程	□ Filling of land 填土 Area of filling 填土面積 sq.m 平方米□About 約 Depth of filling 填土厚度 m 米□About 約 □ Excavation of land 挖土 Area of excavation 挖土面積 sq.m 平方米□About 約 Depth of excavation 挖土深度 m 米□About 約 (Please indicate on site plan the boundary of concerned land/pond(s), and particulars of stream diversion, the extent of filling of land/pond(s) and/or excavation of land) (請用圖則顯示有關土地/池塘界線,以及河道改道、填塘、填土及/或挖土的細節及/或範圍))					
(b) Intended use/development 有意進行的用途/發展	(請用國則線小有關工地/池格子級,以及用追改道、吳格、吳正及/敦松工即和即及/敦地國)					
(iii) For True (iii) and	eation (INTIONITY)					
	□ Public utility installation 公用事業設施裝置					
	Utility installation for private project 私人發展計劃的公用設施裝置					
	Please specify the type and number of utility to be provided as well as the dimensions of each building/structure, where appropriate 請註明有關裝置的性質及數量,包括每座建築物/構築物(倘有)的長度、高度和闊度					
(a) Nature and scale	Name/type of installation 裝置名稱/種類 Number of provision 數量 Dimension of each installation /building/structure (m) (LxWxH) 每個裝置/建築物/構築物的尺寸 (米) (長 x 闊 x 高)					
性質及規模						
	(Please illustrate on plan the layout of the installation 請用圖則顯示裝置的布局)					

(iv)	Ė	orType (iv)tapplica	tion #	第位)類目前			Applications	
(a)	I	Please specify the pro	posed	minor relaxation of	stated	development restriction(s) and a	also fill in the	
	_					rs in part (v) below –		
	1	請列明擬議略為放寬的	的發展	限制 <u>並填妥於第(v)</u> 音	形分的	孫議用途/發展及發展細節 -		
		Plot ratio restriction 地積比率限制		From 由		to至		
		Gross floor area restric 總樓面面積限制	tion	From 由	sq. m	平方米 to 至sq. m 平方法	米	
		Site coverage restrictio 上蓋面積限制	n	From 由	•••••	% to 至%		
		Building height restrict 建築物高度限制	tion	From 由m 米 to 至m 米				
				From 由		mPD 米 (主水平基準上) to 至		
						mPD 米 (主水平基準上)		
				From 由		storeys 層 to 至store	ys 層	
		Non-building area restu 非建築用地限制	riction	From 由		.m to 至m		
		Others (please specify) 其他(請註明)						
(v)		oriType((v)/applicati		<i>第(v)類申讀</i>				
					マケノー・	게임 사고리 보호 그는 가능 선생 F (사이) 사이 60~ \		
] -			業(園藝及建築材料銷售)		
		posed (s)/development		(為	期五	牛)		
		義用途/發展						
			(Please	illustrate the details of the	propo	sal on a layout plan 請用平面圖說明建議	詳情) 	
(b)	Dev	velopment Schedule 發展	細節表					
	Pro	posed gross floor area (C	iFA) 擬	議總樓面面積		1090sq.m 平方米	☑About 約	
	Proposed plot ratio 擬議地積比率				0.325	DAbout約		
	Proposed site coverage 擬議上蓋面積				32.5 %	MAbout約		
	Proposed no. of blocks 擬議座數					б		
	Pro	posed no. of storeys of ea	ach bloc	k 每座建築物的擬議層	줼數	storeys 層		
						□ include 包括 storeys of basen		
						□ exclude 不包括 storeys of base	sements 層地庫	
	Pro	posed building height of	each blo	ck 每座建築物的擬議	高度	mPD 米(主水平基準上	_) 🗹 About 約	
						3.5-8m 米	掛About 約	
L								

☐ Domestic part				
	要面面積 要面面積		sq. m 平方米	□About 約
	of Units 單位數目			
	unit size 單位平均面	瘡	sq. m 平方米	□About 約
=	d number of residents			□1100at #3
Cstimator	i mumber of resident		***************************************	
☐ Non-domestic	part 非住用部分		GFA 總樓面面	穑
	ace 食肆		 sq. m 平方米	□About 約
□ hotel 酒/			sq. m 平方米	□About 約
	Д		(please specify the number of rooms	
			請註明房間數目)	
□ office 辦	八字		sq. m 平方米	 □About 約
		∀ /== 3%	1075 sq. m 平方米	□About 約
	l services 商店及服剂	的打栗	1以72 sq. m 平力示	⊔About #ŋ
☐ Governm	nent, institution or co	mmunity facilities	(please specify the use(s) and	concerned land
	機構或社區設施	initiality facilities	area(s)/GFA(s) 請註明用途及有關的	
LX/N V	州中汉川山		樓面面積)	
			皮面面以	

☑ other(s)	甘州		(please specify the use(s) and	concerned land
Ly outer(s)	共心		area(s)/GFA(s) 請註明用途及有關的	
			樓面面積)	1770日日日194/ %6
			洗方間面積15平方	米
			•••••	
☐ Open space Ø	 大憩用地		(please specify land area(s) 請註明	北面面積)
	ppen space 私人休憩	用地	sq. m 平方米 □ Not l	•
=	pen space 公眾休憩		sq. m 平方米 口 Not l	
	i i	ole) 各樓層的用途 (如:	1 /2 /2 /2 /2 /2 /2 /2 /2 /2 /2 /2 /2 /2	
[Block number]	[Floor(s)]		[Proposed use(s)]	
[座數]	[層數]		[擬議用途]	
*		***************		•••••

******	*******			
(4) D 4(2)		£ 原工业士 / 少去	: \	
(a) rroposed use(s)	or uncovered area (1	fany) 露天地方(倘有	7.7 中外统践市 经	
***************************************		行車及行人	走火通道	

***************************************	******************			
•••••	•••••		***************************************	

Anticipated completion time (in month and year) of the development proposal (by phase (if any)) (e.g. June 2023) 擬議發展計劃預期完成的年份及月份 (分期 (倘有)) (例: 2023 年 6 月) (Separate anticipated completion times (in month and year) should be provided for the proposed public open sp Government, institution or community facilities (if any)) (申請人須就擬議的公眾休憩用地及政府、機構或社區設施(倘有)提供個別擬議完成的年份及月份) 2024年6月								
8. Vehicular Access Arrangement of the Development Proposal	擬議發展計劃預期完成的年份及月份 (分期 (倘有)) (例: 2023 年 6 月) (Separate anticipated completion times (in month and year) should be provided for the proposed public open space and Government, institution or community facilities (if any))							
	••••							
	,							
1) THE PROPERTY AND THE								
Yes 是 Any vehicular access to the site/subject building? 是否有車路通往地盤/有關 建築物? Yes 是 There is an existing access. (please indicate the street name appropriate) 有一條現有車路。(請註明車路名稱(如適用)) ※灣路經鄉村小路 □ There is a proposed access. (please illustrate on plan and specify th 有一條擬議車路。(請在圖則顯示,並註明車路的闊度)								
Yes 是	5							
Yes 是 Yes 是 (Please specify type(s) and number(s) and illustrate on plan) 請註明種類及數目並於圖則上顯示) Taxi Spaces 的士車位 Coach Spaces 旅遊巴車位 Light Goods Vehicle Spaces 輕型貨車車位 Medium Goods Vehicle Spaces 中型貨車車位 Heavy Goods Vehicle Spaces 重型貨車車位 Others (Please Specify) 其他 (請列明)	2							

9. Impacts of Development Proposal 擬議發展計劃的影響						
If necessary, please use separate sheets to indicate the proposed measures to minimise possible adverse impacts or give justifications/reasons for not providing such measures. 如需要的話,請另頁註明可盡量減少可能出現不良影響的措施,否則請提供理據/理由。						
	Yes 是	□ Please provide details 請提供詳情				
Does the development			~~~~~~~~~~~~~~~~~~~~~~~~~~~~~~~~~~~~~~			
proposal involve						
alteration of existing building?						
擬議發展計劃是否			***************************************			
包括現有建築物的						
改動?	No A		***************************************	***************************************		
	No 否		1			
	Yes 是		indary of concerned land/pond(s), and pa	irticulars of stream diversion,		
		the extent of filling of land/pond(s)				
Does the development proposal involve the			池塘界線,以及河道改道、填塘、填土	工及/ 实授工的細即及/实规		
operation on the		園)				
right?		☐ Diversion of stream 河道	改道			
擬議發展是否涉及		│ □ Filling of pond 填塘				
右列的工程?			sq.m 平方米	□About 約		
(Note: where Type (ii)		Depth of filling 填塘深度				
application is the subject of application,						
please skip this		☐ Filling of land 填土	ng m 亚卡华	□ A hout 4/1		
section.			sq.m 平方米			
註: 如申請涉及第		Depth of filling 填土厚度 m 米 □About 約				
(ii)類申請,請跳至下		☐ Excavation of land 挖土				
一條問題。)			面積 sq.m 平方米			
		Depth of excavation 挖土	∴深度m 米	口About 約		
	No 否	lacksquare				
	On envir	onment 對環境	Yes 會 🗌	No 不會 ☑		
		c 對交通	Yes 會 🗌	No 不會 ☑		
		r supply 對供水	Yes 會 □	No 不會 ☑		
		age 對排水 s 對斜坡	Yes 會 □ Yes 會 □	No 不會 ☑ No 不會 ☑		
		by slopes 受斜坡影響	Yes 會 □	No 不會 🔽		
		pe Impact 構成景觀影響	Yes 會 □	No 不會 ☑		
	Tree Fell	ing 砍伐樹木	Yes 會 🗌	No 不會 💟		
		mpact 構成視覺影響	Yes 會 □	No 不會 位		
Would the	Others (I	Please Specify) 其他 (請列明)	Yes 會 □	No 不會 ☑		
development						
proposal cause any	l					
adverse impacts?	Please s	tate measure(s) to minimise the	impact(s). For tree felling, p	lease state the number,		
擬議發展計劃會否 造成不良影響?		diameter at breast height and species of the affected trees (if possible)				
担队小尺影谱:		監量減少影響的措施。如涉及砍 品種(倘可)	伐樹木,請說明受影響樹木的	数目、及胸高度的樹幹		
1						
				• • • • • • • • • • • • • • • • • • • •		

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		· · · · · · · · · · · · · · · · · · ·				

10. Justifications 理由
The applicant is invited to provide justifications in support of the application. Use separate sheets if necessary. 現請申請人提供申請理由及支持其申請的資料。如有需要,請另頁說明。
現時有很多農業愛好者,年輕人及新一代年輕家庭喜愛農業種植,而鄰近地段大部份都是農業用地及綠化地帶,我等希開設(園藝及建築材料銷售)幫助有興趣農業工作或家庭式農耕樂
的人士購買所須農具及種子,同時我等亦會協助和教導有興趣農業人士種植方式。 希望貴會能認同我等的建議及批准是次申請
我等營業時間為每日上午8時至下午6時,星期日及公眾假期休息。

11. Decla	ration 聲明	
	are that the particulars given in this application a 明,本人就這宗申請提交的資料,據本人所知	re correct and true to the best of my knowledge and belief. 1及所信,均屬真實無誤。
to the Board'		als submitted in this application and/or to upload such materials bublic free-of-charge at the Board's discretion. 本人現准許委战至委員會網站,供公眾免費瀏覽或下載。
Signature 簽署	30	□ Applicant 申請人 / □ Authorised Agent 獲授權代理人
	WONG SUN WO WILLIAM	
	Name in Block Letters 姓名(請以正楷填寫)	Position (if applicable) 職位 (如適用)
Professional 專業資格	☐ HKIS 香港測量師學↑☐ HKILA 香港園境師彎☐ RPP 註冊專業規劃師	會 / □ HKIA 香港建築師學會 / 會 / □ HKIE 香港工程師學會 /
on behalf of 代表	□ Company 公司 / □ Organisation Name a	nd Chop (if applicable) 機構名稱及蓋章(如適用)
Date 日期	25-09-2023	(DD/MM/YYYY 日/月/年)

Remark 備註

The materials submitted in this application and the Board's decision on the application would be disclosed to the public. Such materials would also be uploaded to the Board's website for browsing and free downloading by the public where the Board considers appropriate.

委員會會向公眾披露申請人所遞交的申請資料和委員會對申請所作的決定。在委員會認為合適的情況下,有關申請資料亦會上載至委員會網頁供公眾免費瀏覽及下載。

Warning 警告

Any person who knowingly or wilfully makes any statement or furnish any information in connection with this application, which is false in any material particular, shall be liable to an offence under the Crimes Ordinance. 任何人在明知或故意的情况下,就這宗申請提出在任何要項上是虛假的陳述或資料,即屬違反《刑事罪行條例》。

Statement on Personal Data 個人資料的聲明

1. The personal data submitted to the Board in this application will be used by the Secretary of the Board and Government departments for the following purposes:

委員會就這宗申請所收到的個人資料會交給委員會秘書及政府部門,以根據《城市規劃條例》及相關的城市規劃委員會規劃指引的規定作以下用途:

- (a) the processing of this application which includes making available the name of the applicant for public inspection when making available this application for public inspection; and 處理這宗申請,包括公布這宗申請供公眾查閱,同時公布申請人的姓名供公眾查閱;以及
- (b) facilitating communication between the applicant and the Secretary of the Board/Government departments. 方便申請人與委員會秘書及政府部門之間進行聯絡。
- 2. The personal data provided by the applicant in this application may also be disclosed to other persons for the purposes mentioned in paragraph 1 above. 申請人就這宗申請提供的個人資料,或亦會向其他人士披露,以作上述第 1 段提及的用途。
- 3. An applicant has a right of access and correction with respect to his/her personal data as provided under the Personal Data (Privacy) Ordinance (Cap. 486). Request for personal data access and correction should be addressed to the Secretary of the Board at 15/F, North Point Government Offices, 333 Java Road, North Point, Hong Kong. 根據《個人資料(私隱)條例》(第 486 章)的規定,申請人有權查閱及更正其個人資料。如欲查閱及更正個人資料,應向委員會秘書提出有關要求,其地址為香港北角渣華道 333 號北角政府合署 15 樓。

For Developments involving Columbarium Use, please also complete the following: 如發展涉及靈灰安置所用途,請另外填妥以下資料:		
Ash interment capacity 骨灰安放容量 [@]		
Maximum number of sets of ashes that may be interred in the niches 在龕位內最多可安放骨灰的數量 Maximum number of sets of ashes that may be interred other than in niches 在非龕位的範圍內最多可安放骨灰的數量		
Total number of niches 龕位總數		
Total number of single niches 單人龕位總數		
Number of single niches (sold and occupied) 單人龕位數目(已售並佔用) Number of single niches (sold but unoccupied) 單人龕位數目(已售但未佔用) Number of single niches (residual for sale) 單人龕位數目(待售)		
Total number of double niches 雙人龕位總數 ———————————————————————————————————		
Number of double niches (sold and fully occupied) 雙人龕位數目(已售並全部佔用) Number of double niches (sold and partially occupied) 雙人龕位數目(已售並部分佔用) Number of double niches (sold but unoccupied) 雙人龕位數目(已售但未佔用) Number of double niches (residual for sale) 雙人龕位數目(待售)		
Total no. of niches other than single or double niches (please specify type) 除單人及雙人龕位外的其他龕位總數 (請列明類別)		
Number. of niches (sold and fully occupied)		
Proposed operating hours 擬議營運時間		
 Ash interment capacity in relation to a columbarium means – 就 就 就 就 接 大 安 世 京 大 安 安 安 安 安 安 古 古 日 市 日 日 日 日 日 日 日 日 日 日 日 日		

Gist of Applica	tion F	申請摘要				
(Please provide details in both English and Chinese <u>as far as possible</u> . This part will be circulated to relevant consultees, uploaded to the Town Planning Board's Website for browsing and free downloading by the public and available at the Planning Enquiry Counters of the Planning Department for general information.) (請 <u>盡量以英文及中文填寫。此部分將會發送予相關諮詢人士、上載至城市規劃委員會網頁供公眾免費瀏覽及下載及於規劃署規劃資料查詢處供一般參閱。)</u>						
Application No. 申請編號	(For Official Use Only) (請勿填寫此欄)					
Location/address 位置/地址	元朗流浮山深灣路即D.D129 Lot No,s 1796,1797,1798,1800,1801,1802及毗連政府土地.			1801,		
Site area				3355 s	q. m 平方#	∜ ☑ About 約
地盤面積	(includ	es Government land	of包括政府土	:地 370 ^s	sq. m 平方升	失 ☑ About 約)
Plan 圖則		山及尖鼻咀分區 L-LFS/11	計劃大綱核准	圖 編號		
Zoning 地帶	RE	С				
Applied use/ development 申請用途/發展	擬諱	養臨時商店及服務 (為	5行業(園藝及及 為期五年)	建築材料銷售)		
(i) Gross floor are and/or plot rat			sq.m	平方米	Plot Ra	tio 地積比率
總樓面面積及 地積比率	/ 或	Domestic 住用		□ About 約 □ Not more than 不多於		□About 約 □Not more than 不多於
		Non-domestic 非住用	1090	☑ About 約 □ Not more than 不多於	0.325	☑About 約 □Not more than 不多於
(ii) No. of blocks 幢數		Domestic 住用				
		Non-domestic 非住用		6		
		Composite 綜合用途				

(iii)	Building height/No. of storeys 建築物高度/層數	Domestic 住用	m 米 □ (Not more than 不多於)
			mPD 米(主水平基準上)□ (Not more than 不多於)
			Storeys(s) 層 □ (Not more than 不多於)
			(□Include 包括/□ Exclude 不包括 □ Carport 停車間 □ Basement 地庫 □ Refuge Floor 防火層 □ Podium 平台)
		Non-domestic 非住用	3.5-8 m 米 □ (Not more than 不多於)
			mPD 米(主水平基準上) □ (Not more than 不多於)
			1 Storeys(s) 層 □ (Not more than 不多於)
			(□Include 包括/□ Exclude 不包括 □ Carport 停車間 □ Basement 地庫 □ Refuge Floor 防火層 □ Podium 平台)
		Composite 綜合用途	m 米 □ (Not more than 不多於)
			mPD 米(主水平基準上) □ (Not more than 不多於)
			Storeys(s) 層 口 (Not more than 不多於)
			(□Include 包括/□ Exclude 不包括 □ Carport 停車間 □ Basement 地庫 □ Refuge Floor 防火層 □ Podium 平台)
(iv)	Site coverage 上蓋面積		32.5 % \(\overline{\Omega}\) About 約
(v)	No. of units 單位數目		
(vi)	Open space 休憩用地	Private 私人	sq.m 平方米 □ Not less than 不少於
		Public 公眾	sq.m 平方米 🗆 Not less than 不少於

(vii)	No. of parking spaces and loading /	Total no. of vehicle parking spaces 停車位總數	5
	unloading spaces 停車位及上落客貨 車位數目	Private Car Parking Spaces 私家車車位 Motorcycle Parking Spaces 電單車車位 Light Goods Vehicle Parking Spaces 輕型貨車泊車位 Medium Goods Vehicle Parking Spaces 中型貨車泊車位 Heavy Goods Vehicle Parking Spaces 重型貨車泊車位 Others (Please Specify) 其他 (請列明)	5
		Total no. of vehicle loading/unloading bays/lay-bys 上落客貨車位/停車處總數	2
		Taxi Spaces 的士車位 Coach Spaces 旅遊巴車位 Light Goods Vehicle Spaces 輕型貨車車位 Medium Goods Vehicle Spaces 中型貨車位 Heavy Goods Vehicle Spaces 重型貨車車位 Others (Please Specify) 其他 (請列明)	2

Submitted Plans, Drawings and Documents 提交的圖則、繪圖及文件		
	<u>Chinese</u> 中文	English 英文
Plans and Drawings 圖則及繪圖		
Master layout plan(s)/Layout plan(s) 總綱發展藍圖/布局設計圖	Ĭ	
Block plan(s) 樓宇位置圖		
Floor plan(s) 樓字平面圖		
Sectional plan(s) 截視圖		
Elevation(s) 立視圖		
Photomontage(s) showing the proposed development 顯示擬議發展的合成照片		
Master landscape plan(s)/Landscape plan(s) 園境設計總圖/園境設計圖		
Others (please specify) 其他(請註明)	ď	
雨水排放建議圖。行車路線圖。申請地點位置圖		
Reports 報告書		
Planning Statement/Justifications 規劃綱領/理據		
Environmental assessment (noise, air and/or water pollutions)		
環境評估(噪音、空氣及/或水的污染)		
Traffic impact assessment (on vehicles) 就車輛的交通影響評估		
Traffic impact assessment (on pedestrians) 就行人的交通影響評估		
Visual impact assessment 視覺影響評估		
Landscape impact assessment 景觀影響評估		
Tree Survey 樹木調査		
Geotechnical impact assessment 土力影響評估	Ā	
Drainage impact assessment 排水影響評估		
Sewerage impact assessment 排污影響評估		
Risk Assessment 風險評估		
Others (please specify) 其他(請註明)	Ш	
Note: May insert more than one「レ」. 註:可在多於一個方格內加上「レ」號		

- Note: The information in the Gist of Application above is provided by the applicant for easy reference of the general public. Under no circumstances will the Town Planning Board accept any liabilities for the use of the information nor any inaccuracies or discrepancies of the information provided. In case of doubt, reference should always be made to the submission of the applicant.

 主述申請摘要的資料是由申請人提供以方便市民大眾参考。對於所載資料在使用上的問題及文義上的歧異,城市規劃委員
- 會概不負責。若有任何疑問,應查閱申請人提交的文件。

致 城市規劃委員會 每日車輛進出流量評估

. 私家車 星期日及公眾假期 輕型貨車 星期1至星期六 私家車 <u>星期1至星期六</u> OUT ĪN OUT IN IN OUT 時間 1 2 1 08:00 1 1 09:00 1 10:00 11:00 1 1 12:00 1 1 1 1 13:00 1 14:00 15:00 16:00 2 17:00 2 1 2 18:00 18:30

輕型貨車在星期日及公眾假期休息,不會即出申請場地。

沈樂年建築工程設計有限公司 SLN And Associates Ltd.

6/F, Double Building, 22 Stanley Street, Central, Hong Kong Tel: 2525 0909, 2526 1006-9, 2526 1000 Fax: 2810 6380

e-mail: sln@netvigator.com

GEOTECHNICAL PLANNING REVIEW REPORT (GPRR) FOR

A COMMERCIAL DEVELOPMENT (FIVE SALES SHOPS)

AT

LOT 1796, 1797, 1798, 1800, 1801 & 1802 IN D.D. 129, DEEP BAY VILLA, YUEN LONG

Client: Hoi Fu Man Fung Gondola Co. Ltd. Planning Consultant: P & C Engineering Consultancy Co.

Registered Geotechnical Engineer: SLN And Associates Ltd.

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Geology

Existing Slope/Retaining Wall Features

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Historical Landslide Catchment Inventory

Boulder Inventory

GASP Report

3. GEOTECHNICAL CONSIDEATIONS

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APPENDICES

Appendix A Conceptual Drawings of The Proposed Development

Appendix B Site Photographic Records

Appendix C Location Plan and Slope Maintenance Responsibility

1.0 INTROCUTION

1.1 Background

The application site is located at Lot 1796, 1797, 1798, 1800, 1801 & 1802 in D.D. 129, Deep Bay Villa, Yuen Long. A site plan (1:5000) is shown in *Figures 1*.

The proposed development is for commercial use. It basically comprises of 5 single-storey shops each 8m high and covers a rectangular floor area of 215m^2 . The total floor area amounts to 1075m^2 . In addition, there will a temporary single-storey toilet of 3.5m in height and 15m^2 in area, two 3.5mx7m loading/unloading zones for light-good vehicle, and five 2.5mx5m private car parks. The conceptual drawing of the proposed development is shown in *Appendix* A.

Owing to the application of Section 16, it is mandatory to submit a Geotechnical Planning Review Report (GPRR) to assess the geotechnical feasibility of the proposed development. SLN & Associates Ltd. has been appointed to be the Geotechnical Consultant responsible for this study and submission. This report details the desk study summarizing the available information on geological and ground conditions. It is envisaged that a thorough design in respect of the development will be submitted to Buildings Department for approval shortly after the GPRR is accepted by various government departments.

1.2 The Study Approach

The geotechnical planning review is generally carried out in accordance with the common practice as described by "GEO Advice Note for Planning Applications under Town planning Ordinance (Cap.31)".

2.0 EXISTING INFORMATION

2.1 Topography

The topography of the site now found and presented in a survey plan consists of a gentle sloping ground rising from +26mPD to 34mPD across a length of 85m, which represent a gentle overall sloping angle of 5.5°, dipping to the northwest. It is also found in some spots minor difference in level retained by concrete planks for forming level platforms. However, a deviation from the topographic record kept by the Lands Department is noticed. It is believed that some filling of the ground has been done causing some of the geotechnical features to become dismissed, rendering the current profile a more safe and desirable condition.

The total site area is about 3320m² and most of it will be occupied by the proposed development. To the east of site is a natural terrain and there is a track road adjacent to the south and east sides of the site. This track road is used as an access road for the private villas that are located to the southwest of the site.

A topographic survey plan showing the most updated ground profile of the site is given in *Figure 2a* while another topographic survey plan (1:1000) presenting both current and original ground profiles is attached in *Figure 2b*.

Photographic records of the site are enclosed in *Appendix B*.

2.2 Adjacent lot and Structure

The site is adjacent to the following structure:

a) Private Villas

There are a group of private villas at about 30m away from the subject site. Because of such long distance, they are supposed not to be affected by the proposed development. As a part of the development, a carriageway which runs along the east side of the villas area and leads directly to the subject site will also be constructed.

2.3 Geology

Based on a geological map given in Geotechnical Area Studies Program (GASP) – Report 4 "North West New Territories" published by Geotechnical Control Office in 1988, the site is underlain by COLLUVIUM. Neither superficial materials nor geological faults are identified at the site. The geological map is reproduced in *Figure 3*.

2.4 Existing Slope/Retaining Wall Features

According to the slope information retrieved from GEO's Slope Information System (SIS), there should be two registered slopes either within or in the close proximity of the site. The one that lies within the site is named Feature 2SW-C/C84, which is a man-made slope of 4.5m in height, 70m in length and has a slope angle of 40°. It lies approximately in the middle of the site and rises from a toe level of +26mPD to a peak level of +31mPD. The slope generally dips to the west. The other registered slope is named Feature 2SW-C/C85, which is also a man-made slope but falls outside of our site, so it is not a major concern of the proposed development. However, these two Features have now been flattened into a gentle sloping ground after some filling work has been done. The brief description of which is given in Section 2.1 above.

A location plan showing both Features together with the corresponding maintenance responsibilities are enclosed in *Appendix C*.

2.5 Natural Terrain Landslide Inventory

According to the Natural Terrain Landslide Inventory (NTLI) provided in GEO's online SIS, no landslides were observed within 200mm offset from the site. A graphical NTLI-Landslide Record is given in *Figure 4*.

2.6 Historical Landslide Catchment Inventory

Based on the information given in GEO's online SIS, no historical landslide catchment inventories were found within 100-150m offset from the site.

2.7 Boulder Inventory

According to GEO's QRA of Boulder Fall Hazards No.S2_H, no boulder fall records are found in the study area. An extract of QRA of Boulder Fall Hazards No.S2_H is reproduced in *Figure 5*.

2.8 GASP Report

As a part of the desk study, reference has been made to Geotechnical Land Use Map (GLUM) enclosed in GASP – Report 4. The map suggests that the site is categorized as GLUM Class III. Development within this class may possibly require intensive geotechnical investigation, and hence the costs associated with site investigation, site formation, foundation and drainage work are likely to be high. Another map called Physical Constraints Map indicates that our site is susceptible to overland flow and periodic inundation. Therefore, a proper drainage system should be put in place to save the area from inundation.

Extracts of the above two maps are shown in *Figures 6 and 7* respectively.

Attention should be drawn to that the information presented in this report are generally based on high altitude aerial photograph interpretation (API), GASP report up to year 1988, and current GEO's SIS. Therefore, the information contained herein, and to which our engineering interpretation and assessment have referred, may not be up-to-date and even insufficient for the proposed development. More detailed appraisal should be prepared by further study.

3.0 GEOTECHNICAL CONSIDERATION

3.1 General

For the proposed development, the following geotechnical related construction works are envisaged:

- Ground Investigation works
- Site formation works
- Existing slopes
- Foundation works
- Retaining structures
- Excavation works.

3.2 Ground Investigation works

In order to investigate and confirm the ground condition and soil/rock properties, a ground investigation program is recommended to be carried out at the proposed site by a GIFW contractor at a later stage.

3.3 Site formation works

Based on the development layout plan, the proposed building will be built mainly on a flat land. Minor site formation works would therefore be required.

3.4 Existing Slopes

As mentioned earlier, there are two registered slopes lying within or beside our site. Even though both of them appears to be in stable condition after the backfilling work, further study should be carried out to review the implications that may have arisen from that work.

3.5 Foundation works

The foundation of the proposed development will be designed to sustain the following loads:

- 1. Gravity load and live load from the proposed building;
- 2. Lateral wind load and soil load acting on the proposed building.

Since only one-storey buildings will be constructed on the site, the building loads should be relatively small as compared to tall building. If dense stratum or bedrock is found within 2m to 3m from the ground surface, then it would be feasible to use a shallow foundation such as spread footing or raft footing. The actual allowable bearing capacity of the founding soil at the site and the type of foundation to be adopted for the proposed development shall be subject to site-specific GI information and field testing such as plate load test. Reference should be made to "Code of Practice for Foundation 2017" while preparing the detailed foundation design.

It should be ensured that the foundation works used will not cause any adverse effects to the surrounding geotechnical features during the construction period or in the long run.

3.6 Excavation works

An excavation depth of about 2m is supposed to be made at the site to facilitate the construction work for foundation. In view of this, temporary Excavation and Lateral Support Works (ELS works) should be adopted to sustain the soil load imposed during excavation. Specifically, a shoring system employing sheet piles wall is considered feasible for supporting the excavation pit of this kind.

Any possible adverse effects incurred during each stage of excavation work shall be fully addressed in the design of ELS works. As a result, the damages to the adjacent structures, features, underground utilities, and public road could be avoided.

Before excavation work begins, a comprehensive condition survey should be carried out on and near the existing land. Any defects found should be fully documented with color photographs.

A monitoring system should also be set up on adjoining land and structure, which may include settlement checkpoints, tilting checkpoints, piezometers and inclinometers. During the excavation and construction of foundation, checkpoint readings should be taken and recorded daily.

4.0 CONCLUSION

This report has discussed all the issues concerning the geotechnical planning review under Town Planning Ordinance Section 16 for the captioned project. In conclusion, the proposed development is considered geotechnically feasible.

5.0 REFERENCES


GCO, (1988). Geotechnical Area Studies Programme. North West New Territories. GASP Report IV. Geotechnical Control Office, Civil Engineering Services Department.


GEO, (2019). Natural Terrain Landslide Inventory. Slope Information System. Geotechnical Engineering Office, Civil Engineering and Development Department.


GEO. QRA of Boulder Fall Hazards. Slope Information System. Geotechnical Engineering Office, Civil Engineering and Development Department.

FIGURES

Figure 1	Site Plan (1:5000)
Figure 2a	Topographic Survey Plan (1:1000)
Figure 2b	Topographic Survey Plan
Figure 3	Extract of GASP Report Map - Geological Map
Figure 4	NTLI - Landslide Record
Figure 5	Area of QRA of Boulder Fall Hazards No.S2_H
Figure 6	Extract of GASP Report Map - Geotechnical Land Use Map
Figure 7	Extract of GASP Report Map - Physical Constraints Map

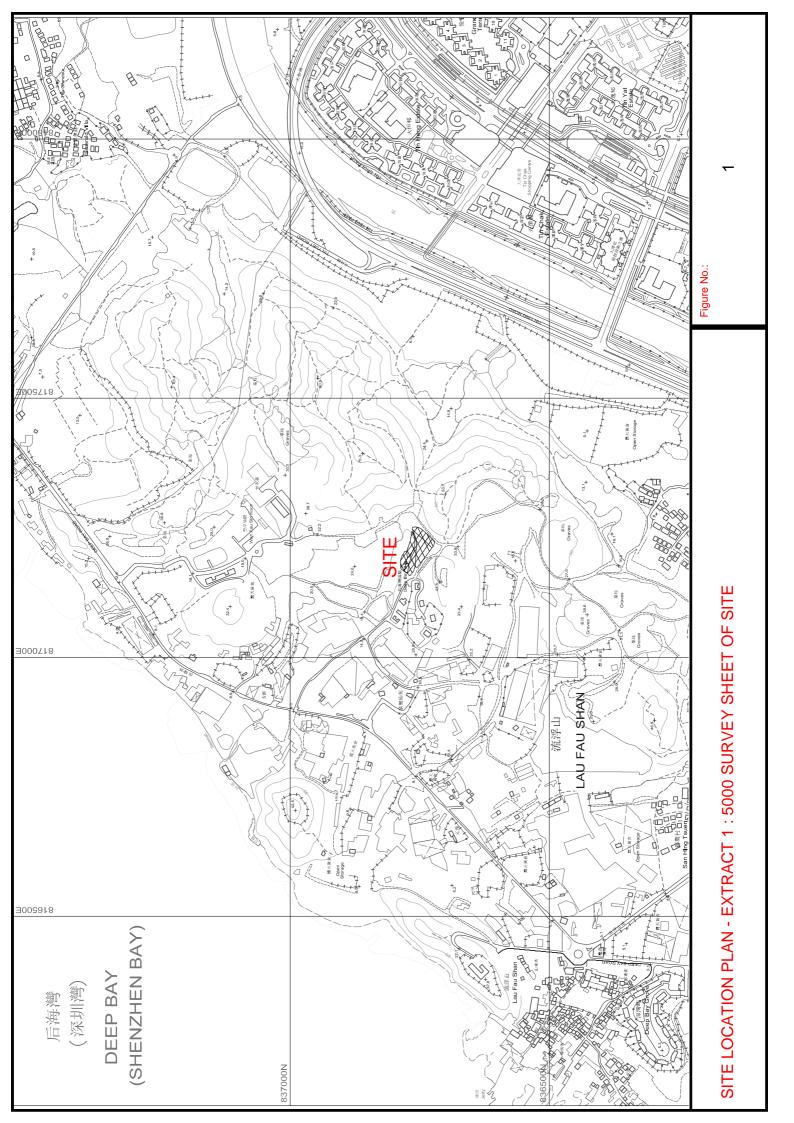

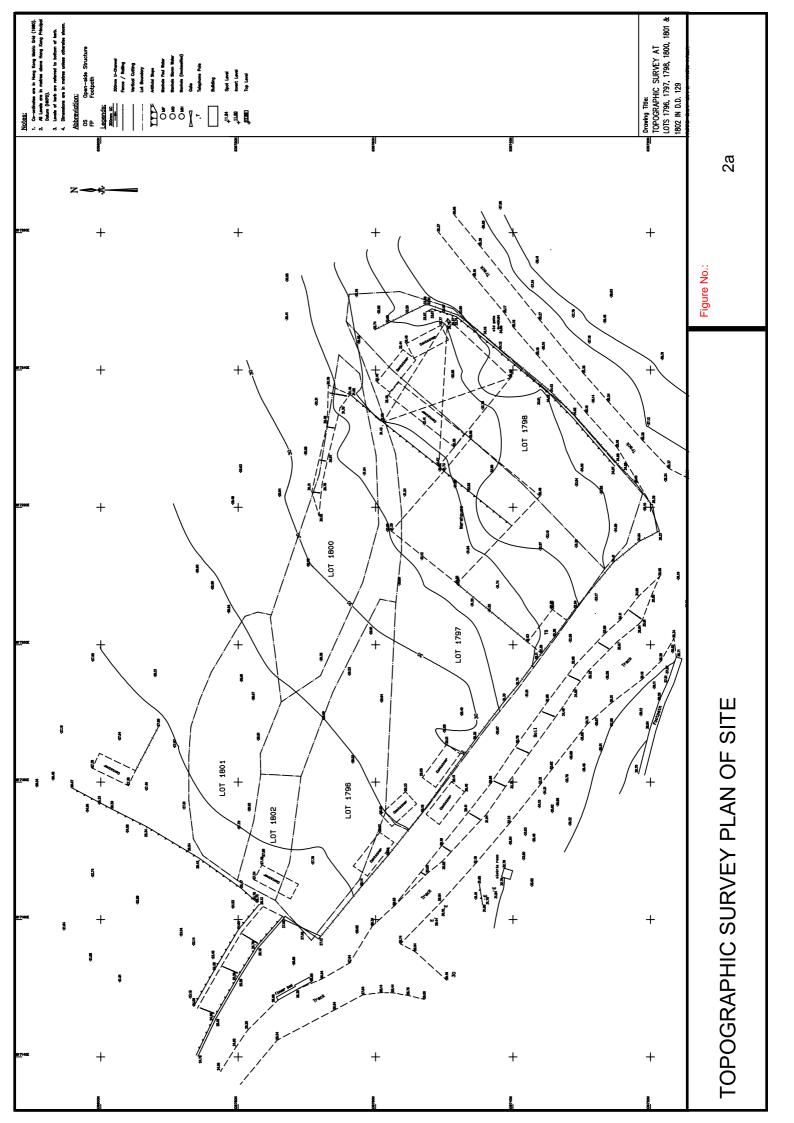

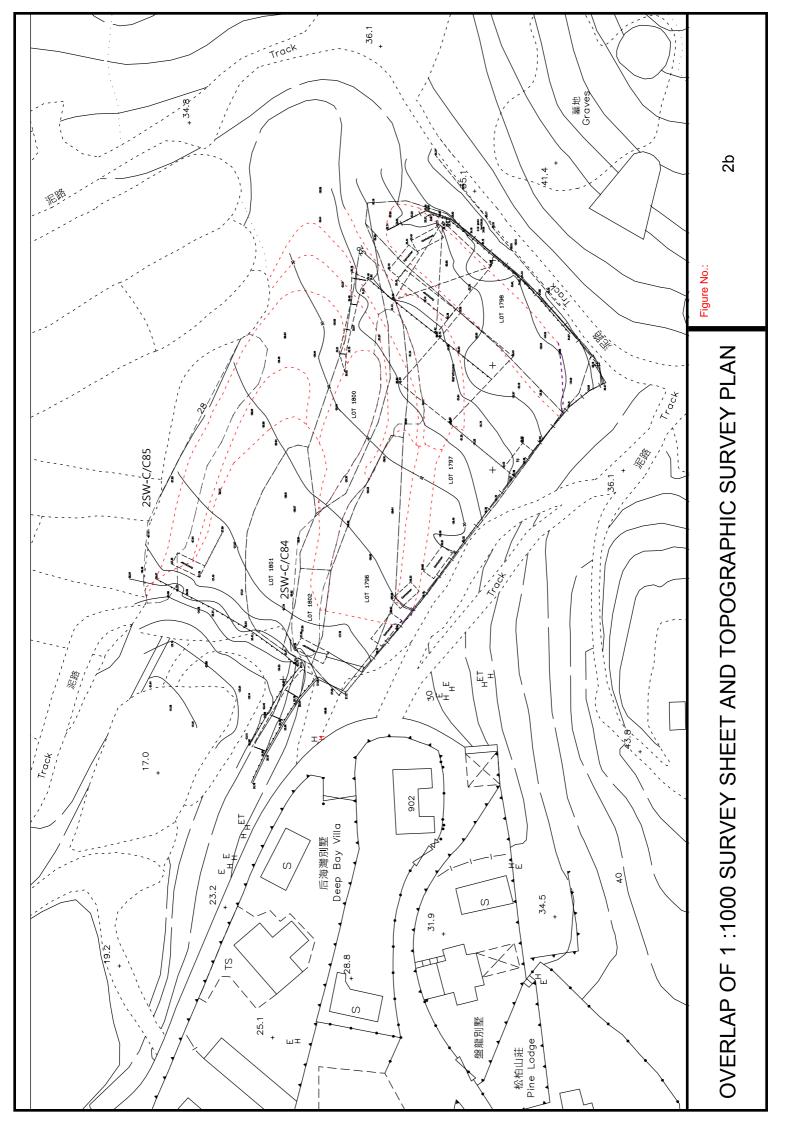


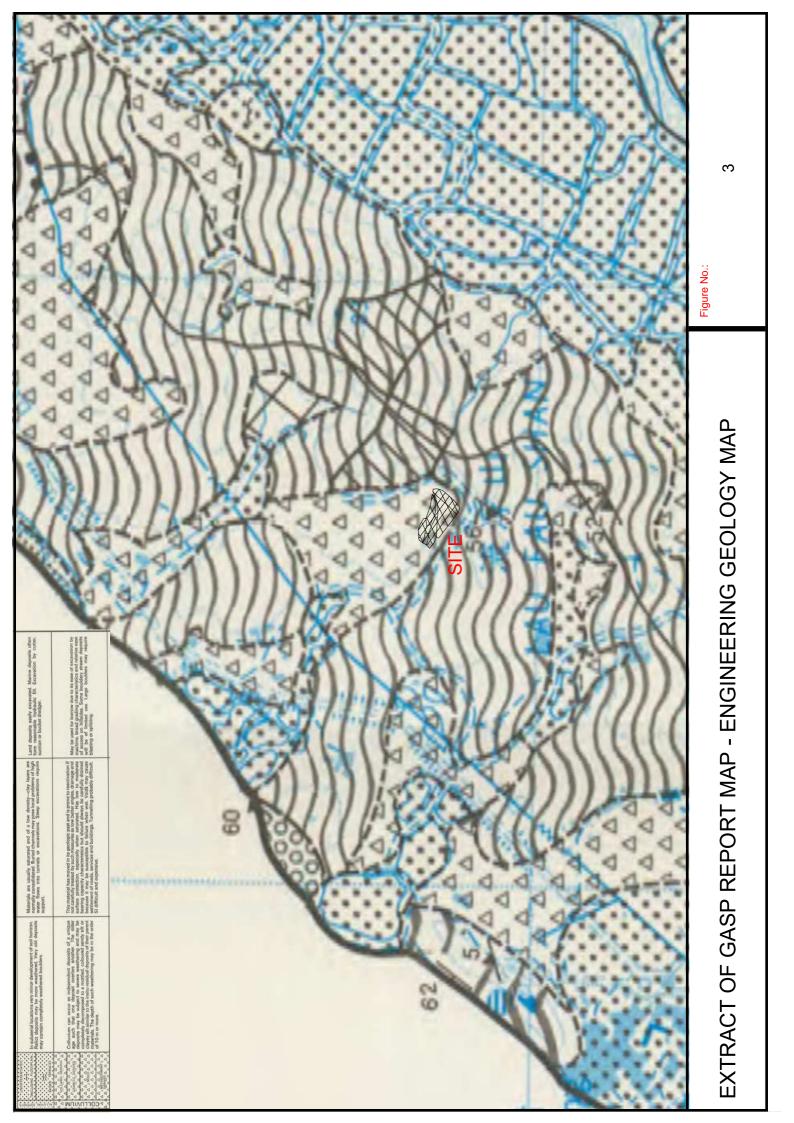


Figure No.:


Figure No.:

2

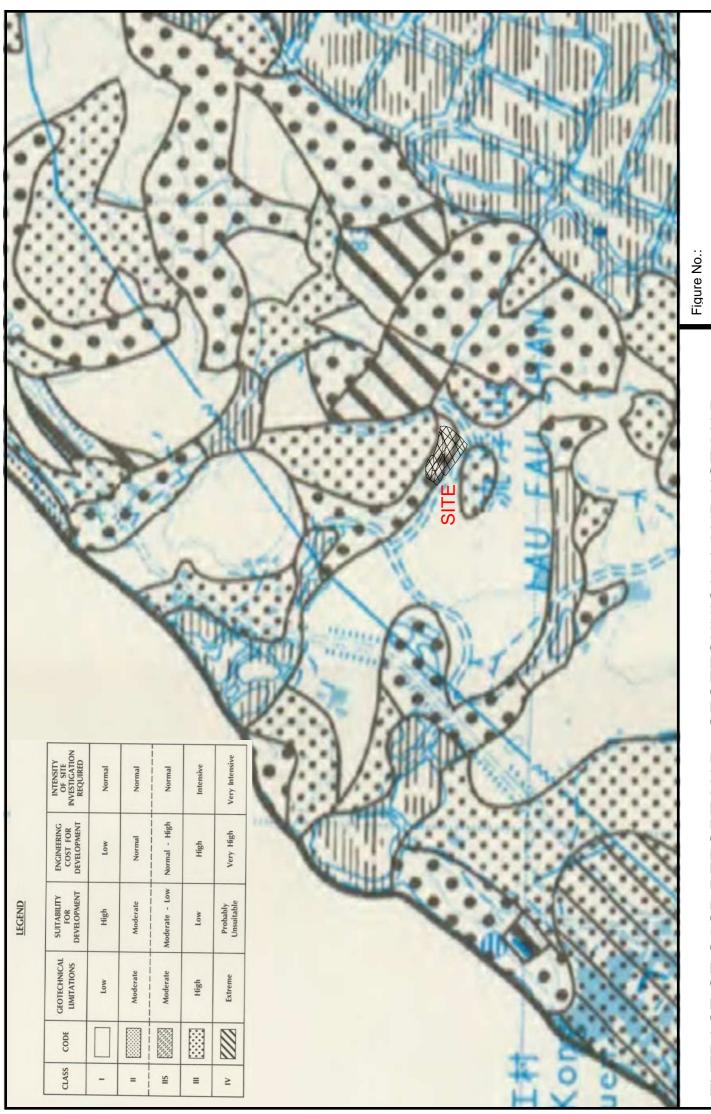

EXTRACT OF GASP REPORT MAP - GEOTECHNICAL LAND USE MAP

9

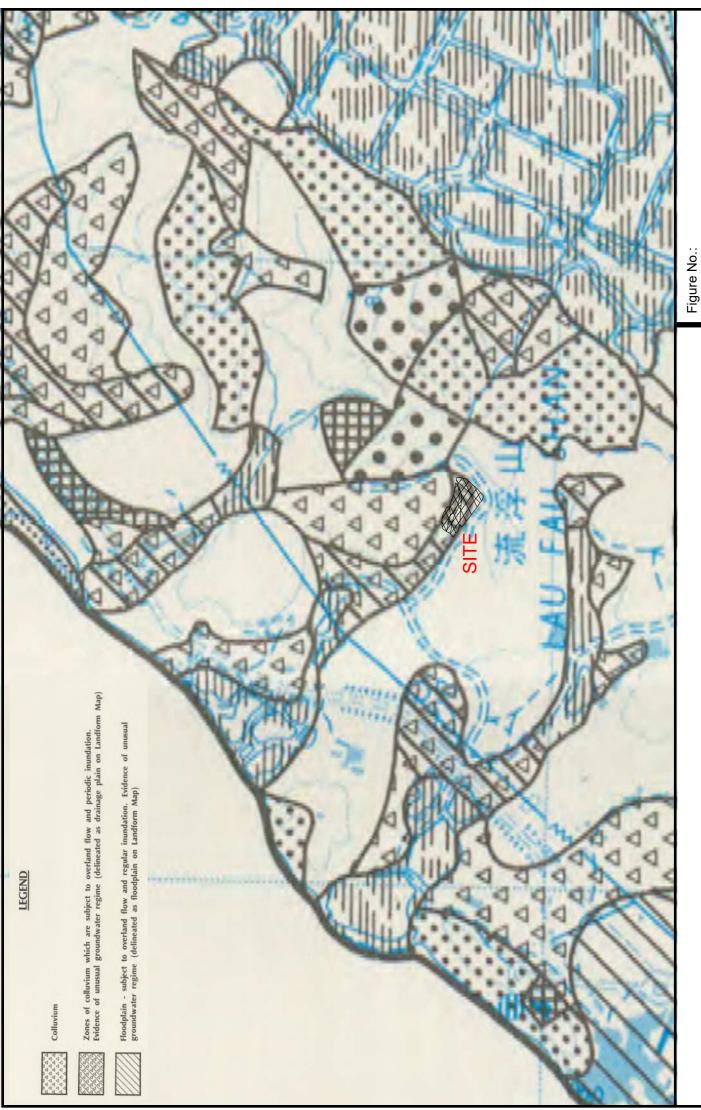


EXTRACT OF GASP REPORT MAP - PHYSICAL CONSTRAINTS MAP

Appendix A

Conceptual Drawings of The Proposed Development

擬議臨時商店及服務行業(園藝及建築材料銷售) 布局圖

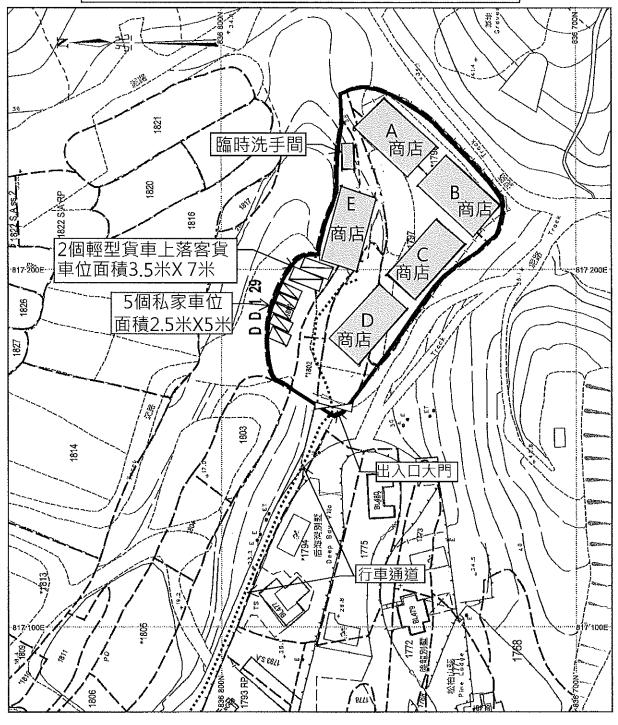

地政總署測繪處

Survey and Mapping Office, Lands Department

比例尺 SCALE 1:1000 ** metres 10 0 10 20 30 40 50 metres



商店

A-E商店每間面積215平方米X高8米(1層) 5間商店合共總樓面面積1075平方米

臨時洗手間面積15平方米高3.5米(1層)

✓ 2個輕型貨車上落客貨車位面積3.5米 X 7米

■ 5個私家車停泊位面積2.5米 X 5米

••••• 行車通道

Appendix B

Site Photographic Records



Plate 1




Plate 2




Plate 3

Appendix C

Location Plan and Slope Maintenance Responsibility

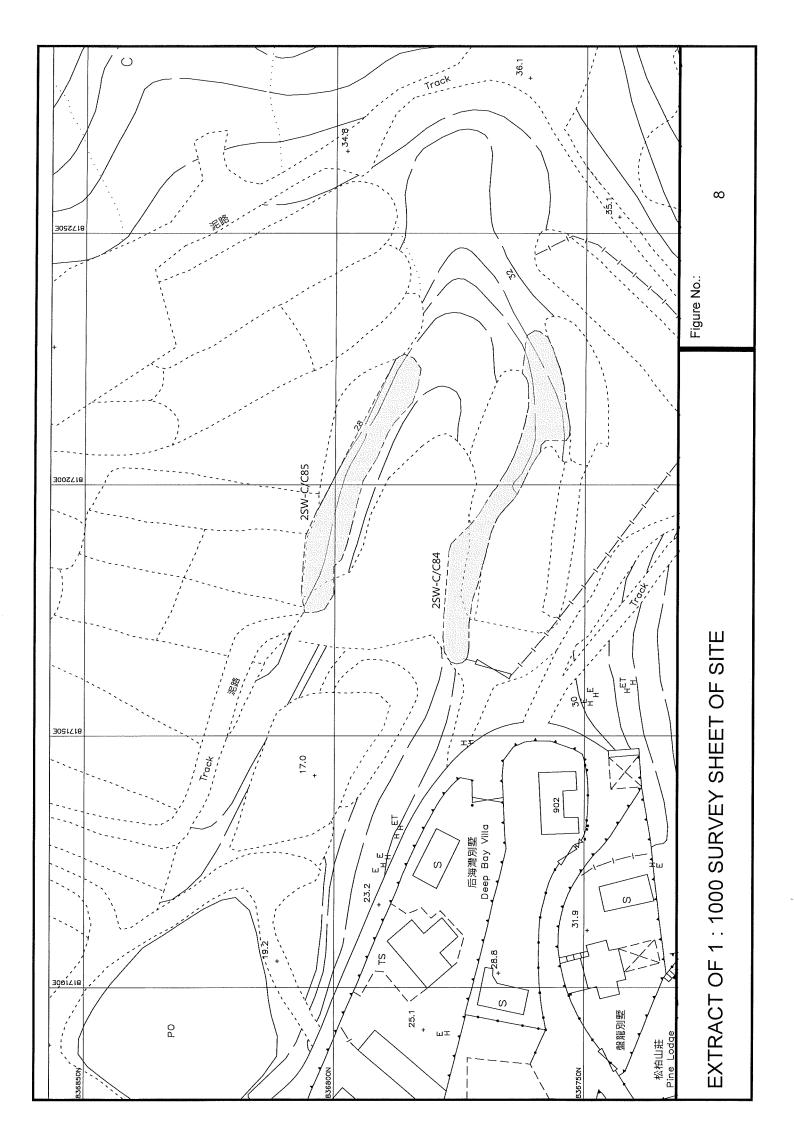

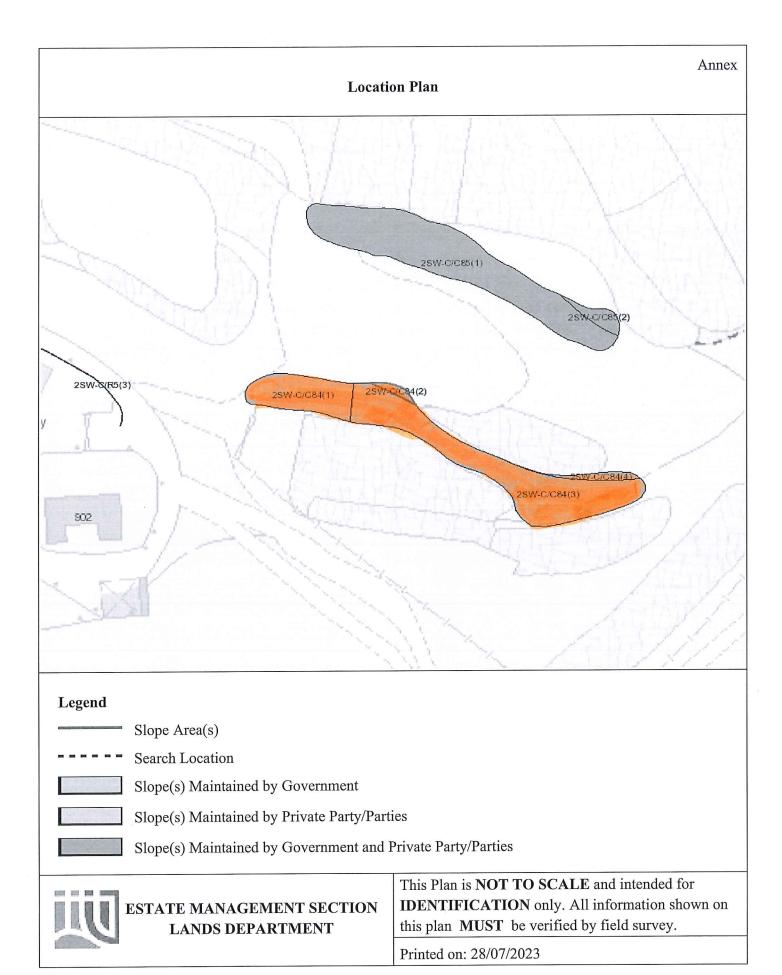

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(2SW-C/C84)



ESTATE MANAGEMENT SECTION LANDS DEPARTMENT

List of Slope Maintenance Responsibility Area(s)

1	2SW-C/C84		Sub-Division	1
	Location	WITHIN DD129 LOTS	1802, 1801, 1800 & ADJOINING (GL
	Responsible Lot/Party DD129 Lot1802		Maintenance Agent	Not Applicable
	Remarks	Not Applicable		

- End of Report -

Notes:

- (i) The location plan in Annex is for identification purposes of slope(s) only.
- (ii) The slope(s) as listed in the Slope Maintenance Responsibility Report may not be shown on the location plan in Annex.

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(2SW-C/C84)



ESTATE MANAGEMENT SECTION LANDS DEPARTMENT

List of Slope Maintenance Responsibility Area(s)

1	2SW-C/C84		Sub-Division	2
	Location WITHIN DD129 LOTS1802, 1		1801, 1800 & ADJOINING C	GL
	Responsible Lot/Party	DD129 Lot1801	Maintenance Agent	Not Applicable
	Remarks Not Applicable			

- End of Report -

Notes:

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- (ii) The slope(s) as listed in the Slope Maintenance Responsibility Report may not be shown on the location plan in Annex.

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(2SW-C/C84)



ESTATE MANAGEMENT SECTION LANDS DEPARTMENT

1

List of Slope Maintenance Responsibility Area(s)

1	2SW-C/C84		Sub-Division	3
	Location WITHIN DD129 LOTS1802, 1		1801, 1800 & ADJOINING C	GL
	Responsible Lot/Party	Lands Department	Maintenance Agent	Lands Department
		For enquiries about the maintenance of this slope / sub-division of the slope, please contact the		
	Remarks	Maintenance Agent directly.		

- End of Report -

Notes:

- (i) The location plan in Annex is for identification purposes of slope(s) only.
- (ii) The slope(s) as listed in the Slope Maintenance Responsibility Report may not be shown on the location plan in Annex.

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(2SW-C/C84)



ESTATE MANAGEMENT SECTION LANDS DEPARTMENT

List of Slope Maintenance Responsibility Area(s)


1	1 2SW-C/C84		Sub-Division 4	
	Location	eation WITHIN DD129 LOTS180		GL
	Responsible Lot/Party	DD129 Lot1800	Maintenance Agent	Not Applicable
	Remarks	Not Applicable		

- End of Report -

Notes:

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(2SW-C/C85)

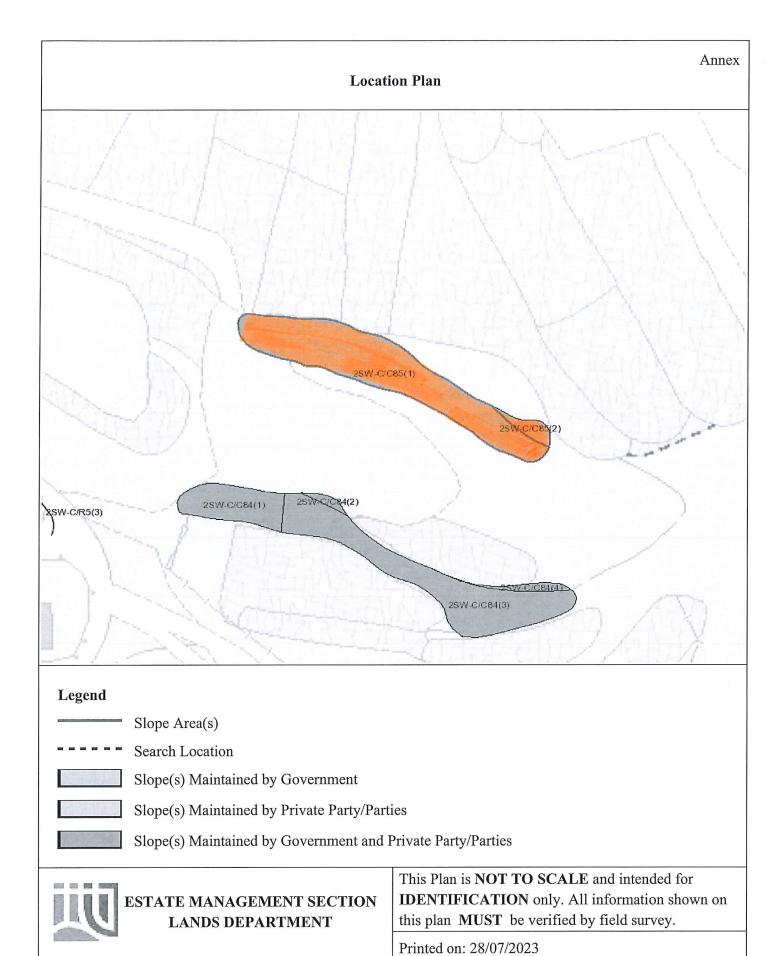

ESTATE MANAGEMENT SECTION LANDS DEPARTMENT

List of Slope Maintenance Responsibility Area(s)

1	2SW-C/C85		Sub-Division	1
	Location	WITHIN DD129 LOT18	N DD129 LOT1817 & ADJOINING GL	
	Responsible Lot/Party	Lands Department	Maintenance Agent	Lands Department
		For enquiries about the maintenance of this slope / sub-division of the slope, please contact the		
	Remarks	Maintenance Agent direct	dy.	


- End of Report -

Notes:

- (i) The location plan in Annex is for identification purposes of slope(s) only.
- (ii) The slope(s) as listed in the Slope Maintenance Responsibility Report may not be shown on the location plan in Annex.


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擬議臨時商店及服務行業(園藝及建築材料銷售) 布局圖

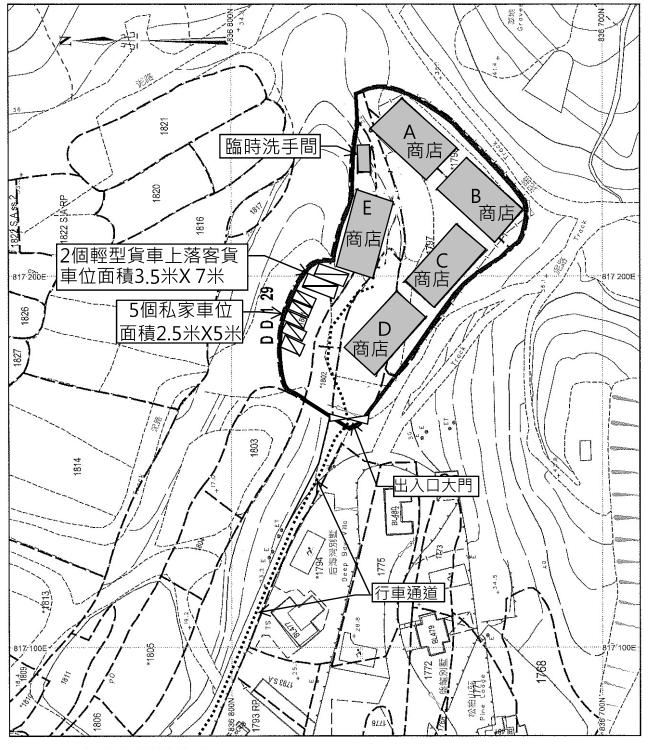

地政總署測繪處

Survey and Mapping Office, Lands Department



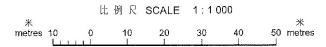

商店

A-E商店每間面積215平方米X高8米(1層) 5間商店合共總樓面面積1075平方米

臨時洗手間面積15平方米高3.5米(1層)

2個輕型貨車上落客貨車位面積3.5米 X 7米

■ 5個私家車停泊位面積2.5米 X 5米

············· 行車通道

雨水排放建議圖 CP1 CL= +32.400 淺灰色為我等預計 450 mm UC 承接雨水範圍面 積約4900平方米 1:100 820 450mmUC 1816 1:100 Start Point **Icharine** CL= +32.700 IL= + 32.550 450mm P.E.Pipe 817 200E 817 200E 450mm UC 現有600mm 1:100 天然排水道 827 CL= +27.200 IL= + 26.600 L= +27.200 1814 Calculation for channels Catchment Area of site Site Catchment Area = 4900 m^2= 0.004900 km^2 Peak runoff in m³/s = 0.278 x 0.95 x 250 mm/hr x 0.004900km² = 0.32352 m³/s = 19411 liter/min ands Department According to (Figure 8.7 - Chart for the Rapid Design of Channels), For gradient 1:100, 450UC will be suitable for ₩ metres

Note:

- 1. Catchpit (CP1-CP3) with desilting facility shall follow CEDD's standard drawing No. C24061.
- 2. Catchpit and UC follows Typical Details of Geotechnical Manual for Slope Fig.8.10 and Fig.8.11 respectively.
- 3. The inverted level of the connection point shall be verified on site prior the commencement of work
- 4.Grating Concrete Cover follows CEDD's standard drawing No. C2412E: U-CHANNELS WITH PRECAST CONCRETE SLABS



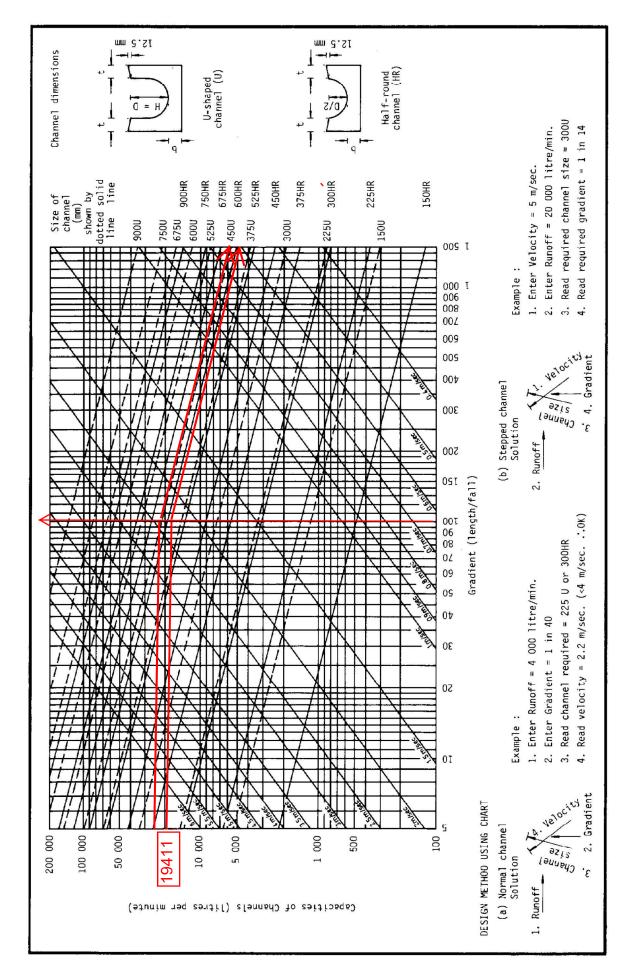


Figure 8.7 - Chart for the Rapid Design of Channels

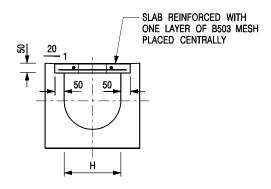

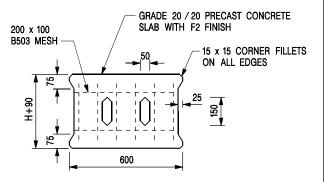



TYPICAL SECTION

PLAN OF SLAB

U-CHANNELS WITH PRECAST CONCRETE SLABS

(UP TO H OF 525)

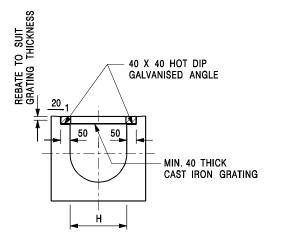

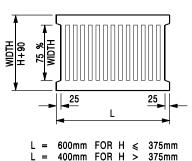

TYPICAL SECTION

CAST IRON GRATING

(DIMENSIONS ARE FOR GUIDANCE ONLY, CONTRACTOR MAY SUBMIT EQUIVALENT TYPE)

U-CHANNEL WITH CAST IRON GRATING

(UP TO H OF 525)

NOTES:

- 1. ALL DIMENSIONS ARE IN MILLIMETRES.
- 2. H=NOMINAL CHANNEL SIZE.
- 3. ALL CAST IRON FOR GRATINGS SHALL BE GRADE EN-GJL-150 COMPLYING WITH BS EN 1561.
- 4. FOR COVERED CHANNELS TO BE HANDED OVER TO HIGHWAYS DEPARTMENT FOR MAINTENANCE, THE GRATING DETAILS SHALL FOLLOW THOSE AS SHOWN ON HyD STD. DRG. NO. H3156.


REF.	REVISION	SIGNATURE	DATE
A CAST IRON GRATING AMENDED.		Original Signed	12.2002
В	B NAME OF DEPARTMENT AMENDED.		01.2005
С	MINOR AMENDMENT. NOTE 3 ADDED.	Original Signed	12.2005
D	NOTE 4 ADDED.	Original Signed	06.2008
Е	NOTES 3 & 4 AMENDED.	Original Signed	12.2014

COVER SLAB AND CAST IRON GRATING FOR CHANNELS



CIVIL ENGINEERING AND DEVELOPMENT DEPARTMENT


SCALE	1:20	DRAWING NO.
DATE	JAN 1991	C2412E

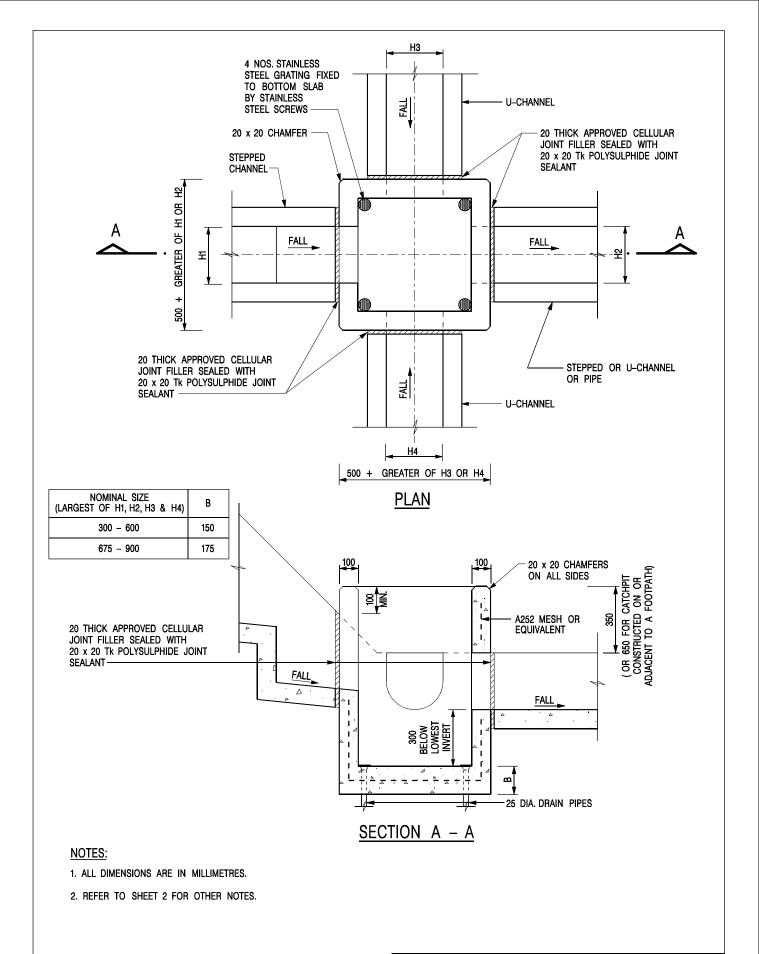

	REF.	REVISION		SIGNATURE	DATE
CATCHPIT WITH TRAP	CIVIL ENGINEER DEVELOPMENT DE			T	
(SHEET 1 OF 2)	SCAL	E 1:20	DRAWII		
(SHEEL LOF 2)	DATE	JAN 1991	C24	406 /1	
			•		

FORMER DRG. NO. C2406J.

Original Signed 03.2015

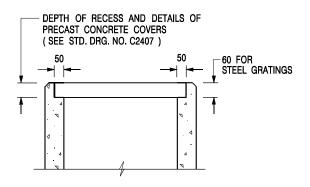

ALTERNATIVE TOP SECTION FOR PRECAST CONCRETE COVERS / GRATINGS

NOTES:

- 1. ALL DIMENSIONS ARE IN MILLIMETRES.
- 2. ALL CONCRETE SHALL BE GRADE 20 /20.
- 3. CONCRETE SURFACE FINISH SHALL BE CLASS U2 OR F2 AS APPROPRIATE.
- 4. FOR DETAILS OF JOINT, REFER TO STD. DRG. NO. C2413.
- 5. CONCRETE TO BE COLOURED AS SPECIFIED.
- 6. UNLESS REQUESTED BY THE MAINTENANCE PARTY AND AS DIRECTED BY THE ENGINEER, CATCHPIT WITH TRAP IS NORMALLY NOT PREFERRED DUE TO PONDING PROBLEM.
- 7. UPON THE REQUEST FROM MAINTENANCE PARTY, DRAIN PIPES AT CATCHPIT BASE CAN BE USED BUT THIS IS FOR CATCHPITS LOCATED AT SLOPE TOE ONLY AND AS DIRECTED BY THE ENGINEER.
- 8. FOR CATCHPITS CONSTRUCTED ON OR ADJACENT TO A FOOTPATH, STEEL GRATINGS (SEE DETAIL 'A' ON STD. DRG. NO. C2405) OR CONCRETE COVERS (SEE STD. DRG. NO. C2407) SHALL BE PROVIDED AS DIRECTED BY THE ENGINEER.
- 9. IF INSTRUCTED BY THE ENGINEER, HANDRAILING (SEE DETAIL 'G' ON STD. DRG. NO. C2405; EXCEPT ON THE UPSLOPE SIDE) IN LIEU OF STEEL GRATINGS OR CONCRETE COVERS CAN BE ACCEPTED AS AN ALTERNATIVE SAFETY MEASURE FOR CATCHPITS NOT ON A FOOTPATH NOR ADJACENT TO IT. TOP OF THE HANDRAILING SHALL BE 1 000 mm MIN. MEASURED FROM THE ADJACENT GROUND LEVEL.
- 10. MINIMUM INTERNAL CATCHPIT WIDTH SHALL BE 1 000 mm FOR CATCHPITS WITH A HEIGHT EXCEEDING 1 000 mm MEASURED FROM THE INVERT LEVEL TO THE ADJACENT GROUND LEVEL. AND, STEP IRONS (SEE DSD STD. DRG. NO. DS1043) AT 300 c/c STAGGERED SHALL BE PROVIDED. THICKNESS OF CATCHPIT WALL FOR INSTALLATION OF STEP IRONS SHALL BE INCREASED TO 150 mm.
- 11. FOR RETROFITTING AN EXISTING CATCHPIT WITH STEEL GRATING, SEE DETAIL 'F' ON STD. DRG. NO. C2405.
- 12. SUBJECT TO THE APPROVAL OF THE ENGINEER, OTHER MATERIALS CAN ALSO BE USED AS COVERS / GRATINGS.

FORMER DRG. NO. C2406J. Original Signed | 03.2015 REF. REVISION SIGNATURE DATE CIVIL ENGINEERING AND CATCHPIT WITH TRAP CEDD **DEVELOPMENT DEPARTMENT** DRAWING NO. **SCALE** 1:20

DATE

JAN 1991

C2406 /2

(SHEET 2 OF 2)

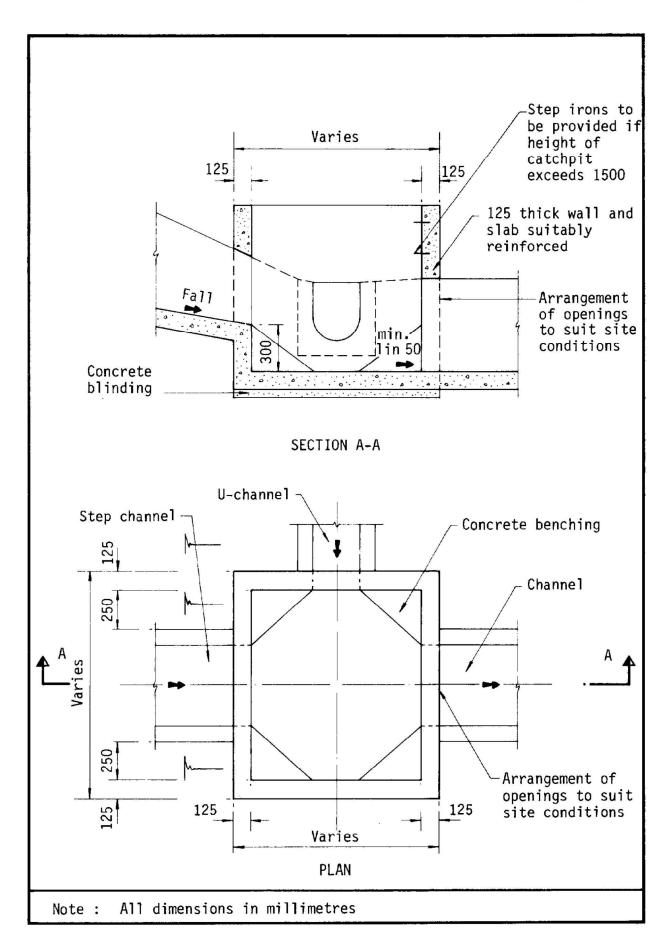


Figure 8.10 - Typical Details of Catchpits


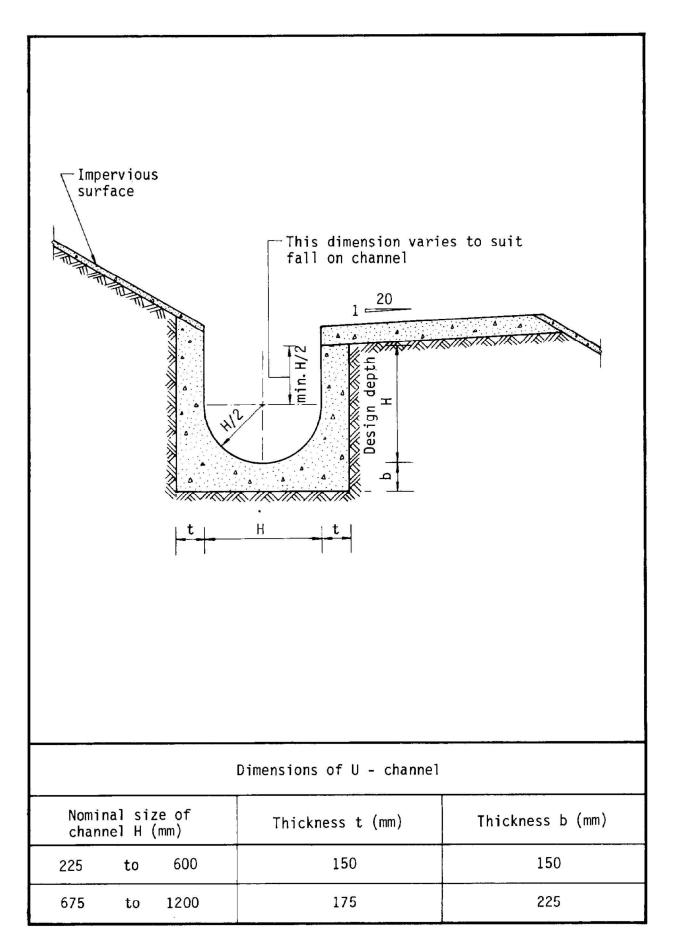



Figure 8.11 - Typical U-channel Details

申請地點位置圖

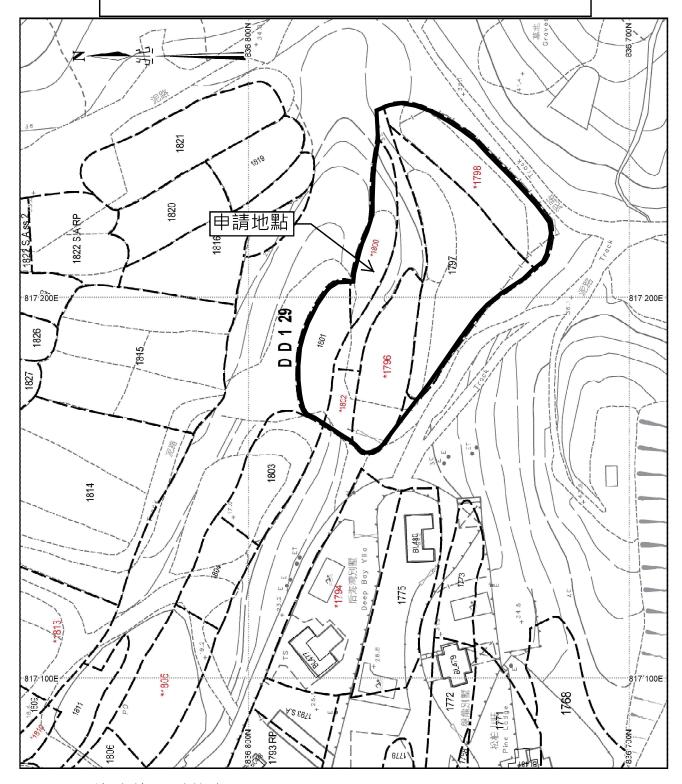

地政總署測繪處

Survey and Mapping Office, Lands Department

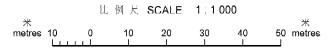



致 城市規劃委員會

- 1. 有關上述申請,我等將申請地點的構築物分為 5 個,每個 215 平方米,皆 因應消防條例所限,因上述建設全部為臨時性質,可以減小建設成本,。
- 2. 所有構築物全部為本公司所用,沒有分租給第3者。
- 3. 我等位於唐人新村舊址 (即 DD122 (GLA/TYL3940)請看附件舊地址位置圖) 都係經營農業工具(包括沙鏟,泥爬,水喉,水桶,洒水裝備),種子銷售及 建築材料銷售 (搭建溫室使用的鋼架及配件,防晒網,和小五金),現向貴 會申請用途亦為上述用途,最主要係皆因政府收回我等現時使用的場地而 被逼搬遷,而上述申請地點在規劃許可第二欄內,可申請臨時改作商店及 服務行業,因此我等才作出是次申請。

此致

代理人 Wong sun wo 18-10-2023

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TPB/A/YL-LFS/495

Comments from the Antiquities and Monuments Office

Please confirm / clarify if there is any ground excavation proposed for the temporary shop and services (selling gardening supplies and construction materials), including but not limited to site formation works, foundation works, building works, drainage works, etc. If affirmative, the applicant is required to provide details of the proposed works, e.g. the location, extent and depth of the proposed ground excavation and so on for the further comment of the Antiquities and Monuments Office.

有關古跡辦的提問,我等回應如下:

- 1. 如獲得批准,我等的臨建築物全部以臨時物料搭建,及只有 1 層高,因此不須要建造地基因此我等不會進行挖掘泥土的工序,平整地盤及地基工程。
- 如獲批准我等會進行排水工程,將會在申請範圍的周邊建設排水渠,而有關排水渠的深度 約為 0.15 米至 0.6 米以內,跟據地基波幅計算,挖掘的深度不會超過 0.6 米,渠面闊度約為 0.45 米(請看附件雨水排放建議圖)

代理人 黃新和

21-11-2023

雨水排放建議圖 CP1 CL= +32.400 淺灰色為我等預計 450 mm UC 承接雨水範圍面 積約4900平方米 1:100 820 450mmUC 1816 1:100 Start Point **Icharine** CL= +32.700 IL= + 32.550 450mm P.E.Pipe 817 200E 817 200E 450mm UC 現有600mm 1:100 天然排水道 827 CL= +27.200 IL= + 26.600 L= +27.200 1814 Calculation for channels Catchment Area of site Site Catchment Area = 4900 m^2= 0.004900 km^2 Peak runoff in m³/s = 0.278 x 0.95 x 250 mm/hr x 0.004900km² = 0.32352 m³/s = 19411 liter/min ands Department According to (Figure 8.7 - Chart for the Rapid Design of Channels), For gradient 1:100, 450UC will be suitable for ₩ metres

Note:

- 1. Catchpit (CP1-CP3) with desilting facility shall follow CEDD's standard drawing No. C24061.
- 2. Catchpit and UC follows Typical Details of Geotechnical Manual for Slope Fig.8.10 and Fig.8.11 respectively.
- 3. The inverted level of the connection point shall be verified on site prior the commencement of work
- 4.Grating Concrete Cover follows CEDD's standard drawing No. C2412E: U-CHANNELS WITH PRECAST CONCRETE SLABS

Previous s.16 Application covering the Application Site

Rejected Applications

	Application No.	Proposed Use	Zoning	Date of	Rejection
				Consideration	Reasons
				(RNTPC)	
1	A/YL-LFS/351	Temporary Private Vehicle Park and	REC	18.9.2020	(1) & (2)
		Open Storage (Dump Truck and Skip			
		Truck) for a period of 3 years			
2	A/YL-LFS/400	Proposed Temporary Open Storage	REC	25.6.2021	(1) & (2)
		(Dump Box) for a Period of 3 Years			

Rejection Reasons

- 1. Not in line with the planning intention.
- 2. Not in line with TPB PG-13F

Similar s.16 Applications in the vicinity of the Site within the same "REC" Zone on the Lau Fau Shan and Tsim Bei Tsui OZP

Approved Applications

	Application No.	Proposed Use(s)/	Date of Consideration
		<u>Development(s)</u>	(RNTPC)
1	A/YL-LFS/330	Proposed Temporary Shop	4.1.2019
		and Service (Retail of Family Goods)	(Revoked on 4.4.2021)
		with Ancillary Office	
		for a Period of 3 Years	
2	A/YL-LFS/370	Proposed Temporary Shop and Services	9.10.2020
		(Selling of Radio Controlled Cars and	(Revoked on 17.5.2022)
		Accessories) for a Period of 3 Years	
3	A/YL-LFS/374	Proposed Temporary Shop and Services	20.11.2020
		(Retail of Family Goods) with Ancillary	(Revoked on 28.2.2023)
		Office for a Period of 3 Years	
4	A/YL-LFS/406	Proposed Temporary Shop and Services	24.9.2021
		(Shop for Selling Hardware Accessories)	(Revoked on 24.3.2022)
		for a Period of 3 Years	
5	A/YL-LFS/420	Proposed Temporary Shop and Services	6.5.2022
		(Shop for Selling Hardware Accessories)	
		for a Period of 3 Years	

Government Departments' General Comments

1. Land Administration

Comments of the District Lands Officer/Yuen Long, Lands Department (DLO/YL, LandsD):

He has no adverse comment on the application.

2. Environment

Comments of the Director of Environmental Protection (DEP):

- (a) He has no adverse comment on the application from environmental planning perspective since no heavy vehicle or dusty operation would be involved.
- (b) There is no substantiated environmental complaint pertaining to the Site in the past three years.
- (c) Should the application be approved, please consider advising or imposing the following requirements:
 - (i) no vehicle exceeding 5.5 tonnes, including medium goods vehicle, heavy goods vehicle and container trailer/tractor, as defined in the Road Traffic Ordinance, is allowed to enter/exit or to be parked/stored on the Site at any time during the planning approval period; and
 - (ii) sewage from the toilet shall be collected by reputable waste collectors regularly and disposed of properly.
- (d) The applicant should note his advisory comments at **Appendix IV**.

3. Landscaping

Comments of the Chief Town Planner/Urban Design and Landscape, Planning Department (CTP/UD&L, PlanD):

- (a) She has no comment on the application from landscape planning perspective.
- (b) The Site is situated in area of miscellaneous rural fringe predominated by temporary structures, open storages, graveyard and scattered tree groups. The Site was hard paved and occupied by temporary structures and open storages. Further significant landscape impact on existing landscape resources within the applied use is not anticipated.
- (c) Similar applications have been approved within the same "Recreation" zone. The proposed use is considered not incompatible to the landscape character of the surrounding area.

4. Drainage

Comments of the Chief Engineer/Mainland North, Drainage Services Department (CE/MN, DSD):

- (a) He has no objection in principle to the application from drainage point of view.
- (b) Should the Board consider that the application is acceptable from planning point of view, a condition should be stipulated requiring the applicant to submit a revised drainage proposal, and to implement and maintain the proposed drainage facilities to his satisfaction.
- (c) The applicant should note his detailed comments on the submitted drainage proposal at **Appendix IV**.

5. Slope Safety

Head of Geotechnical Engineering Office, Civil Engineering and Development Department (H(GEO), CEDD)

- (a) With reference to the topograpgic survey plan enclosed in the Geotechnical Planning Review Report (GPRR), he has no adverse geotechnical comments on the application.
- (b) Nevertheless, it is noted from the GPRR that feature No. 2SW-C/C84, which falls within Lot 1800 to 1802 in D.D.129 and the adjoining Government land, have been modified by land filling works.
- (c) The applicant should note his advisory comments at **Appendix IV**.

6. Fire Safety

Comments of the Director of Fire Services (D of FS):

- (a) He has no objection in principle to the proposal subject to fire service installations (FSIs) being provided to his satisfaction.
- (b) The applicant should note his advisory comments at **Appendix V**.

7. Others

Comments of the Executive Secretary (Antiquities & Monuments), Antiquities and Monuments Office, Development Bureau (ES(AM), AMO, DEVB):

- (a) The Site is situated within Lau Fau Shan Site of Archaeological Interest.
- (b) After reviewing the location and scope of the proposed works, AMO has no objection in principle to the application from both the archaeological and built heritage conservation perspectives.
- (c) Notwithstanding, the applicant is required to inform AMO immediately when any antiquities or supposed antiquities under the Antiquities and Monuments Ordinance

(Cap. 53) are discovered in the course of works.

8. District Officer's Comments

Comments of the District Officer (Yuen Long), Home Affairs Department (DO(YL), HAD):

He has not received any feedback from locals.

9. Other Departments' Comments

The following government departments have no objection to/no comment on the application:

- (a) Chief Building Surveyor/New Territories West, Buildings Department (CBS/NTW, BD);
- (b) Chief Engineer/Construction, Water Supplies Department (CE/C, WSD);
- (c) Chief Engineer/Land Works (CE/LW), CEDD;
- (d) Project Manager (West) (PM(W)), CEDD;
- (e) Chief Highway Engineer/New Territories West, Highways Department (CHE/NTW, HyD);
- (f) Commissioner of Police (C of P);
- (g) Commissioner for Transport (C for T); and
- (h) Director of Agriculture, Fisheries and Conservation (DAFC).

Recommended Advisory Clauses

- (a) the planning permission is given to the development/use under application. It does not condone any other development/use (i.e. open storage) which currently exists on the application site (the Site) but not covered by the application. Immediate action should be taken to discontinue such development/use not covered by the permission;
- (b) to resolve any land issues relating to the development with the concerned owner(s) of the Site;
- (c) to note the comments of the District Lands Officer/Yuen Long, Lands Department (DLO/YL, LandsD) that:
 - (i) the Site comprises Old Schedule Agricultural Lots held under the Block Government Lease which contains the restriction that no structures are allowed to be erected without the prior approval of the Government, and the Government Land (GL);
 - (ii) no permission is given for occupation of GL (about 370m² subject to verification) included in the Site. Any occupation of GL without Government's prior approval is not allowed;
 - (iii) the owner of the lot will need to apply to DLO/YL, LandsD for permitting the structures to be erected or to regularise any irregularities on-site, if any. Also, the applicant has to either exclude the GL from the Site or immediately apply for a formal approval prior to actual occupation of GL. Besides, given the proposed use is temporary in nature, only application for regularisation or erection of temporary structure(s) will be considered. Application(s) for any of the above will be considered by LandsD acting in the capacity of the landlord or lessor at its sole discretion and there is no guarantee that such application(s) will be approved. If such application(s) is approved, it will be subject to such terms and conditions, including among others the payment of rent or fee, as may be imposed by LandsD.
- (d) to note the comments of the Commissioner for Transport (C for T) that sufficient manoeuvring space shall be provided within the Site. No vehicles are allowed to queue back to public roads or reverse onto/from public roads. The local track leading to the Site is not under Transport Department's purview. The applicant shall obtain consent of the owners/managing departments of the local track for using it as the vehicular access to the Site:
- (e) to note the comments of the Chief Highway Engineer/New Territories West, Highways Department (CHE/NTW, HyD) that adequate drainage measures shall be provided to prevent surface water running from the Site to the nearby public roads and drains. The access road connecting the Site with Deep Bay Road is not and will not be maintained by HyD. HyD should not be responsible for maintaining any access connecting the Site and Deep Bay Road;
- (f) to note the comments of the Director of Environmental Protection (DEP) to follow the relevant mitigation measures and requirements in the revised "Code of Practice on Handling the Environmental Aspects of Temporary Uses and Open Storage Sites" to minimise any potential environmental nuisance. Sewage from the temporary toilets shall be collected by reputable waste collectors regularly and disposed of properly;

- (g) to note the comments of the Chief Engineer/Mainland North, Drainage Services Department (CE/MN, DSD) on the submitted drainage proposal:
 - (i) please demonstrate with hydraulic calculation that the proposed drainage facilities are adequate to collect, convey and discharge the surface runoff accrued on the Site and the overland flow intercepted from the adjacent lands especially the area at the southern side of the Site as the level of that is significantly higher than the Site;
 - (ii) please indicate the full alignment of the discharge path from the Site all the way down to the ultimate discharge point (e.g. a well-established stream course/public drainage system);
 - (iii) the existing nullah/channel/watercourse, to which the applicant proposed to discharge the stormwater from the Site is not clearly shown in the drainage proposal;
 - (iv) further to (ii) and (iii) above, since there is no record of the said discharge path, please provide site photos to demonstrate its presence and existing condition;
 - (v) the cover levels and invert levels of the proposed U-channels, catchpits/sand traps should be shown on the drainage plan;
 - (vi) cross sections showing the existing and proposed ground levels of the Site with respect to the adjacent areas should be given;
 - (vii) sand trap or provision alike should be provided before the collected runoff is discharged to the public drainage facilities;
 - (viii) standard details should be provided to indicate the sectional details of the proposed U-channel and the catchpit/sand trap;
 - (ix) where walls and hoarding are erected along the site boundary, adequate opening should be provided to intercept the existing overland flow passing through the Site;
 - (x) the development should neither obstruct overland flow nor adversely affect existing natural streams, village drains, diches and the adjacent areas, etc.; and
 - (xi) the applicant should consult DLO/YL of LandsD and seek consent from the relevant owners for any drainage works to be carried out outside his lot boundary before commencement of the drainage works;
- (h) to note the comments of the Head of Geotechnical Engineering Office, Civil Engineering and Development Department (H(GEO), CEDD) that feature No. 2SW-C/C84, which falls within Lot No. 1800 to 1802 in D.D.129 and adjoining Government land, have been modified by land filling works. H(GEO), CEDD has no record of the filling works. The applicant shall be reminded of the requirements of making necessary site formation submission(s), including but not limited to any necessary stability assessments on existing/proposed geotechnical features within or in the vicinity of the Site, to the Buildings Department (BD) for approval as required under the provision of Buildings Ordinance;

- (i) to note the comments of the Director of Fire Services (D of FS) that in consideration of the design/nature of the proposal, fire service installations (FSIs) are anticipated to be required. Therefore, the applicant is advised to submit relevant layout plans incorporated with the proposed FSIs to the Fire Services Department (FSD) for approval. The layout plans should be drawn to scale and depicted with dimensions and nature of occupancy. The location of the proposed FSI to be installed should be clearly marked on the layout plans. If the proposed structures are required to comply with the Buildings Ordinance (BO) (Cap. 123), detailed fire service requirements will be formulated upon receipt of formal submission of general building plans;
- (j) to note the comments of the Chief Building Surveyor/New Territories West (CBS/NTW), BD that:
 - (i) the Site shall be provided with means of obtaining access thereto from a street and emergency vehicular access in accordance with Regulations 5 and 41D of the Building (Planning) Regulations (B(P)R) respectively;
 - (ii) the Site does not abut on a specified street of not less than 4.5m wide and its permitted development intensity shall be determined under Regulation 19(3) of the B(P)R at the building plan submission stage;
 - (iii) before any new building works (including containers/open sheds as temporary buildings, demolition and land filling, etc.) are to be carried out on the Site, prior approval and consent of Building Authority (BA) should be obtained, otherwise they are unauthorized building works (UBW) under the BO. An Authorized Person should be appointed as the co-ordinator for the proposed building works in accordance with the BO;
 - (iv) for UBW erected on leased land, enforcement action may be taken by BD to effect their removal in accordance with the prevailing enforcement policy against UBW as and when necessary. The granting of any planning approval should not be construed as an acceptance of any existing building works or UBW on the Site under BO;
 - (v) any temporary shelters or converted containers for office, storage, washroom or other uses that are considered as temporary buildings and are subject to the control of Part VII of the B(P)R; and
 - (vi) detailed checking under the BO will be carried out at building plan submission stage; and
- (k) to note the comments of the Executive Secretary (Antiquities & Monuments), Antiquities and Monuments Office, Development Bureau (ES(AM), AMO, DEVB) that the Site is situated within Lau Fau Shan Site of Archaeological Interest. The applicant is required to inform AMO immediately when any antiquities or supposed antiquities under the Antiquities and Monuments Ordinance (Cap. 53) are discovered in the course of works.

Urgent	Return Receipt Requested	☐ Sign ☐ Encryp	t Mark Subject Restricted	☐ Expand personal&publi



A/YL-LFS/495 DD 129 Lau Fau Shan Recreation

10/11/2023 02:28

From:

To: File Ref: tpbpd <tpbpd@pland.gov.hk>

Dear TPB Members,

458 withdrawn. Objections are relevant and upheld.

Application should be rejected.

Mary Mulvihill

From:

To: tpbpd <tpbpd@pland.gov.hk>

Date: Wednesday, 15 March 2023 1:40 AM HKT

Subject: A/YL-LFS/458 DD 129 Lau Fau Shan Recreation

A/YL-LFS/458

Lots 1796, 1797, 1798, 1800, 1801 and 1802 and Adjoining Government Land in D.D. 129, Lau Fau Shan

Site area: 3,355sq.m Includes Government Land of about 370sq.m

Zoning: "Recreation"

Applied use: Shop and Services (Garden Supplies and Construction Materials) / 7 Vehicle Parking / 5 Years

Dear TPB Members,

Application 400 was rejected on 25 June 2021 but the open storage operations have continued.

The footprint of the current application is part of 400 with some additional lots and Government Land.

That this is an application for Open Storage under the guise of shop is evident.

Members should reject again for the same reasons.

Mary Mulvihill

From:

To: tpbpd <tpbpd@pland.gov.hk>

Date: Sunday, 30 May 2021 4:16 AM CST

Subject: A/YL-LFS/400 DD 129 Lau Fau Shan Recreation

Dear TPB Members,

351 was rejected so now its back with "Dump Box', presumably open storage of containers.

The application did not meet the Town Planning Board Guidelines No. 13F in that the site fell within Category 3 areas. The site was not subject to any previous planning approval and there were adverse departmental comments. The Environmental Protection Department, Transport Department, Drainage Services Department and Urban Design and Landscape Unit of PlanD did not support/had reservation on the application as the applicant failed to demonstrate that the applied use would not have adverse environmental, traffic, drainage and landscape impacts. Seven similar applications within the same "REC" zone were rejected, and the circumstances of the current application were similar to those rejected applications. Rejection of the current application was in line with the Committee's previous decisions.

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currently partly hard-paved and partly covered with soil/gravel. Part of the Site is used for parking/open storage of dump trucks and skip trucks without valid planning permission

Has enforcement action been initiated? If not why not?

Mary Mulvihill

From:

To: "tpbpd" <tpbpd@pland.gov.hk>

Sent: Thursday, August 27, 2020 3:03:30 AM

Subject: Re: A/YL-LFS/351 DD 129 Lau Fau Shan Recreation

Dear TPB Members,

Almost one year later.

There is clearly no need for a vehicle park as there are only a few private residences in the district.so it is effectively open storage.

As there is no history of previous approval for this use then the application has no merit no matter how many reports are submitted.

Mary Mulvihill

From:

To: "tpbpd" <tpbpd@pland.gov.hk>

Sent: Saturday, November 23, 2019 4:13:50 AM

Subject: A/YL-LFS/351 DD 129 Lau Fau Shan Recreation

A/YL-LFS/351

Lots 1796, 1798, 1802, 1803, 1804, 1805 and 1806 in D.D. 129, Lau Fau Shan

Site area: 3,104.7sq.m Zoning: "Recreation"

Applied use: 52 Vehicle Park and Open Storage

Dear TPB Members,

Open Storage on land zoned Recreation is absolutely unacceptable. The site is still relatively vegetated. There are a number of residences in the vicinity.

Members cannot approve a plan that would trash the land and create yet another brownfield in this already heavily polluted area.

Mary Mulvihill