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This document is received on

The Town Planning Board will formally acknowledge
the date of receipt of the application only upon receipt
of all the required information and documents.

<u>Form No. S16-I</u> 表格第 S16-I 號

APPLICATION FOR PERMISSION

UNDER SECTION 16 OF

THE TOWN PLANNING ORDINANCE

(CAP.131)

根據《城市規劃條例》(第131章) 第16條號交的許可申請

Applicable to proposals not involving or not only involving: 適用於建議不涉及或不祇涉及:

- (i) Construction of "New Territories Exempted House(s)"; 興建「新界豁免管制屋宇」;
- (ii) Temporary use/development of land and/or building not exceeding 3 years in rural areas; and 位於鄉郊地區土地上及/或建築物內進行為期不超過三年的臨時用途/發展;及
- (iii) Renewal of permission for temporary use or development in rural areas 位於鄉郊地區的臨時用途或發展的許可續期

Applicant who would like to publish the <u>notice of application</u> in local newspapers to meet one of the Town Planning Board's requirements of taking reasonable steps to obtain consent of or give notification to the current land owner, please refer to the following link regarding publishing the notice in the designated newspapers: https://www.info.gov.hk/tpb/en/plan_application/apply.html

申請人如欲在本地報章刊登<u>申請通知</u>,以採取城市規劃委員會就取得現行土地擁有人的同意或通知現行土地擁有人所指定的其中一項合理步驟,請瀏覽以下網址有關在指定的報章刊登通知: https://www.info.gov.hk/tpb/tc/plan_application/apply.html

General Note and Annotation for the Form 項寫表格的一般指引及註解

- "Current land owner" means any person whose name is registered in the Land Registry as that of an owner of the land to which the application relates, as at 6 weeks before the application is made 「現行土地擁有人」指在提出申請前六星期,其姓名或名稱已在土地註冊處註冊為該申請所關乎的土地的擁有人的人
- & Please attach documentary proof 請夾附證明文件
- ^ Please insert number where appropriate 請在適當地方註明編號

Please fill "NA" for inapplicable item 請在不適用的項目填寫「不適用」

Please use separate sheets if the space provided is insufficient 如所提供的空間不足,請另頁說明

Please insert a 「 v 」 at the appropriate box 請在適當的方格內上加上「 v 」 號

2301658 - 15.6 2023 By H

For Official Use Only 請勿填寫此欄 Application No. 申請編號 カ/ツレールシル / 3 门 Date Received 收到日期 **2** ① JUN 73:3

- The completed form and supporting documents (if any) should be sent to the Secretary, Town Planning Board (the Board), 15/F, North Point Government Offices, 333 Java Road, North Point, Hong Kong.
 申請人須把填妥的申請表格及其他支持申請的文件(倘有),送交香港北角渣華道 333 號北角政府合署 15 樓城市規劃委員會(下稱「委員會」)秘書收。
- 2. Please read the "Guidance Notes" carefully before you fill in this form. The document can be downloaded from the Board's website at http://www.info.gov.hk/tpb/. It can also be obtained from the Secretariat of the Board at 15/F, North Point Government Offices, 333 Java Road, North Point, Hong Kong (Tel: 2231 4810 or 2231 4835), and the Planning Enquiry Counters of the Planning Department (Hotline: 2231 5000) (17/F, North Point Government Offices, 333 Java Road, North Point, Hong Kong and 14/F, Sha Tin Government Offices, 1 Sheung Wo Che Road, Sha Tin, New Territories). 請先細閱《申請須知》的資料單張,然後填寫此表格。該份文件可從委員會的網頁下載(網址: http://www.info.gov.hk/tpb/),亦可向委員會秘書處(香港北角渣華道 333 號北角政府合署 15 樓 電話: 2231 4810 或 2231 4835)及規劃署的規劃資料查詢處(熱線: 2231 5000) (香港北角渣華道 333 號北角政府合署 17 樓及新界沙田上禾輋路 1 號沙田政府合署 14 樓)索取。
- 3. This form can be downloaded from the Board's website, and obtained from the Secretariat of the Board and the Planning Enquiry Counters of the Planning Department. The form should be typed or completed in block letters. The processing of the application may be refused if the required information or the required copies are incomplete.

 此表格可從委員會的網頁下載,亦可向委員會秘書處及規劃署的規劃資料查詢處索取。申請人須以打印方式或以正楷填寫表格。如果申請人所提交的資料或文件副本不齊全,委員會可拒絕處理有關申請。

1.	Name of Applicant	申請人姓名/名稱
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(□Mr. 先生 /□Mrs. 夫人 /□Miss 小姐 /□Ms. 女士 / 🗹 Company 公司 /□ Organisation 機構)

Top Grow (HK) Development Limited 溢昇(香港)發展有限公司

2. Name of Authorised Agent (if applicable) 獲授權代理人姓名/名稱(如適用)

(□Mr. 先生 /□Mrs. 夫人 /□Miss 小姐 /□Ms. 女士 / ☑ Company 公司 /□ Organisation 機構)

R-riches Property Consultants Limited 盈卓物業顧問有限公司

3.	Application Site 申請地點	
(a)	Full address / location / demarcation district and lot number (if applicable) 詳細地址/地點/丈量約份及地段號碼(如適用)	Lots 3540 S.B ss.1 (Part), 3540 S.B ss. 2, 3540 S.B ss. 3, 3540 S.B ss.4, 3540 S.B ss. 5, 3540 S.B ss. 6 (Part), 3540 S.B RP (Part), 3559 S.A, 3559 S.B and 3559 RP in D.D. 104, Pok Wai, Yuen Long, New Territories
(b)	Site area and/or gross floor area involved 涉及的地盤面積及/或總樓面面 積	☑Site area 地盤面積 1,023 sq.m 平方米☑About 約 □Gross floor area 總樓面面積 N/A sq.m 平方米□About 約
(c)	Area of Government land included (if any) 所包括的政府土地面積(倘有)	N/A sq.m 平方米 □About 約

(d)	Name and number of the statutory plan(s) 有關法定圖則的名稱及編	Approved Nam Sang Wai Outline Zoning Plan No.: S/YL-NSW/8
(e)	Land use zone(s) involved 涉及的土地用途地帶	"Village Type Development" Zone
(f)	Current use(s) 現時用途	Vacant (If there are any Government, institution or community facilities, please illustrate on plan and specify the use and gross floor area) (如有任何政府、機構或社區設施,請在圖則上顯示,並註明用途及總樓面面積)
4.	"Current Land Owne	'of Application Site 申請地點的「現行土地擁有人」
The	是唯一的「現行土地擁有」 is one of the "current land o	r''#& (please proceed to Part 6 and attach documentary proof of ownership). _ #& (請繼續填寫第 6 部分,並夾附業權證明文件)。 ners''#& (please attach documentary proof of ownership). _ #& (請夾附業權證明文件)。
	The application site is entire	on Government land (please proceed to Part 6). 上(請繼續填寫第 6 部分)。
5.	Statement on Owner's 就土地擁有人的同	Consent/Notification ほ/通知土地擁有人的陳述
(a)	application involves a total	rd(s) of the Land Registry as at
(b)	已取得	of"current land owner(s)" [#] 名「現行土地擁有人」 [#] 的同意。
	No. of 'Current Land Owner(s)' 「理坛上地塘村	current land owner(s)" obtained 取得「現行土地擁有人」"同意的詳情 number/address of premises as shown in the record of the Land (istry where consent(s) has/have been obtained 象土地註冊處記錄已獲得同意的地段號碼/處所地址 (D/MM/YYYY) 取得同意的日期 (日/月/年)
	(Plance use consists of the	if the space of any box above is insufficient. 如上列任何方格的空間不足,請另頁說明)

	Details of the "current land owner(s)" notified 已獲通知「現行土地擁有人」"的詳細資料									141				
	Lar	. of 'Current nd Owner(s)' 現行土地擁 人」數目	Land I	Registry	where i	notifica	tion(s) h	nown in as/have l 地段號码	oeen giv	/en	e giv	en D/MM	1/YY	fication YY) 月/年)
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	Reas	published noti 於	ces in le	Notifica ocal nev (日/) minent	tion to C wspapers 月/年)在	Owner(s s on 指定報 on or n	章就申	地擁有之	人發出並 (DI -次通知	■知所抄 ○/MM/] ^{&}	採取的	<u>今理步</u>	基型	
		published noti 於	ces in le	Notifica ocal nev (日/) minent (DD/	tion to C wspapers 月/年)在 position MM/YY	Owner(s s on 指定報 on or n (YY)&) 向十 章就申 ear appl	地擁有之 請刊登一 ication si	人發出这 (DI -次通知 te/prem	通知所抄 D/MM/Y I ^{&} nises on	采取的 (YYY)	<u>今理步</u>	٠	請的通
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4	0	Form No. S16-I 表格第 S16-I 號					
6.	Type(s)	of Application 申請類別					
	Type (i) 第(i)類	Change of use within existing building or part thereof 更改現有建築物或其部分內的用途					
\checkmark	Type (ii) 第(ii)類	Diversion of stream / excavation of land / filling of land / filling of pond as required under Notes of Statutory Plan(s) 根據法定圖則《註釋》內所要求的河道改道/挖土/填土/填塘工程					
	Type (iii) 第(iii)類	Public utility installation / Utility installation for private project 公用事業設施裝置/私人發展計劃的公用設施裝置					
	Type (iv) 第(iv)類	Minor relaxation of stated development restriction(s) as provided under Notes of Statutory Plan(s) 略為放寬於法定圖則《註釋》內列明的發展限制					
	Type (v) 第(v)類	Use / development other than (i) to (iii) above 上述的(i)至(iii)項以外的用途/發展					
註 1 Note	Note 1: May insert more than one「✓」. 註 1: 可在多於一個方格內加上「✓」號 Note 2: For Development involving columbarium use, please complete the table in the Appendix. 註 2: 如發展涉及靈灰安置所用途,請填妥於附件的表格。						
(3)	(i) For Type (i) application 供第(i)類申讀						
	Total floo nvolved 步及的總樓	sq.m 平方米					

(i) For Type (i) applicati	n 供第(i)類申請			
(a) Total floor area involved 涉及的總樓面面積		E .	sq.m 平方米	
(b) Proposed use(s)/development 擬議用途/發展	the use and gross floor	ment, institution or community urea) 或社區設施,請在圖則上顯え		
(c) Number of storeys involved 涉及層數		Number of units inv 涉及單位數目	volved	
	Domestic part 住用部	3分	sq.m 平方米	□About 約
(d) Proposed floor area 擬議樓面面積	Non-domestic part 非	住用部分	sq.m 平方米	□About 約
	Total 總計		sq.m 平方米	□About 約
(e) Proposed uses of different	Floor(s) 樓層 Cur	rent use(s) 現時用途	Proposed t	ıse(s) 擬議用途
floors (if applicable) 不同樓層的擬議用途(如適 用)				
(Please use separate sheets if the space provided is insufficient) (如所提供的空間不足,請另頁說	*	*		
明)				

(ii) For Type (ii) application	ation 供第(ii)類申讀
	□ Diversion of stream 河道改道
	□ Filling of pond 填塘 Area of filling 填塘面積sq.m 平方米 □About 約
	Depth of filling 填塘深度 m 米 □About 約
(a) Operation involved 涉及工程	▼ Filling of land 填土 Area of filling 填土面積
	□ Excavation of land 挖土
	Area of excavation 挖土面積sq.m 平方米 □About 約
u =	Depth of excavation 挖土深度 m 米 □About 約
	(Please indicate on site plan the boundary of concerned land/pond(s), and particulars of stream diversion, the extent of filling of land/pond(s) and/or excavation of land) (請用圖則顯示有關土地/池塘界線,以及河道改道、填塘、填土及/或挖土的細節及/或範圍))
,	
(b) Intended use/development 有意進行的用途/發展	Proposed Filling of Land for Permitted Houses (New Territories Exempted Houses)
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	AND
(tii) For Type (iii) applie	cation 供第(iii)類申請
(tii) For Type (iii) applie	□ Public utility installation 公用事業設施裝置
(tii) For Type (iii) applie	
(fii) For Type (iii) applie	□ Public utility installation 公用事業設施裝置 □ Utility installation for private project 私人發展計劃的公用設施裝置 Please specify the type and number of utility to be provided as well as the dimensions of each building/structure, where appropriate 請註明有關裝置的性質及數量,包括每座建築物/構築物(倘有)的長度、高度和闊度
(fii) For Type (iii) applic	□ Public utility installation 公用事業設施裝置 □ Utility installation for private project 私人發展計劃的公用設施裝置 Please specify the type and number of utility to be provided as well as the dimensions of each building/structure, where appropriate
(a) Nature and scale 性質及規模	□ Public utility installation 公用事業設施裝置 □ Utility installation for private project 私人發展計劃的公用設施裝置 Please specify the type and number of utility to be provided as well as the dimensions of each building/structure, where appropriate 請託明有關裝置的性質及數量,包括每座建築物/構築物(倘有)的長度、高度和闊度 Number of Name/type of installation
(a) Nature and scale	□ Public utility installation 公用事業設施裝置 □ Utility installation for private project 私人發展計劃的公用設施裝置 Please specify the type and number of utility to be provided as well as the dimensions of each building/structure, where appropriate 請託明有關裝置的性質及數量,包括每座建築物/構築物(倘有)的長度、高度和闊度 Number of Name/type of installation
(a) Nature and scale	□ Public utility installation 公用事業設施裝置 □ Utility installation for private project 私人發展計劃的公用設施裝置 Please specify the type and number of utility to be provided as well as the dimensions of each building/structure, where appropriate 請託明有關裝置的性質及數量,包括每座建築物/構築物(倘有)的長度、高度和闊度 Number of Name/type of installation

MY I	For Type (iv) application 🛱	性第(iv)類申請		
]	proposed use/development a	nd development particul	d development restriction(s) and <u>a</u> ars in part (v) below – 勺擬議用途/發展及發展細節 –	also fill in the
	Plot ratio restriction 地積比率限制	From 由	to 至	
	Gross floor area restriction 總樓面面積限制	From 由sq. m	平方米 to 至sq. m 平方法	米
	Site coverage restriction 上蓋面積限制	From 由	% to 至%	
	Building height restriction 建築物高度限制		m 米 to 至 m 米	
la		From 由	mPD米 (主水平基準上) to 至	
		***********	mPD 米 (主水平基準上)	
		From 由	storeys層 to至 store	ys 層
	Non-building area restriction 非建築用地限制	From 由	.m to 至	
	Others (please specify) 其他(請註明)	, ,		
(v) E	or Type (v) application 供	第(v)類申讀		
	s)/development 養用途/發展	illustrate the details of the propo	osal on a layout plan 請用平面圖說明建議	詳情)
(b) Dev	velopment Schedule 發展細節表			
Proj	posed gross floor area (GFA) 擬	議總樓面面積	sq.m 平方米	□About 約
Proj	posed plot ratio 擬議地積比率		\	□About 約
Proj	posed site coverage 擬議上蓋面積	責	%	□About 約
	posed no. of blocks 擬議座數			
Proj	posed no. of storeys of each block	每座建築物的擬議層數	storeys 層	
			□ include 包括 storeys of basem □ exclude 不包括 storeys of base	AMERICA SERVICE CO.
Pro	posed building height of each blo	ck 每座建築物的擬議高度	mPD 米(主水平基準上 m 米)□About 約 □About 約

Domestic	part 住用部分		<i></i>
	總樓面面積	sq. m 平方米	□About 約
	per of Units 單位數目		
	nge unit size 單位平均面積	sq. m 平方米	□About 約
	nated number of residents 估計住客數目		
│	etic part 非住用部分	GFA 總樓面面	i積
404.004	g place 食肆	 sq. m 平方米	 □About 約
	酒店	sq. m 平方米	□About 約
		(please specify the number of rooms	202
		請註明房間數目)	
□ offic	e 辦公室	sq. m 平方米	19
	and services 商店及服務行業	sq. m 平方米	□About 約
snop	and services Fill X X NX NX N N N N N N N N N N N N N N		
	ernment, institution or community facilities	(please specify the use(s) and	concerned land
		area(s)/GFA(s) 請註明用途及有關的	NAS 1990, CARLO MANAGEM MANAGEM MANAGEM
以 的	、機構或社區設施	樓面面積)	176日日日1月/ 86
	\.	1安田田1貝)	
		()(a)(a) and	
∐ othe	r(s) 其他	(please specify the use(s) and	ACC TO STATE STATES
		area(s)/GFA(s) 請註明用途及有關的	沙地山山惧/総
		樓面面積)	1 2
		\	
		\	
			ul. Tr. Tr. Len
	ce 休憩用地	(please specify land area(s) 請註明:	- 22 700
☐ priva	ite open space 私人休憩用地	sq. m 平方米 口 Not I	less than 不少於
☐ priva			less than 不少於
☐ priva	ite open space 私人休憩用地	sq. m 平方米 □ Not I sq. m 平方米 □ Not I	less than 不少於
☐ priva☐ publ	tte open space 私人休憩用地 ic open space 公眾休憩用地 fferent floors (if applicable) 各樓層的用途 (如遊	sq. m 平方米 □ Not I sq. m 平方米 □ Not I 箇用)	less than 不少於
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7. Anticipated Completi 擬議發展計劃的預		of the Development Proposal 時間					
Anticipated completion time (in month and year) of the development proposal (by phase (if any)) (e.g. June 2023) 擬議發展計劃預期完成的年份及月份 (分期 (倘有)) (例: 2023 年 6 月) (Separate anticipated completion times (in month and year) should be provided for the proposed public open space and Government, institution or community facilities (if any)) (申請人須就擬議的公眾休憩用地及政府、機構或社區設施(倘有)提供個別擬議完成的年份及月份)							
January 2024							
		•••••					
0 77.11							
8. Vehicular Access Arra 擬議發展計劃的行		t of the Development Proposal 安排					
Any vehicular access to the	Yes 是	✓ There is an existing access. (please indicate the street name, where appropriate) 有一條現有車路。(請註明車路名稱(如適用))					
site/subject building? 是否有車路通往地盤/有關 建築物?		Accessible from Castle Peak Road - Tam Mi via a local access There is a proposed access. (please illustrate on plan and specify the width) 有一條擬議車路。(請在圖則顯示,並註明車路的闊度)					
	No 否						
Any provision of parking space for the proposed use(s)? 是否有為擬議用途提供停車位?	Yes 是	□ (Please specify type(s) and number(s) and illustrate on plan) 請註明種類及數目並於圖則上顯示) Private Car Parking Spaces 私家車車位 Motorcycle Parking Spaces 電單車車位 Light Goods Vehicle Parking Spaces 輕型貨車泊車位 Medium Goods Vehicle Parking Spaces 中型貨車泊車位 Heavy Goods Vehicle Parking Spaces 重型貨車泊車位 Others (Please Specify) 其他 (請列明)					
	No 否	$ \checkmark $					
Any provision of loading/unloading space for the proposed use(s)? 是否有為擬議用途提供上落客貨車位?	Yes 是	□ (Please specify type(s) and number(s) and illustrate on plan) 請註明種類及數目並於圖則上顯示) Taxi Spaces 的士車位 Coach Spaces 旅遊巴車位 Light Goods Vehicle Spaces 輕型貨車車位 Medium Goods Vehicle Spaces 中型貨車車位 Heavy Goods Vehicle Spaces 重型貨車車位 Others (Please Specify) 其他 (請列明)					
	No否	\checkmark					

9. Impacts of De	velopme	nt Proposal 擬議發展計劃的影響
justifications/reasons for	r not prov	sheets to indicate the proposed measures to minimise possible adverse impacts or give ding such measures. 上減少可能出現不良影響的措施,否則請提供理據/理由。
Does the development	Yes 是	□ Please provide details 請提供詳情
proposal involve		
alteration of existing building?		
擬議發展計劃是否 包括現有建築物的		
改動?	No 否	✓
	Yes 是	(Please indicate on site plan the boundary of concerned land/pond(s), and particulars of stream diversion,
# **		the extent of filling of land/pond(s) and/or excavation of land)
Does the development proposal involve the		(請用地盤平面圖顯示有關土地/池塘界線,以及河道改道、填塘、填土及/或挖土的細節及/或範 [87]
operation on the		園) □ Diversion of stream 河道改道
right? 擬議發展是否涉及		□ Filling of pond 填塘
右列的工程?		Area of filling 填塘面積sq.m 平方米 □About 約
(Note: where Type (ii) application is the		Depth of filling 填塘深度 m 米 □About 約
subject of application,		▼ Filling of land 填土
please skip this section.		Area of filling 填土面積
註:如申請涉及第		
(ii)類申請,請跳至下 一條問題。)		□ Excavation of land 挖土 Area of excavation 挖土面積sq.m 平方米 □About 約
		Depth of excavation 挖土深度
	No 否	
		onment 對環境 Yes 會 □ No 不會 ☑ Yes 會 □ No 不會 ☑ Yes 會 □ No 不會 ☑
		supply 對供水 Yes 會 □ No 不會 ☑
	On drain	age 對排水 Yes 會 □ No 不會 ☑
		by slopes 受斜坡影響 Yes 會 □ No 不會 ☑
		pe Impact 構成景觀影響 Yes 會 □ No 不會 ☑ ing 砍伐樹木 Yes 會 □ No 不會 ☑
		npact 構成視覺影響 Yes 會 □ No 不會 ☑
Would the	Others (1	Please Specify) 其他 (請列明) Yes 會 □ No 不會 ☑
development	-	
proposal cause any adverse impacts?	Please s	ate measure(s) to minimise the impact(s). For tree felling, please state the number,
擬議發展計劃會否 造成不良影響?	diameter 請註明語	at breast height and species of the affected trees (if possible) 是量減少影響的措施。如涉及砍伐樹木,請說明受影響樹木的數目、及胸高度的樹幹是種(倘可)
*	Constitution in the section	
		······································
e e		

10. Justifications 理由

The applicant is invited to provide justifications in support of the application. Use separate sheets if necessary. 現請申請人提供申請理由及支持其申請的資料。如有需要,請另頁說明。

Background

The applicant seeks planning permission from the Town Planning Board (the Board) for 'Proposed Filling of Land for Permitted Houses (New Territories Exempted Houses (NTEHs)' in respect to various private lots in D.D. 104, Pok Wai, Yuen Long, New Territories (Plan 1).

Planning Context

The Site currently falls within an area zoned as "Village Type Development" ("V") on the Approved Nam Sang Wai Outline Zoning Plan (OZP) No. S/YL-NSW/8 (Plan 2). According to the Notes of the OZP, 'House (NTEH only)' is a Column 1 use which is always permitted within the "V" zone.

However, filling of land/pond or excavation of land, including that to effect a change of use to any of those specified in Columns 1 and 2 uses/developments always permitted under the covering Notes, requires planning permission from the Board. Since the applied filling of land is intended for development of NTEHs, it is considered in line with the planning intention of "V" zone.

Development Proposal

The Site occupied an area of 1,023 sq.m (about) of private land (Plan 3). The Site will be filled wholly and the depth of filling will not be more than 1.24 m as site formation for development of 8 permitted houses (NTEHs) (Plans 4 to 6). The Site is accessible from Castle Peak Road - Tam Mi via a local access (Plan 1).

The Site is currently vacant and is slopping from the north to the south with approximate site levels of +4.96 mPD (about) and +3.80 mPD (about) respectively according to the topographic survey (**Plan 4**). Furthermore, the Site is also adjoining the application site of the approved S.16 planning application No. A/YL-NSW/305 (the Adjoining Site) for temporary 'public vehicle park' use with associated filling of land. According to the approved scheme of Adjoining Site, filling of land (with proposed site level +7.1 mPD) would be carried out to create a flat surface for the operation of the 'public vehicle park' by the applicant of the Adjoining Site. As the Site is significantly lower than the Adjoining Site and there are level differences within the Site, site formation work involving filling of land (i.e. not more than 1.24 m in depth, filled to +5.04 mPD) is therefore required to create a flat surface for development of 8 permitted houses (NTEHs)(**Plans 4** to **6**).

The Site is the subject of a previous S.16 planning application No. A/YL-NSW/310 for 'Proposed Filling of Land for Permitted Houses (NTEHs)' submitted by the same applicant, which was approved by the Board in 2023. When compared with the previous application, the current application involves of increased in depth of filling but reduction in filling area. During the preparation of drainage proposal by the applicant for compliance with approval condition (a) of the previous application (No. A/YL-NSW/310), i.e. the submission of a drainage proposal before the commencement of the land filling works on the site, it was determined that the approved depth of filling (i.e. with site level of +4.4 mPD) was insufficient to facilitate the proposed drainage facilities at the Site. Consequently, additional land filling (with site level of +5.04 mPD) is required to facilitate the proposed drainage facilities at the Site.

Minimal vehicular trips will be generated and attracted by the proposed filling works given the scale and nature of the proposal. The proposed filling will be carried out in accordance with relevant environmental ordinance / guidelines as to minimise nuisance and adverse impact to the surrounding environment.

Conclusion

The proposed filling of land works for development of 8 houses (NTEHs) will not create significant adverse impact as the Site falls entirely within the "V" zone. As the applicant intended to raise the site level to +5.04 mPD (about), drainage proposal is submitted to mitigate adverse drainage impact to the surrounding areas (Appendix I).

In view of the above, the Board is hereby respectfully recommended to approve the subject application for `Proposed Filling of Land for Permitted Houses (NTEHs)'.

	Form No. S16-I 表格第 S16-I 别	左
The state of the s	*	,
11. Declaration 聲明	18 27	
I hereby declare that the particulars given in this application are correct and true to 本人謹此聲明,本人就這宗申請提交的資料,據本人所知及所信,均屬真實訊	the best of my knowledge and belief. 無誤。	
I hereby grant a permission to the Board to copy all the materials submitted in this all to the Board's website for browsing and downloading by the public free-of-charge 員會酌情將本人就此申請所提交的所有資料複製及/或上載至委員會網站,供	at the Board's discretion. 本人現准計	rials 午委
Signature	人 / 🗹 Authorised Agent 獲授權代理	旦人
Michael WONG		
Name in Block Letters I 姓名(請以正楷填寫)	Position (if applicable) 職位 (如適用)	
□ HKIS 香港測量師學會 / □ HKIE 香		
Remark 備註		
The materials submitted in this application and the Board's decision on the application materials would also be uploaded to the Board's website for browsing and free documents appropriate. 委員會會向公眾披露申請人所遞交的申請資料和委員會對申請所作的決定。在資料亦會上載至委員會網頁供公眾免費瀏覽及下載。	wnloading by the public where the Bo	oard

Warning 警告

Any person who knowingly or wilfully makes any statement or furnish any information in connection with this application, which is false in any material particular, shall be liable to an offence under the Crimes Ordinance. 任何人在明知或故意的情況下,就這宗申請提出在任何要項上是虛假的陳述或資料,即屬違反《刑事罪行條例》

Statement on Personal Data 個人資料的聲明

The personal data submitted to the Board in this application will be used by the Secretary of the Board and Government departments for the following purposes: 委員會就這宗申請所收到的個人資料會交給委員會秘書及政府部門,以根據《城市規劃條例》及相關的城市規

劃委員會規劃指引的規定作以下用途:

the processing of this application which includes making available the name of the applicant for public inspection when making available this application for public inspection; and 處理這宗申請,包括公布這宗申請供公眾查閱,同時公布申請人的姓名供公眾查閱;以及

facilitating communication between the applicant and the Secretary of the Board/Government departments.

方便申請人與委員會秘書及政府部門之間進行聯絡。

2. The personal data provided by the applicant in this application may also be disclosed to other persons for the purposes mentioned in paragraph 1 above. 申請人就這宗申請提供的個人資料,或亦會向其他人士披露,以作上述第1段提及的用途。

3. An applicant has a right of access and correction with respect to his/her personal data as provided under the Personal Data (Privacy) Ordinance (Cap. 486). Request for personal data access and correction should be addressed to the Secretary of the Board at 15/F, North Point Government Offices, 333 Java Road, North Point, Hong Kong.

根據《個人資料(私隱)條例》(第 486 章)的規定,申請人有權查閱及更正其個人資料。如欲查閱及更正個人資料,應向委員會秘書提出有關要求,其地址為香港北角渣華道 333 號北角政府合署 15 樓。

For Developments involving Columbarium Use, please also complete the following:如發展涉及靈灰安置所用途,請另外填妥以下資料:			
Ash interment capacity 骨灰安放容量@	<u>i</u>		
Maximum number of sets of ashes that may be interred in the niches 在龕位內最多可安放骨灰的數量			
Maximum number of sets of ashes that may be interred other than in niches 在非龕位的範圍內最多可安放骨灰的數量			
Total number of niches 龕位總數			
Total number of single niches 單人龕位總數	8 9		
Number of single niches (sold and occupied) 單人龕位數目 (已售並佔用)			
Number of single niches (sold but unoccupied) 單人龕位數目 (已售但未佔用)			
Number of single niches (residual for sale) 單人龕位數目 (待售)			
Total number of double niches 雙人龕位總數	ž .		
Number of double niches (sold and fully occupied) 雙人龕位數目 (已售並全部佔用)	·		
Number of double niches (sold and partially occupied) 雙人龕位數目 (已售並部分佔用) Number of double niches (sold but unoccupied)			
雙人龕位數目 (已售但未佔用)	a		
Number of double niches (residual for sale) 雙人龕位數目 (待售)	-		
Total no. of niches other than single or double niches (please specify type) 除單人及雙人龕位外的其他龕位總數 (請列明類別)			
Number. of niches (sold and fully occupied)			
龕位數目(已售並全部佔用)			
Number of niches (sold and partially occupied) 龕位數目 (已售並部分佔用)			
Number of niches (sold but unoccupied) 龕位數目 (已售但未佔用)			
Number of niches (residual for sale)			
龕位數目 (待售)			
Proposed operating hours 擬議營運時間			
 ② Ash interment capacity in relation to a columbarium means – 就靈灰安置所而言,骨灰安放容量指: - the maximum number of containers of ashes that may be interred in each niche in the columbarium; 每個龕位內可安放的骨灰容器的最高數目; - the maximum number of sets of ashes that may be interred other than in niches in any area in the columbarium; 在該靈灰安置所並非龕位的範圍內,總共最多可安放多少份骨灰;以及 - the total number of sets of ashes that may be interred in the columbarium. - 在該骨灰安置所內,總共最多可安放多少份骨灰。 	and		


Gist of Applica	Gist of Application 申請摘要				
consultees, uploaded available at the Planr (請 <u>盡量</u> 以英文及中	I to the T ning Enq 文填寫 劃資料查	Town Planning Boa uiry Counters of the 。此部分將會發送了 詢處供一般參閱。	inese <u>as far as possible</u> . This pard's Website for browsing and free Planning Department for general in 予相關諮詢人士、上載至城市規畫)	formation.)	
Application No.	(For Of	ficial Use Only) (請勿	7填寫此欄)		
申請編號			a x X a		
Location/address	i#		* **		
位置/地址	3540	8540 S.B ss.1 (Part) S.B ss. 6 (Part), 354 Vai, Yuen Long, Nev	i, 3540 S.B ss. 2, 3540 S.B ss. 3, 3 40 S.B RP (Part), 3559 S.A, 3559 w Territories	3540 S.B ss.4, 3540 S.B ss. 5, S.B and 3559 RP in D.D. 104,	
Site area			1,023	sq. m 平方米 ☑ About 約	
地盤面積					
1 × 5	(include	es Government land	of包括政府土地 N/A	sq. m 平方米 口 About 約)	
Plan				NA//O	
圖則	Appro	ved Nam Sang Wai	i Outline Zoning Plan No. S/YL-NS	VV/8	
Zoning	9		5		
地帶	"Villag	e Type Developme	nt" Zone		
T 10		*	7 2 2	·	
Applied use/ development 申請用途/發展	Propo	sed Filling of Land	for Permitted Houses (New Territo	ries Exempted Houses)	
B 1					
	_				
			sq.m 平方米	Plot Ratio 地積比率	
(i) Gross floor are and/or plot rat			* ************************************	□About 約	
總樓面面積及	/ 或	Domestic 住用	□ About 約 □ Not more than	□Not more than	
地積比率		_	不多於	不多於	
र्के Gar		Non-domestic 非住用	□ About 約 □ Not more than	□About 約 □Not more than	
		护江州	不多於	不多於	
(ii) No. of block 幢數		Domestic 住用		* *	
 3		Non-domestic 非住用			
.e		Composite 綜合用途			


(žii)	Building height/No. of storeys	Domestic 住用	m 米
,	建築物高度/層數		□ (Not more than 不多於)
			mPD 米(主水平基準上) □ (Not more than 不多於)
			Storeys(s) 層 □ (Not more than 不多於)
			(□Include 包括/□ Exclude 不包括 □ Carport 停車間 □ Basement 地庫 □ Refuge Floor 防火層 □ Podium 平台)
	£	Non-domestic 非住用	m 米 □ (Not more than 不多於)
			mPD 米(主水平基準上) □ (Not more than 不多於)
			Storeys(s) 層 □ (Not more than 不多於)
			(□Include 包括/□ Exclude 不包括 □ Carport 停車間 □ Basement 地庫 □ Refuge Floor 防火層 □ Podium 平台)
	8	Composite 綜合用途	m 米 □ (Not more than 不多於)
	2		mPD 米(主水平基準上) □ (Not more than 不多於)
	er E		Storeys(s) 層 口 (Not more than 不多於)
			□ Include 包括/□ Exclude 不包括 □ Carport 停車間 □ Basement 地庫 □ Refuge Floor 防火層 □ Podium 平台)
(iv)	Site coverage 上蓋面積		% □ About 約
(v)	No. of units 單位數目		
(vi)	Open space 休憩用地	Private 私人	sq.m 平方米 🗆 Not less than 不少於
		Public 公眾	sq.m 平方米 口 Not less than 不少於


(vii) No. of parking	Total no. of vehicle parking spaces 停車位總數	*
spaces and loading /	344 6	
unloading spaces	Private Car Parking Spaces 私家車車位	
停車位及上落客貨	Motorcycle Parking Spaces 電單車車位	
車位數目	Light Goods Vehicle Parking Spaces 輕型貨車泊車位	d
	Medium Goods Vehicle Parking Spaces 中型貨車泊車位	
	Heavy Goods Vehicle Parking Spaces 重型貨車泊車位	
	Others (Please Specify) 其他 (請列明)	
	1 3,7 3,113 (34,7 4,7 4)	
		41
	Total no. of vehicle loading/unloading bays/lay-bys	
	上落客貨車位/停車處總數	50.7
	1 - No. 11 -	
* *	Taxi Spaces 的士車位	70
	Coach Spaces 旅遊巴車位	h - 1
	Light Goods Vehicle Spaces 輕型貨車車位	
	Medium Goods Vehicle Spaces 中型貨車位	
	Heavy Goods Vehicle Spaces 重型貨車車位	
	Others (Please Specify) 其他 (請列明)	
	See 18 C Constitution Constitution constitution	
2 2	9	

Submitted Plans, Drawings and Documents 提交的圖則、繪圖及文件		
	<u>Chinese</u> 中文	English 英文
Plans and Drawings 圖則及繪圖		
Master layout plan(s)/Layout plan(s) 總綱發展藍圖/布局設計圖		\checkmark
Block plan(s) 樓宇位置圖		
Floor plan(s) 樓宇平面圖		
Sectional plan(s) 截視圖		\mathbf{Z}
Elevation(s) 立視圖		
Photomontage(s) showing the proposed development 顯示擬議發展的合成照片		
Master landscape plan(s)/Landscape plan(s) 園境設計總圖/園境設計圖	- 🗆	
Others (please specify) 其他(請註明)		\mathbf{Z}
Location plan, Plan showing the zoning of the Site, Plan showing the land status of the Si	te	
Topography plan, Drainage proposal		
Reports 報告書		
Planning Statement/Justifications 規劃綱領/理據		
Environmental assessment (noise, air and/or water pollutions)		
環境評估(噪音、空氣及/或水的污染)		
Traffic impact assessment (on vehicles) 就車輛的交通影響評估		-
Traffic impact assessment (on pedestrians) 就行人的交通影響評估		
Visual impact assessment 視覺影響評估		
Landscape impact assessment 景觀影響評估		
Tree Survey 樹木調查		
Geotechnical impact assessment 土力影響評估		
Drainage impact assessment 排水影響評估		
Sewerage impact assessment 排污影響評估		
Risk Assessment 風險評估		
Others (please specify) 其他(請註明)		L
		11
Note: May insert more than one 「 🗸 」. 註:可在多於一個方格內加上「 🗸 」號		


- Note: The information in the Gist of Application above is provided by the applicant for easy reference of the general public. Under no circumstances will the Town Planning Board accept any liabilities for the use of the information nor any inaccuracies or discrepancies of the information provided. In case of doubt, reference should always be made to the submission of the applicant.
- 註: 上述申請摘要的資料是由申請人提供以方便市民大眾參考。對於所載資料在使用上的問題及文義上的歧異,城市規劃委員 會概不負責。若有任何疑問,應查閱申請人提交的文件。

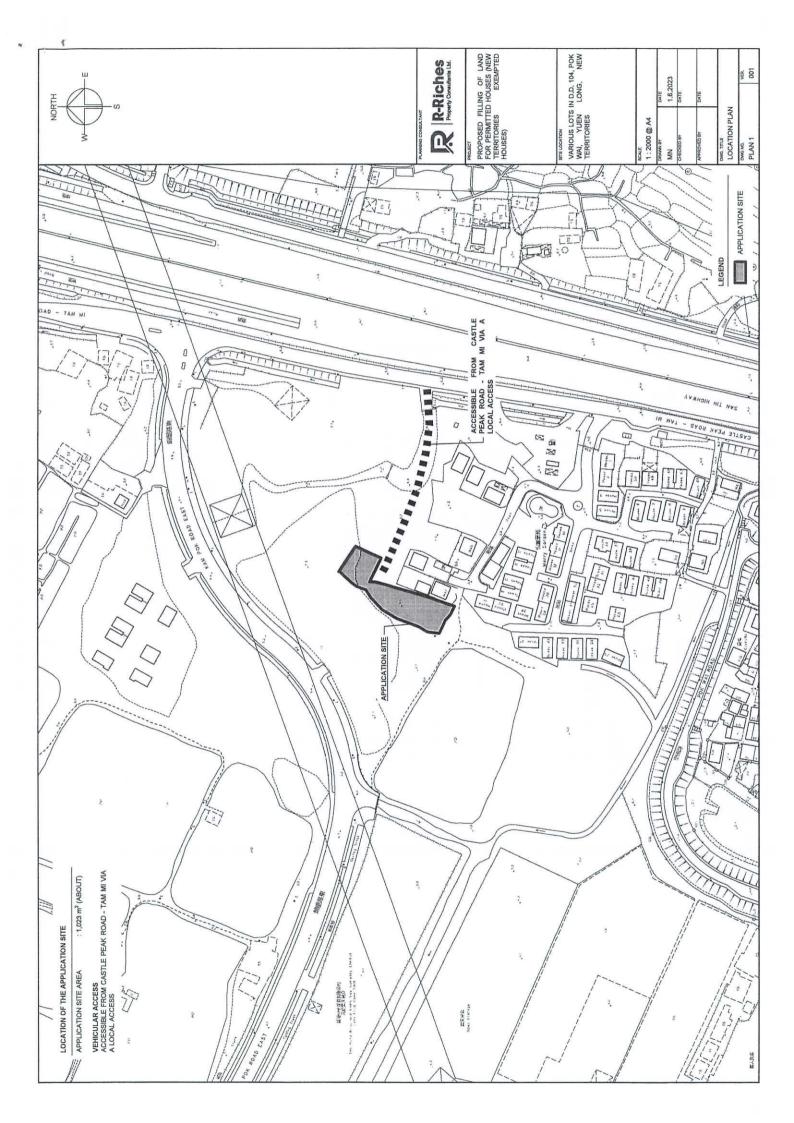


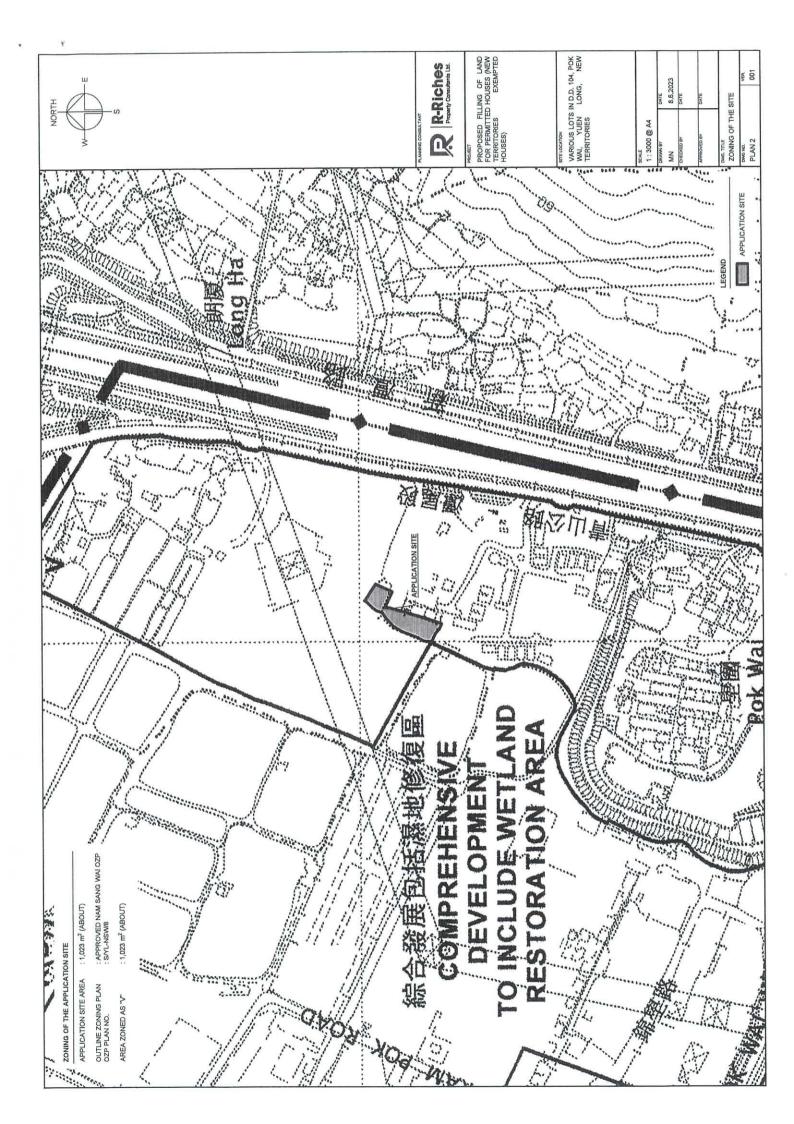


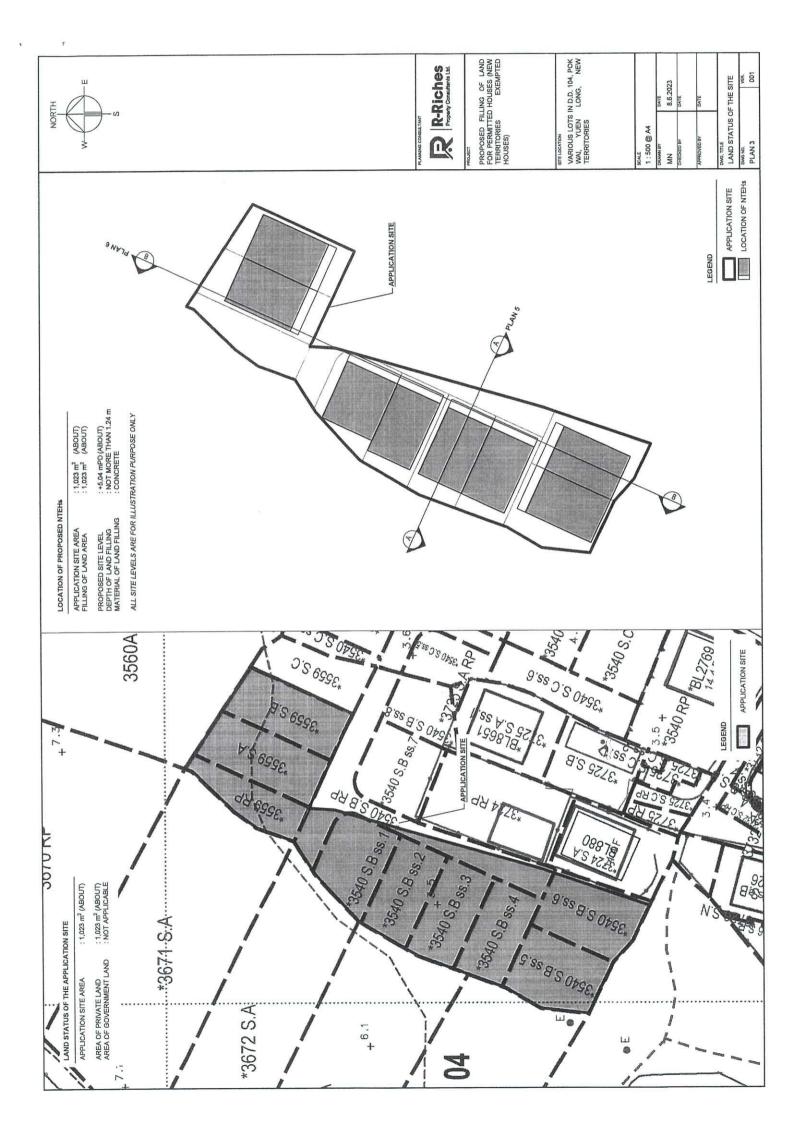


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458 458 458 458 458 458 458 458	25.0 SS. 65.5 SS. 65.	APPLICATION SITE
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1:1,023 m² (ABOUT) 1:1,023 m² (A	12 88 12 88	25 25 gs azis
	25 25 25 25 25 25 25 25 25 25 25 25 25 2	THE STATE OF THE S
PROPOSED FILLING OF APPLICATION SITE ARE PROPOSED FILLING ARE PROPOSED SITE LEVEL DEPTH OF PILLING MATERIAL OF FILLING MATERIAL OF FILLING ATTAINS ATT	+4.57 +4.59 +4.59 +4.59 +4.59	ZN
3560 A 44.8 3 3 3 3 4.48 4.88 4.88 4.88 4.88 4	9'55 2'5	APPLICATION SITE
A.S. 923E	8 1 1 1 1 1 1 1 1 1 1 1 1 1 1 1 1 1 1 1	
(ABOUT) 0-4.96 mPD (ABOUT) 1-4.96 mPD (ABOUT) 1-4.96 mPD (ABOUT) 1-4.95 mPD (ABOUT) 1-5.95 mPD (ABOUT) 1-5.9	088 18 as 25 TE 35	7-
EXISTING CONDITION APPLICATION SITE AREA EXISTING SITE LEVEL 3671 +687 +687	44.8 42.8 42.8 42.8 42.8 42.8 42.8 42.8	TOPOGRAPHIC SURVEY WAS CONDUCTED IN MAY 2023 SITE LEVELS ARE FOR ILLUSTRATION PURPOSE ONLY.

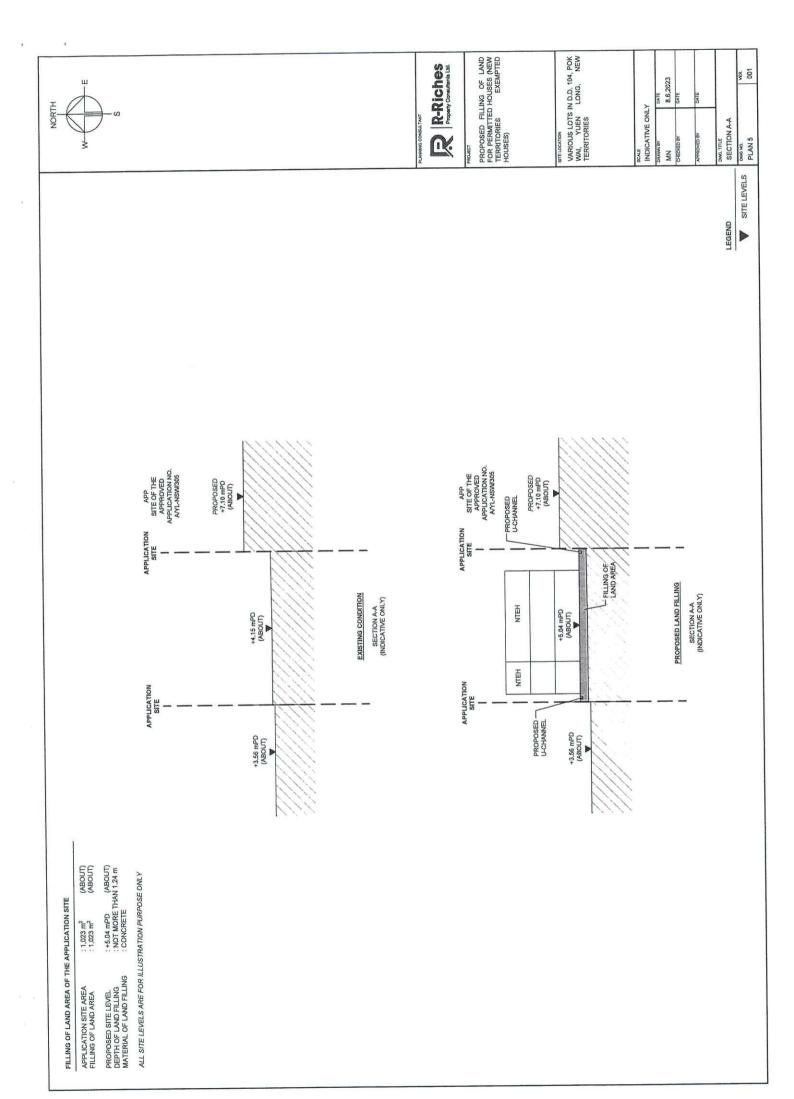

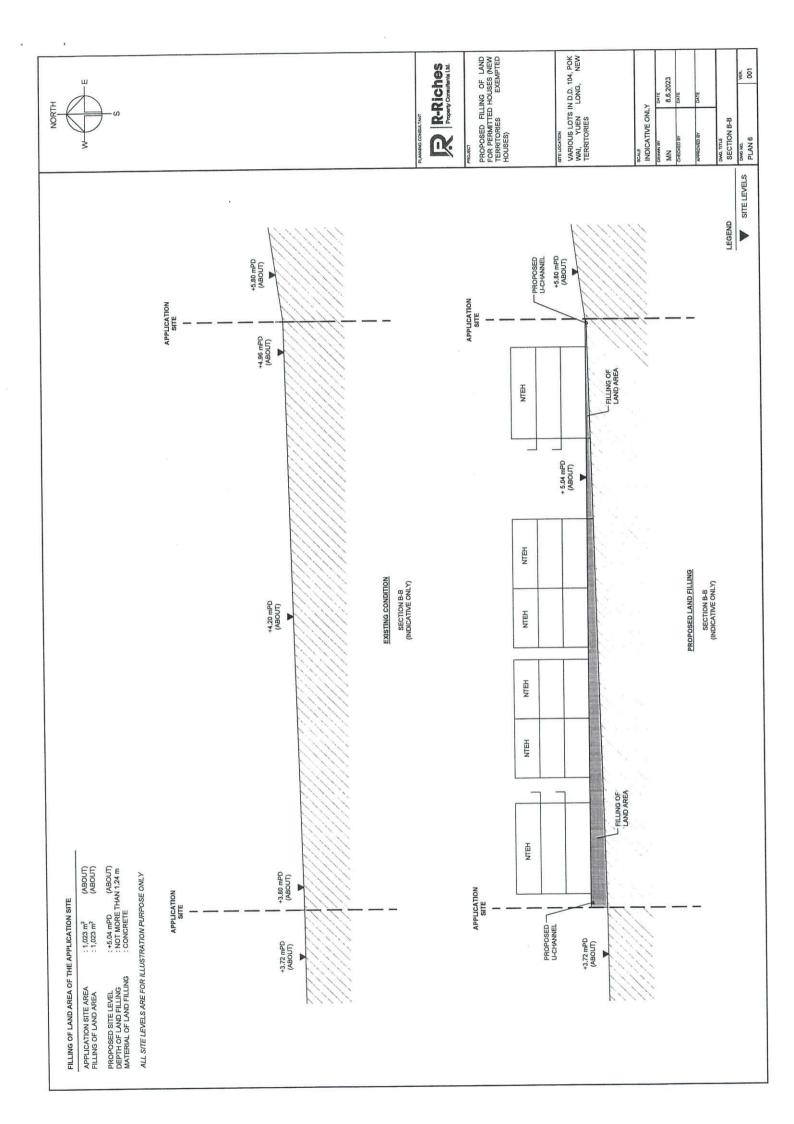

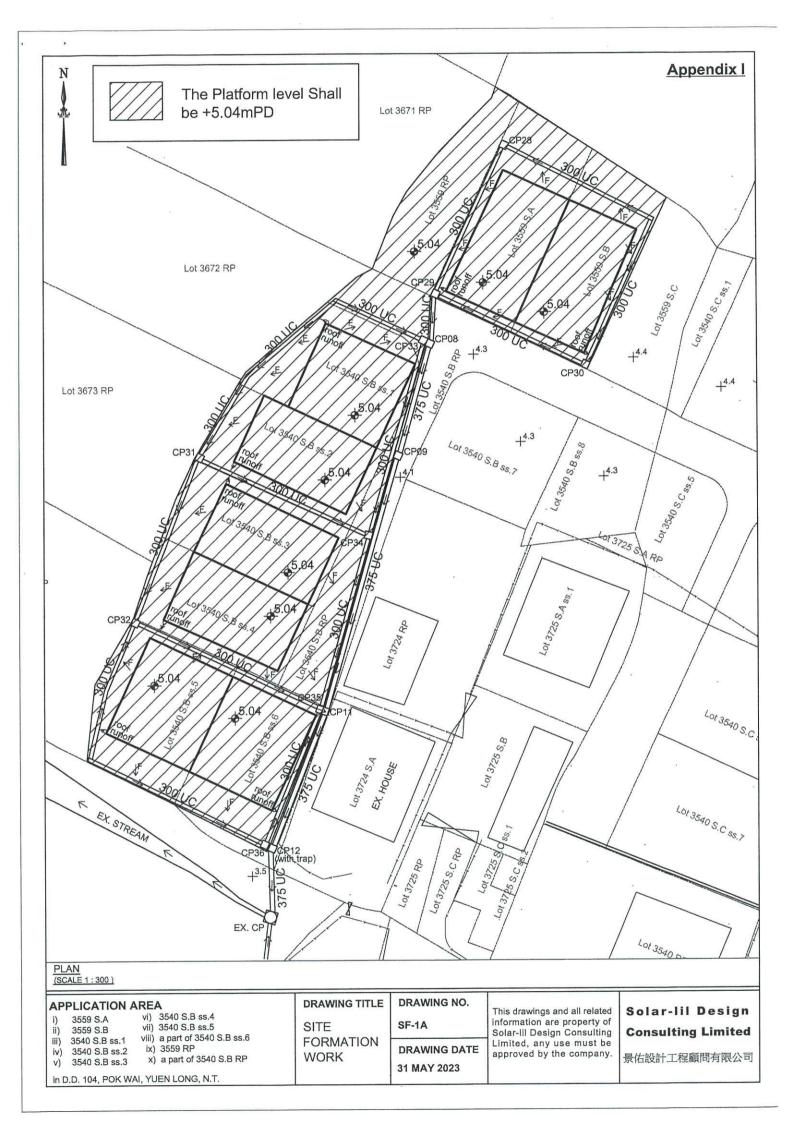




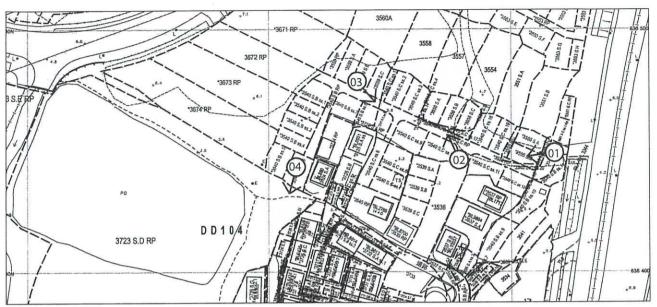


BLOCK PLAN (SCALE 1 : 1500)

CATCHPIT	CL	A 1	A 2	A 3	X 1
CP08 (CEDD DRAWING NO. C2405/1)	4.30	3.86			3.51
CP09 (CEDD DRAWING NO. C2405/1)	4.10	3.42			3.42
CP11 (CEDD DRAWING NO. C2405/1)	3.70	3.23	3.30		3.23
CP12 (WITH TRAP) (CEDD DRAWING NO. C2406/1)	3.50	3.11			3.11
CP28 (CEDD DRAWING NO. C2405/1)	5.04	4.61			4.61
CP29 (CEDD DRAWING NO. C2405/1)	5.04	4.48			3.90
CP30 (CEDD DRAWING NO. C2405/1)	5.04	4.61			4.61
CP31 (CEDD DRAWING NO. C2405/1)	5.04	4.57			4.57
CP32 (CEDD DRAWING NO. C2405/1)	5.04	4.43	4.62		4.43
CP33 (CEDD DRAWING NO. C2405/1)	5.04	4.66			4.66
CP34 (CEDD DRAWING NO. C2405/1)	5.04	4.43	4.50		4.43
CP35 (CEDD DRAWING NO. C2405/1)	5.04	4.28	4.28	4.46	3.30
CP36 (CEDD DRAWING NO. C2405/1)	5.04	4.58			4.58
EX.CP	3.22	2.72			2.25

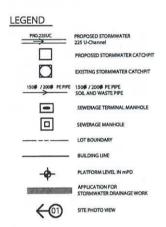


GENERAL NOTES

- 1. ALL DIMENSIONS ARE IN MILLIMETERS
- 2. CONCRETE MIX TO BE 30D/20 AND COMPLY WITH CS1.
- 3. BUNDING LAYER TO BE 15P MIX.
- 4. ALL NEW 225 CHANNEL ARE OF FALL GRADIENT 1:100
- 5. PROPOSED CONNECTION UNDERGROUND PIPE IS TO BE CONSTRUCTED UNDER FOOTPATH AND THE UPVC PIPE PROVIDED CONCRETE SURROUND MIN. 150MM THICK.

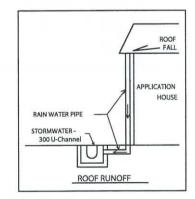

Α	PPLICATION SITE			DRAWING TITLE	DRAWING NO.		7.77
i	A CONTRACTOR OF THE PARTY OF TH	vi) 3540 S.B ss.4 vii) 3540 S.B ss.5 viii) 3540 S.B ss.6		STORMWATER DRAINAGE WORK	ST-2A	This drawings and all related information are property of Solar-lil Design Consulting	Solar-lil Design Consulting Limited
ii	v) 3540 S.B ss.2	VIII) 3340 3.0 33.0	in D.D. 104 POK WAI, YUEN LONG, N.T.		DRAWING DATE 31 MAY 2023	Limited, any use must be approved by the company.	景佑設計工程顧問有限公司

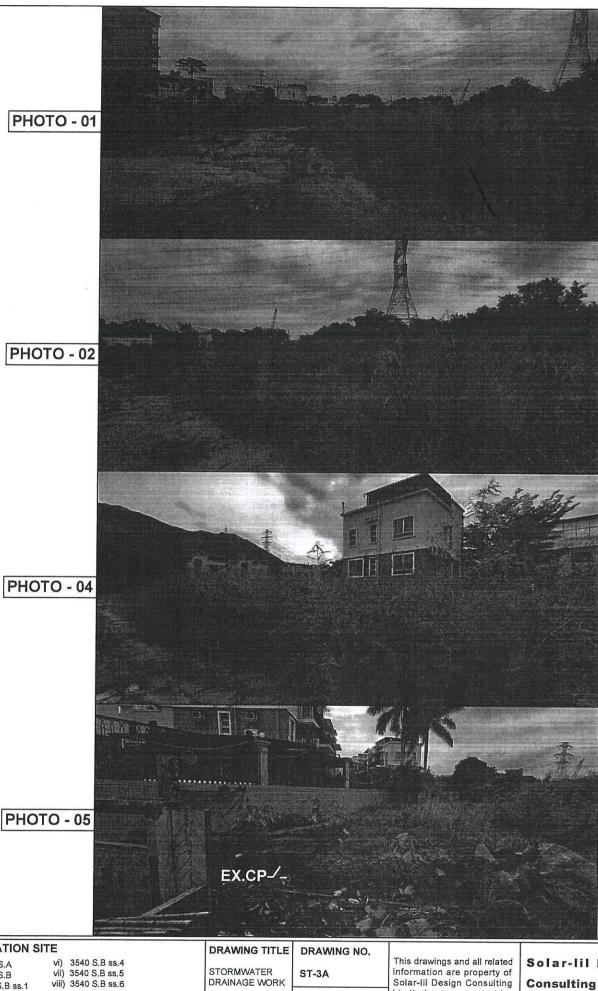

APPLICATION SITE

3559 S.A 3559 S.B


iii) iv) v) 3540 S.B ss.1 3540 S.B ss.2 3540 S.B ss.3


in D.D. 104 POK WAI, YUEN LONG, N.T.

Limited, any use must be approved by the company. DRAWING DATE 31 MAY 2023

Solar-lil Design **Consulting Limited**

景佑設計工程顧問有限公司

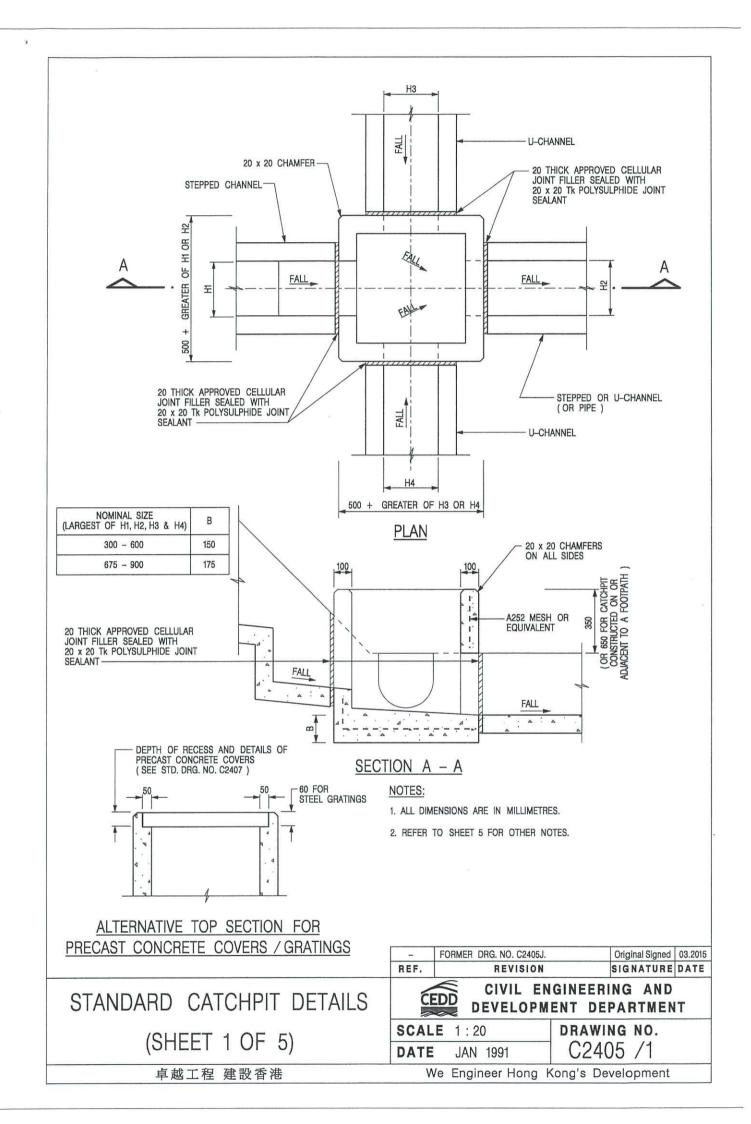

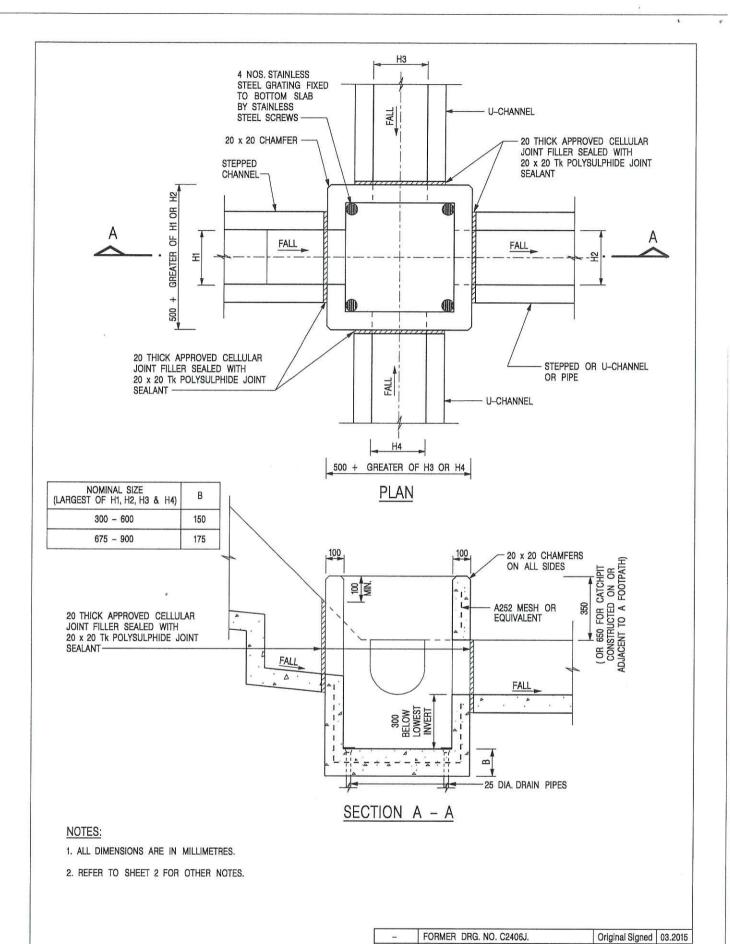

CATCHPIT WITH TRAP (SHEET 1 OF 2)

卓越工程 建設香港

SCALE 1:20 **DATE** JAN 1991

CEDD

REF.


C2406 /1

SIGNATURE DATE


We Engineer Hong Kong's Development

CIVIL ENGINEERING AND

DEVELOPMENT DEPARTMENT

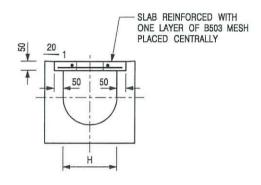


TYPICAL SECTION

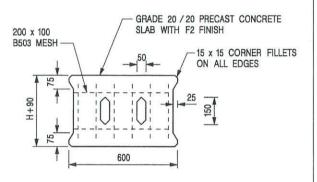


PLAN OF SLAB

U-CHANNELS WITH PRECAST CONCRETE SLABS

(UP TO H OF 525)

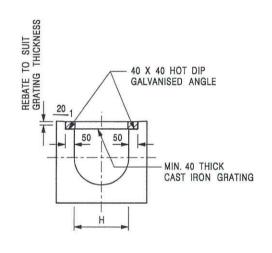

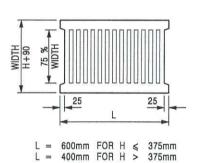

TYPICAL SECTION

CAST IRON GRATING

(DIMENSIONS ARE FOR GUIDANCE ONLY, CONTRACTOR MAY SUBMIT EQUIVALENT TYPE)

U-CHANNEL WITH CAST IRON GRATING

(UP TO H OF 525)

NOTES:

- 1. ALL DIMENSIONS ARE IN MILLIMETRES.
- 2. H=NOMINAL CHANNEL SIZE.
- ALL CAST IRON FOR GRATINGS SHALL BE GRADE EN-GJL-150 COMPLYING WITH BS EN 1561.
- 4. FOR COVERED CHANNELS TO BE HANDED OVER TO HIGHWAYS DEPARTMENT FOR MAINTENANCE, THE GRATING DETAILS SHALL FOLLOW THOSE AS SHOWN ON HyD STD. DRG. NO. H3156.

REF.	REVISION	SIGNATURE	DATE
Α	CAST IRON GRATING AMENDED.	Original Signed	12.2002
В	NAME OF DEPARTMENT AMENDED.	Original Signed	01.2005
С	MINOR AMENDMENT. NOTE 3 ADDED.	Original Signed	12.2005
D	NOTE 4 ADDED.	Original Signed	06.2008
E	NOTES 3 & 4 AMENDED.	Original Signed	12.2014

COVER SLAB AND CAST IRON GRATING FOR CHANNELS

CEDE
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200

CIVIL ENGINEERING AND DEVELOPMENT DEPARTMENT


SCALE 1:20

DATE JAN 1991

C2412E

卓越工程 建設香港

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ALTERNATIVE TOP SECTION FOR PRECAST CONCRETE COVERS / GRATINGS

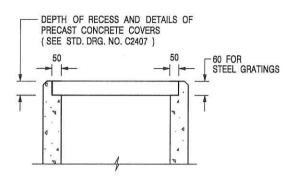NOTES:

- 1. ALL DIMENSIONS ARE IN MILLIMETRES.
- 2. ALL CONCRETE SHALL BE GRADE 20 /20.
- 3. CONCRETE SURFACE FINISH SHALL BE CLASS U2 OR F2 AS APPROPRIATE.
- 4. FOR DETAILS OF JOINT, REFER TO STD. DRG. NO. C2413.
- 5. CONCRETE TO BE COLOURED AS SPECIFIED.
- 6. UNLESS REQUESTED BY THE MAINTENANCE PARTY AND AS DIRECTED BY THE ENGINEER, CATCHPIT WITH TRAP IS NORMALLY NOT PREFERRED DUE TO PONDING PROBLEM.
- 7. UPON THE REQUEST FROM MAINTENANCE PARTY, DRAIN PIPES AT CATCHPIT BASE CAN BE USED BUT THIS IS FOR CATCHPITS LOCATED AT SLOPE TOE ONLY AND AS DIRECTED BY THE ENGINEER.
- 8. FOR CATCHPITS CONSTRUCTED ON OR ADJACENT TO A FOOTPATH, STEEL GRATINGS (SEE DETAIL 'A' ON STD. DRG. NO. C2405 /2) OR CONCRETE COVERS (SEE STD. DRG. NO. C2407) SHALL BE PROVIDED AS DIRECTED BY THE ENGINEER.
- 9. IF INSTRUCTED BY THE ENGINEER, HANDRAILING (SEE DETAIL 'J' ON STD. DRG. NO. C2405 /5; EXCEPT ON THE UPSLOPE SIDE) IN LIEU OF STEEL GRATINGS OR CONCRETE COVERS CAN BE ACCEPTED AS AN ALTERNATIVE SAFETY MEASURE FOR CATCHPITS NOT ON A FOOTPATH NOR ADJACENT TO IT. TOP OF THE HANDRAILING SHALL BE 1 000 mm MIN. MEASURED FROM THE ADJACENT GROUND LEVEL.
- 10. MINIMUM INTERNAL CATCHPIT WIDTH SHALL BE 1 000 mm FOR CATCHPITS WITH A HEIGHT EXCEEDING 1 000 mm MEASURED FROM THE INVERT LEVEL TO THE ADJACENT GROUND LEVEL. AND, STEP IRONS (SEE DSD STD. DRG. NO. DS1043) AT 300 % STAGGERED SHALL BE PROVIDED. THICKNESS OF CATCHPIT WALL FOR INSTALLATION OF STEP IRONS SHALL BE INCREASED TO 150 mm.
- 11. FOR RETROFITTING AN EXISTING CATCHPIT WITH STEEL GRATING, SEE DETAIL 'G' ON STD. DRG. NO. C2405 /4.
- 12. SUBJECT TO THE APPROVAL OF THE ENGINEER, OTHER MATERIALS CAN ALSO BE USED AS COVERS / GRATINGS.

Α	MINOR AMENDMENT.	Original Signed	04.2016
	FORMER DRG. NO. C2406J.	Original Signed	03.2015
REF.	REVISION	SIGNATURE	DATE

CATCHPIT WITH TRAP (SHEET 2 OF 2)

卓越工程 建設香港

DATE

CIVIL ENGINEERING AND **DEVELOPMENT DEPARTMENT**

SCALE 1:20 DRAWING NO. C2406 /2A

JAN 1991

We Engineer Hong Kong's Development



Our Ref. : DD104 Lot 3540 S.B ss.1 & VL

Your Ref. : TPB/A/YL-NSW/317

The Secretary **Town Planning Board** 15/F, North Point Government office 333 Java Road North Point, Hong Kong

Dear Sir,



Appendix Ia of RNTPC

By Email

20 September 2023

1st Further Information

Proposed Filling of Land for Permitted Houses (New Territories Exempted Houses) in "Village Type Development" Zone, Various Lots in D.D. 104, Pok Wai, Yuen Long, New Territories

(S.16 Planning Application No. A/YL-NSW/317)

We are writing to submit Further Information to address departmental comments of the subject application (Appendix I).

Should you require more information regarding the application, please contact our Mr. Orpheus LEE at (852) 2339 0884 / orpheuslee@r-riches.com.hk or the undersigned at your convenience. Thank you for your kind attention.

Yours faithfully,

For and on behalf of

R-riches Property Consultants Limited

Louis TSE

Town Planner

cc DPO/FSYLE, PlanD


(Attn.: Mr. Gary LAM

(Attn.: Mr. Davy LAM

email: gtllam@pland.gov.hk

email: dlylam@pland.gov.hk



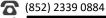



)

Responses-to-Comments

Proposed Filling of Land for Permitted Houses (New Territories Exempted Houses) in "Village Type Development" Zone, Various Lots in D.D. 104, Pok Wai, Yuen Long, New Territories

(Application No. A/YL-NSW/317)

(i) A RtoC Table:

	Departmental Comments	Applicant's Responses
1. (Comments of Chief Engineer/Mainland North, D	rainage Services Department
	(Contact Person: Mr. Terence TANG; Tel: 2300 1	257)
(a)	The gradients of the proposed u-channels should be shown on the drainage plan.	Noted. The applicant will submit a revised drainage proposal, with provision of peripheral u-channels and catchpits to
(b)	It is noted that the overland flow would pass through the application site from its northern and eastern side. Please demonstrate with hydraulic calculations, with catchment plan, that all proposed/ existing drainage facilities are adequate to collect, convey and discharge the surface runoff accrued on the application site and to intercept the overland flow from the adjacent lands.	mitigate potential adverse drainage impact generated by the proposed development after planning approval has been granted from the Town Planning Board (the Board). The applicant will implement the proposed drainage facilities at the application site (the Site) once the drainage proposal is accepted by the DSD/the Board.
(c)	Please advise why u-channel is not provided at the northern side and north-west of the site. Please advise how the overland flow from the above area of the site could be properly intercepted and discharged. Peripheral surface channels shall be provided along the site boundary to collect the surface runoff accrued on the application site and to intercept the overland flow from the adjacent lands.	
(d)	Please provide connection details with cross section for CP35 to CP11.	
(e)	The existing drainage facilities, to which the stormwater of the development from the subject site would discharge, are not maintained by this office. The applicant should identify the owner of the existing	

	drainage facilities to which the proposed connection will be made and obtain consent from the owner prior to commencement of the proposal works. In the case that it is a local village drains, DO/YL should be consulted.	
(f)	The applicant should check and ensure the hydraulic capacity of the existing drainage facilities would not be adversely affected by the captioned development. Please provide site photos to show existing condition of the existing drainage facilities which receives the discharge from the application site.	
(g)	Please provide hydraulic calculations for the proposed discharging drainage facility demonstrating its capacity to cater for the surface runoff from the entire application site.	
(h)	Please clarify whether any walls or hoarding would be erected along the site boundary. Where walls or hoarding are erected are laid along the site boundary, adequate opening should be provided to intercept the existing overland flow passing through the site.	
(i)	Please provide more cross sections in Section A direction showing the existing and proposed ground levels of the captioned site with respect to the adjacent areas.	
(j)	The development should neither obstruct overland flow nor adversely affect existing natural streams, village drains, ditches and the adjacent areas, etc.	
(k)	The applicant should consult DLO/YL and seek consent from the relevant owners for any drainage works to be carried out outside his lot boundary before commencement of the drainage works.	





Our Ref. : DD104 Lot 3540 S.B ss.1 & VL

Your Ref. : TPB/A/YL-NSW/317

The Secretary **Town Planning Board** 15/F, North Point Government office 333 Java Road North Point, Hong Kong

By Email

11 January 2024

Dear Sir,

2nd Further Information

Proposed Filling of Land for Permitted Houses (New Territories Exempted Houses) in "Village Type Development" Zone, Various Lots in D.D. 104, Pok Wai, Yuen Long, New Territories

(S.16 Planning Application No. A/YL-NSW/317)

We are writing to submit Further Information to address departmental comments of the subject application (Appendix I).

Should you require more information regarding the application, please contact our Mr. Orpheus LEE at (852) 2339 0884 / orpheuslee@r-riches.com.hk or the undersigned at your convenience. Thank you for your kind attention.

Yours faithfully,

For and on behalf of

R-riches Property Consultants Limited

Louis TSE

Town Planner

cc DPO/FSYLE, PlanD


(Attn.: Mr. Gary LAM

(Attn.: Mr. Edison KWAN

email: gtllam@pland.gov.hk

email: ekckwan@pland.gov.hk)



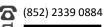



Responses-to-Comments

Proposed Filling of Land for Permitted Houses (New Territories Exempted Houses) in "Village Type Development" Zone, Various Lots in D.D. 104, Pok Wai, Yuen Long, New Territories

(Application No. A/YL-NSW/317)

(i) A RtoC Table:

Departmental Comments		Applicant's Responses	
1. Comments of Chief Engineer/Mainland North, Drainage Services Department			
(Contact Person: Mr. Terence TANG; Tel: 2300 1257)			
Comments received on 28/7/2023 and 7/11/2023			
(i)	The gradients of the proposed u-channels should be shown on the drainage plan.	The gradient of the proposed U-channel has been shown, please refer to the Drawing ST-1C (Annex I).	
(ii)	It is noted that the overland flow would pass through the application site from its northern and eastern side. Please demonstrate with hydraulic calculations, with catchment plan, that all proposed/ existing drainage facilities are adequate to collect, convey and discharge the surface runoff accrued on the application site and to intercept the overland flow from the adjacent lands.	Please refer to the "Design Statement" (Annex I).	
(iii)	Please advise why u-channel is not provided at the northern side and north-west of the site. Please advise how the overland flow from the above area of the site could be properly intercepted and discharged. Peripheral surface channels shall be provided along the site boundary to collect the surface runoff accrued on the application site and to intercept the overland flow from the adjacent lands.	Since the terrain of the area is slightly sloping, stormwater channels were provided at the lowest points to facilitate the collection of rainwater.	
(iv)	Please provide connection details with cross section for CP35 to CP11.	Please refer to the "detail "x" on the Drawing No. ST-3C (Annex I).	
(v)	The existing drainage facilities, to which the stormwater of the development from the subject site would discharge, are not	Noted.	



	maintained by this office. The applicant should identify the owner of the existing drainage facilities to which the proposed connection will be made and obtain consent from the owner prior to commencement of the proposal works. In the case that it is a local village drains, DO/YL should be consulted.	
(vi)	The applicant should check and ensure the hydraulic capacity of the existing drainage facilities would not be adversely affected by the captioned development. Please provide site photos to show existing condition of the existing drainage facilities which receives the discharge from the application site.	Please refer to the "Design Statement" and "Site Photo" (Annex I).
(vii)	Please provide hydraulic calculations for the proposed discharging drainage facility demonstrating its capacity to cater for the surface runoff from the entire application site.	Please refer to the "Design Statement" (Annex I).
(viii)	Please clarify whether any walls or hoarding would be erected along the site boundary. Where walls or hoarding are erected are laid along the site boundary, adequate opening should be provided to intercept the existing overland flow passing through the site.	Noted, the application site does not have any walls or hoardings.
(xi)	Please provide more cross sections in Section A direction showing the existing and proposed ground levels of the captioned site with respect to the adjacent areas.	Please refer to the "Section" on the Drawing No. ST-3C (Annex I).
(x)	The development should neither obstruct overland flow nor adversely affect existing natural streams, village drains, ditches and the adjacent areas, etc.	Noted.
(xi)	The applicant should consult DLO/YL and seek consent from the relevant owners for any drainage works to be carried out outside his	Noted.




	lot boundary before commencement of the	
	•	
	drainage works.	
Comr	ments received on 22/12/2023	
(i)	Please review if CP03 and CP04 can be	CP03 and CP04 cannot be combined. They
(7)	combined.	are reserved for the two sides of the land (different owners), facilitating their potential future development purposes (Annex I).
(ii)	For DETAIL "X", backdrop manhole should be provided as the level difference is greater than 600 mm according to SDM.	The level of CP35 has been changed, and the DETAIL "X" has also been updated. Please refer to the drawing No. ST-3C (Annex I).
(iii)	Photo of existing stream is missing. Please provide.	For existing stream, please refer to the ST-2C, Photos 3, 4 and 6 (Annex I).
(iv)	Design Statement - Please indicate the channel C-1 to 4 representing which channels.	Please refer to the Design Statement P.2 for indication of the channels (Annex I).
(v)	Please advise where is the 300UC hydraulic checking.	The 300UC hydraulic checking has been provided, please refer to the design statement (Annex I).
(vi)	It was noted in your response no. (viii) that no walls would be available, however there are walls showing in the sectional drawings. Please clarify if those are existing walls.	The application site (the Site) does not have any walls or hoardings, however, the surrounding area (i.e. the car parking area next to the Site and the private area Lot 3724 RP in D.D. 104) has walls. Additionally, the catchment area where from the highest point to the lowest point (drainage channels) do not have any wall (Annex I).




05 JAN 2024



CATCHPIT	CL	A 1	A 2	A 3	X 1
CP01 (CEDD DRAWING NO. C2405/1)	5.00	4.62			4.62
CP02 (CEDD DRAWING NO. C2405/1)	5.00	4.46			4.46
CP03 (CEDD DRAWING NO. C2405/1)	4.90	4.24			4.24
CP04 (CEDD DRAWING NO. C2405/1)	4.80	4.18			4.18
CP05 (CEDD DRAWING NO. C2405/1)	4.60	3.98			3.98
CP06 (CEDD DRAWING NO. C2405/1)	4.40	3.83			3.79
CP07 (CEDD DRAWING NO. C2405/1)	4.30	3.63			3.63
CP08 (CEDD DRAWING NO. C2405/1)	4.30	3.51			3.51
CP09 (CEDD DRAWING NO. C2405/1)	4.10	3.42			3.42
CP11 (CEDD DRAWING NO. C2405/1)	3.70	3.23	3.30		3.20
CP12 (WITH TRAP) (CEDD DRAWING NO. C2406/1)	3.50	3.11			2.97
CP28 (CEDD DRAWING NO. C2405/1)	5.04	4.61			4.61
CP29 (CEDD DRAWING NO. C2405/1)	5.04	4.48	4.48		3.64
CP30 (CEDD DRAWING NO. C2405/1)	5.04	4.61			4.61
CP31 (CEDD DRAWING NO. C2405/1)	5.04	4.57			4.57
CP32 (CEDD DRAWING NO. C2405/1)	5.04	4.43	4.62		4.43
CP33 (CEDD DRAWING NO. C2405/1)	5.04	4.66			4.66
CP34 (CEDD DRAWING NO. C2405/1)	5.04	4.43	4.50		4.43
CP35 (CEDD DRAWING NO. C2405/1)	5.04	4.28	4.28	4.46	4.28
CP36 (CEDD DRAWING NO. C2405/1)	5.04	4.58			4.58
EX.CP	3.22	2.72			2.25

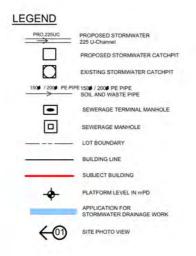

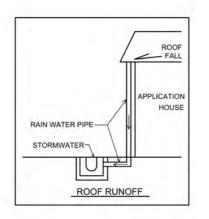



APPLICATION SITE

ii) 3559 S.A ii) 3559 S.B iii) 3540 S.B ss.1 iv) 3540 S.B ss.2 v) 3540 S.B ss.3

3559 S.A vi) 3540 S.B 3559 S.B vii) 3540 S.B


vi) 3540 S.B ss.4 vii) 3540 S.B ss.5 viii) 3540 S.B ss.6 YUEN LONG, N.T.

STORMWATER DRAINAGE WORK ST-2C

DRAWING DATE 05 JAN 2024 This drawings and all related information are property of Solar-lil Design Consulting Limited, any use must be approved by the company.

Solar-lil Design Consulting Limited

景佑設計工程顧問有限公司

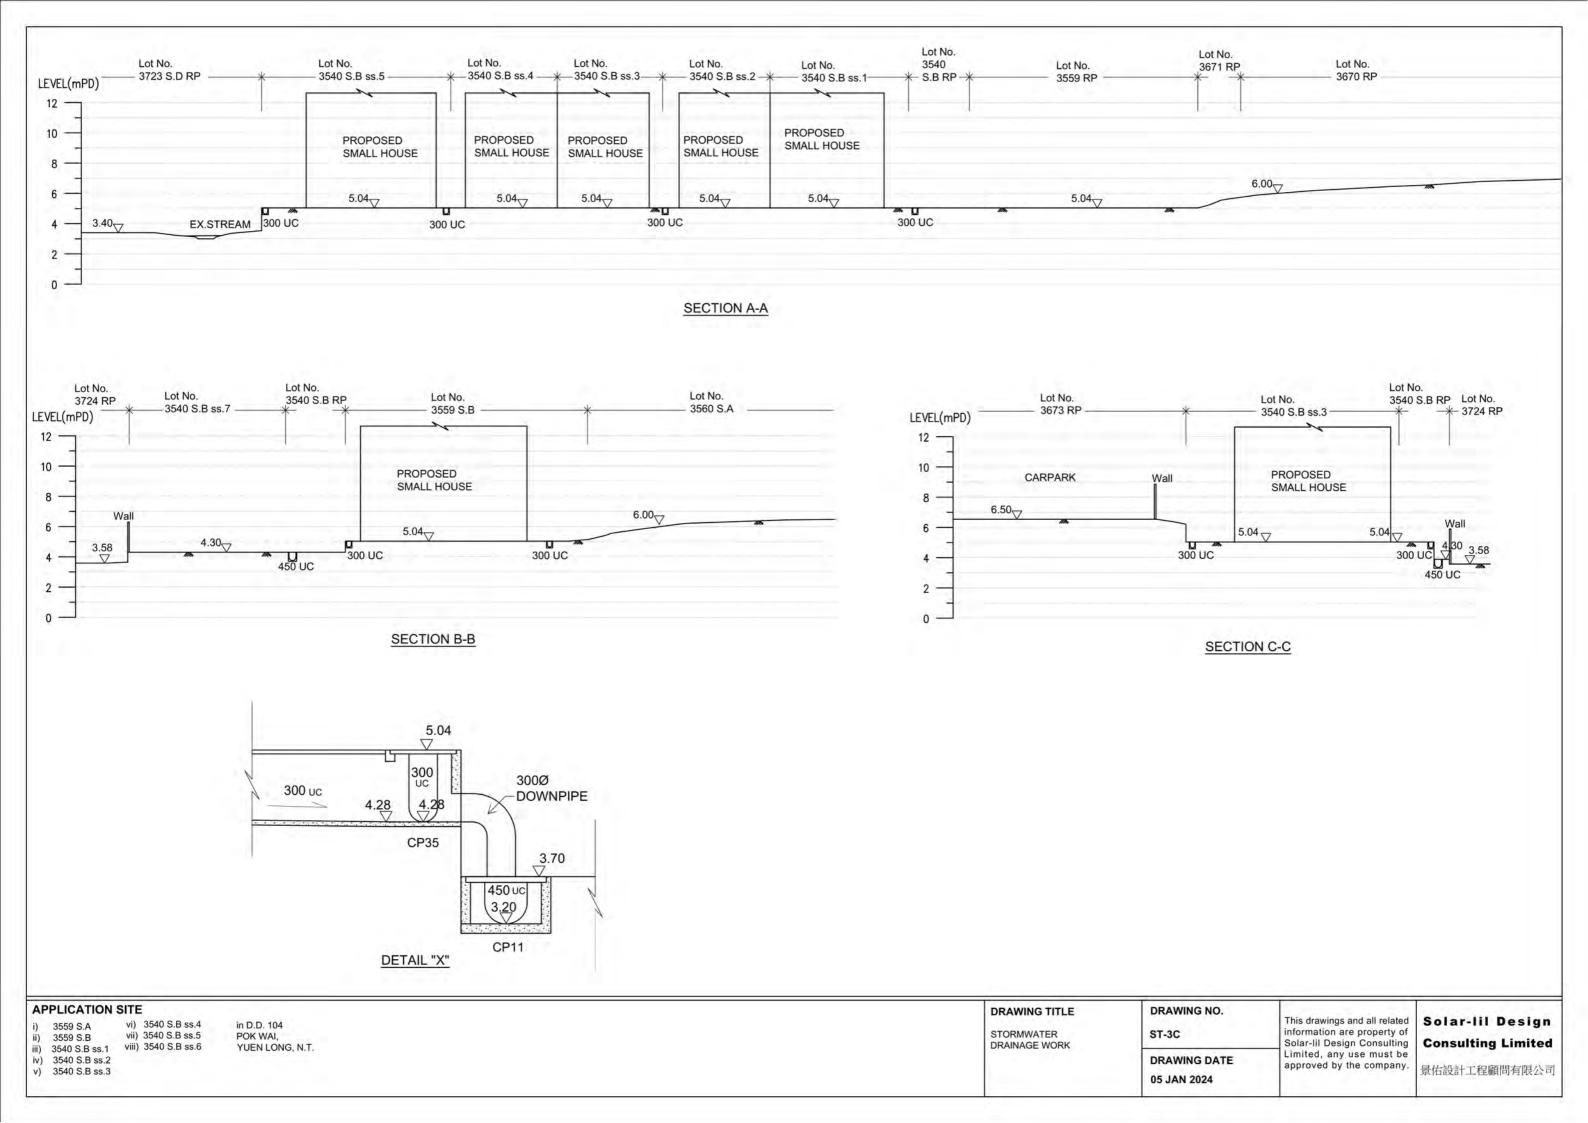

Date: 05-JAN-2024

APPLICATION SITE

D.D. 104 POK WAI, YUEN LONG, N.T.

Design of Surface Drainage System

Design Statement

- 1 Design Based on a 200 year return period storm
- 2 Maximum run-off estimation is based on the "Rational Method", i.e.

$$Q = K.I.A / 60$$

where,

Q = Max runoff (1 / min)

 $\label{eq:Kampoff} K = \text{Run-off mean intesity rainfall(mm/min)} \text{ which depends on the} \\ \text{time concentration } t$

$$t = 0.14465 * (L/H^{0.2} * A^{0.1})$$

H = Average fall (m per 100m) from summit of catchment to the point of desi $_{1}(\delta h/\delta L)/100$

L = Distance in metres measured on the line of natural flow between the design section and that point of the catchment from which water would take the longest time to reach the design section.

- 3 Design channels referred to Chapter 8 of the Geotechnical Manual for Slopes, GEO.
- 4 Design of underground pipes referred to the Municipal Group Design Handbook, 1990.

Discharge from Catchment


Area	Area	L	δh	δL	$H((\delta h / \delta L) / 100)$	Time Conc t	i.	For Permanent drainage	Q
	(m^2)	(m)	(m)	(m)	(m/100m)	(min)	(mm/hr)	i x1.138	(1/min)
Area-A	2386	141	2.5	89	0.0003	48.1	175	199	7920
Area-B	1534	118	2.9	60	0.0005	37.7	190	216	5529
Area-C	660	84	3	52	0.0006	28.2	215	245	2692
Area-D	88	47	1.1	31	0.0004	21.3	240	273	401
Area-E	12	18	0.20	17	0.0001	12.4	290	330	67
Area-F	421	52	2.26	30	0.0008	17.3	255	290	2037
Area-G	25	18	0.10	13	0.0001	12.5	290	330	138
Area-H	378	52	0.50	37	0.0001	24.7	225	256	1614
Area-K	438	34	0.50	25	0.0002	14.7	270	307	2243

Channel	Area	Total Q	Channel Size	Gradient	Capacity of Channel	Velocity >1.3 & < 5	Check
		(l/min)	(mm)		(l/min)	(m/s)	
Channel-A	А	7920	450	1:68	29000	2.6	OK
Channel-B	A+B	13449	450	1:78	27000	2.5	OK
Channel-C	A+B+C	16141	450	1:105	25000	2.3	OK
Channel-D	A+B+C+D+F+G	18717	450	1:109	24500	2.2	OK
Channel-E	A+B+C+D+E+F+G+H+K	22641	450	1:109	24500	2.2	OK
Channel-F	F	2037	300	1:100	5000	1.3	OK
Channel-G	F+G	2175	300	1:30	16000	3.1	OK
Channel-H	Н	1614	300	1:100	5000	1.3	OK
Channel-K	K	2243	300	1:100	5000	1.3	OK

	APPLICATION SITE
	Lot Nos.
	3540 S.B ss.13 & 3555 S.A
	3540 S.B ss.12, 3540 S.C ss.20 & 3555 S.E
	3540 S.C ss.19 & 3555 S.C
	3540 S.C ss.18
	3540 S.C ss.12 & 3540 S.C ss.13
	3540 S.C ss.11D.D.104
	3540 S.C ss.17 & 3556 S.C
	3540 S.C ss.16 & 3556 S.B
	3540 S.C ss.4, 3540 S.C ss.14 & 3556 S.A
	3540 S.C ss.3
	3540 S.C ss.10
	3540 S.C ss.9
	3540 S.C ss.2
	3540 S.C ss.1 & 3559 S.C
	3540 S.B ss.8 & 3540 S.C ss.5
	3540 S.B ss.7
	3540 S.C ss.7
	3559 S.A
	3559 S.B
	3540 S.B ss.1
	3540 S.B ss.2
	3540 S.B ss.3
	3540 S.B ss.4
	3540 S.B ss.5
	3540 S.B ss.6
	in D.D. 104
	POK WAI,
,	YUEN LONG, N.T.

Date: 05-JAN-2024

Channel and Catchment Area

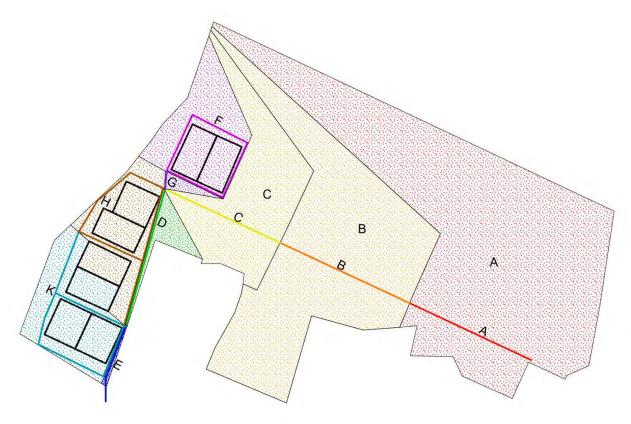

Channel	Catchment Area
Channel-A ———	Area-A
Channel-B ———	Area-B
Channel-C —	Area-C
Channel-D ———	Area-D
Channel-E ———	Area-E
Channel-F ———	Area-F
Channel-G ———	Area-G
Channel-H ———	Area-H
Channel-K ———	Area-K



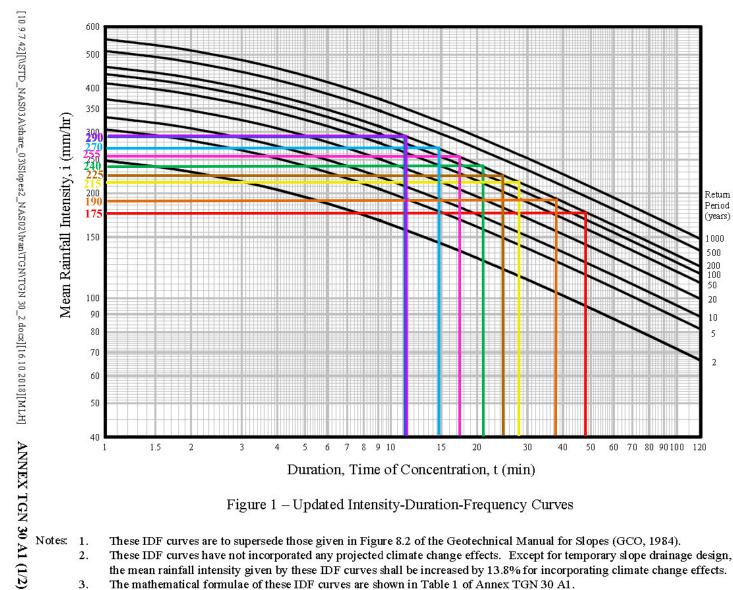


Figure 1 – Updated Intensity-Duration-Frequency Curves

Notes: 1.

- These IDF curves are to supersede those given in Figure 8.2 of the Geotechnical Manual for Slopes (GCO, 1984).
- These IDF curves have not incorporated any projected climate change effects. Except for temporary slope drainage design, the mean rainfall intensity given by these IDF curves shall be increased by 13.8% for incorporating climate change effects.
- The mathematical formulae of these IDF curves are shown in Table 1 of Annex TGN 30 A1.




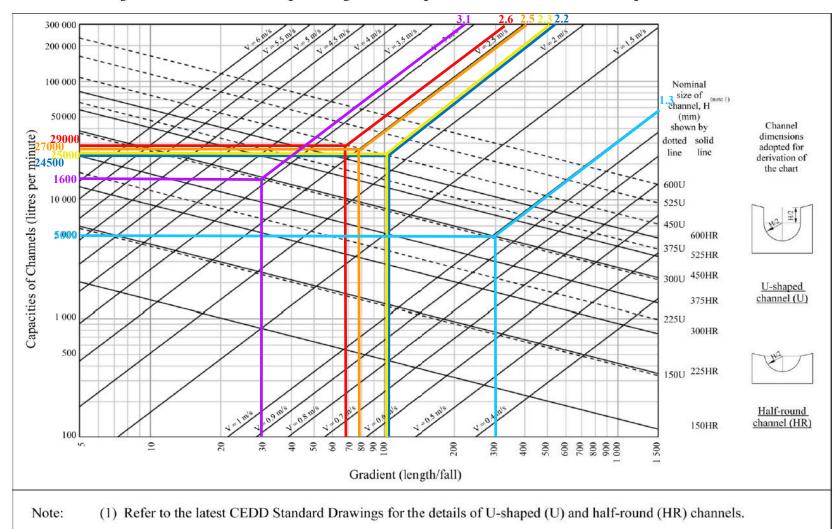



Figure 1 - Chart for the rapid design of U-shaped and half-round channels up to 600 mm



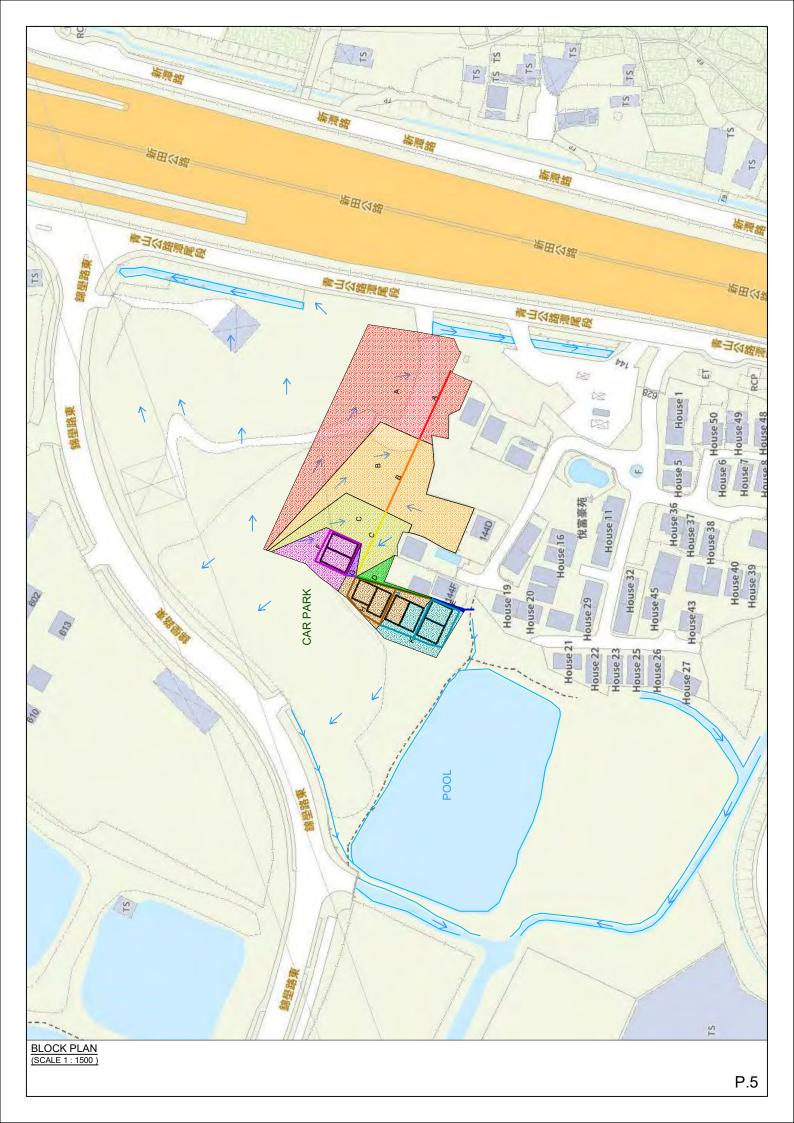

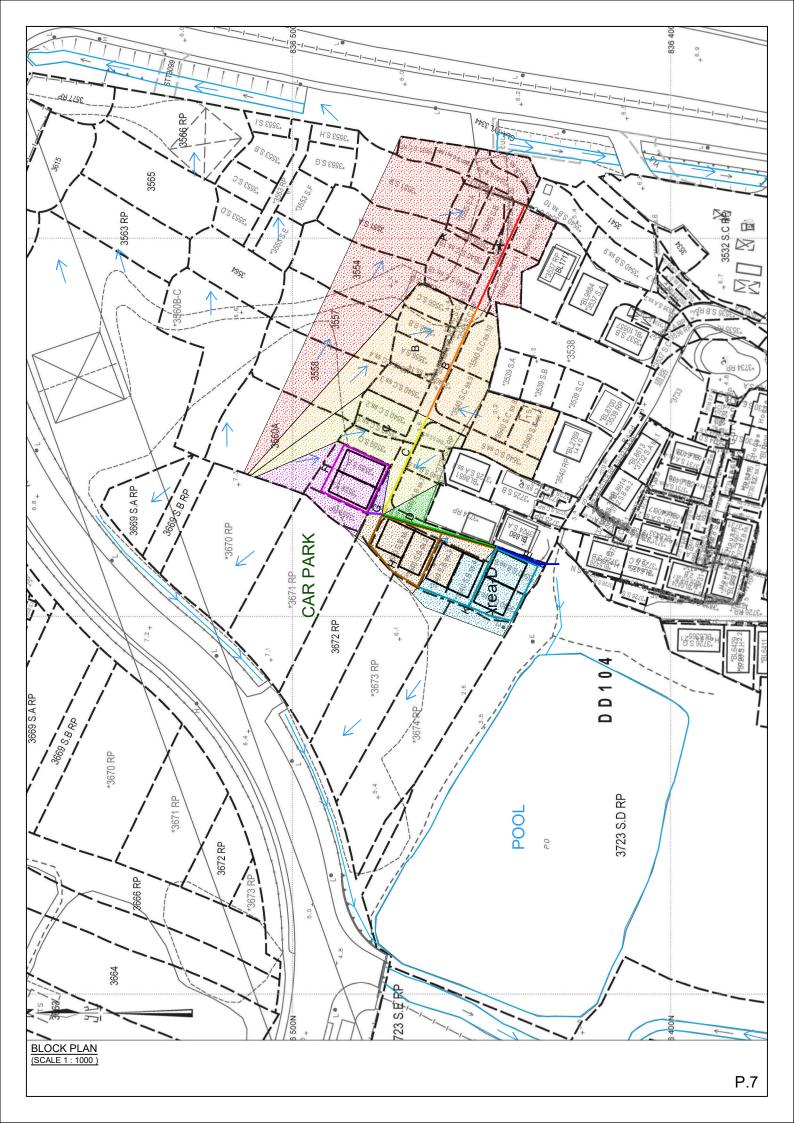

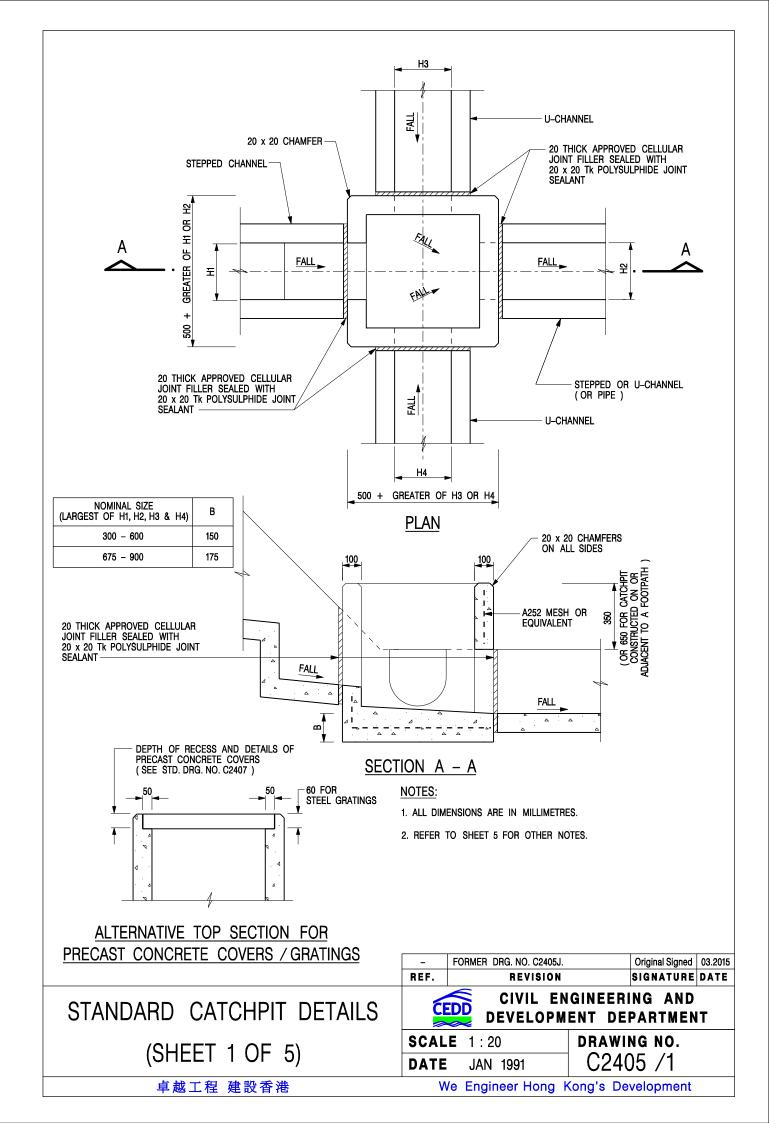

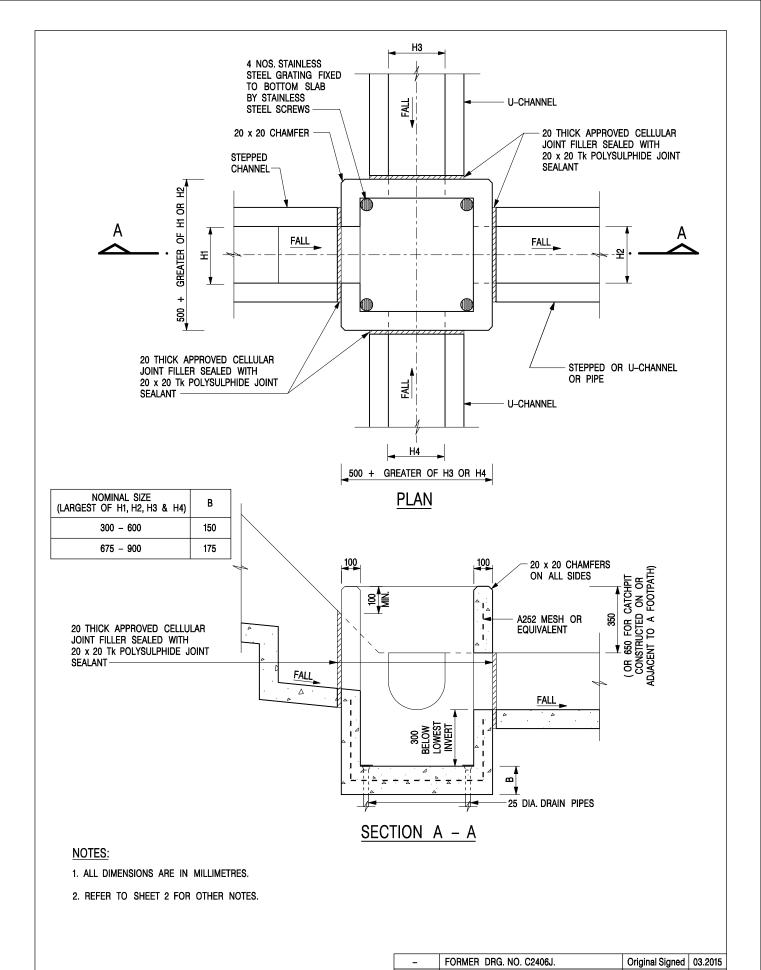

CATCHPIT WITH TRAP (SHEET 1 OF 2)

CIVIL ENGINEERING AND DEVELOPMENT DEPARTMENT

SCALE 1:20

DATE JAN 1991

REF. REVISION SIGNATURE DATE

DATE JAN 1991


SIGNATURE DATE


DATE JAN 1991

SIGNATURE DATE

DATE JAN 1991

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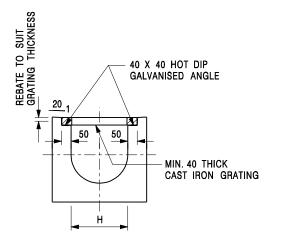


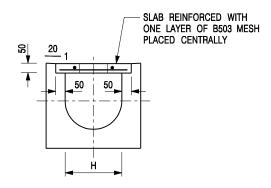
TYPICAL SECTION

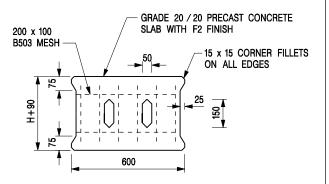PLAN OF SLAB

U-CHANNELS WITH PRECAST CONCRETE SLABS

(UP TO H OF 525)



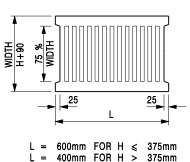

TYPICAL SECTION

CAST IRON GRATING

(DIMENSIONS ARE FOR GUIDANCE ONLY, CONTRACTOR MAY SUBMIT EQUIVALENT TYPE)

U-CHANNEL WITH CAST IRON GRATING

(UP TO H OF 525)

NOTES:

- 1. ALL DIMENSIONS ARE IN MILLIMETRES.
- 2. H=NOMINAL CHANNEL SIZE.
- 3. ALL CAST IRON FOR GRATINGS SHALL BE GRADE EN-GJL-150 COMPLYING WITH BS EN 1561.
- 4. FOR COVERED CHANNELS TO BE HANDED OVER TO HIGHWAYS DEPARTMENT FOR MAINTENANCE, THE GRATING DETAILS SHALL FOLLOW THOSE AS SHOWN ON HyD STD. DRG. NO. H3156.

Ε	NOTES 3 & 4 AMENDED.	Original Signed	12.2014
D	NOTE 4 ADDED.	Original Signed	06.2008
С	MINOR AMENDMENT. NOTE 3 ADDED.	Original Signed	12.2005
В	NAME OF DEPARTMENT AMENDED.	Original Signed	01.2005
Α	CAST IRON GRATING AMENDED.	Original Signed	12.2002
REF.	REVISION	SIGNATURE	DATE

COVER SLAB AND CAST IRON GRATING FOR CHANNELS




CIVIL ENGINEERING AND DEVELOPMENT DEPARTMENT

 SCALE 1:20
 DRAWING NO.

 DATE JAN 1991
 C2412E

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ALTERNATIVE TOP SECTION FOR PRECAST CONCRETE COVERS / GRATINGS

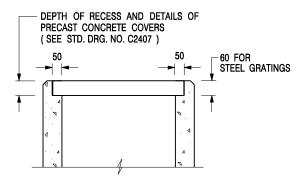NOTES:

- 1. ALL DIMENSIONS ARE IN MILLIMETRES.
- 2. ALL CONCRETE SHALL BE GRADE 20 /20.
- 3. CONCRETE SURFACE FINISH SHALL BE CLASS U2 OR F2 AS APPROPRIATE.
- 4. FOR DETAILS OF JOINT, REFER TO STD. DRG. NO. C2413.
- 5. CONCRETE TO BE COLOURED AS SPECIFIED.
- UNLESS REQUESTED BY THE MAINTENANCE PARTY AND AS DIRECTED BY THE ENGINEER, CATCHPIT WITH TRAP IS NORMALLY NOT PREFERRED DUE TO PONDING PROBLEM.
- 7. UPON THE REQUEST FROM MAINTENANCE PARTY, DRAIN PIPES AT CATCHPIT BASE CAN BE USED BUT THIS IS FOR CATCHPITS LOCATED AT SLOPE TOE ONLY AND AS DIRECTED BY THE ENGINEER.
- FOR CATCHPITS CONSTRUCTED ON OR ADJACENT TO A FOOTPATH, STEEL GRATINGS (SEE DETAIL 'A' ON STD. DRG. NO. C2405 /2) OR CONCRETE COVERS (SEE STD. DRG. NO. C2407) SHALL BE PROVIDED AS DIRECTED BY THE ENGINEER.
- 9. IF INSTRUCTED BY THE ENGINEER, HANDRAILING (SEE DETAIL 'J' ON STD. DRG. NO. C2405 /5; EXCEPT ON THE UPSLOPE SIDE) IN LIEU OF STEEL GRATINGS OR CONCRETE COVERS CAN BE ACCEPTED AS AN ALTERNATIVE SAFETY MEASURE FOR CATCHPITS NOT ON A FOOTPATH NOR ADJACENT TO IT. TOP OF THE HANDRAILING SHALL BE 1 000 mm MIN. MEASURED FROM THE ADJACENT GROUND LEVEL.
- 10. MINIMUM INTERNAL CATCHPIT WIDTH SHALL BE 1 000 mm FOR CATCHPITS WITH A HEIGHT EXCEEDING 1 000 mm MEASURED FROM THE INVERT LEVEL TO THE ADJACENT GROUND LEVEL. AND, STEP IRONS (SEE DSD STD. DRG. NO. DS1043) AT 300 ℃ STAGGERED SHALL BE PROVIDED. THICKNESS OF CATCHPIT WALL FOR INSTALLATION OF STEP IRONS SHALL BE INCREASED TO 150 mm.
- FOR RETROFITTING AN EXISTING CATCHPIT WITH STEEL GRATING, SEE DETAIL 'G' ON STD. DRG. NO. C2405 /4.
- SUBJECT TO THE APPROVAL OF THE ENGINEER, OTHER MATERIALS CAN ALSO BE USED AS COVERS / GRATINGS.

REF.	REVISION	SIGNATURE	DATE
-	FORMER DRG. NO. C2406J.	Original Signed	03.2015
Α	MINOR AMENDMENT.	Original Signed	04.2016

CATCHPIT WITH TRAP (SHEET 2 OF 2)

卓越工程 建設香港



CIVIL ENGINEERING AND DEVELOPMENT DEPARTMENT

SCALE 1:20 **DATE** JAN 1991

DRAWING NO. C2406 /2A

We Engineer Hong Kong's Development



Our Ref. : DD104 Lot 3540 S.B ss.1 & VL

Your Ref. : TPB/A/YL-NSW/317

The Secretary **Town Planning Board** 15/F, North Point Government office 333 Java Road

By Email

22 January 2024

North Point, Hong Kong

Dear Sir,

4th Further Information

Proposed Filling of Land for Permitted Houses (New Territories Exempted Houses) in "Village Type Development" Zone, Various Lots in D.D. 104, Pok Wai, Yuen Long, New Territories

(S.16 Planning Application No. A/YL-NSW/317)

We are writing to submit Further Information to provide clarifications of the subject application, details are as follows:

The target completion time of the proposed development is April 2024 (Appendix I). (i)

Should you require more information regarding the application, please contact our Mr. Orpheus LEE at (852) 2339 0884 / orpheuslee@r-riches.com.hk or the undersigned at your convenience. Thank you for your kind attention.

Yours faithfully,

For and on behalf of

R-riches Property Consultants Limited

Louis TSE

Town Planner

cc DPO/FSYLE, PlanD

(Attn.: Mr. Gary LAM


(Attn.: Mr. Edison KWAN

email: gtllam@pland.gov.hk

email: ekckwan@pland.gov.hk)





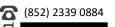



	7. Anticipated Completion Time of the Development Proposal 擬議發展計劃的預計完成時間					
擬議發展計劃預期完成的年份及(Separate anticipated completion Government, institution or community (申請人須就擬議的公眾休憩用) April 2024	投月份 (分 times (in unity facili 地及政府	month and year) should be provided for the proposed public open space and				
8. Vehicular Access Arra 擬議發展計劃的行	_	et of the Development Proposal 安排				
Any vehicular access to the site/subject building? 是否有車路通往地盤/有關建築物?	Yes 是 No 否	 ✓ There is an existing access. (please indicate the street name, where appropriate) 有一條現有車路。(請註明車路名稱(如適用)) Accessible from Castle Peak Road - Tam Mi via a local access □ There is a proposed access. (please illustrate on plan and specify the width) 有一條擬議車路。(請在圖則顯示,並註明車路的闊度) 				
Any provision of parking space for the proposed use(s)? 是否有為擬議用途提供停車位?	Yes 是 No 否	□ (Please specify type(s) and number(s) and illustrate on plan) 請註明種類及數目並於圖則上顯示) Private Car Parking Spaces 私家車車位 Motorcycle Parking Spaces 電單車車位 Light Goods Vehicle Parking Spaces 輕型貨車泊車位 Medium Goods Vehicle Parking Spaces 中型貨車泊車位 Heavy Goods Vehicle Parking Spaces 重型貨車泊車位 Others (Please Specify) 其他 (請列明)				
Any provision of loading/unloading space for the proposed use(s)? 是否有為擬議用途提供上落客貨車位?	Yes 是 No 否	□ (Please specify type(s) and number(s) and illustrate on plan) 請註明種類及數目並於圖則上顯示) Taxi Spaces 的士車位 Coach Spaces 旅遊巴車位 Light Goods Vehicle Spaces 輕型貨車車位 Medium Goods Vehicle Spaces 中型貨車車位 Heavy Goods Vehicle Spaces 重型貨車車位 Others (Please Specify) 其他 (請列明)				

Relevant Extracts of the Town Planning Board Guidelines for <u>Application for Developments within Deep Bay Area under Section 16 of the Town</u> <u>Planning Ordinance</u> (TPB PG-No. 12C)

Wetland Buffer Area (WBA)

- (a) The intention of the WBA is to protect the ecological integrity of the fish ponds and wetland within the Wetland Conservation Area (WCA) and prevent development that would have a negative off-site disturbance impact on the ecological value of fish ponds.
- (b) Within the WBA, for development or redevelopment which requires planning permission, an ecological impact assessment (EcoIA) would need to be submitted. Some local and minor uses (including temporary uses) are exempted from the requirement of EcoIA.
- (c) Applications for new open storage or port back-up uses within the WBA, whether temporary or permanent, would normally not be allowed in view of the adverse disturbances of such activities on birds, in particular for those uses involving filling of contiguous ponds. However, open storage or container back-up uses located close to the Lok Ma Chau crossing and without involving pond filling might be sympathetically considered by the Board in view of the genuine need to facilitate cross-boundary movements of goods in the area.

Appendix A

<u>List of Uses Exempted from Ecological Impact Assessment within the Wetland Buffer Area</u>

For planning applications involving uses/development within the Wetland Buffer Area, the following uses/development are exempted from the requirement of ecological impact assessment as part of the submission to the Board:

- Temporary Uses
- Agricultural Use (except in SSSI Zone)
- Ancestral Hall
- Bank#
- Barbecue Spot
- Barber Shop#
- Beauty Parlour#
- Burial Ground
- Clinic/Polyclinic*
- Electricity Substation of single storey
- Government Refuse Collection Point^
- House (Alteration, modification and/or redevelopment to the existing building bulk only)
- New Territories Exempted Houses
- Off-Course Betting centre#
- On-farm Domestic Structure
- Photographic Studio#
- Playground/Playing Field in "V" and "R(D)" zones
- Police Post/Police Reporting Centre
- Post Office*
- Private Club#
- Public Convenience
- Public Library*
- Public Utility Installation (electricity mast, lamp pole, pipeline and telephone booth only)^
- Pumping Station of single storey
- Refreshment Kiosk
- Retail Shop#
- School*
- Showroom excluding Motor-vehicle Showroom#
- Shrine
- Social Welfare Facility*
- Tent Camping Site

Note:

- # other than free-standing building
- * other than free-standing building exceeding 3 storeys
- ^ not applicable to the "Other Specified Uses" annotated "Eco-lodge" zone on the Ma Tso Lung and Hoo Hok Wai Outline Zoning Plan

Previous s.16 Applications covering the Application Site on the Approved Nam Sang Wai Outline Zoning Plan No. S/YL-NSW/8

Approved Application

	Application No.	Proposed Use(s)/ Development(s)	<u>Date of</u> <u>Consideration</u> (RNTPC/TPB)	Approval Conditions
1.		Proposed Filling of Land for Permitted Houses (New Territories Exempted Houses)	5.5.2023 Approved by RNTPC	1 to 2

Approval Conditions

- 1. the submission of a drainage proposal before the commencement of the land filling works on the site
- 2. the implementation of the drainage proposal upon completion of the land filling works on the site

Rejected Application

No.	Application No.	Use(s)/Development(s)	Date of Consideration (RNTPC/TPB)	Rejection Reason(s)
1.	A/YL-NSW/57	Temporary Open Storage of Vehicles for Sale and Machineries for 12 Months	26.3.1999 Rejected by RNTPC	(1), (2), (3) & (4)

Rejection Reason(s):

- (1) The development is not in line with the planning intention of the "Village Type Development" zone which is for village development and expansion. There is insufficient justification in the submission for a departure from the planning intention, even on a temporary basis.
- (2) The development is not compatible with the land uses of the surrounding areas which include the marshes, fish ponds and village houses.
- (3) The site falls within Deep Bay Buffer Zone 2. The development does not comply with the Town Planning Board Guidelines for "Application for Developments within Deep Bay Buffer Zones" in that there is insufficient information in the submission to demonstrate that the development would not have significant impacts on the environment, ecology and drainage in the area.
- (4) The approval of the application would set an undesirable precedent for other similar applications. The cumulative effect of approving such similar applications would result in a general degradation of the environment of the area.

Similar s.16 Applications within the same "V" Zone on the Approved Nam Sang Wai Outline Zoning Plan No. S/YL-NSW/8

Approved Applications

	Application No.	Proposed Use(s)/ Development(s)	Date of Consideration (RNTPC/TPB)
1.		Proposed Temporary Public Vehicle Park (excluding Container Vehicle) for a Period of 5 Years and associated Filling and Excavation of Land	23.12.2022 Approved by RNTPC
2.		Proposed Temporary Public Vehicle Park (Excluding Container Vehicle) with Ancillary Electric Vehicle Charging Facility and Office for a Period of 5 Years and Associated Filling of Land	27.10.2023 Approved by RNTPC

Recommended Advisory Clauses

- (a) to note the comments of the Commissioner for Transport (C for T), Transport Department that:
 - the subject site is connected to public road via a section of a local track which is not managed by Transport Department. The applicant should arrange by themselves if necessary, and should seek consent from the relevant land owner(s) and/or Lands Department on the right of using the vehicular access; and
 - Sufficient manoeuvring space shall be provided within the subject site. No vehicle is allowed to queue back to or reverse onto/from the subject site at any time during the planning approval period.
- (b) to note the comments of the Chief Highway Engineer/New Territories West, Highways Department (CHE/NTW, HyD) that:
 - the proposed access arrangement of the application site should be commented and approved by Transport Department;
 - HyD shall not be responsible for the maintenance of any access connecting the application site and Castle Peak Road Tam Mi. Presumably, the relevant department will provide comments, if any; and
 - adequate drainage measures shall be provided to prevent surface water running from the application site to the nearby public roads and drains.
- (c) to note the comments of the Director of Environmental Protection (DEP) that:
 - the applicant is advised to follow the Recommended Pollution Control Clauses for Construction Contracts to minimize the environmental impacts during construction stage; and
 - it is the applicant's responsibility to comply with all relevant environmental legislations during construction of the project.
- (d) to note the comments of the Director of Fire Services (D of FS) that the applicant is reminded to observe the requirements as stipulated in "New Territories Exempted House A Guide to Fire Safety Requirements".
- (e) to note the comments of the Chief Building Surveyor/New Territories West, Buildings Department (CBS/NTW, BD) that:
 - site formation works are building works under the control of the Buildings Ordinance (BO). Before the proposed filing of land is to be carried out on the application site, the prior approval and consent of the Building Authority (BA) should be obtained, otherwise they are Unauthorized Building Works. An Authorized Person (AP) should be appointed as the co-ordinator for the proposed site formation in accordance with the BO; and

- notwithstanding the paragraph above, the Director of Lands may issue a certificate of exemption from prior approval and consent of the BA in respect of site formation works in the New Territories under the Buildings Ordinance (Application to the New Territories) Ordinance. The applicant may approach District Land Officer/Yuen Long or seek AP's advice for details.
- (f) to note the comments of the Chief Engineer/Construction, Water Supplies Department (CE/C, WSD) that:
 - for provision of water supply to the development, the applicant may need to extend his/her inside services to the nearest suitable government water mains for connection; and
 - the applicant shall resolve any land matter (such as private lots) associated with the provision of water supply and shall be responsible for the construction, operation and maintenance of the inside services within the private lots to WSD's standards.
- (g) to note the comments of the Director of Electrical and Mechanical Services (DEMS) that the parties concerned with planning, designing, organizing and supervising any activity near the underground cable or overhead line should approach the electricity supplier (i.e. CLP Power) for the requisition of cable plans (and overhead line alignment drawings, where applicable) to find out whether there is any underground cable and/or overhead line within and/or in the vicinity of the application site. They should also be reminded to observe the Electricity Supply Lines (Protection) Regulation and the "Code of Practice on Working near Electricity Supply Lines" established under the Regulation when carrying out works in the vicinity of the electricity supply lines.
- (h) to note the comments of the Chief Engineer/Mainland North, Drainage Services Department (CE/MN, DSD) that:
 - DSD has the following comments on the drainage proposal submitted by the applicant from public drainage point of view:
 - 1. Please review if CP03 and CP04 can be combined.
 - 2. For DETAIL "X", backdrop manhole should be provided as the level difference is greater than 600 mm according to SDM.
 - 3. Photo of existing stream is missing. Please provide.
 - 4. Design Statement Please indicate the channel C-1 to 4 representing which channels.
 - 5. Please advise where is the 300UC hydraulic checking.
 - 6. It was noted in your response no. (viii) that no walls would be available, however there are walls showing in the sectional drawings. Please clarify if those are existing walls.
 - the development should neither obstruct overland flow nor adversely affect existing natural streams, village drains, ditches and the adjacent areas, etc.; and

• the applicant should consult DLO/YL, LandsD and seek consent from the relevant owners for any drainage works to be carried out outside his lot boundary before commencement of the drainage works.