只會在收到所有必要的資料及文件**後才正式確認收到** 申請的日期。

This cocument is received on 26 APR 33.

The Town Planning Board will formally acknowledge the date of receipt of the application only upon receipt

<u>Form No. S16-III</u> 表格第 S16-III 號

# APPLICATION FOR PERMISSION

# UNDER SECTION 16 OF THE TOWN PLANNING ORDINANCE

(CAP.131)

根據《城市規劃條例》(第131章) 第16條遞交的許可申請

Applicable to Proposal Only Involving Temporary Use/Development of Land and/or Building Not Exceeding 3 Years in Rural Areas or Renewal of Permission for such Temporary Use or Development\*

適用於祇涉及位於鄉郊地區土地上及/或建築物內進行為期不超過三年的臨時用途/發展或該等臨時用途/發展的許可續期的建議\*

\*Form No. S16-I should be used for other Temporary Use/Development of Land and/or Building (e.g. temporary use/developments in the Urban Area) and Renewal of Permission for such Temporary Use or Development.

\*其他土地上及/或建築物內的臨時用途/發展 (例如位於市區內的臨時用途或發展)及有關該等臨時用途/發展的許可續期,應使用表格第 S16-I 號。

Applicant who would like to publish the <u>notice of application</u> in local newspapers to meet one of the Town Planning Board's requirements of taking reasonable steps to obtain consent of or give notification to the current land owner, please refer to the following link regarding publishing the notice in the designated newspapers: <a href="https://www.info.gov.hk/tpb/en/plan\_application/apply.html">https://www.info.gov.hk/tpb/en/plan\_application/apply.html</a>

申請人如欲在本地報章刊登<u>申請通知</u>,以採取城市規劃委員會就取得現行土地擁有人的同意或通知現行土地擁有人所指定的其中一項合理步驟,請瀏覽以下網址有關在指定的報章刊登通知: https://www.info.gov.hk/tpb/tc/plan\_application/apply.html

# General Note and Annotation for the Form

#### 填寫表格的一般指引及註解

- "Current land owner" means any person whose name is registered in the Land Registry as that of an owner of the land to which the application relates, as at 6 weeks before the application is made
  - 「現行土地擁有人」指在提出申請前六星期,其姓名或名稱已在土地註冊處註冊為該申請所關乎的 土地的擁有人的人
- 《 Please attach documentary proof 請來附證明文件
- ^ Please insert number where appropriate 請在適當地方註明編號

Please fill "NA" for inapplicable item 請在不適用的項目填寫「不適用」

Please use separate sheets if the space provided is insufficient 如所提供的空間不足,請另頁說明

Please insert a 「レ」 at the appropriate box 請在適當的方格内上加上「レ」號

For Official Use Only	\pplication \c :[[]] 널링	A region of the first term of	ST	646	
清智度每面欄	Date Received 收到日期		) ( A	. 33	

- 1. The completed form and supporting documents (if any) should be sent to the Secretary, Town Planning Board (the Board), 15/F, North Point Government Offices, 333 Java Road, North Point, Hong Kong. 申請人須把填妥的申請表格及其他支持申請的文件(倘有),送交香港北角渣華道 333 號北角政府合署 15 樓城市規劃委員會(下稱「委員會」)秘書收。
- 2. Please read the "Guidance Notes" carefully before you fill in this form. The document can be downloaded from the Board's website at <a href="http://www.info.gov.hk/tpb/">http://www.info.gov.hk/tpb/</a>. It can also be obtained from the Secretariat of the Board at 15/F, North Point Government Offices, 333 Java Road, North Point, Hong Kong (Tel: 2231 4810 or 2231 4835), and the Planning Enquiry Counters of the Planning Department (Hotline: 2231 5000) (17/F, North Point Government Offices, 333 Java Road, North Point, Hong Kong and 14/F, Sha Tin Government Offices, 1 Sheung Wo Che Road, Sha Tin, New Territories). in the state of the part of the part of the state of the part of the state of the part of the Board at 15/F, North Point Government Offices, 333 Java Road, North Point, Hong Kong and 14/F, Sha Tin Government Offices, 1 Sheung Wo Che Road, Sha Tin, New Territories). in the part of the Board at 15/F, North Point Government Offices, 333 Java Road, North Point, Hong Kong and 14/F, Sha Tin Government Offices, 1 Sheung Wo Che Road, Sha Tin, New Territories). In the part of the Board at 15/F, North Point Government Offices, 333 Java Road, North Point Government Offices, 1 Sheung Wo Che Road, Sha Tin, New Territories). In the part of the Planning Enquiry Counters of the Planning Enquiry Counters
- 3. This form can be downloaded from the Board's website, and obtained from the Secretariat of the Board and the Planning Enquiry Counters of the Planning Department. The form should be typed or completed in block letters. The processing of the application may be refused if the required information or the required copies are incomplete. 此表格可從委員會的網頁下載,亦可向委員會秘書處及規劃署的規劃資料查詢處索取。申請人須以打印方式或以正楷填寫表格。如果申請人所提交的資料或文件副本不齊全,委員會可拒絕處理有關申請。

1. Name of Applicant 申請人好	生名/名稱
(□Mr. 先生 /□Mrs. 夫人 /□Miss 小姐 /	□Ms. 女士 / ☑ Company 公司 / □ Organisation 機構 )
Chuen Kee Transportation Company	泉記運輸公司

2. Name of Authorised Agent (if applicable) 獲授權代理人姓名/名稱(如適用)
(□Mr. 先生 /□Mrs. 夫人 /□Miss 小姐 /□Ms. 女士 /☑Company公司 /□Organisation 機構)

R-riches Property Consultants Limited 盈卓物業顧問有限公司

3.	Application Site 申請地點	
(a)	Full address / location / demarcation district and lot number (if applicable) 詳細地址/地點/丈聚約份及地段號碼(如適用)	Lots 276 S.B RP, 277 S.B RP, 279 S.B RP (Part), 282 S.B RP, 283 S.B RP, 284, 285, 289, 321 RP (Part), 322, 323 and 324 in D.D. 99, Chau Tau, New Territories
(b)	Site area and/or gross floor area involved 涉及的地盤面積及/或總樓面面 積	☑Site area 地盤面積 4,242 sq.m 平方米☑About 約 ☑Gross floor area 總樓面面積 3,562 sq.m 平方米☑About 約
(c)	Area of Government land included (if any) 所包括的政府土地面積(倘有)	NA sq.m 平方米 □About 約

(d)	Name and number of the related statutory plan(s) 有關法定圖則的名稱及編號	statutory plan(s) Approved San Tin Outline Zoning Plan : S/YL-ST/8							
(e)	Land use zone(s) involved "Green Belt" Zone 涉及的土地用途地帶								
(f)	Vacant and occupied by temporary structures  Current use(s) 現時用途  (If there are any Government, institution or community facilities, please illustrate on plan and specify the use and gross floor area) (如有任何政府、機構或計區設施,設在關則上顯示,並註明用途及總樓面面積)								
4.	"Current Land Owner" of A	pplication Site 申請地點的「現行土地	——————— 也擁有人 」						
The	applicant 申請人 -								
	is the sole "current land owner" (pl 是唯一的「現行土地擁有人」" (i	ease proceed to Part 6 and attach documentary proof 背纖續填寫第 6 部分,並夾附業權證明文件)。	of ownership).						
ď									
	The application site is entirely on Go 申請地點完全位於政府土地上(請	vernment land (please proceed to Part 6). 继續填寫第6部分)。							
	Statement	ADT - CO - C							
5.	Statement on Owner's Conse 就土地擁有人的同意/通	· · · · · · · · · · · · · · · · · · ·							
(a)									
(b)	(b) The applicant 申請人 —  □ has obtained consent(s) of"current land owner(s)"".  已取得名「現行土地擁有人」"的同意。								
	Details of consent of "current land owner(s)" obtained 取得「現行土地擁有人」"同意的詳情								
	No. of 'Current Land Owner(s)' 「現行土地擁有人」數目  Lot number/address of premises as shown in the record of the Land (DD/MM/YYYY) 取得同意的日期 (日/月/年)								
		•							
	(Please use separate sheets if the space of any box above is insufficient, 如上列任何方格的空間不足,諸昇百說明)								

	Details of the "current land owner(s)" notified  已復通知「現行土地擁有人」"的詳細資料  No. of 'Current Lot number/address of premises as shown in the record of the given									
	Lai	. of Current id Owner(s)' 現行土地擁 人」數目	Lot number/address Land Registry wher 根據土地註冊處記	e notification(s	) has/have bed	in the record of the given given				
						•				
	(Plea	se use separate s	heets if the space of any	box above is ins	sufficient. 如上	:列任何方格的空	間不足,謝另頁說明			
<b>√</b>			le steps to obtain cons 【取得土地擁有人的[							
•	Reas	onable Steps to	o Obtain Consent of C	Owner(s) 取得	上地擁有人	的同意所採取的	<u> </u>			
		sent request for consent to the "current land owner(s)" on(DD/MM/YYYY)*** 於(日/月/年)向每一名「現行土地擁有人」*郵遞要求同意書*								
	Reasonable Steps to Give Notification to Owner(s) 向土地擁有人發出通知所採取的合理步驟									
			ices in local newspap (日/月/年)				YY) <sup>&amp;</sup>			
	Ø	posted notice in a prominent position on or near application site/premises on 21/4/2023 (DD/MM/YYYY)&								
			(日/月/年)		申請處所或附	付近的顯明位置	貼出關於該申請的遊			
	<b>\limes</b>	office(s) or ru 於	relevant owners' corpral committee on (日/月/年 小鄉事委員會 <sup>&amp;</sup>	21/4/2023	(DD/Mi	ለ/YYYY) <sup>&amp;</sup>				
	<u>Othe</u>	ers 其他								
		others (please 其他(請指明					•			
	-									
	-									

6. Type(s) of Application								
(A) Temporary Use/Development of Land and/or Building Not Exceeding 3 Years in Rural Areas								
	位於鄉郊地區土地上及/或建築物內進行為期不超過三年的臨時用途/發展							
(For Renewal of Permission for Temporary Use or Development in Rural Areas, please proceed to Part (B))								
(如屬位於鄉郊地區臨時用	途/發展的規劃許可續	月,請填寫(B)部分)						
(a) Proposed usc(s)/development 擬議用途/發展								
	(Please illustrate the detai	s of the proposal on a la	yout plan) (請用平面圖說明擬議詳情)					
(b) Effective period of permission applied for	Ø year(s) 年		3					
申請的許可有效期	☐ month(s)	固月						
(c) Development Schedule 發展網	節表							
Proposed uncovered land area		••••	sq.m <b>妇</b> About 約					
Proposed covered land area 携	<b>菲議有上蓋土地面積</b>	••••						
Proposed number of buildings	s/structures 擬議建築物。	<b>/構築物數目</b>	2					
Proposed domestic floor area	擬議住用樓面面積	••••	/sq.m □About 約					
Proposed non-domestic floor	area 擬議非住用樓面面	磺	3,562 sq.m ☑About 约					
Proposed gross floor area 擬語	凝總樓面面積	••••	3,562 sq.m 🗹 About 約					
		ace below is insuffici-	ole) 建築物/構築物的擬議高度及不同樓層 ent) (如以下空間不足,請另頁說明) BUILDING BEIGHT					
B1 (G/F) WAREHOUSE (EXCL. DANGERO (1/F) WAREHOUSE (EXCL. DANGERO		BOUT) 1,673 m² (ABOUT) 1,673 m² (ABOUT)	11 m (ABOUT)(2-STOREY)					
B2 (G/F) ANCILLARY CANTEEN (1/F) ANCILLARY OFFICE	109 m² (A)	OUT) 108 m² (ASOUT) . 108 m² (ASOUT)	8 m (ABOUT)(2-STOREY)					
	TOTAL 1,781 m²	(ABOUT) 3,562 m <sup>2</sup> (ABOUT)	***********					
Proposed number of car parking	spaces by types 不同種類	[停車位的擬議數目						
Private Car Parking Spaces 私家			4					
Motorcycle Parking Spaces 電單								
Light Goods Vehicle Parking Spa			3					
Medium Goods Vehicle Parking	·							
Heavy Goods Vehicle Parking Sp		*********						
Others (Please Specify) 其他 (言	背列明)	***						
Proposed number of loading/unloading spaces 上落客貨車位的擬議數目								
Taxi Spaces 的土車位								
Coach Spaces 旅遊巴車位		**********						
Light Goods Vehicle Spaces 輕差	型貨車車位		2					
Medium Goods Vehicle Spaces	中型货車車位							
Heavy Goods Vehicle Spaces 重								
Heavy Goods Vehicle Spaces 重型貨車車位 Others (Please Specify) 其他 (請列明) 1 (Container Vehicle)								
O mere (1 rease cheem) Settle (8			1 (Container Vehicle)					

Proposed operating hours 4: 1/2 1/2/2 Monday to Saturday from 09:00 to 19:00, no operation on Sunday and public holiday						
(d)	Any vehicular acces	ss to	s 足 [	appropriate) 有一條現有車路。(誰	access. (please indicate the 註明車路名稱(如適用)) Chau Road via a local acce	1
	是否有車路通往地 有關建築物?			There is a proposed acc	cess. (please illustrate on plan a 請在圖則顯示,並註明車路的	nd specify the width)
		No	否			
(e)	Impacts of Developm	ent Propos	al 擬詩	義發展計劃的影響		
	(If necessary, please u justifications/reasons 措施,否則請提供理	for not pro	oviding	to indicate the proposed me such measures. 如需要的記	asures to minimise possible adv 舌,請另頁註明可盡量減少可	能出現不良影響的
(i)	Does the	Yes 是	☐ Pi	lease provide details 請提	供詳情	
	development proposal involve			<del>"</del>		
	alteration of existing building?		• •			
	擬議發展計劃是		••			
	否包括現有建築   物的改動?	No否	<b>☑</b>			
		Yes 是	div	ersion, the extent of filling of land	oundary of concerned land/pond(s), a /pond(s) and/or excavation of land) /如界線,以及河道改道、填塘、填土	
			160 160	-		
	•			Diversion of stream 河道記	<b>收道</b>	
(ii)	Does the development proposal involve the operation on the			] Filling of pond 填塘 Area of filling 填塘面積 Depth of filling 填塘深度	sq.m 平方米 m 米	□About 約 □About 約
right? 擬議發展是否涉 及右列的工程?				] Filling of land 填土 Area of filling 填土面積 Depth of filling 填土厚度	4,242 sq.m. sq.m 平方米 not.more.than.1.6 m 米	☑About 約 □About 約
		·		] Excavation of land 挖土 Area of excavation 挖土面 Depth of excavation 挖土	ī積sq.m 平方米 深度	於 tuodA□ ; 於 tuodA□
		No否				
				對環境	Yes 會 □ Yes 會 □	No 不會 ☑ No 不會 ☑
			r supply	,對供水	Yes 會 □	No 不會 ☑
(iii) Would the		On drain			Yes 會 □ Yes 會 □	No 不會 ☑ No 不會 ☑
	development proposal cause any	Affected	by slop	es 受斜坡影響	Yes 🎃 🗌	No 不會 🗹
	adverse impacts?			ict 構成景觀影響 次伐樹木	Yes 曾 □ Yes 曾 □	No 不會 ☑ No 不會 ☑
	擬議發展計劃會 否 造 成 不 良 影	Visual I	npact 相	<b>構成視覺影響</b>	Yes 會 🗌	No 不會 🛭
	響?	Others (	Please S	Specify) 其他 (請列明)	Yes 會 □	No 不會 🗹
	•				•	

# Form No. S16-III 表格第 S16-III 號

diametel 說註明。 幹直徑)	tate measure(s) to minimise the impact(s). For tree felling, please state the number, at breast height and species of the affected trees (if possible) 整元減少影響的措施。如涉及砍伐樹木,請說明受影響樹木的數目、及胸高度的樹及品種(倘可)  Temporary Use or Development in Rural Areas 展的許可續期
(a) Application number to which the permission relates 與許可有關的申請編號	A//
(b) Date of approval 獲批給許可的日期	(DD 日/MM 月/YYYY 年)
(c) Date of expiry 許可屆滿日期	(DD 日/MM 月/YYYY 年)
(d) Approved use/development 已批給許可的用途/發展	
•	<ul> <li>□ The permission does not have any approval condition 許可並沒有任何附帶條件</li> <li>□ Applicant has complied with all the approval conditions 申請人已履行全部附帶條件</li> <li>□ Applicant has not yet complied with the following approval condition(s):</li> </ul>
(e) Approval conditions 附帶條件	申請人仍未履行下列附帶條件:  Reason(s) for non-compliance:
,	(Please use separate sheets if the space above is insufficient) (如以上空間不足,請另頁說明)
(f) Renewal period sought 要求的續期期間	□ year(s) 年 □ month(s) 個月

7. Justifications 理由
The applicant is invited to provide justifications in support of the application. Use separate sheets if necessary. 現請申請人提供申請理由及支持其申請的資料,如有需要,請另真說明)
Please refer to supplementary statement.
,

Form No. S16-III 表格第 S16-III 號
B. Declaration 聲明
hereby declare that the particulars given in this application are correct and true to the best of my knowledge and belief. 本人誰此聲明,本人就這宗申請提交的資料,據本人所知及所信,均屬真質無誤。
hereby grant a permission to the Board to copy all the materials submitted in this application and/or to upload such materials of the Board's website for browsing and downloading by the public free-of-charge at the Board's discretion. 本人現准許委員會的情將本人就此申請所提交的所有資料複製及/或上稅至委員會網站,供公眾免費瀏覧或下稅。
Signature ©署  Michael WONG  □ Applicant 申請人 / ☑ Authorised Agent 獲授權代理人
Name in Block Letters Position (if applicable) 姓名(請以正楷填寫) 職位 (如適用)
Professional Qualification(s)  □ Member 會員 / □ Fellow of 資深會員 □ HKIP 香港規劃師學會 / □ HKIA 香港建築師學會 / □ HKIS 香港測量師學會 / □ HKIE 香港工程師學會 / □ HKILA 香港園境師學會/ □ HKIUD 香港城市設計學會 □ RPP 註冊專業規劃師 Others 其他
n behalf of R-Riches Property Consultants Limited
☑ Company 公司 / □ Organisation Name and Chortel Dicable)機構名稱及蓋章(如適用)
Date 日期 21/4/2023 (DD/MM/YYYY 日/月/年)
Remark 備註
he materials submitted in this application and the Board's decision on the application would be disclosed to the public. Such naterials would also be uploaded to the Board's website for browsing and free downloading by the public where the Board onsiders appropriate. 長員會會向公眾披露申請人所遞交的申請資料和委員會對申請所作的決定。在委員會認為合適的情况下,有關申請資料亦會上載至委員會網頁供公眾免費瀏覽及下載。
Warning 警告

Any person who knowingly or wilfully makes any statement or furnish any information in connection with this application, which is false in any material particular, shall be liable to an offence under the Crimes Ordinance. 任何人在明知或故意的情况下,就這宗申請提出在任何要項上是虛假的陳述或資料,即屬違反《刑事罪行條例》。

# Statement on Personal Data 個人資料的聲明

- 1. The personal data submitted to the Board in this application will be used by the Secretary of the Board and Government departments for the following purposes: 委員會就這宗申請所收到的個人資料會交給委員會秘售及政府部門,以根據《城市規劃條例》及相關的城市規劃委員會規劃指引的規定作以下用途:
  - (a) the processing of this application which includes making available the name of the applicant for public inspection when making available this application for public inspection; and 處理這宗中請,包括公布這宗申請供公眾查閱,同時公布申請人的姓名供公眾查閱:以及
  - (b) facilitating communication between the applicant and the Secretary of the Board/Government departments. 方便申請人與委員會秘書及政府部門之間進行聯絡。
- 2. The personal data provided by the applicant in this application may also be disclosed to other persons for the purposes mentioned in paragraph 1 above. 申請人就這宗申請提供的個人資料,或亦會向其他人士披露,以作上述第 1 段提及的用途。
- 3. An applicant has a right of access and correction with respect to his/her personal data as provided under the Personal Data (Privacy) Ordinance (Cap. 486). Request for personal data access and correction should be addressed to the Secretary of the Board at 15/F, North Point Government Offices, 333 Java Road, North Point, Hong Kong. 根據(個人資料(私隱)條例)(第 486 章)的規定,申請人有權查閱及更正其個人資料。如欲查閱及更正個人資料,應向委員會秘書提出有關要求,其地址為香港北角渣華道 333 號北角政府合署 15 樓。

Gist of Applica	tion 申請摘要
consultees, uploaded available at the Plann (讀 <u>盡</u> 以英文及中	ils in both English and Chinese <u>as far as possible</u> . This part will be circulated to relevant to the Town Planning Board's Website for browsing and free downloading by the public and ing Enquiry Counters of the Planning Department for general information.) 文填寫。此部分將會發送予相關諮詢人士、上載至城市規劃委員會網頁供公眾免費瀏覽及則資料查詢處供一般參閱。)  (For Official Use Only) (請勿填寫此欄)
申請編號	
Location/address 位置/地址	Lots 276 S.B RP, 277 S.B RP, 279 S.B RP (Part), 282 S.B RP, 283 S.B RP, 284, 285, 289, 321 RP (Part), 322, 323 and 324 in D.D. 99, Chau Tau, New Territories
Site area 地盤面積	4,242 sq. m 平方米 Ø About 約
ZEMLEN'S	(includes Government land of包括政府土地 sq. m 平方米 □ About 約)
Plan 圖則	Approved San Tin Outline Zoning Plan No.: S/YL-ST/8
Zoning 地帶	"Green Belt" Zone
Type of Application 申請類別	☑ Temporary Use/Development in Rural Areas for a Period of 位於鄉郊地區的臨時用途/發展為期
	☑ Year(s) 年3 □ Month(s) 月
	□ Renewal of Planning Approval for Temporary Use/Development in Rural Areas for a Period of 位於鄉郊地區臨時用途/發展的規劃許可續期為期
	□ Year(s) 年 □ Month(s) 月
Applied use/ development 申請用途/發展	Proposed Temporary Warehouse (excluding Dangerous Goods Godown) with Ancillary Office and Canteen for a Period of 3 Years and Associated Filling of Land

(i)	Gross floor area and/or plot ratio		sq.r	n 平方米	Plot R	atio 地積比率
	總樓面面積及/或 地積比率	Domestic 住用	/	□ About 約 □ Not more than 不多於	1	□About 約 □Not more than 不多於
		Non-domestic 非住用	3,562	☑ About 約 □ Not more than 不多於	0.84	☑About 約 □Not more than 不多於
(ii)	No. of block 幢數	Domestic 住用		1		
		Non-domestic 非住用		2		
(iii)	Building height/No. of storeys 建築物高度/層數	Domestic 住用		1	☐ (Not	m 米 more than 不多於)
				<i>1</i>	☐ (Not :	Storeys(s) 層 more than 不多於)
		Non-domestic 非住用		8 - 11 (about)	□ (Not :	m 米 nore than 不多於)
				2	Ø (Not :	Storeys(s) 層 more than 不多於)
(iv)	Site coverage 上蓋面積		42		%	☑ About 約
(v)	No. of parking spaces and loading / unloading spaces 停車位及上落客貨車位数目	Medium Goods Veh Heavy Goods Veh Others (Please Spe	ng Spaces 私家ng Spaces 電單 cle Parking Specificle Parking Spicle Parking Specify) 其他 (言	E車車位 E車車位 aces 輕型貨車泊車 Spaces 中型貨車泊 paces 重型貨車泊車 青列明)	車位	7 4 (PC) 3 (LGV)
	:	上落客貨車位/化 Taxi Spaces 的士 Coach Spaces 旅	車位		9.	3
		Light Goods Vehicle Spaces 輕型貨車車位 Medium Goods Vehicle Spaces 中型貨車位 Heavy Goods Vehicle Spaces 重型貨車車位				
		Others (Please Spe Container Vehicle	ecify) 其他 (記	背列明) ————————————————————————————————————		1 (CV)

Plans and Drawings   Image	Submitted Plans, Drawings and Documents 提交的圖則、繪圖及文件	<u>Chinese</u> 中文	<u>English</u> 英文
Block plan(s) 樓字位置圖 Floor plan(s) 樓字位面圖 Sectional plan(s) 鐵視圖 Elevation(s) 立視圖 Photomontage(s) showing the proposed development 顯示擬議發展的合成照片 Master landscape plan(s)/Landscape plan(s) 園境設計圖 Others (please specify) 其他(請註明) Others (please specify) 其他(請註明) Floor plan showing the zoning of the Site/Original Premises, Plan showing the land status of the Site/Original Premises, Cocation Plan of the Site/Original Premises, Plan showing the land status of the Site/Original Premises, Cocation Plan of the Site/Original Premises, Plan showing the NDA Phasing of the Original Premises Reports 報告書 Planning Statement/Justifications 規劃網領/理據 Environmental assessment (noise, air and/or water pollutions) 環境評估(噪音、空氣及/或水的污染) Traffic impact assessment (on vehicles) 就車輛的交通影響評估 Visual impact assessment 很優影響評估 Unadscape impact assessment 景觀影響評估 Candscape impact assessment 景觀影響評估 Candscape impact assessment 排水影響評估 Candscape impact assessment 排水影響評述 Candscape impact assessment 排水影響評述 Candscape impact assessment impact assessment impact assess	Plans and Drawings 圖則及繪圖		. ,
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Note: The information in the Gist of Application above is provided by the applicant for easy reference of the general public. Under no circumstances will the Town Planning Board accept any liabilities for the use of the information nor any inaccuracies or discrepancies of the information provided. In case of doubt, reference should always be made to the submission of the applicant. 註: 上述申請摘要的資料是由申請人提供以方便市民大眾参考。對於所能資料在使用上的問題及文義上的歧異,城市規劃委員

會概不負責。若有任何疑問,應查閱申請人提交的文件。

#### **SECTION 16 PLANNING APPLICATION**

# PROPOSED TEMPORARY WAREHOUSE (EXCLUDING DANGEROUS GOODS GODOWN) WITH ANCILLARY OFFICE AND CANTEEN FOR A PERIOD OF 3 YEARS AND ASSOCIATED FILLING OF LAND IN "GREEN BELT" ZONE

VARIOUS LOTS IN D.D. 99, CHAU TAU, NEW TERRITORIES

**PLANNNIG STATEMENT** 

<u>Applicant</u>

**Chuen Kee Transportation Company** 

Consultancy Team

Planning Consultant:

**R-riches Property Consultants Limited** 



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#### **APPENDICES**

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#### **EXECUTIVE SUMMARY**

- The applicant seeks to apply for planning permission under Section 16 of the Town Planning Ordinance (Cap. 131) to use various lots in D.D. 99, San Tin, New Territories (the Site) for Proposed Temporary Warehouse (Excluding Dangerous Goods Godown) with Ancillary Office and Canteen for a Period of 3 Years and Associated Filling of Land
- The Site falls within an area zoned as "Green Belt" on the Approved San Tin Outline Zoning Plan No. S/YL-ST/8. The Site consists of an area of 4,242m² (about). 2 structures are proposed at the Site for warehouse, site office and canteen with total GFA of 3,562m² (about), the remaining area is reserved for parking, loading/unloading spaces and circulation area.
- The Site is accessible from Lok Ma Chau Road via a local access. The proposed development will operate on Monday to Saturday from 09:00 to 19:00. No operation on Sunday and public holiday.
- Justifications for the proposed development are as follows:
  - The applicant's original premises are affected by the development of Kwu Tung North New Development Area
  - The applied use is the same as the applicant's original premises in Kwu Tung
  - The proposed development is not incompatible with surrounding land use
  - No adverse impact is anticipated to the surrounding area
  - The proposed development is only on a temporary basis, it will not frustrate the long-term planning intention of the "GB" zone
- Details of development parameters are as follows:

No. of Storey	2 ·
Building Height	8 m – 11m (about)
Non-Domestic GFA	3,562 m² (about) ·
Domestic GFA	Not applicable
Total GFA:	3,562 m² (about)
Number of Structure	2
Site Coverage	42% (about)
Plot Ratio	0.84 (about)
Uncovered Area	2,461 m² (about)
Covered Area	1,781 m² (about)
Application Site Area	4,242 m² (about)





# 行政摘要 (內文如與英文版本有任何差異,應以英文版本為準)

- 申請人現根據(城市規劃條例)(第131章)第16條,提交有關新界洲頭史量約份第99約多個地段的規劃申請,於上述地段作擬議臨時貨倉(危險品倉庫除外)速附屬辦公室及食堂(為期3年)及相關填土工程。
- 申請地點所在的地區在《新田分區計劃大綱核准圖編號 S/YL-ST/8》上劃為「綠化地帶」用途地帶。申請地盤面積為4,242平方米(約)。申請地點將設有2座構築物作貨倉及場地辦公室,構築物的總樓面面積合共為3,562平方米(約),其餘地方將預留作停車位、上/落貨位及流轉空間。
- 申請地點可從落馬洲路經一條地區道路前往。擬議發展的作業時間為星期一至六上午9時至下午7時。星期日及公眾假期休息。
- 擬議發展的申請理據如下:
  - 申請人原來的經營處所受到政府古洞北新發展區發展影響
  - 申請的用途與申請人先前於古洞北的發展用途一致
  - 擬議發展與周邊的用途並非不協調
  - 擬議發展不會對周邊地區帶來負面影響
  - · 擬議發展只屬臨時性質,則不會影響「綠化地帶」用途地帶的長途規劃意向
- 擬議發展的詳情發展参數如下:

申請地盤面積:	4,242 平方米(約)
上蓋媳面積:	1,781 平方米(約)
<b>露天地方面積</b> :	2,461 平方米(約)
地積比率:	0.84(約)
上蓋覆蓋率:	42% (約)
<b>楼宇数目</b> :	2 座
<b>總接面面積</b>	3,562 平方米(約)
住用總裝面面積:	不適用
非住用總接面面新:	3,562 平方米 (約)
構築物高度:	8 米 - 11 米 (約)
棋築物層數:	2 烃

#### 1. INTRODUCTION

#### Background

- 1.1 R-riches Property Consultants Limited has been commissioned by *Chuen Kee Transportation Company* (the applicant) to submit this planning application under the Section (S.) 16 of the *Town Planning Ordinance (Cap. 131)* (the Ordinance) to the Town Planning Board (the Board) on its behalf in respect to Lots 276 S.B RP, 277 S.B RP, 279 S.B RP (Part), 282 S.B RP, 283 S.B RP, 284, 285, 289, 321 RP (Part), 322, 323 and 324 in D.D. 99, Chau Tau, New Territories (the Site)(Plan 3).
- 1.2 The applicant seeks to use the Site for Proposed Temporary Warehouse (Excluding Dangerous Goods Godown) with Ancillary Office and Canteen for a Period of 3 Years and Associated Filling of Land (proposed development). The Site falls within an area zoned as "Green Belt" ("GB") on the Approved San Tin Outline Zoning Plan (OZP) No. S/YL-ST/8 (Plan 2). According to the Notes of the OZP, 'warehouse (excluding dangerous goods godown)' is not a column 1 nor 2 use within the "GB" zone, which requires planning permission from the Board (Plan 2). In order to use the Site for the proposed development, submission of planning application under S.16 of the Ordinance is required.
- 1.3 In support of the proposal, a set of indicative development plans and drawings are provided with the planning statement. Set of assessments to mitigate potential adverse impacts will be submitted, if required, at a later stage for the consideration of Government departments and members of the Board.



#### 2. JUSTIFICATIONS

Affected by the Implementation of Kwu Tung North New Development Area

- 2.1 The applicant has been operating their warehouse (for storage of household goods) business in Kwu Tung (i.e. various lots in D.D. 95) since the 2000s (Plans 4 to 6). The premises currently falls within an area zoned as "Residential (Group B)", "Open Space" and "Open Space (1)" on the Approved Kwu Tung North (KTN) OZP No. S/KTN/2 (Plan 5).
- 2.2 According to the implementation program of the development of KTN NDA, the premises falls within sites under the Remaining Phase Works¹ (Plan 7). As land where the premises will be developed for 'residential' and 'open space' uses upon completion of the KTN NDA, the concerned parcel of land will be resumed and reverted to the Government in the future. Therefore, the applicant desperately needs to identify suitable site for relocation to continue its business operation.

Applicant's Effort in Identifying Suitable Site for Relocation

2.3 Whilst the applicant had spent effort to relocate its premises to a number of alternative sites in the New Territories., those sites were considered not suitable or impracticable due to various issues such as land use incompatibility, environmental concerns, land ownership, accessibility or site area being too small/big (Appendix I and Plan 8). At last, the Site was identified as it is the nearest to the applicant's original premises in Kwu Tung and easily accessible from Lok Ma Chau Road via a local access.

Applied Use Is the Same as the Affected Business in Kwu Tung

- 2.4 The proposed development involves of warehouse (excluding dangerous goods godown) with ancillary office and canteen to support the daily operation of the Site. The applied use is the same as the affected business in Kwu Tung.
- 2.5 Despite the fact that the Site area (i.e. 4,242 m²) and GFA (i.e. 3,562 m²) are larger than the original premises in Kwu Tung, the growth in online shopping has stimulated demand for local indoor storage space in Hong Kong since the early 2010s. In light of this, the applicant had previously proposed expanding the operation scale in order to alleviate the pressing demand at the original premises; however, the Government's land resumption plan to facilitate the implementation of the KTN NDA caused the business expansion plan to be put on hold temporarily.
- 2.6 The proposed scheme (with a higher plot ratio and building height than the original

<sup>&</sup>lt;sup>1</sup> Remaining Phase Works – PWP Item No. 828CL – Remaining Phase of Site Formation and Engineering Infrastructure Works at KTN NDA and FLN NDA



premises) provides an excellent opportunity to support the applicant's original business expansion plan in Kwu Tung. The expanded warehouse could result in increased efficiency by providing more space for storage, bulk breaking, and packaging of household goods.

2.7 It could also result in cost savings by reducing transportation costs for frequent deliveries and improving the overall supply chain. The proposed site office will also allow the applicant to attract more business clients, which will subsequently generate employment opportunities and economic benefits for the New Territories while also better utilizing precious land resources. The applicant will strictly follow the proposed scheme, and no further expansion is anticipated during the planning approval period.

The Proposed Development is Not Incompatible with Surrounding Land Use

- 2.8 Although the Site falls within area zoned as "GB" zone of the Approved San Tin OZP No. S/YL-ST/8, the Site is currently vacant and occupied by some vacant temporary structures. The building height of proposed structures (i.e. 11m) are not significantly higher than nearby New Territories Exempted Houses (i.e. 8.23m). The applied use is also considered not incompatible with surrounding land use which is dominated by vehicle park, storage and workshops uses across Lok Ma Chau Road. The proposed development will not create adverse impact to the surrounding area.
- 2.9 Although the proposed development is not in line with planning intention of the "GB", the special background of the application should be considered on individual merit, which approval of the current application would therefore not set an undesirable precedent for the "GB" zone. Upon approval of the planning application, the applicant will make effort in complying with approval conditions related to fire service and drainage aspects, to minimize potential adverse impact arisen from the proposed development.



# 3. SITE CONTEXT

#### Site Location

3.1 The Site is located in close vicinity of the Lok Ma Chau Border Control Point. It is approximately 200m west of Lok Ma Chau Border Control Point; 5.8km west of Sheung Shui MTR Station; and 9.5km southwest of Man Kam To Boundary Control Point (Plan 1).

#### Accessibility

3.2 The Site is accessible from Lok Ma Chau Road via a local access (Plan 1).

#### Existing Site Condition

3.3 The Site is generally flat, partially fenced off and covered by vegetation. It is currently occupied by several vacant temporary structures. The site level of the Site varies from +3.4 mPD to +4.5 mPD (about)(Plans 3 and 9).

#### Surrounding Area

- 3.4 The Site is mainly surrounded by vehicle park, temporary structures for storage, workshop and agricultural uses; and vacant land covered by vegetation and hard-paving.
- 3.5 To its immediate north are areas occupied by temporary structures for storage and agricultural uses. To its further north are land covered by vegetation and woodland.
- 3.6 To its immediate east are vacant land covered by vegetation. To its further east and northeast are indigenous villages Pun Uk Tsuen and Chau Tau Tsuen.
- 3.7 To its immediate south are vacant land covered by vegetation and Chau Tau West Road.
  To its further south are vacant land covered by vegetation and vehicle parks across Lok
  Ma Chau Road.
- 3.8 To its immediate west is the local access connecting the Site to Lok Ma Chau Road. To its further west are vehicle park, occupied by temporary structures for warehouse, logistics centres and workshop uses.



#### 4. PLANNING CONTEXT

#### Zoning of the Application Site

- 4.1 The Site falls within an area zoned as "GB" on the Approved San Tin OZP No. S/YL-ST/8 (Plan 2). According to the Notes of the OZP, 'warehouse' use is not a column 1 nor column 2 use within the "GB" zone, which requires permission from the Board.
- 4.2 The Site falls wholly within "GB" zone (Plan 2). The application is only on a temporary basis, it will not frustrate the long-term planning intention of the "GB" zone.

#### Planning Intention

4.3 The planning intention of this zone is primarily for defining the limits of urban and sub-urban development areas by natural features and to contain urban sprawl as well as to provide passive recreational outlets. There is a general presumption against development within this zone.

#### Land Filling Restrictions

4.4 Any <u>filling of land</u>/pond or excavation of land, including that to effect a change of use to any of those specified in Columns 1 and 2 above or the uses or developments always permitted under the covering Notes (except public works co-ordinated or implemented by Government, and maintenance, repair or rebuilding works), <u>shall not be undertaken or continued on or after the date of the first publication in the Gazette of the notice of the interim development permission area plan without the permission from the Town Planning Board under section 16 of the Town Planning Ordinance.</u>

#### Relevant Guidelines

- 4.5 Town Planning Board Guidelines (TPB PG-No. 10)
  - 4.5.1 The TPB PG-No. 10 for Application for Development Within GB Zone is relevant to the application. As application for new development in a "GB" zone will only be considered in exceptional circumstances and must be justified with very strong planning grounds. The scale and intensity of the proposed development including the plot ratio, site coverage and building height should be compatible with the character of surrounding areas.
  - 4.5.2 The design and layout of any proposed development should be compatible with the surrounding areas. The development should not involve extensive clearance of existing natural vegetation, affect the existing natural landscape, or cause any adverse visual impact on the surrounding environment. Tree



preservation and landscaping proposals should be provided.

- 4.5.3 The proposed development should not overstrain the capacity of existing and planned infrastructure such as sewerage, roads and water supply. It should not adversely affect drainage on the surrounding development.
- 4.6 The proposed development is intended to facilitate relocation of business premises affected by land resumption for development of KTN NDA. As the applied use is the same as the affected business in Kwu Tung and the proposed scheme is considered not incompatible with the surrounding area, sympathetic consideration should be given based on the special background of the application.

#### Previous Application

4.7 There is no previous approved S.16 application in respect of the Site.

#### Similar Application

4.8 There is no similar approved application within the same "GB" zone.

#### Land Status

4.9 The Site consist 12 private lots, i.e. Lots 276 S.B RP, 277 S.B RP, 279 S.B RP (Part), 282 S.B RP, 283 S.B RP, 284, 285, 289, 321 RP (Part), 322, 323 and 324 in D.D. 99 with total land area of 4,242 m² (about) of Old Schedule Lots held under the Block Government Lease (Plan 7). Majority of the land lots are currently owned by Tso Tong, while the remaining area are owned by individuals and companies. The ownership details are provided at Table 1 below:

Table 1: Land Ownership of the Site

Priv	rate-Lot in D.D. 99	Ownership			
1	Lot 276 S.B RP	Billion Win International Holdings Limited			
2	Lot 277 S.B RP	Man Ting Shiu Tong			
3	Lot 279 S.B RP	Man Hok Tin Tso			
4	Lot 282 S.B RP	· Dillian Min Data and I I I I I I I I I I I I I I I I I I I			
5	Lot 283 S.B RP	Billion Win International Holdings Limited			
6	Lot 284	Man On Tsai Tso			
7	Lot 285	Poon For Ling, Poon Ching Wan, Poon Ching Sau			
8	Lot 289	Man Ting Shiu Tong			
9	Lot 321 RP	Man Hok Tin Tso			
10	Lot 322	Different Market and the second secon			
11	Lot 323	Billion Win International Holdings Limited			
12	Lot 324	Richlands Properties Limited .			



4.10 Since there is the restriction that no structure is allowed to be erected without the prior approval of the Government on the private land portion of the Site. The applicant will submit Short Term Waiver (STW) application to LandsD to make way for erection of the proposed structures at the Site. No structure is proposed for domestic use.

#### 5. DEVELOPMENT PROPOSAL

**Development Details** 

5.1 The Site consists of an area of 4,242 m<sup>2</sup> (about). The detailed development parameters are shown at Table 2 below.

Table 2: Development Parameters of the Proposed Development

No. of Storey	2
Building Height	8 m – 11m (about)
Non Boniesat GIA	3,562 m² (about)
- Non-Domestic GFA	• •
- Domestic GFA	Not applicable
Total GFA	3,562 m² (about)
Number of Structure	2
Site Coverage	42% (about)
Plot Ratio	0.84 (about)
	2,401 117 (about)
Uncovered Area	2,461 m² (about)
Covered Area	1,781 m² (about)
Application Site Area	4,242 m² (about)

5.2 2 structures are proposed at the Site for warehouse and ancillary site office/canteen with total GFA of 3,562 m² (about), the remaining area is reserved for parking, loading/unloading (L/UL) spaces and circulation area (Plan 10). Details of structures are shown at Table 3 below:

Table 3: Details of Proposed Structures

Structure	Use	Covered Area	Gross Floor Area	Building Height
B1	Warehouse (Excl. Dangerous Goods Godown)	1,673 m² (about)	3,346 m² (about)	11 m (2-storey)
В2	Ancillary Office and Canteen	108 m² (about)	216 m² (about)	8 m (2-storey)
	Total	1,781 m² (about)	3,562 m² (about)	-

Land Filling of the Site

5.3 The whole Site (i.e. 4,242m²) is proposed to be filled with concrete with no more than 1.6m in depth (new site level varies from +4.5mPD to +5.5mPD) for site formation of



structures, parking and circulation space (Plan 11). As the Site is of soiled ground, concrete site formation is required to provide a relatively flat surface for erection of structure and circulation purpose. Therefore, land filling area is considered necessary and has been kept to minimal for the operation of the proposed development. The Site will be reinstated the Site after the planning approval period.

#### Operation Mode

- 5.4 The Site will be used as warehouse (excluding dangerous goods godown) for storage of household goods, kitchenware, toiletries, household electrical appliance etc.. The proposed development will operate on Monday to Saturday from 09:00 to 19:00. No operation on Sunday and public holiday. No workshop activities and storage of dangerous goods will be carried out at the Site at any time during the planning approval period.
- 5.5 It is estimated that the Site would be able to accommodate not more than <u>15</u> staff. The site office is proposed to provide indoor office space for administrative staff to support the daily operation of the Site. Only staff of the Site will be served at the ancillary canteen. As no shopfront is proposed at the Site, visitor is not anticipated at the Site.

#### Minimal Traffic Impact

- The Site is accessible from Lok Ma Chau Road via a local access (Plan 1). One 7.3m (about) wide ingress/egress is provided at the western part of the Site (Plan 10). A proper run-in/out will be implemented by respective B/Ds under PWP Item No. 7856CL², which connects the local access to Lok Ma Chau Road (Plan 12).
- 5.7 Sufficient space is provided for smooth maneuvering of vehicle entering to and exiting from the Site and within the Site (Plan 13). No vehicle will be allowed to queue back to or reverse onto/from the Site to the public road. Staff is deployed to station at the ingress/egress of the Site to direct incoming/outgoing vehicle to enhance pedestrian safety.
- 5.8 4 private car parking spaces, 3 light goods vehicle parking spaces and 3 L/UL spaces are provided at the Site, details of spaces are provided at **Table 4** below:

<sup>&</sup>lt;sup>2</sup> PWP Item No. 7856 CL – Development of Lok Ma Chau Loop – Main Works Package 1 – Site Formation and Instructure Works



Table 4: Parking and L/UL Provisions

Type of Parking Space:	Number of Space	
Private Car Parking Space for Staff		
- 2.5 m (W) X 5 m (L)	4	
Light Goods Vehicle Parking Space for Staff		
- 3.5 m (W) X 7 m (L)	3	
Type of L/UL Space:	Number of Space	
L/UL Space for Light Goods Vehicle		
- 3.5 m (W) X 7 m (L)	2	
L/UL Space for Container Vehicle		
- 3.5 m (W) X 16 m (L)	1	

5.9 Below is the breakdown of peak hours of estimated vehicular trip attracted by the proposed development:

Table 5: Trip Generation and Attraction of the Proposed Development

					· DCTCIOPI		
		Trip Generation and Attraction					
Time Period		ate Car Light Goods taff) Vehicle		Container Vehicle		2-Way	
	In	Out	In	Out	In	Out	Total -
Trips at AM							·
<u>peak</u> per hour (09:00 – 10:00)	4	0	2	0	1	0	7
Trips at <u>PM</u> <u>peak</u> per hour (17:00 – 18:00)	0	4	0	1	0	1	6
Traffic trip per hour (average)	1	1	1	1	0.5	0.5	· 5

5.10 As the number of vehicular trips generated and attracted by the proposed development is minimal, adverse traffic impact to the surrounding roads should not be anticipated.

#### Minimal Environmental Impact

5.11 The applicant will strictly follow the 'Code of Practice on Handling the Environmental Aspects of Temporary Uses and Open Storage Sites' issued by Environmental Protection Department (EPD) to minimise adverse environmental impacts and nuisance to the surrounding area. The applicant will strictly comply with all environmental protection / pollution control ordinances, i.e. Water Pollution Control Ordinance, Air Pollution Control Ordinance, Noise Control Ordinance etc. at all times during the planning approval period.



- During the construction stage, the applicant will follow the good practices stated in ProPECC PN 1/94 to minimize the impact on the nearby watercourse water quality. Surface run-off from the construction phase will be discharged into storm drains through appropriately designed sand/silt removal facilities such as sand traps, silt traps, and sediment basins. Silt removal facilities, channels, and manholes will be maintained, and the deposited silt and grit will be removed on a regular basis, at the start and end of each rainstorm, to ensure that these facilities are always operational.
- 5.13 During the operation of the proposed development, the major source of wastewater will be sewage from toilets generated by staff. The applicant will implement good practices under ProPECC PN 5/93 when designing on-site drainage system with the Site, i.e. the use of septic tank for sewage treatment. The applicant will submit and implement relevant proposals to the satisfaction of Director of Environmental Protection after planning permission has been obtained from the Board. Licensed collectors will be employed by the applicant to collect and dispose of sewage regularly, and the location of portable toilets are located away from the watercourse in the vicinity.
- 5.14 2.5m high solid metal wall with thickness of 5mm will be erected along the site boundary by the applicant. The boundary wall will be installed properly by licensed contractor to prevent misalignment of walls, to ensure that there is no gap or slit on boundary wall. In addition, maintenance will be conducted by the applicant on a regular basis.

#### Minimal Landscape Impact

- 5.15 No old and valuable tree or protected species has been identified at the Site. Due to proposed land filling works for circulation purpose, majority of the Site area will be disturbed. The remaining area will be affected by the erection of structures for warehouse and site office/canteen uses. Therefore, all existing trees will be affected and none of the existing trees is proposed to be retained at the Site.
- 5.16 The applicant will submit a landscape proposal to alleviate the potential visual impact of the proposed development.

#### Minimal Drainage Impact

5.17 Although there is no existing drainage system within the Site, existing public drainage manhole is available for connection along the western boundary of the Site. The applicant submitted a drainage proposal, with provision of peripheral u-channels and catchpits to mitigate adverse drainage impact generated by the development (Appendix II).



5.18 As illustrated at the drainage proposal, adverse drainage impact to the surrounding areas should not be anticipated. The applicant will implement the proposed drainage facilities at the Site once the drainage proposal is accepted by Drainage Services Department/the Board.

#### Fire Safety Aspect

- 5.19 The applicant submitted a fire service installations (FSIs) proposal in accordance to Building Ordinance, Fire Services Ordinance and Fire Safety (Buildings) Ordinance (Appendix III).
- 5.20 The applicant will implement the proposed FSIs at the Site once the proposal is accepted by Fire Services Department/the Board.



#### 6. CONCLUSION

- The applicant has previously spent effort in identifying suitable site for relocation of their premises in Kwu Tung to pave way for the development of KTN NDA. Whilst the applicant has tried to relocate its premises to a number of alternative sites in New Territories, those sites were considered not suitable or impracticable. The applied use is the same as the affected business in Kwu Tung. The proposed development would be able to facilitate the applicant's business expansion plan, in order to alleviate the pressing demand for indoor storage space.
- Although the proposed development is not a column one nor column two use within the "GB" zone, the application is only on a temporary basis, it would not jeopardize the long-term planning intention of the "GB" zone. Given that the application's special background is to facilitate the development of KTN NDA, approval of the current application would not set an undesirable precedent within the "GB" and should be considered on its own merits.
- As the surrounding area is intermixed with workshops, storage and vacant land and the BH of proposed structures are similar to the nearby NTEHs, the proposed development is considered not incompatible with the surrounding area. The applicant will also strictly follow the 'Code of Practice on Handling the Environmental Aspects of Temporary Uses and Open Storage Sites' by the EPD to minimize all possible environmental impacts on the nearby sensitive receivers.
- The proposed development will not create significant adverse traffic, environmental, landscape and drainage impact to the surrounding areas. Adequate mitigation measures are provided, i.e. submission of landscape, drainage, fire service installations proposals etc. to mitigate any adverse impact arising from the proposed development (Appendices.II to IV).
- 6.5 In view of the above, the Board is hereby respectfully recommended to approve the subject application for 'Proposed Temporary Warehouse (Excluding Dangerous Goods Godown) with Ancillary Office and Canteen for a Period of 3 Years and Associated Filling of Land'.

R-riches Property Consultants Limited April 2023





# LIST OF PLANS


Plan 1	Location Plan
Plan 2	Plan Showing the Zoning of the Application Site
Plan 3	Plan Showing the Land Status of the Application Site
Plan 4	Land Status of the Applicant's Original Premises in Kwu Tung
Plan 5	Land Use Zoning of the Applicant's Original Premises in Kwu Tung
Plan 6	Aerial Photo of the Applicant's Original Premises in Kwu Tung
Plan 7	Applicant's Original Premises in Kwu Tung (NDA Development Phasing)
Plan 8	Plan Showing Alternative Site for Relocation
Plan 9	Aerial Photo of the Application Site
Plan 10	Layout Plan
Plan 11	Land Filling Area of the Application Site
Plan 12	Run-In/Out of the Application Site
Plan 13	Swept Path Analysis







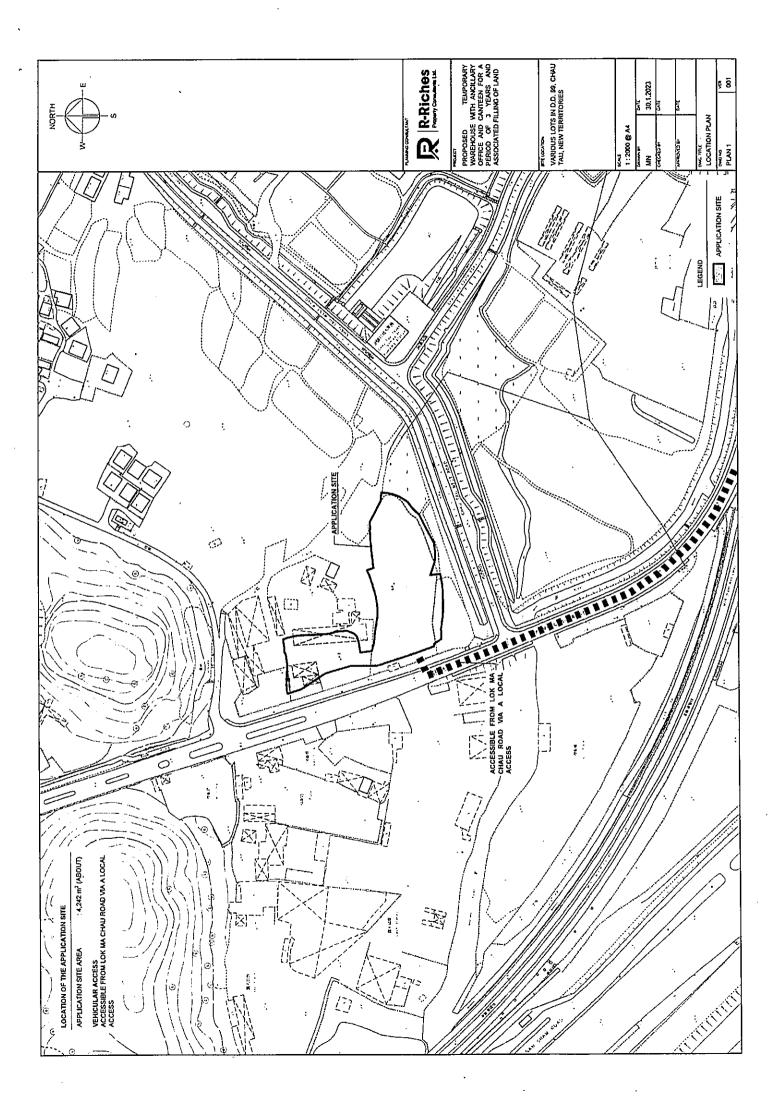

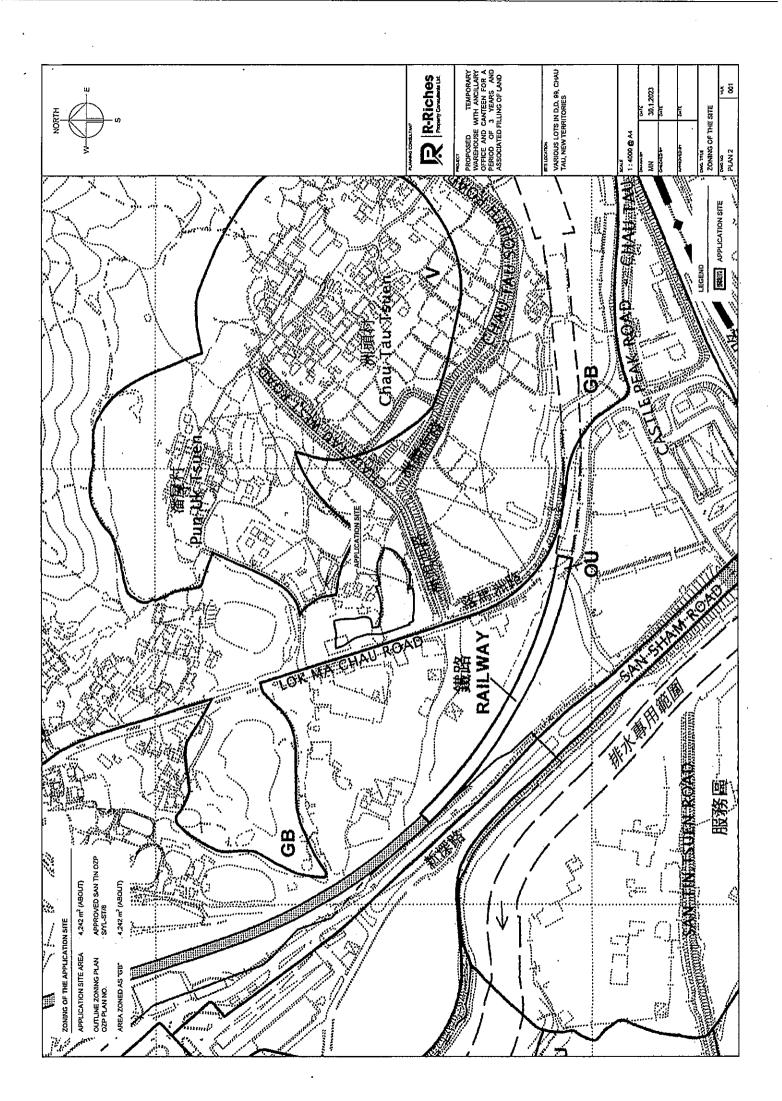


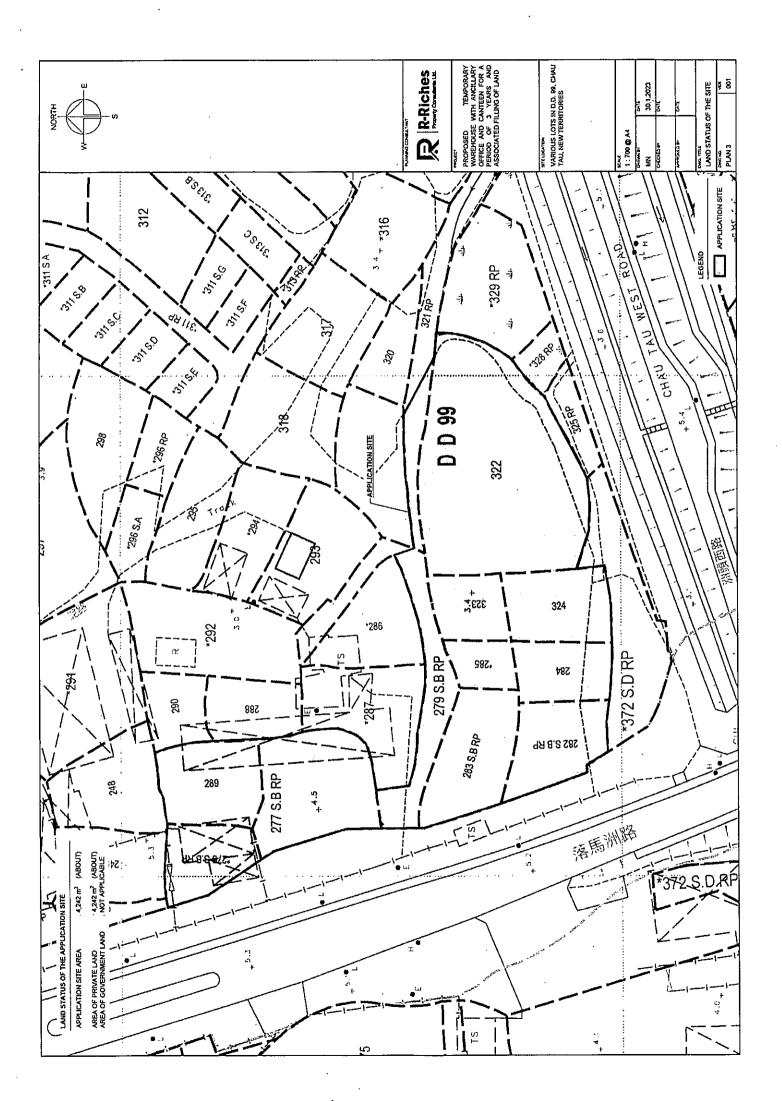


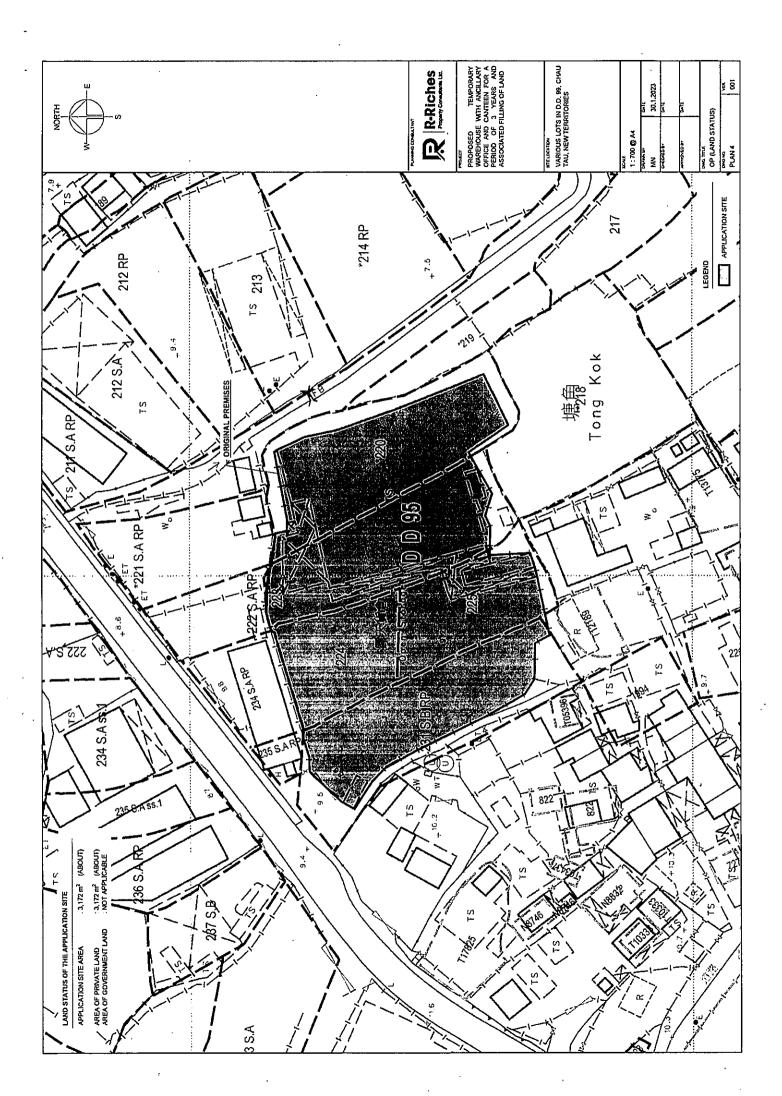

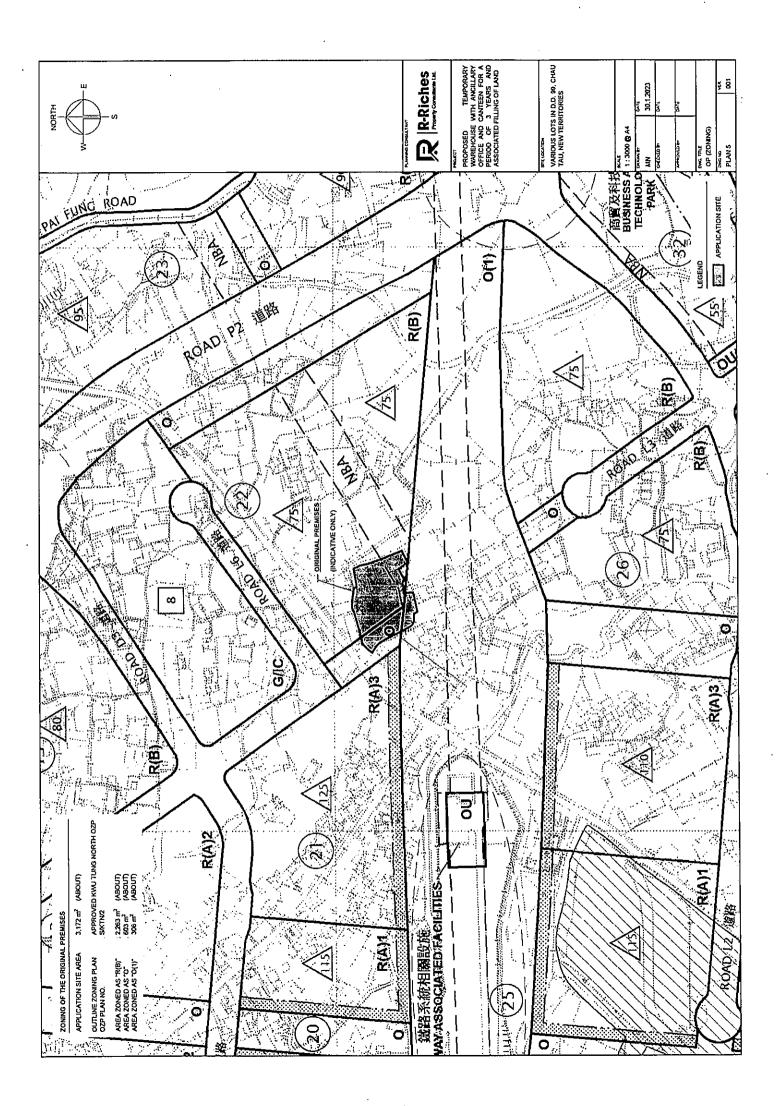





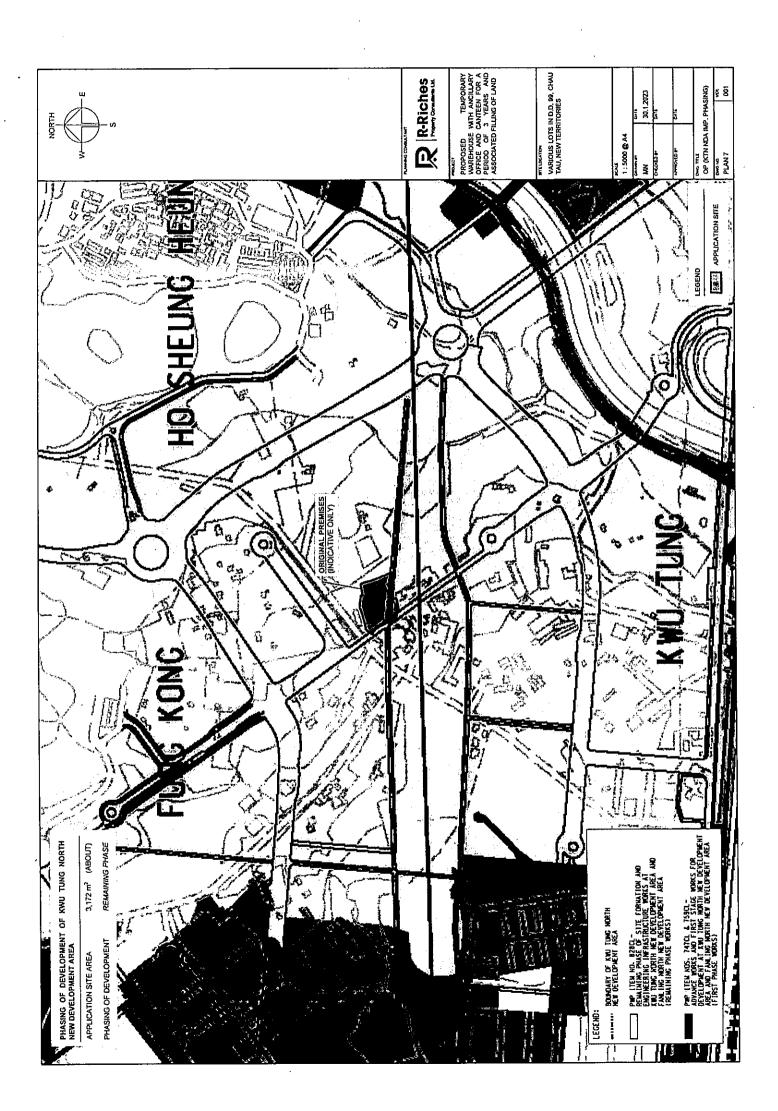


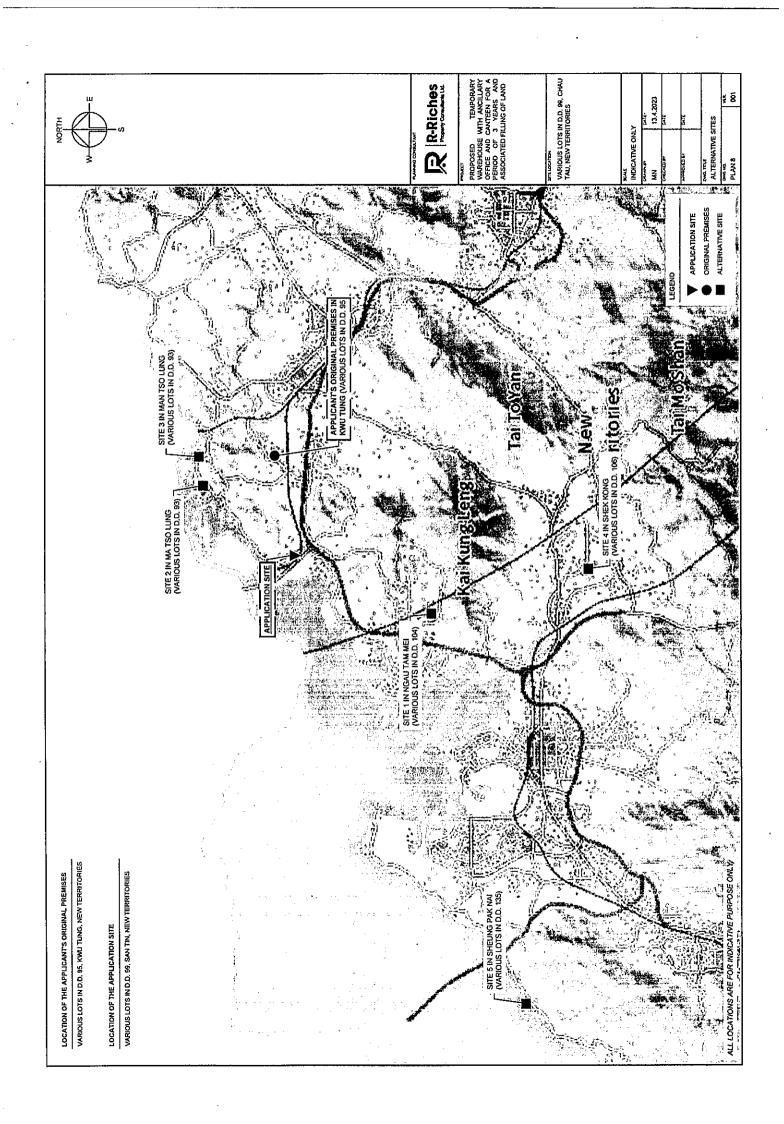




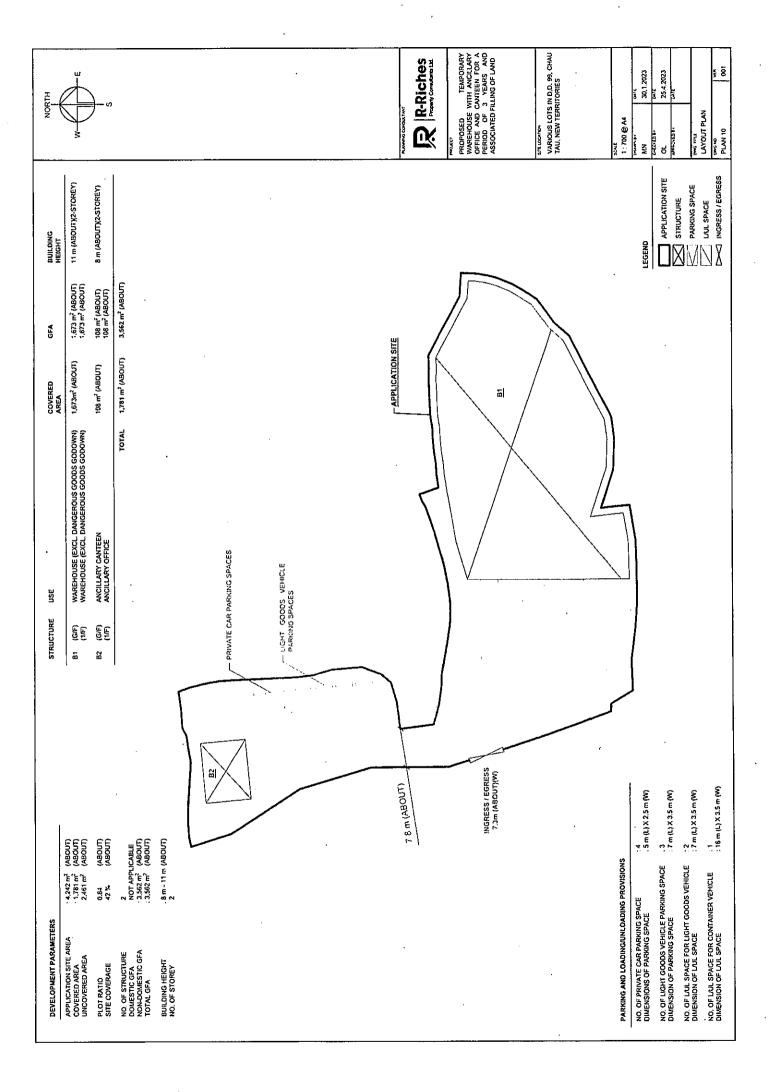

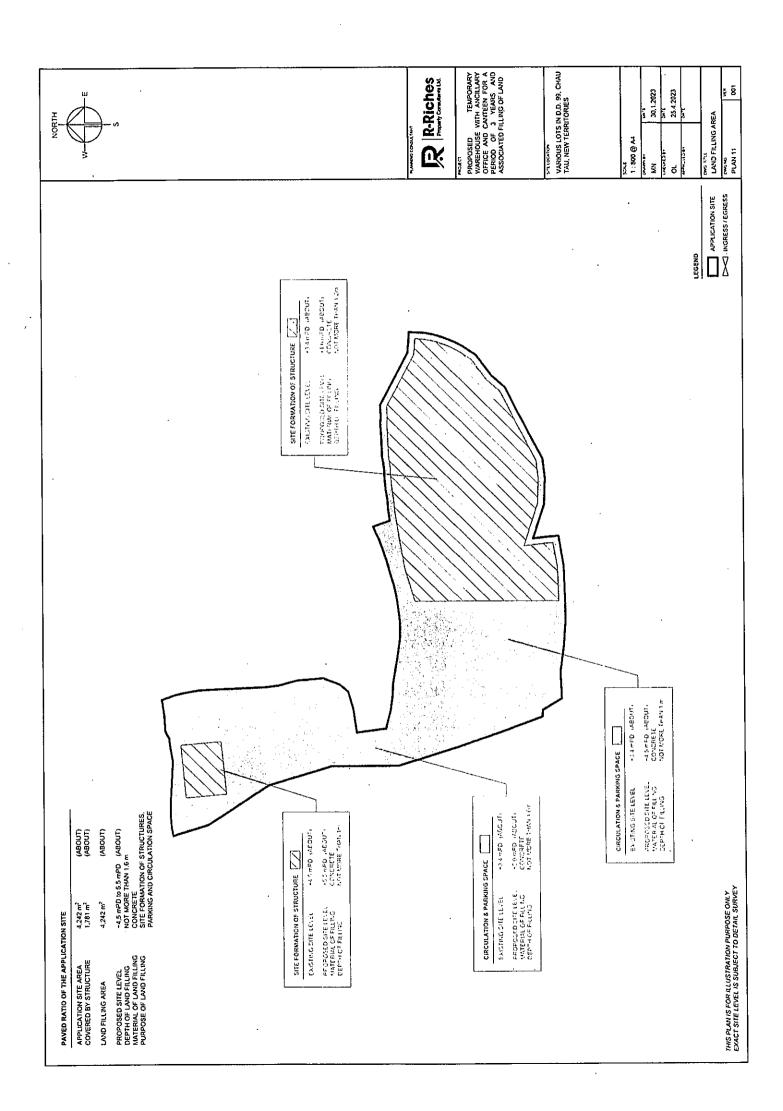

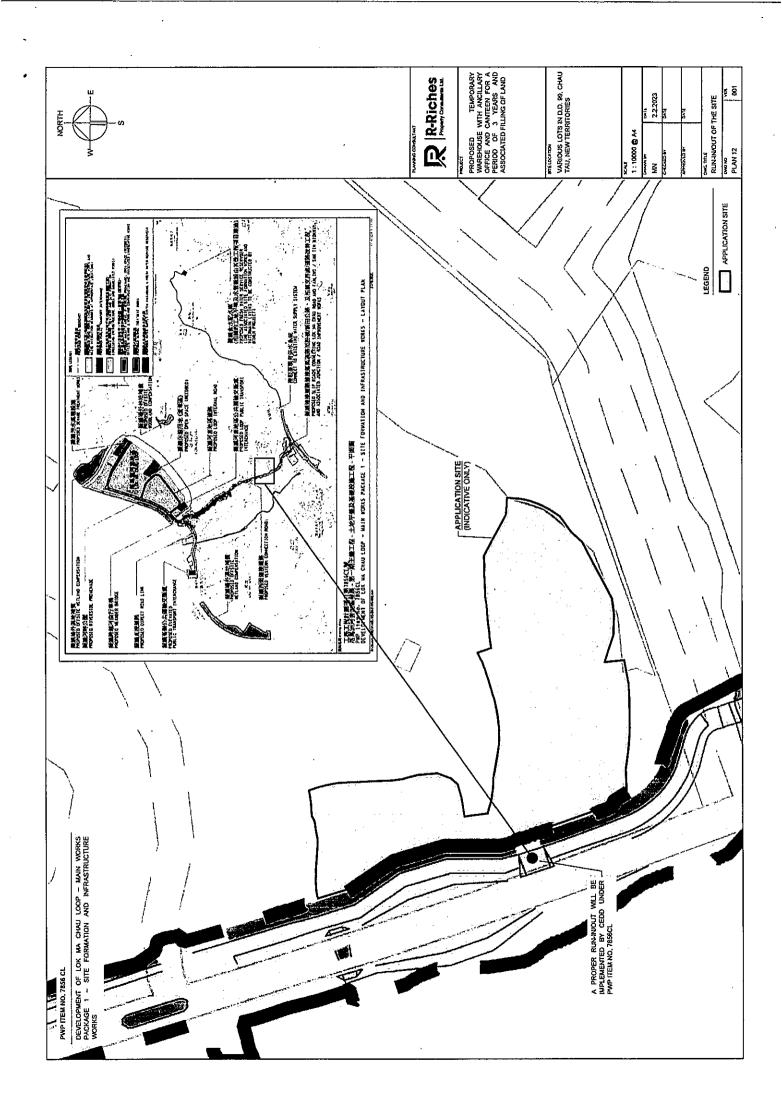

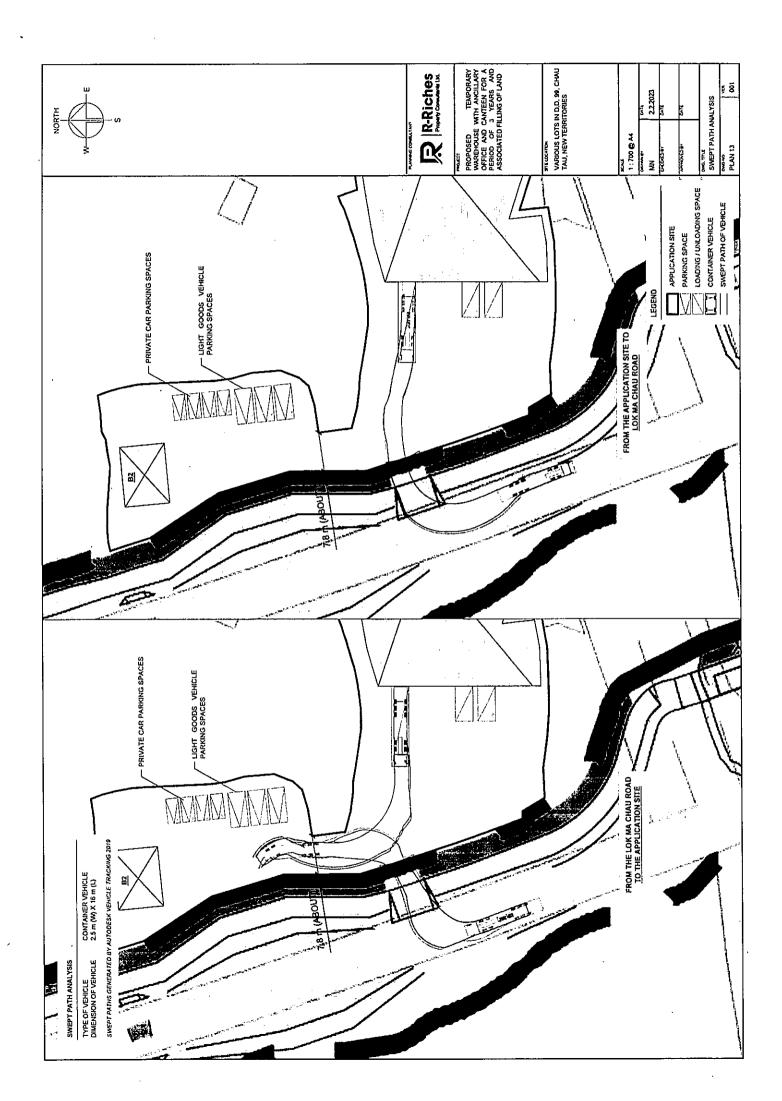

### **APPENDICES**

Appendix I

Alternative Sites for Relocation

Appendix II

**Drainage Proposal** 

Appendix III

Fire Service Installations Proposal

### Appendix I Alternative Sites for Relocation



Proposed Temporary Warehouse (Excluding Dangerous Goods Godown) with Anaillary Office and Canteen for a Period of 3 Years and Associated Filling of Land in "Green Belt" Zone, Various Lots in D.D. 99, Chau Tay, New Territories

# Appendix 1 - Alternative Site Options for Relocation of the Applicant's Original Premises


Alternative Site / Application Site	Site 1	Site 2	Site 3	Site 4	Site 5	Application Site
Location	Various Lots in D.D. 104, Ngau Tam Mei, Yuen Long, New Territories	Various Lots in D.D. 93, Ma Tso Lung, New Territories	Various Lots in D.D. 93, Ma Tso Lung, New Territories	Various Lots in D.D. 106, Shek Kong, Yuen Löng, New Territories	Various Lots in D.D. 135, Sheung Pak Nai, Yuen Long, New Territories	Various Lots in D.D. 99, Chau Tau, New Territories
Site Area	3,930 m² (about)	30,190 m² (about)	5,500 m² (about)	540 m² (about)	13,320 m² (about)	4,242m² (about)
Accessibility	Accessible from Wang Ping Shan South Road via a local access	Accessible from Ma Tso Lung Road via a local access	Accessible from Ma Tso Lung Road via a local access	Accessible from Kam Shui Road via a local access	Accessible from Nim Wan Road via a local access	Accessible from Lok Ma Chau Road via a local access
Distance from Original Premises	7.81km (about) from the original premises	3.07km (about) from the original premises	3.75km (about) from the original premises	13.51km (about) from the original premises	22.2km (about) from the original premises	2.8km (about) from the original premises
Outline Zoning Plan	Draft Kam Tin North OZP No. S/YL-KTN/10	Approved Ma Tso Lung and Hoo Hok Wai OZP No. S/NE-MTL/3	Approved Ma Tso Lung and Hoo Hok Wai OZP No. S/NE-MTL/3	Approved Shek Kong OZP No. S/YL-SK/9	Approved Sheung Pak Nai and Ha Pak Nai OZP No. S/YL-PN/9	Approved San Tin OZP No. S/YL- ST/8
Zoning	"Village Type Development"	"Conservation Area (1)"	"Conservation Area (1)"	"Village Type Development"	"Coastal Protection Area"	"Green Belt"
Existing Condition	Hard paved and occupied by temporary structures	Mostly vacant, covered by vegetation and occupied by fishpond.	Vacant and covered by vegetation	Vacant and covered by temporary structures	Occupied by temporary structures and fishponds	Generally flat, partially covered by vegetation and occupied by vacant temporary structures
Surrounding Area	Surrounded by vehicle repair workshop, holiday camp site, and residential use	Surrounded by vegetation, pond, some GIC uses and residential use	Surrounded by vegetation, pond, some GIC uses and residential use	Surrounded by residential development, some GIC uses and temporary structures for plant nursery	Surrounded by fishpond and some temporary structures	Surrounded by vehicle park, temporary structures for storage, workshop and agricultural uses; and vacant land covered by vegetation and hard-paving
Suitability for Relocation	Not suitable for relocation  10% larger than the original premises  Tree felling is required  Nearby residential development  Not compatible with the surrounding area	Not suitable for relocation  748% larger than the original premises  Within the closed area  Falls within the "Conservation Area" zone  Tenancy for portion of the site is not feasible  Not compatible with the surrounding area	Not suitable for relocation  - \$4%   Jarger than the original premises  - Within the closed area  - Falls within the "Conservation Area" zone  - Tenancy for portion of the site is not feasible  - Not compatible with the surrounding area	Not suitable for relocation  - 85% smaller than the original premises  - Tree felling is required  - Tenancy for portion of the site is not feasible  - Not compatible with the surrounding area	Not suitable for relocation  274% larger than the original premises  Ealls within the "Coastal Protection Area" zone  Active agricultural activities  Not compatible with the surrounding area	Suitable for relocation:  - Similar in site area  - No active agricultural activities  - Not incompatible with the surrounding area




Proposed Temporary Warehouse (Excluding Dangerous Goods Godown) with Ancillary Office and Canteen for a Period of 3 Years and Associated Filling of Land in "Green Belt" Zone, Various Lots in D.D. 99, Chau Tau, N.T.

Appendix II
Drainage Proposal



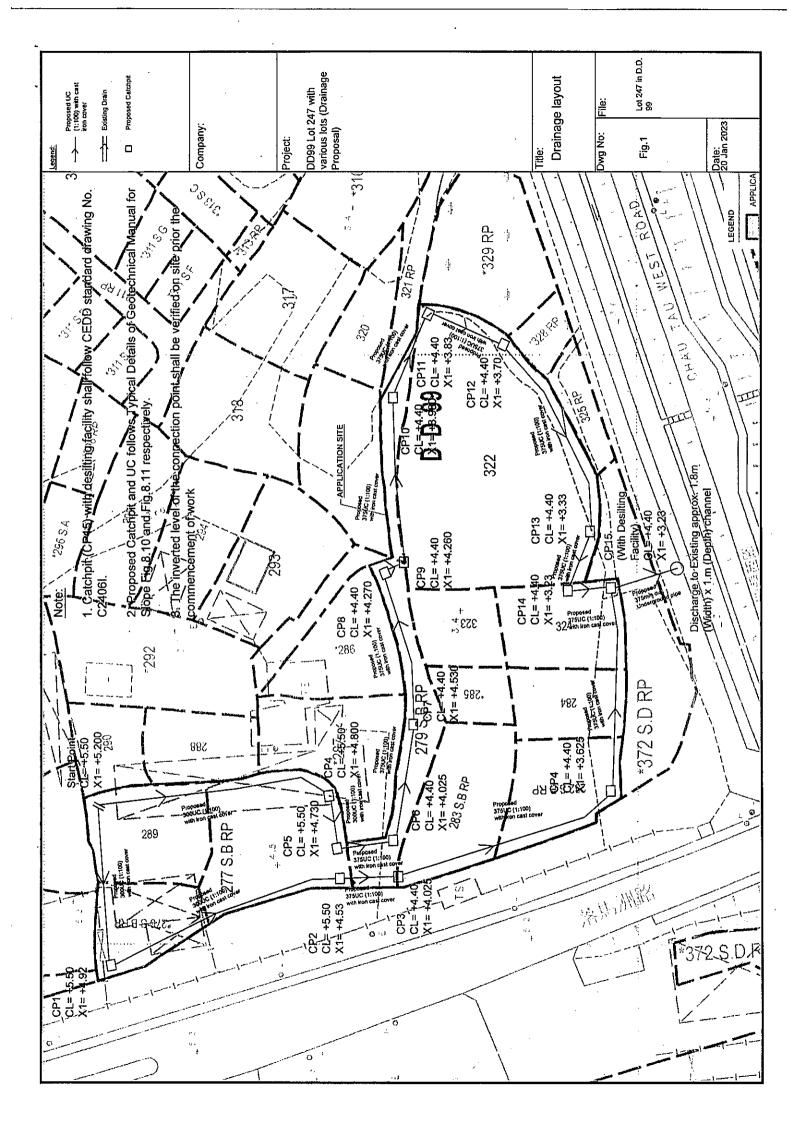

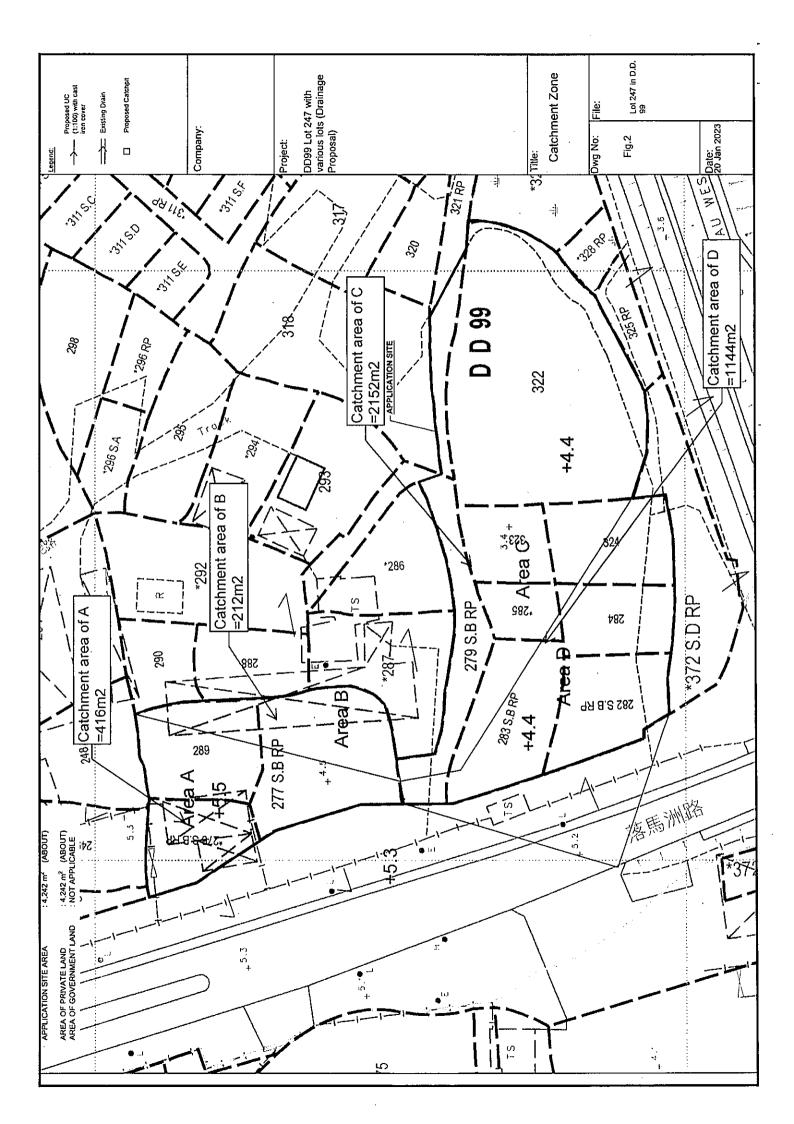

Company: Project :

Date:

23/8/2018

### Calculation for channels:

Catchment	4	at cita
( '3)chment	Anta	of site

Arca A	=	792 0.000792	m^2 km^2							
Peak runoff in m^3/s	= = =	0.278 0.052292 3138	x m^3/s liter/min	0.95	x	250	mm/hr	x	0,000792	km^2
Area B	Ξ Ξ	405 0.000405	m^2 km^2							
Peak runoff in m^3/s	= = =	0.278 0.02674 1604	x m^3/s liter/min	0.95	x	250	រភារសៀរជ	x	0.000405	km^2
Arca C	=	2567 0.002567	m^2 km^2							
Peak runoff in m^3/s	= = =	0.278 0.169486 10169	x m^3/s liter/min	0,95	x	250	пил√нг	x	0.002567	km^2
Area D	==	1645 0.001645	m^2 km^2							
Peak runoff in m^3/s	≖ = =	0.278 0.108611 6517	x m^3/s liter/min	0.95	x	250	mnvlir	x	0.001645	km^2
Total Peak Runoff for A Total Peak Runoff for A and D Total Peak Runoff for B Total Peak Runoff for B and C	= = = =	0.052292 0.160903 0.02674 0.278097	m^3/s m^3/s m^3/s m^3/s	= = = =		3137.5 9654.13 1604.40 16685.3	755 775		liter/min liter/min liter/min liter/min	

According to (Figure 8.7 - Chart for the Rapid Design of Channels), For gradient 1:100, 300UC will be suitable for area A and B For gradient 1:100, 375UC will be suitable for area D For gradient 1:100, 375UC will be suitable for area C


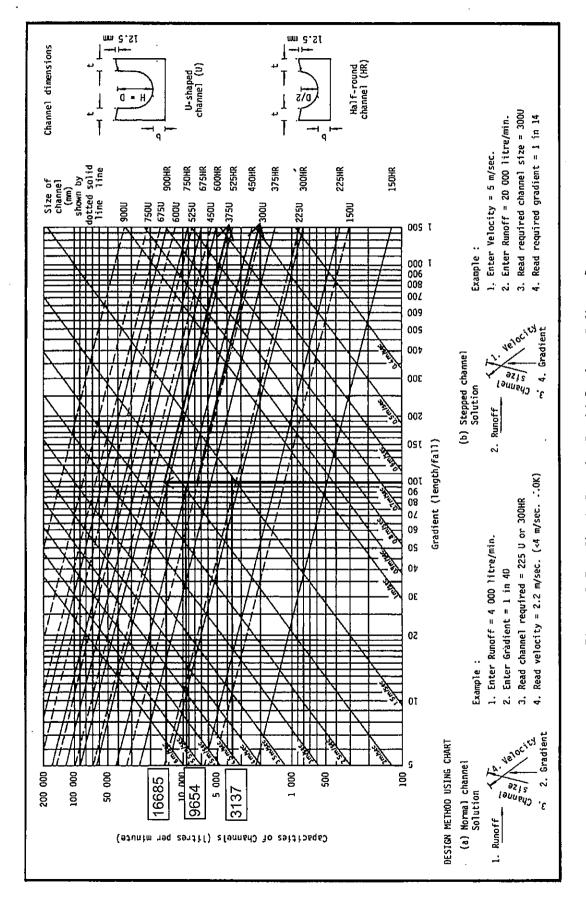


Figure 8.7 - Chart for the Rapid Design of Channels

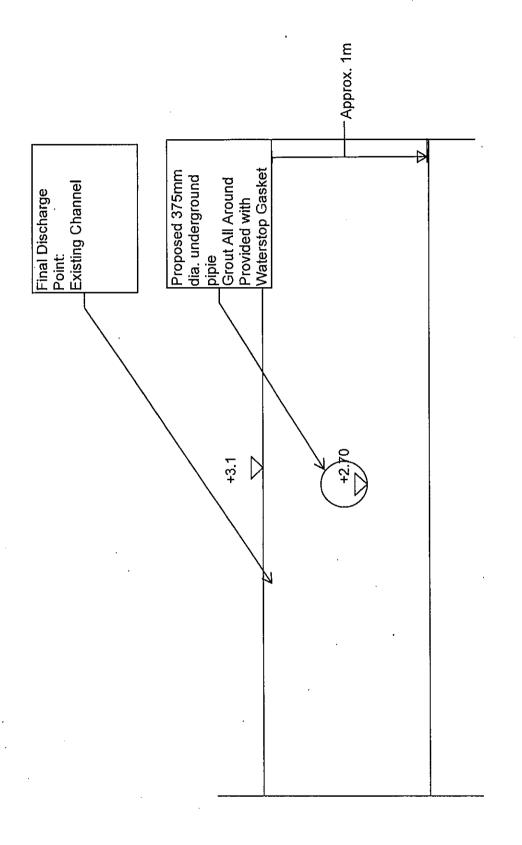

Connection Detail of Existing channel

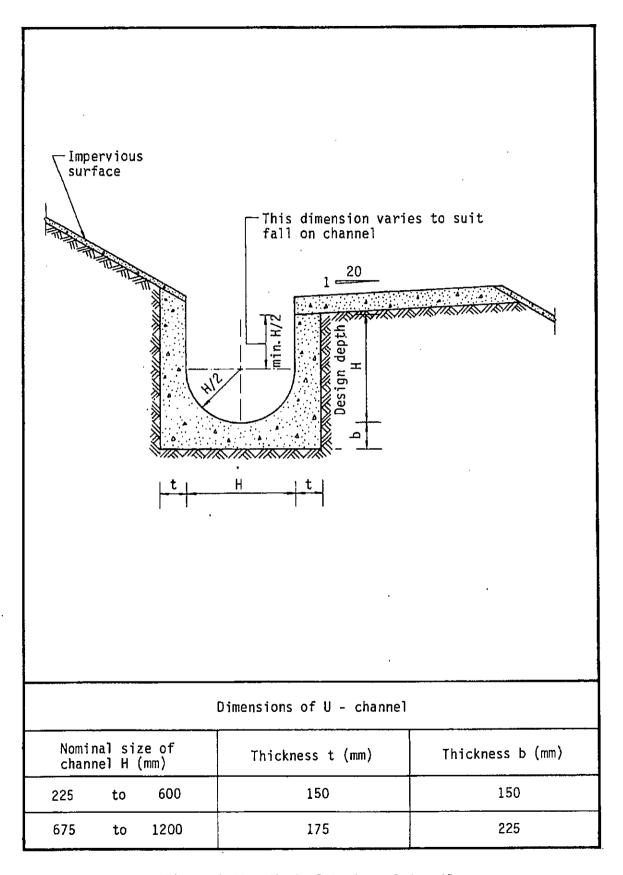


Figure 8.11 - Typical U-channel Details


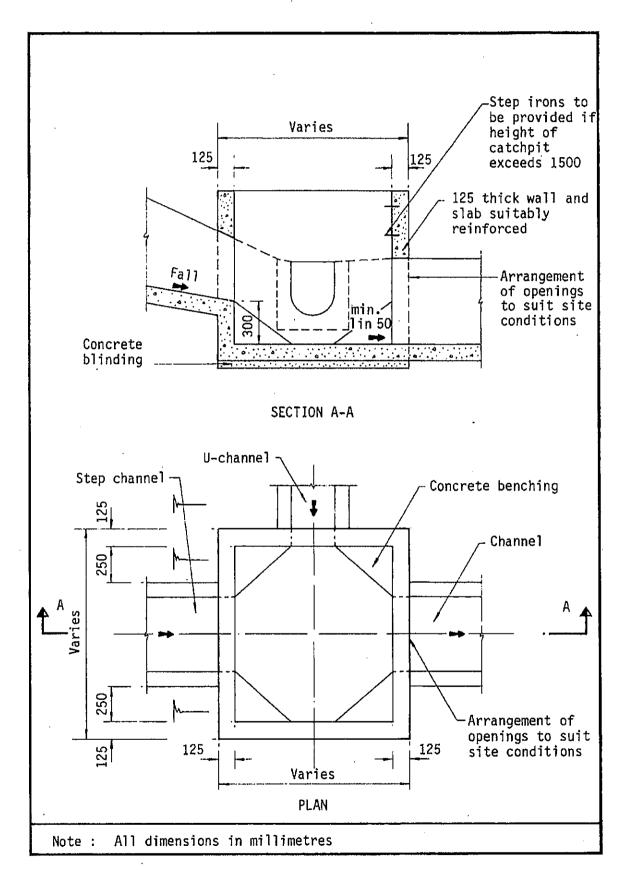


Figure 8.10 - Typical Details of Catchpits

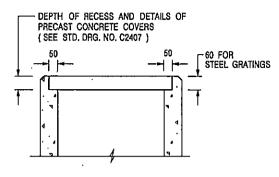

### ALTERNATIVE TOP SECTION FOR PRECAST CONCRETE COVERS / GRATINGS

### NOTES:

- 1. ALL DIMENSIONS ARE IN MILLIMETRES.
- 2. ALL CONCRETE SHALL BE GRADE 20 /20.
- 3. CONCRETE SURFACE FINISH SHALL BE CLASS U2 OR F2 AS APPROPRIATE,
- 4. FOR DETAILS OF JOINT, REFER TO STD. DRG. NO. C2413.
- 5. CONCRETE TO BE COLOURED AS SPECIFIED.
- UNLESS REQUESTED BY THE MAINTENANCE PARTY AND AS DIRECTED BY THE ENGINEER, CATCHPIT WITH TRAP IS NORMALLY NOT PREFERRED DUE TO PONDING PROBLEM.
- UPON THE REQUEST FROM MAINTENANCE PARTY, DRAIN PIPES AT CATCHPIT BASE CAN BE USED BUT THIS IS FOR CATCHPITS LOCATED AT SLOPE TOE ONLY AND AS DIRECTED BY THE ENGINEER,
- FOR CATCHPITS CONSTRUCTED ON OR ADJACENT TO A FOOTPATH, STEEL GRATINGS (SEE DETAIL 'A' ON STD, DRG, NO. C2405 ) OR CONCRETE COVERS (SEE STD. DRG, NO. C2407 ) SHALL BE PROVIDED AS DIRECTED BY THE ENGINEER.
- 9. IF INSTRUCTED BY THE ENGINEER, HANDRAILING (SEE DETAIL 'G'
  ON STD. DRG. NO. C2405; EXCEPT ON THE UPSLOPE SIDE) IN LIEU OF
  STEEL GRATINGS OR CONCRETE COVERS CAN BE ACCEPTED AS AN ALTERNATIVE
  SAFETY MEASURE FOR CATCHPITS NOT ON A FOOTPATH NOR ADJACENT TO IT.
  TOP OF THE HANDRAILING SHALL BE 1 000 mm MIN. MEASURED FROM THE
  ADJACENT GROUND LEVEL.
- 10. MINIMUM INTERNAL CATCHPIT WIDTH SHALL BE 1 000 mm FOR CATCHPITS WITH A HEIGHT EXCEEDING 1 000 mm MEASURED FROM THE INVERT LEVEL TO THE ADJACENT GROUND LEVEL. AND, STEP IRONS (SEE DSD STD. DRG. NO. DS1043) AT 300 c/c STAGGERED SHALL BE PROVIDED. THICKNESS OF CATCHPIT WALL FOR INSTALLATION OF STEP IRONS SHALL BE INCREASED TO 150 mm.
- FOR RETROFITTING AN EXISTING CATCHPIT WITH STEEL GRATING, SEE DETAIL 'F' ON STD. DRG. NO. C2405.
- SUBJECT TO THE APPROVAL OF THE ENGINEER, OTHER MATERIALS CAN ALSO BE USED AS COVERS / GRATINGS.

- FORMER DRG. NO. C2408J. Original Signed 03.2015

REF. REVISION SIGNATURE DATE

CIVIL ENGINEERING AND DEVELOPMENT DEPARTMENT


SCALE 1:20 DRAWING NO.

DATE JAN 1991 C2406 /2

We Engineer Hong Kong's Development

CATCHPIT WITH TRAP (SHEET 2 OF 2)


卓越工程 建設香港

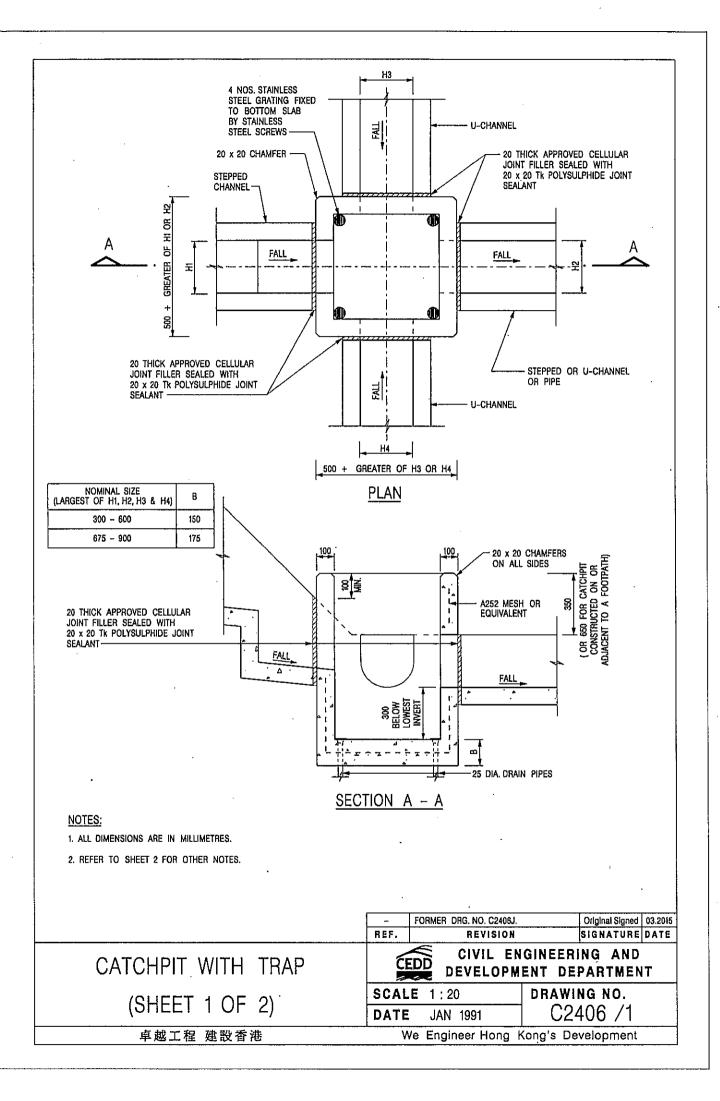

### Appendix III

Fire Service Installations Proposal



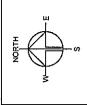

### FIRE SERVICES NOTES:

## HOSE REEL SYSTEM

- HOSE REEL SHALL BE PROVIDED AT POSITIONS AS INDICATED ON PLANS. 7.7
- REEL TUBING, ONE ACTUATING POINT AND ONE AUDIO WARNING DEVICE TO BE LOCATED AT EACH HR POINT. THE ACTUATING POINT SHOULD INCLUDE FACILITIES THERE SHALL BE SUFFICIENT HOSE REELS TO ENSURE THAT EVERY PART OF THE BUILDING CAN BE REACHED BY A LENGTH OF NOT MORE THAN 30M OF HOSE FOR THE FIRE PUMP START DEVICE INITIATION.
  - A MODIFIED HOSE REEL SYSTEM OF 2,000 LITRES WATER TANK TO BE PROVIDED FOR THE ENTIRE BUILDING AS INDICATED ON PLAN. NO FIRE SERVICES INLET TO BE PROVIDED FOR THE MODIFIED HOSE REEL SYSTEM.
- WATER SUPPLY FOR THE MODIFIED HOSE REEL SYSTEM TO BE SINGLE END FEED FROM THE GOVERNMENT TOWN MAIN.
  - THE HR SYSTEM INSTALLED SHOULD BE IN ACCORDANCE WITH PARA. 5.14 OF THE CODE OF PRACTICE FOR MINIMUM FIRE SERVICE INSTALLATION AND EQUIPMENT TWO FIXED FIRE PUMPS (DUTY/STANDBY) TO BE PROVIDED AT F.S. & SPR. PUMP ROOM. £ 4 € € €
- AN INSTRUCTION PLATE SHALL BE PROVIDED NEXT TO THE BREAK GLASS UNIT FOR OPERATION OF HOSE REEL. <u>φ</u>
- AUTOMATIC SPRINKLER SYSTEM તં
- STRUCTURE IN ACCORDANCE WITH LPC RULES INCORPORATING BS EN12845: 2015 AND FSD CIRCULAR LETTER 5/2020. THE SPRINKLER TANK, SPRINKLER PUMP ROOM, SPRINKLER INLET AND SPRINKLER CONTROL VALUE GROUP SHALL BE CLEARLY MARKED ON PLANS. AUTOMATIC SPRINKLER SYSTEM SUPPLIED BY A 135,000L SPRINKLER WATER TANK AND HAZARD CLASS OH3 SHALL BE PROVIDED TO THE ENTIRE BUILDING! 2.1
  - THE CLASSIFICATION OF THE AUTOMATIC SPRINKLER INSTALLATION TO BE ORDINARY HAZARD GROUP 3. ONE NUMBER 135,000 LITRES SPRINKLER WATER TANK TO BE PROVIDED AS INDICATED ON PLANS. 223 234 254 25
    - - SPRINKLER CONTROL VALVE SET AND SPRINKLER INLET TO BE PROVIDED AS INDICATED ON PLANS.
        - TYPE OF STORAGE METHOD FOR THE BUILDING IS AS FOLLOWS:
          - STORAGE CATEGORY: CATEGORY (I)
            - STORAGE HEIGHT: NOT EXCEEDING 4M
          - STORAGE: ST1 **€**@0

### FIRE ALARM SYSTEM က


- FIRE ALARM SYSTEM SHALL BE PROVIDED THROUGHOUT THE ENTIRE BUILDING IN ACCORDANCE WITH BS 5839-1: 2017 AND FSD CIRCULAR LETTER N0.6/2021. ONE ACTUATING POINT AND ONE AUDIO WARNING DEVICE SHOULD BE LOCATED AT EACH HOSE REEL POINT. THE ACTUATION POINT SHOULD INCLUDE FACILITIES FOR 3.1
  - FIRE PUMP START AND AUDIO / VISUAL WARNING DEVICE INITIATION. AN ADDRESSABLE TYPE FIRE ALARM PANEL TO BE PROVIDED AND LOCATED INSIDE G/F F.S. & SPR. PUMP ROOM. 3.2

# MISCELLANEOUS F.S. INSTALLATION

- PORTABLE FIRE EXTINGUISHER WITH SPECIFIED TYPE AND CAPACITY TO BE PROVIDED AT LOCATIONS AS INDICATED ON PLANS. SUFFICIENT EMERGENCY LIGHTING SHALL BE PROVIDED THROUGHOUT THE ENTIRE BUILDINGS/STRUCTURES IN ACCORDANCE WITH BS 5266-1:20216, BS EN 4.1 4.2
- 1838:2013 AND FSD CL 4/202/
- SUFFICIENT DIRECTIONAL AND EXIT SIGN SHALL BE PROVIDED IN ACCORDANCE WITH BS 5266: PART 1 AND FSD CIRCULAR LETTER 5/2008.
  NO EMERGENCY GENERATOR TO BE PROVIDED FOR SERVING THE EMERGENCY POWER. DUPLICATED POWER SUPPLIES FOR ALL FIRE SERVICES INSTALLATIONS COMPRISING A CABLE CONNECTED FROM ELECTRICITY MAINS DIRECTLY BEFORE THE MAIN SWITCH. 6. 4 4. 4
  - WHEN A VENTILATION/ AIR CONDITIONING CONTROL SYSTEM TO A BUILDING IS PROVIDED, IT SHALL STOP MECHANICALLY INDUCED AIR MOVEMENT WITHIN A DESIGNATED FIRE COMPARTMENT 4.5
    - NO DYNAMIC SMOKE EXTRACTION SYSTEM SHALL BE PROVIDED SINCE FIRE COMPARTMENT EXCEEDING 7000 CUBIC METRES AND THE AGGREGATE AREA OF OPENABLE WINDOWS OF THE RESPECTIVE COMPARTMENT EXCEEDS 6.25% OF THE FLOOR AREA OF THAT COMPARTMENT 4.6

R-Riches	PROFECT PROPOSED TEMPORARY WAREHOUSE WITH ANGILLARY OFFICE AND CANTEEN FOR A PERIOD OF 3 YEARS AND ASSOCIATED FILLING OF LAND	WARIOUS LOTS IN D.D. 99, CHAUJ TAU, NEW TERRITORIES	) nos	DL 14.2.2023	OL 11,4,2023	Anny 3-1D gr	PSIS PROPOSAL (1/4)	Cond inc.

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	STRUCTU	STRUCTURE USE	COVERED	BUILDING HEIGHT	FIRE COMPARTMENT
: 4228 r/ 480UT) : 4181 r/ 480UT) : 2.461 rr/ (480UT)	81 (G/F) (1/F)	WAREHOUSE (EXCL. DANGEROUS GOODS GODOWN) WAREHOUSE (EXCL. DANGEROUS GOODS GODOWN)	1,673 m² (ABOUT) 1,673 m² (ABOUT)	5.5 m (ABOUT) 5.5 m (ABOUT)	9201.5 m² (ABOUT) 9201.5 m² (ABOUT)
: 0.84 (ABOUT) : 42 % (ABOUT)	В2 (СУР)	ANCILLARY CANTEEN ANCILLARY OFFICE	188 ㎡ (ABOUT) 188 ㎡ (ABOUT)	4 m (ABOUT) 4 m (ABOUT)	432 m² (ABOUT) 432 m² (ABOUT)
: 2 : NOT APPLICABLE : 3.552 m² (ABOUT) : 3.562 m² (ABOUT)		тота	1,781 m² (ABOUT)	3,562 m² (ABOUT)	

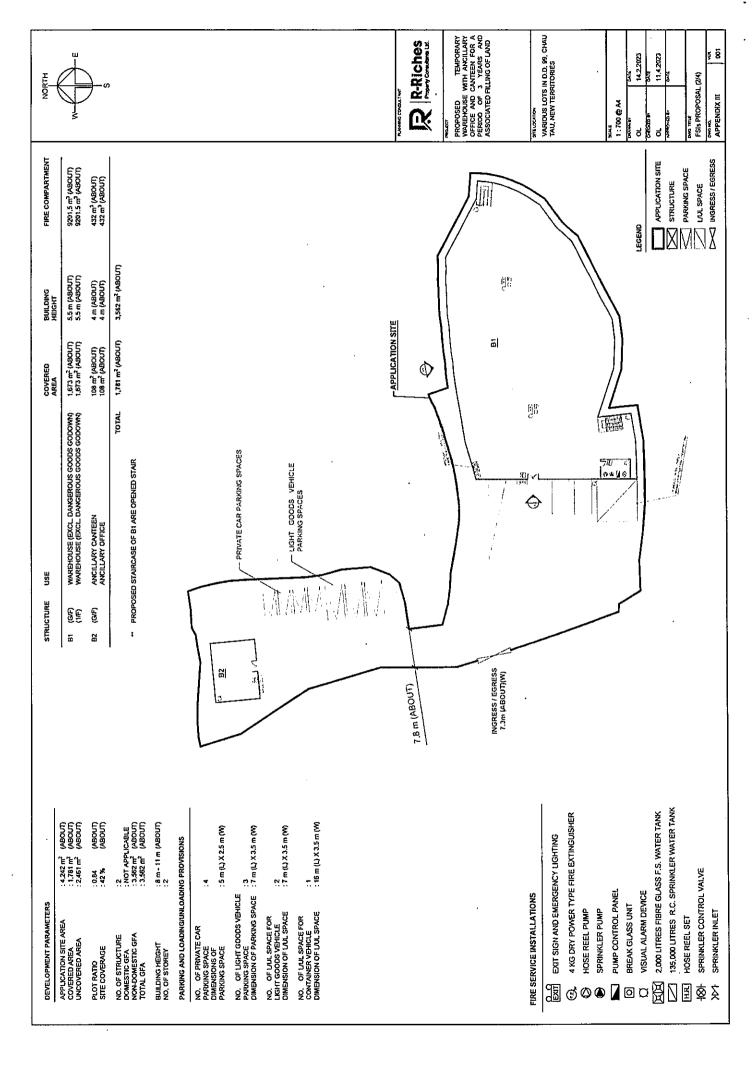.8 m - 11 m (ABOUT)

BUILDING HEIGHT NO. OF STOREY

PLOT RATIO SITE COVERAGE

NO. OF STRUCTURE DOMESTIC GFA NON-DOMESTIC GFA TOTAL GFA

DEVELOPMENT PARAMETERS

APPLICATION SITE AREA COVERED AREA UNCOVERED AREA

PARKING AND LOADING/UNLOADING PROVISIONS

NO. OF PRIVATE CAR PARKING SPACE DIMENSIONS OF PARKING SPACE

# 1/F INTERNAL LAYOUT OF STRUCTURE B1

:1 :16 m (L) X 3.5 m (W)


NO. OF L/UL SPACE FOR CONTAINER VEHICLE DIMENSION OF L/UL SPACE

:2 :7 m (L) X 3.5 m (W)

NO. OF L/UL SPACE FOR LIGHT GOODS VEHICLE DIMENSION OF L/UL SPACE

NO. OF LIGHT GOODS VEHICLE :3 DIMENSION OF PARKING SPACE :7 m (L) X 3.5 m (W)

:5 m (L) X 2.5 m (W)

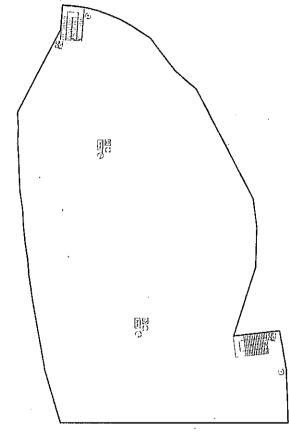

	120 130 130 130 130 130 130 130 130 130 13		\ \ \
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PROPOSED TEJAPORARY WAREHOUSE WITH ANCILLARY OFFICE AND CANTEEN FOR A PERIOD OF 3 YEARS AND ASSOCIATED FILLING OF LAND

R-Riches

VARIOUS LOTS IN D.D. 99, CHAU TAU, NEW TERRITORIES

្ 8

PMG TILL FSIS PROPOSAL (3/4) DMG MG APPENDIX III

14.2.2023 11.4.2023

LEGEND

OL. ಕ

APPLICATION SITE

SITRUCTURE

THE SPACE

UNL SPACE

NORESS/ EGRESS

1:500 @ A4

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EXIT SIGN AND EMERGENCY LIGHTING

4 KG DRY POWER TYPE FIRE EXTINGUISHER HOSE REEL PUMP ⊕ 🖾 🚳

SPRINKLER PUMP


PUMP CONTROL PANEL

**VISUAL ALARM DEVICE** BREAK GLASS UNIT

135,000 LITRES R.C. SPRINKLER WATER TANK 2,000 LITRES FIBRE GLASS F.S. WATER TANK

SPRINKLER CONTROL VALVE HOSE REEL SET

SPRINKLER INLET

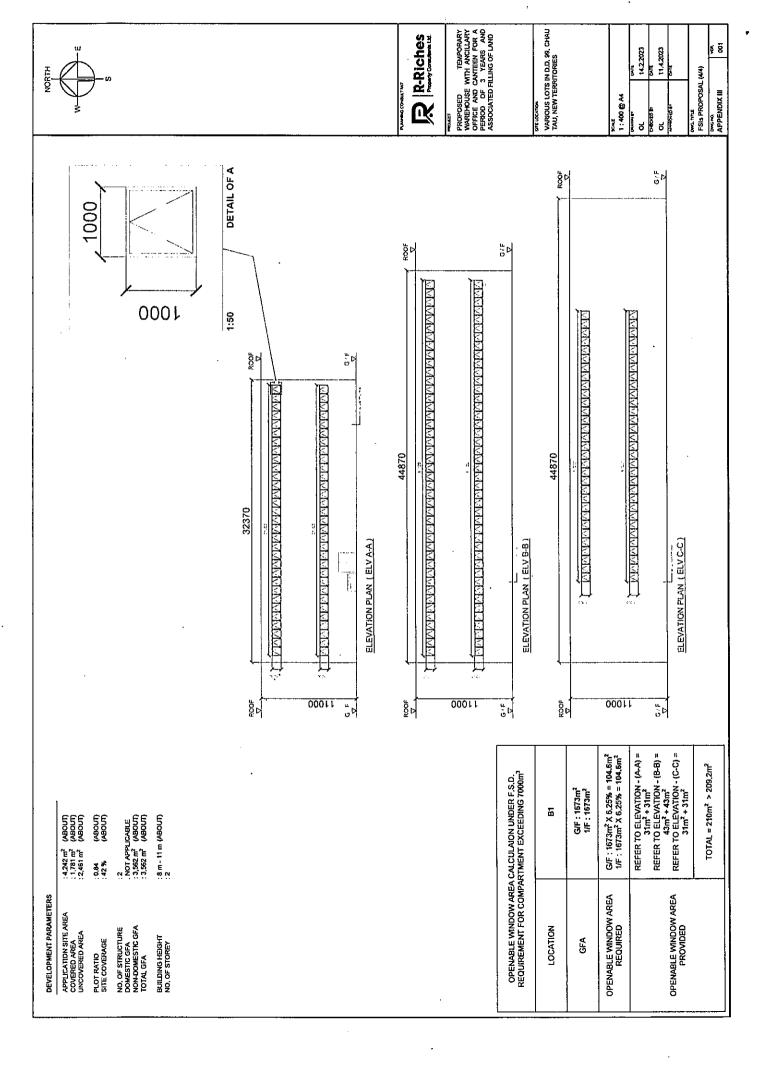

.



### Appendix Ia of RNTPC Paper No. A/YL-ST/646



Our Ref.

: DD99 Lot 247 & VL

Your Ref.

: TPB/A/YL-ST/646

The Secretary
Town Planning Board
15/F, North Point Government office
333 Java Road
North Point, Hong Kong

By Email

7 June 2023

Dear Sir,

### 1<sup>st</sup> Further Information

Proposed Temporary Warehouse (Excluding Dangerous Goods Godown) with Ancillary Office and Canteen for a Period of 3 Years and Associated Filling of Land in "Green Belt" Zone, Various Lots in D.D. 99, Chau Tau, Yuen Long

(S.16 Planning Application No. A/YL-ST/646)

We are writing to submit Further Information to address departmental comments of the subject application (**Appendix I**).

Should you require more information regarding the application, please contact our Mr.

Orpheus LEE at / or the undersigned at your convenience. Thank you for your kind attention.

Yours faithfully,

For and on behalf of

**R-riches Property Consultants Limited** 

Louis TSE

Town Planner

cc DPO/FSYLE, PlanD

(Attn.: Ms. Alice CHEUNG

(Attn.: Mr. Davy LAM

email: ayycheung@pland.gov.hk )

email: dlylam@pland.gov.hk





### Responses-to-Comments

### Proposed Temporary Warehouse (Excluding Dangerous Goods Godown) with Ancillary Office and Canteen for a Period of 3 Years and Associated Filling of Land in <a href=""">"Green Belt" Zone, Various Lots in D.D. 99, Chau Tau, Yuen Long</a>

(S.16 Planning Application No. A/YL-ST/646)

### (i) A RtoC Table:

### **Departmental Comments** Applicant's Responses 1. Comments of District Lands Officer/Yuen Long, LandsD (Contact Person: Mr. YIP Wai Ki; Tel: 2443 3474) (a) LandsD has grave concerns given that there Noted. The applicant will submit Short Term are unauthorized building works and/or uses Waiver (STW) applications to Lands on Lot No. 276 S.B RP in D.D. 99 which are Department to make way for erection of the already subject to lease enforcement actions proposed structures at the Site. No structure according to case priority. The lot owner(s) is proposed for domestic use. should remedy the lease breaches as demanded by LandsD. 2. Comments of Chief Town Planner, Urban Design & Landscape, Planning Department (Contact Person: Mr. NG Tat Yuen, Henry; Tel: 3565 3950) (a) The applicant should provide information on According to the tree survey report existing trees within the site (e.g. species, conducted on 21/4/2023, a total of 2 nos. of size, condition, location and proposed tree trees were recorded within the site boundary treatment) and mitigation measures for (Annex I). No OVT or protected species has consideration. been identified in accordance with the DEVB TC(W) No. 5/2020 - Registration and Preservation of Old and Valuable Trees and the Forests and Countryside Ordinance (Cap.96) respectively. All identified trees are proposed to be felled (Plan 1). Due to the felling of existing trees within the Site, 2 new trees are proposed to be planted to compensate for the loss of the 2 existing




trees (**Plan 1**). They will be planted at the Northern portion of the application site. All these new trees within the Site will be

maintained by the applicant.

	Contact Person: Mr. LEONG Cheung Ching; Tel	
(a)	The site is situated in a relatively low-lying area. The catchment zone in the submission shall consider the flow path with reference to the site topography.	It has been considered accordingly. Please see the revised drainage proposal at <b>Annex</b> II.
(b)	Since the applicant proposes land filling works on the site, the applicant is required to demonstrate that there will be no adverse impact to the nearby site in the drainage proposal.	Cross-section is provided
(c)	There is no cover to the underground pipe according to the information shown in the sectional view. Please view.	Inverted level of underground pipe is revised.
(d)	From our record, the existing channel to be discharged to is 1000mm wide. Please clarify.	It is revised accordingly.
(e)	Please provide the drainage details of the U channel with cast iron grating.	It is provided accordingly in accordance with CEDD's standard drawing C2412E.



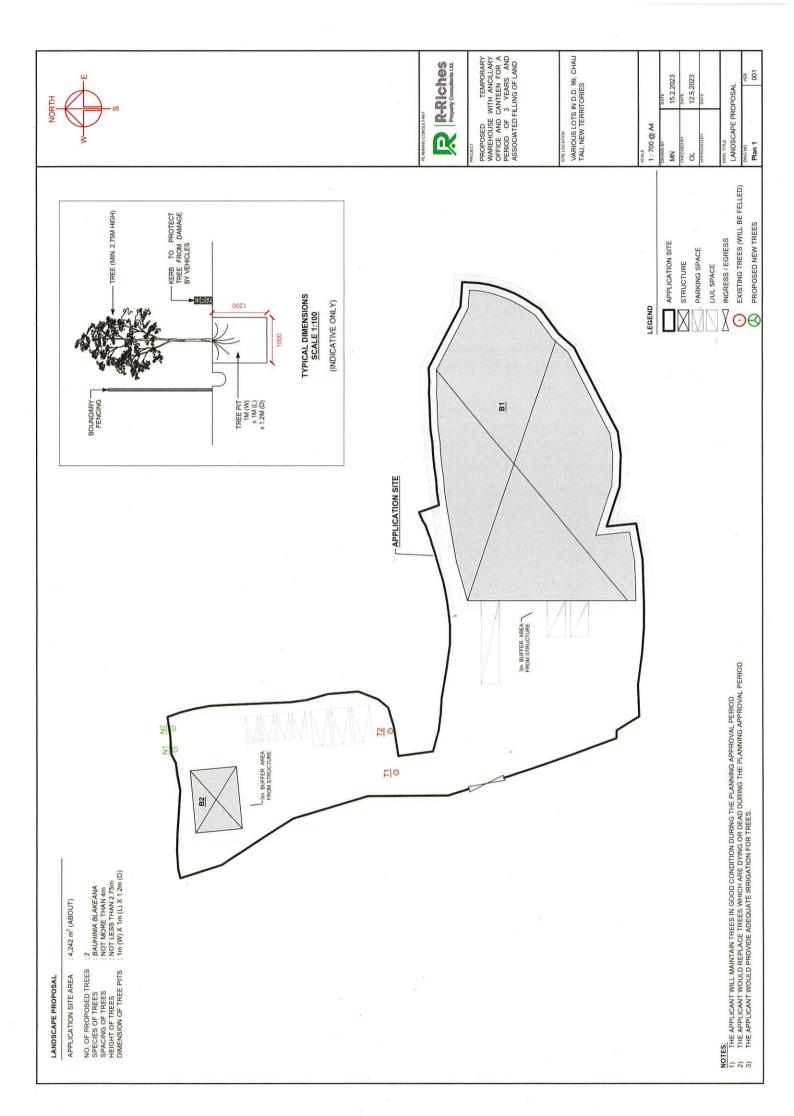



### **Tree Survey Report**

Date of Survey: 21stApril 2023

### **Location:**

Private Area, Chau Tau West Road, Lok Ma Chau

Prepared by:

Mak Ka Hei

Date: 21st April 2023



### Table of contents

1. Introduction 3

2. Summary of Existing Trees

### Appendix:

- I. Tree Survey Plan
- II. Tree Survey Schedule
- III. Photo Records

### Disclaimer:

The tree survey conducted indicates the condition of the surveyed trees at the time of inspection only. The assessments of amenity value, form, health and structural condition of the trees surveyed are based on visual inspection from the ground only. No aerial inspection, root digging or mapping, or diagnostic testing has been conducted as part of this survey. Wing Ho Yuen Landscaping Company Limited cannot accept responsibility for future failure or defects detected after the time of inspection of the trees surveyed in this report.



### 1. Introduction

The survey conducted is to record all the existing trees in the tree survey boundary. The survey include tree species identification, tree tagging with durable labels, the measurements of overall tree height, Diameter at Breast Height (DBH), average crown spread, the evaluation on amenity value, form, health and structural conditions.

The tree survey was conducted on 21st April 2023. Plants with DBH less than 95mm were not recorded in the survey.



### 2. Summary of Existing Trees


The surveyed site is located at Private Area, Chau Tau West Road, Lok Ma Chau.

At the time of inspection on 21<sup>st</sup> April 2023, **2 nos.** tree were found within the Site. **No** dead tree was recorded in the surveyed area. Location of individual tree refers to Appendix I.

Details of tree conditions and photo records for individual tree are recorded in the Appendix II and Appendix III respectively.



# Appendix I – Tree Survey Plan

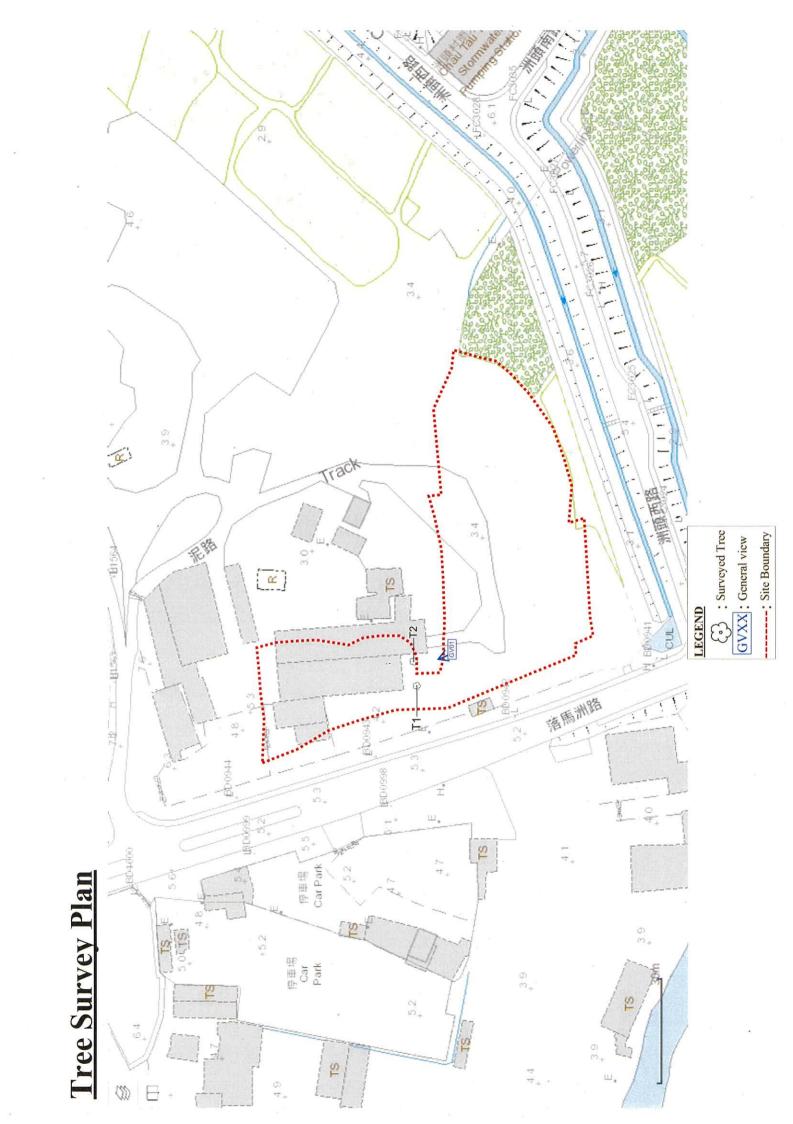



# Appendix II – Tree Survey Schedule

水豪園線化工程有限公司 WING HO YUEN LANDSCAPING CO., LTD.

Tree Survey Schedule

Location:

Tree surveyor(s): Field Survey was conducted on:

Private Area, Chau Tau West Road, Lok Ma Chau Mak Ka Hei 21 April 2023

Tre	Tree Species		Me	Tree Size Measurements	e ents	Amenity Value	Form	Health Condition	Structural Condition	Suitability for- Transplanting	
Botanical Name		Chinese Name	Overall Height (m)	DBH (mm)	Average Crown Spread (m)	High /Med /Low	Good /Fair /Poor	Good /Fair /Poor /Dead	Good /Fair /Poor	High /Med /Low	Remarks
ıaı	Macaranga tanarius	血桶	7.5	360	9.0	Low	Poor	Poor	Poor	Low	broken branch, broken trunk, climbers, abnormal bark cracks, dead branch with fungal fruiting bodies, decay at trunk base, heavy lateral limb, sparse foliage, abnormal leaf size
Litsea monopetala	ıla	假柿木薑子 (假柿樹)	9.0	340	5.5	Low	Poor	Poor	Poor	Low	topped with epicormics

Notes: Amenity Value, Form, Health Condition and Structural Condition of trees were obtained by Visual Assessment Only.

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# Appendix III – Photo Records

# General View



General view 01



# Photo Records



T1 (Overview)



T1 Broken branch\_1



T1 Broken branch\_2



T1 Broken brranch\_3

# Photo Records



T1 Broken trunk



T1 Climbers (Abnormal bark cracks)



T1 Dead branch with fungal fruiting bodies




T1 Decay at trunk base

# Photo Records



T1 Heavy lateral limb

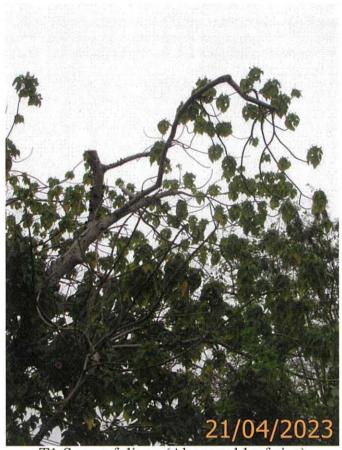


T1 Sparse foliage (Abnormal leaf size)




T2 (Overview)



T2 Topped with epicormics

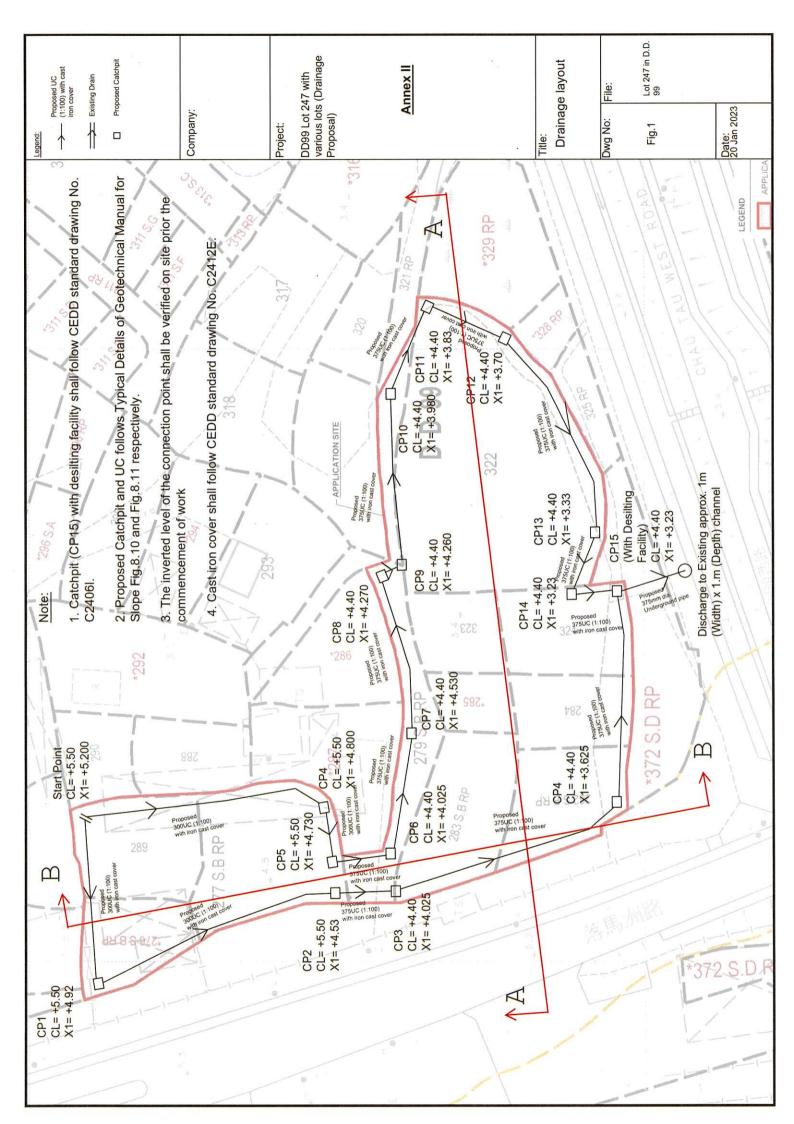

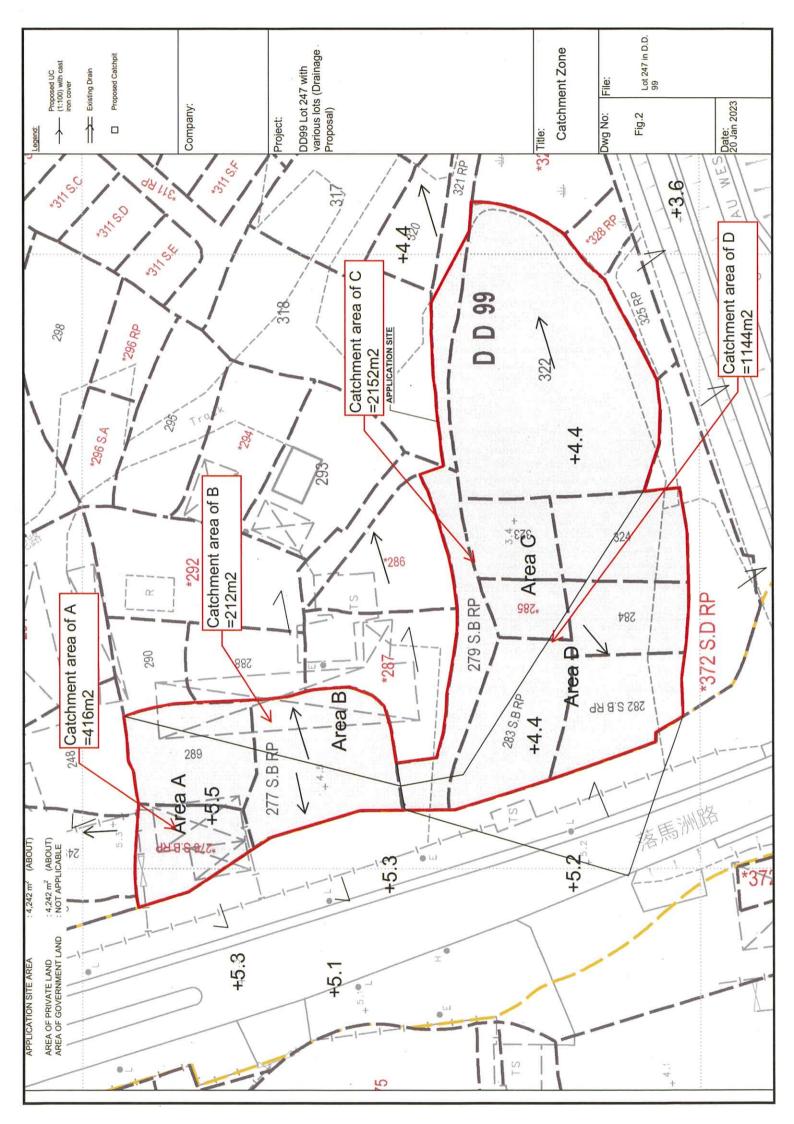

Company: Project:

Date:

23/8/2018

#### Calculation for channels:

#### Catchment Area of site

Area A	=	792 0.000792	m^2 km^2							
Peak runoff in m^3/s	= =	0.278 0.052292 3138	x m^3/s liter/min	0.95	X	250	mm/hr	х	0.000792	km^2
Area B	=	405 0.000405	m^2 km^2							
Peak runoff in m^3/s	= = =	0.278 0.02674 1604	x m^3/s liter/min	0.95	х	250	mm/hr	X	0.000405	km^2
Area C .	= =	2567 0.002567	m^2 km^2							
Peak runoff in m^3/s	= = =	0.278 0.169486 10169	x m^3/s liter/min	0.95	Х	250	mm/hr	х	0.002567	km^2
Area D	=	1645 0.001645	m^2 km^2							
Peak runoff in m^3/s	= = =	0.278 0.108611 6517	x m^3/s liter/min	0.95	Х	250	mm/hr	Х	0.001645	km^2
Total Peak Runoff for A Total Peak Runoff for A and D Total Peak Runoff for B Total Peak Runoff for B and C	= -	0.052292 0.160903 0.02674 0.278097	m^3/s m^3/s m^3/s m^3/s	= = =		3137.5 9654.17 1604.40 16685.8	755 075		liter/min liter/min liter/min liter/min	

According to (Figure 8.7'- Chart for the Rapid Design of Channels), For gradient 1:100, 300UC will be suitable for area A and B For gradient 1:100, 375UC will be suitable for area D For gradient 1:100, 375UC will be suitable for area C




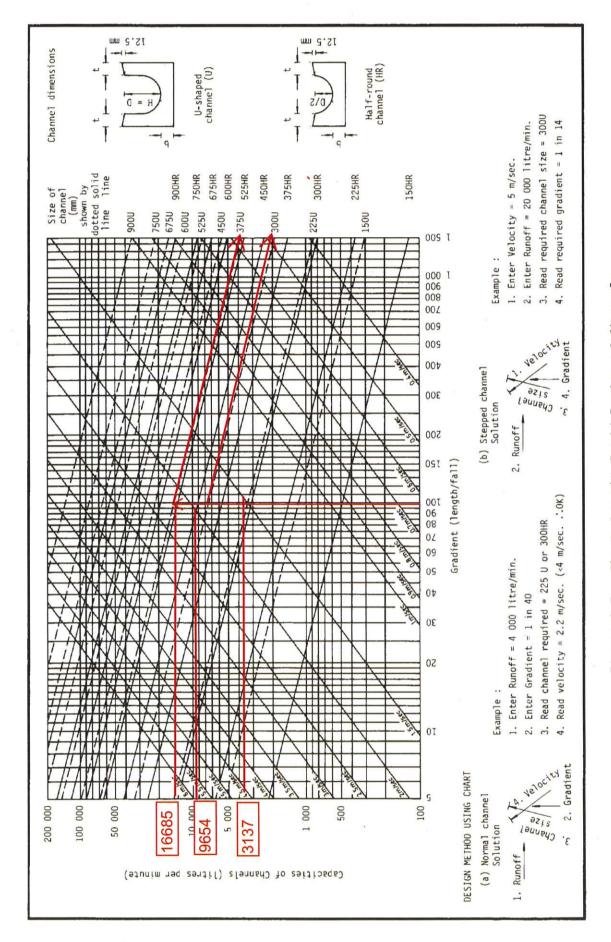



Figure 8.7 - Chart for the Rapid Design of Channels

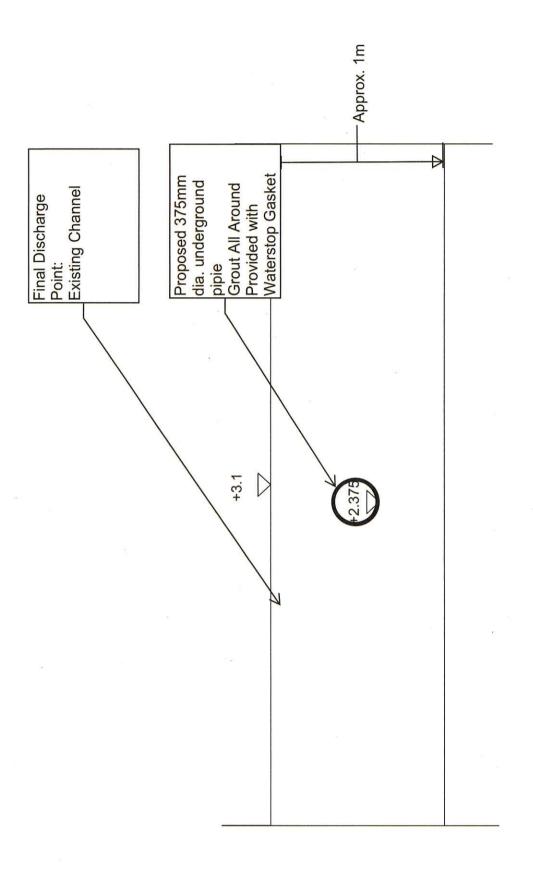

Existing channel Of Connection Detail

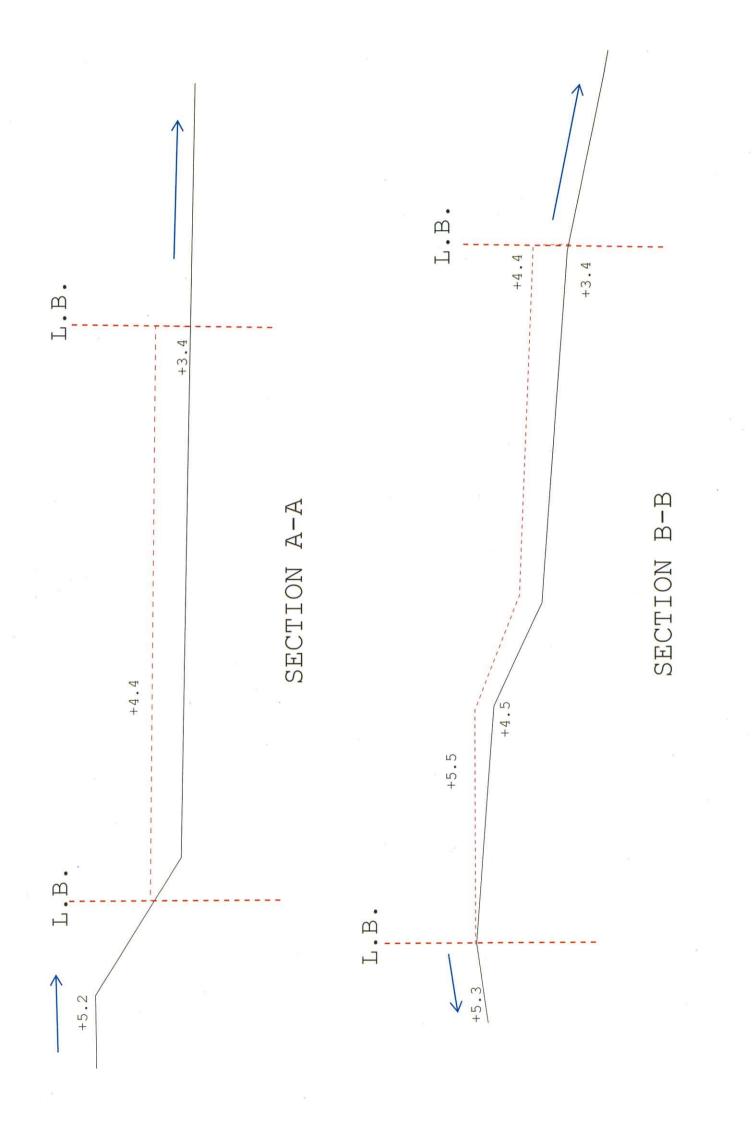

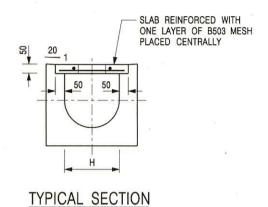


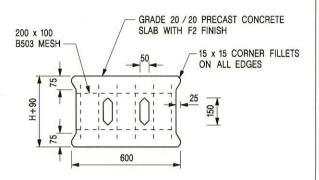


PLAN OF SLAB

## U-CHANNELS WITH PRECAST CONCRETE SLABS

(UP TO H OF 525)

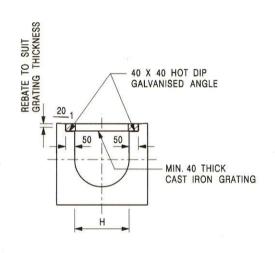

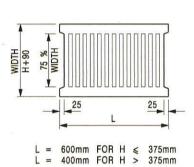

## TYPICAL SECTION

# CAST IRON GRATING

(DIMENSIONS ARE FOR GUIDANCE ONLY, CONTRACTOR MAY SUBMIT EQUIVALENT TYPE)

## U-CHANNEL WITH CAST IRON GRATING

(UP TO H OF 525)

#### NOTES:

- 1. ALL DIMENSIONS ARE IN MILLIMETRES.
- 2. H=NOMINAL CHANNEL SIZE.
- ALL CAST IRON FOR GRATINGS SHALL BE GRADE EN-GJL-150 COMPLYING WITH BS EN 1561.
- 4. FOR COVERED CHANNELS TO BE HANDED OVER TO HIGHWAYS DEPARTMENT FOR MAINTENANCE, THE GRATING DETAILS SHALL FOLLOW THOSE AS SHOWN ON HyD STD. DRG. NO. H3156.

REF.	REVISION	SIGNATURE	DATE
Α	CAST IRON GRATING AMENDED.	Original Signed	
В	NAME OF DEPARTMENT AMENDED.	Original Signed	01.2005
С	MINOR AMENDMENT. NOTE 3 ADDED.	Original Signed	12.2005
D	NOTE 4 ADDED.	Original Signed	
E	NOTES 3 & 4 AMENDED.	Original Signed	

# COVER SLAB AND CAST IRON GRATING FOR CHANNELS

CEDD

# CIVIL ENGINEERING AND DEVELOPMENT DEPARTMENT

**SCALE** 1:20 **DATE** JAN 1991

C2412E

卓越工程 建設香港

We Engineer Hong Kong's Development

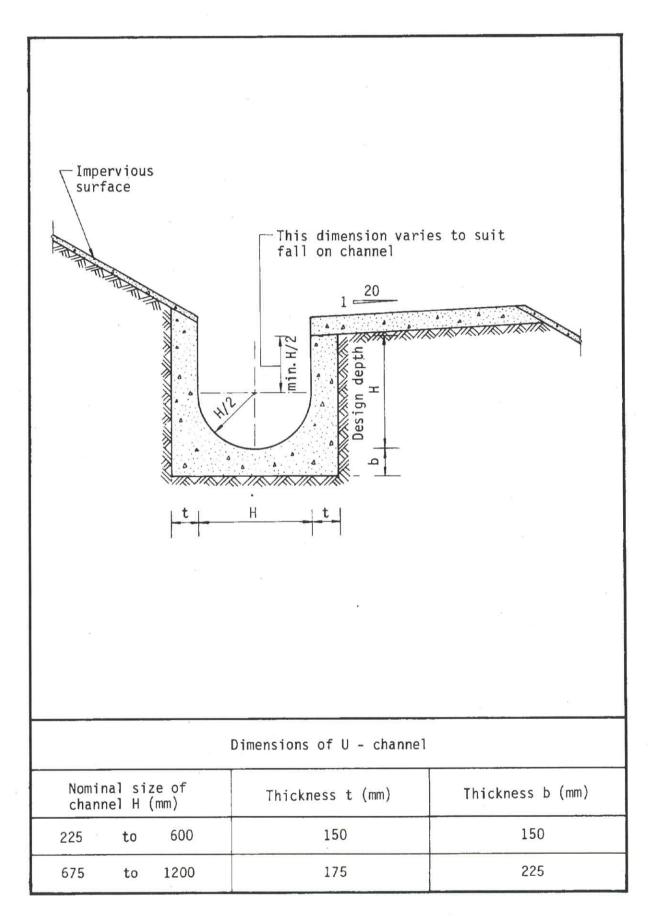


Figure 8.11 - Typical U-channel Details


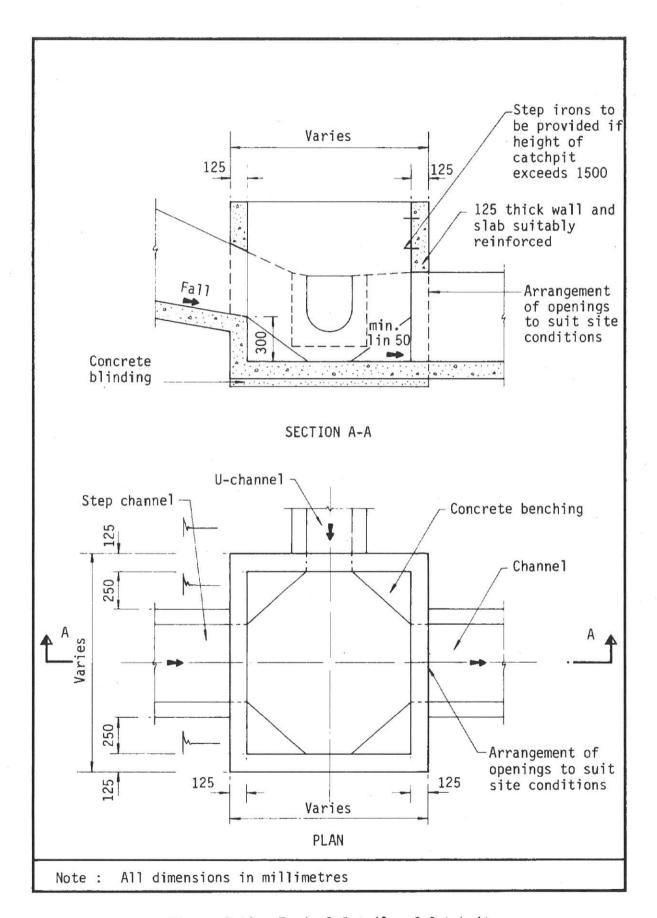


Figure 8.10 - Typical Details of Catchpits

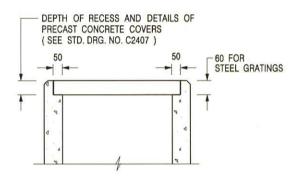

## ALTERNATIVE TOP SECTION FOR PRECAST CONCRETE COVERS / GRATINGS

#### NOTES:

- 1. ALL DIMENSIONS ARE IN MILLIMETRES.
- 2. ALL CONCRETE SHALL BE GRADE 20 /20.
- 3. CONCRETE SURFACE FINISH SHALL BE CLASS U2 OR F2 AS APPROPRIATE.
- 4. FOR DETAILS OF JOINT, REFER TO STD. DRG. NO. C2413.
- 5. CONCRETE TO BE COLOURED AS SPECIFIED
- 6. UNLESS REQUESTED BY THE MAINTENANCE PARTY AND AS DIRECTED BY THE ENGINEER, CATCHPIT WITH TRAP IS NORMALLY NOT PREFERRED DUE TO PONDING PROBLEM.
- 7. UPON THE REQUEST FROM MAINTENANCE PARTY, DRAIN PIPES AT CATCHPIT BASE CAN BE USED BUT THIS IS FOR CATCHPITS LOCATED AT SLOPE TOE ONLY AND AS DIRECTED BY THE ENGINEER.
- 8. FOR CATCHPITS CONSTRUCTED ON OR ADJACENT TO A FOOTPATH, STEEL GRATINGS (SEE DETAIL 'A' ON STD. DRG. NO. C2405 ) OR CONCRETE COVERS (SEE STD. DRG. NO. C2407 ) SHALL BE PROVIDED AS DIRECTED BY THE ENGINEER.
- 9. IF INSTRUCTED BY THE ENGINEER, HANDRAILING (SEE DETAIL 'G' ON STD. DRG. NO. C2405; EXCEPT ON THE UPSLOPE SIDE ) IN LIEU OF STEEL GRATINGS OR CONCRETE COVERS CAN BE ACCEPTED AS AN ALTERNATIVE SAFETY MEASURE FOR CATCHPITS NOT ON A FOOTPATH NOR ADJACENT TO IT. TOP OF THE HANDRAILING SHALL BE 1 000 mm MIN. MEASURED FROM THE ADJACENT GROUND LEVEL
- 10. MINIMUM INTERNAL CATCHPIT WIDTH SHALL BE 1 000 mm FOR CATCHPITS WITH A HEIGHT EXCEEDING 1 000 mm MEASURED FROM THE INVERT LEVEL TO THE ADJACENT GROUND LEVEL. AND, STEP IRONS (SEE DSD STD. DRG. NO. DS1043 ) AT 300 0/c STAGGERED SHALL BE PROVIDED, THICKNESS OF CATCHPIT WALL FOR INSTALLATION OF STEP IRONS SHALL BE INCREASED TO 150 mm.
- FOR RETROFITTING AN EXISTING CATCHPIT WITH STEEL GRATING, SEE DETAIL 'F' ON STD. DRG. NO. C2405.
- SUBJECT TO THE APPROVAL OF THE ENGINEER, OTHER MATERIALS CAN ALSO BE USED AS COVERS / GRATINGS.

CATCHPIT WITH TRAP (SHEET 2 OF 2)

卓越工程 建設香港

FORMER DRG. NO. C2406J. Original Signed 03.2015 SIGNATURE DATE REF. REVISION CIVIL ENGINEERING AND




DEVELOPMENT DEPARTMENT

**SCALE** 1:20 DATE

JAN 1991

DRAWING NO. C2406 /2

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(SHEET 1 OF 2)

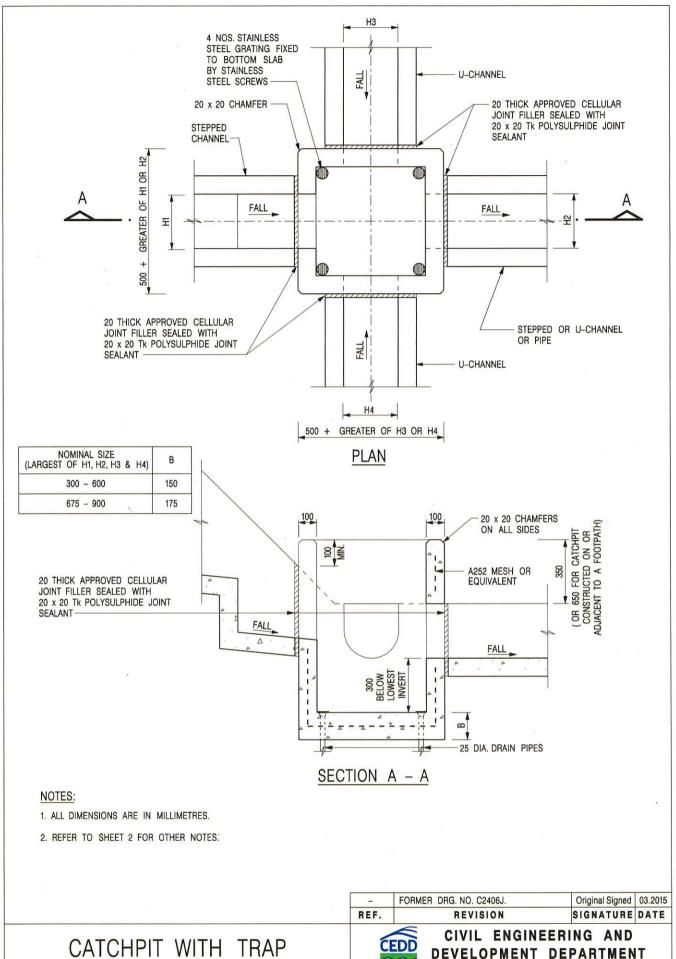**DEVELOPMENT DEPARTMENT** 

**SCALE** 1:20 DATE JAN 1991 DRAWING NO. C2406 /1

We Engineer Hong Kong's Development



## Appendix Ib of RNTPC Paper No. A/YL-ST/646



Our Ref.

: DD99 Lot 247 & VL

Your Ref.

: TPB/A/YL-ST/646

The Secretary Town Planning Board 15/F, North Point Government office 333 Java Road North Point, Hong Kong

By Email

20 June 2023

Dear Sir,

#### 2<sup>nd</sup> Further Information

Proposed Temporary Warehouse (Excluding Dangerous Goods Godown) with Ancillary Office and Canteen for a Period of 3 Years and Associated Filling of Land in "Green Belt" Zone, Various Lots in D.D. 99, Chau Tau, Yuen Long

(S.16 Planning Application No. A/YL-ST/646)

We are writing to submit Further Information to address departmental comments of the subject application (Appendix I).

Should you require more information regarding the application, please contact our Mr. or the undersigned at your Orpheus LEE at convenience. Thank you for your kind attention.

Yours faithfully,

For and on behalf of

R-riches Property Consultants Limited

**Louis TSE** 

**Town Planner** 

cc DPO/FSYLE, PlanD

(Attn.: Ms. Alice CHEUNG

(Attn.: Mr. Davy LAM

email: ayycheung@pland.gov.hk)

email: dlylam@pland.gov.hk





#### Responses-to-Comments

Proposed Temporary Warehouse (Excluding Dangerous Goods Godown) with Ancillary Office and Canteen for a Period of 3 Years and Associated Filling of Land in <a href=""">"Green Belt" Zone, Various Lots in D.D. 99, Chau Tau, Yuen Long</a>

(Application No. A/YL-ST/646)

#### (i) A RtoC Table:

#### **Departmental Comments**

#### **Applicant's Responses**

## Comments of Chief Town Planner, Urban Design & Landscape, Planning Department (Contact Person: Mr. NG Tat Yuen, Henry; Tel: 3565 3950)

(a) Two existing trees were recorded (i.e. T01: Macaranga tanarius and T02: Litsea monopetala) within the site boundary in Annex 1 - Tree Survey Report (Date of Survey 21 April 2023) and are proposed to be felled with compensatory planting of 2 new trees as shown on Plan 1. According to our site visit on 22.5.2023, a number of existing trees were identified within the site but have not been recorded in the advanced FI-1 (e.g. trees at the west and southwest of the site). The applicant is advised to verify and suitably update the information of existing trees within the site and proposed mitigation measures.

According to the revised tree survey report conducted on 13/6/2023, a total of <u>12</u> nos. of trees were recorded within the site boundary (**Annex I**). No OVT or protected species has been identified in accordance with the DEVB TC(W) No. 5/2020 — Registration and Preservation of Old and Valuable Trees and the Forests and Countryside Ordinance (Cap.96) respectively. Among the 12 identified trees, <u>7</u> of them (T1 to T2, T8 to T12) are proposed to be felled while <u>5</u> of them (T3 to T7) will be preserved at the application site (the Site) (**Plan 1**).

Due to the felling of existing trees within the Site, 7 new trees (N1 to N7) are proposed to be planted to compensate for the loss of the 7 existing trees (Plan 1). They will be planted at the Northern and Southern portion of the Site. All these new trees within the Site will be maintained by the applicant.


## Comments of Commissioner for Transport, Transport Department (Contact Person: Mr. LEUNG Chi Kong; Tel: 2399 2778)


(a) From the swept path shown in Drawing No.
Plan 13, it is noted that container vehicle will
encroach into the opposite traffic lane when
leaving the site. Please review.

The Site is assessable from Lok Ma Chau Road via the proposed run-in/out (**Plan 2**). Although the swept path analysis of container vehicle will encroach into the opposite traffic lane when egressing from the Site and making a left-turn, it is envisaged that the time required for encroachment will

		of Lok N straight a for the pr Road. In that the	nort. Also, the la Chau Road nd clear sightli oposed run-in view of the al use of the pr le from traffic	I outside the ine could be p n/out at Lok N bove, it is cor oposed run-i	e Site is provided Ma Chau nsidered n out is
(b)	Please supplement the total number of employee so as to justify the sufficiency of car parking spaces.	more tha car parki Furtherm the Site is of the Site	would be able in 15 employeing spaces are ore, the near located at aple. Therefore, e Site by public	es. 4 nos. of e provided for est bus stop proximately 5 employees co	private or staff. serving m west
(c)	The subject site is connected to Lok Ma Chau Road via a section of a local access which is not managed by Transport Department. The land status of the local access should be clarified with Lands Department by the applicant. Moreover, the management and maintenance responsibilities of the local access should be clarified with the relevant lands and maintenance authorities accordingly.	regarding responsib planning	The applicate land owner(sthe managemoilities of the approval has bonning Board.	ent and main	tment(s) tenance ss after
(d)	Please advise the construction programme of the filling work and the associated trip generation of the construction vehicles under peak hours.	transport land fillir stage. In works, it trips will	mixer trunk ation of conc ng works dur view of the sm is estimated t be generated lay during pea	rete to facili ing the cons nall scale of la that not more and attracte	tate the struction and filling than 4 d by the
	e -	Time Period 09:00 - 10:00	Trip Generation	Trip Attraction	Total 2

	-	17:00 - 18:00	1	1	2
		attracted minimal,	er of vehicula by the prop adverse traff work should no	osed develop fic impact to	oment is nearby
(e)	Based on the layout plan in Drawing No. Plan 10, there is an existing temporary structure located in close proximity to the ingress / egress point. Please review.	close pro Site will Departme proposed Developn Works Pr	ing temporary ximity to the i be demoli ent to facili I under the PW nent of Lok M rojects Packag structure Wor	ngress / egre shed by re tate the ru /P Item No. 7 Ia Chau Loop e 1 – Site Fo	ss of the espective in-in/out 856 CL – o – Main

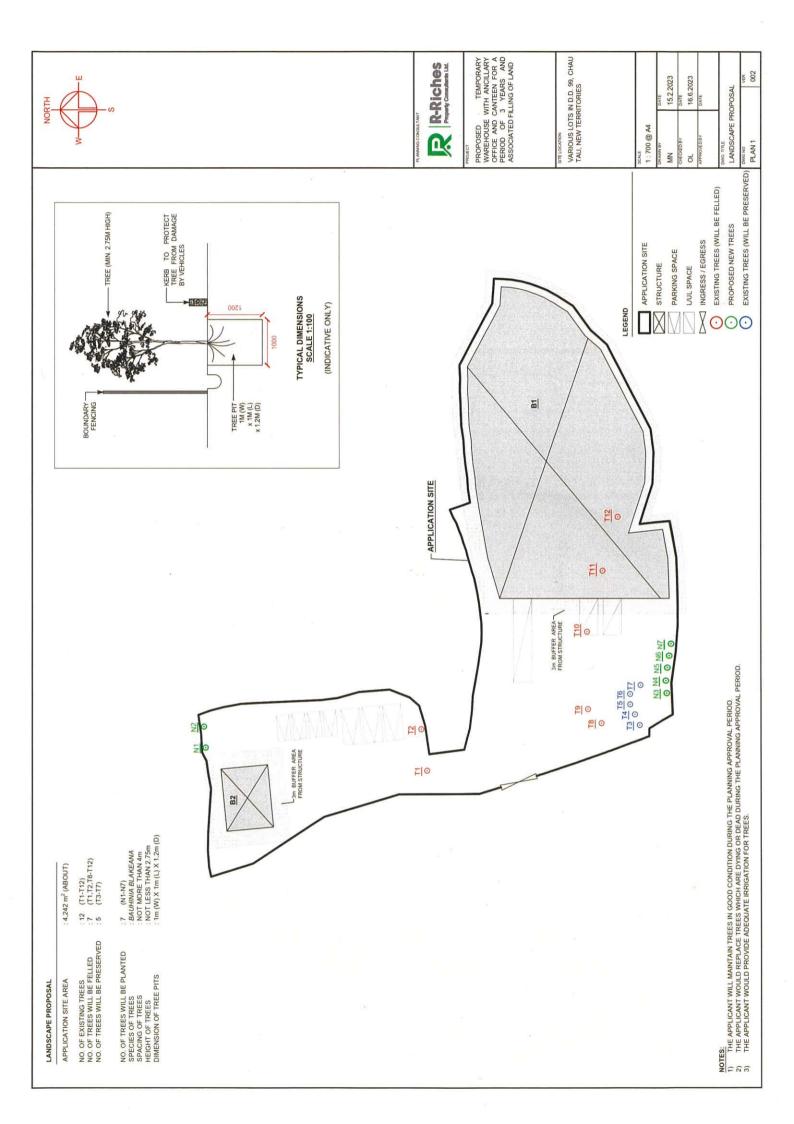

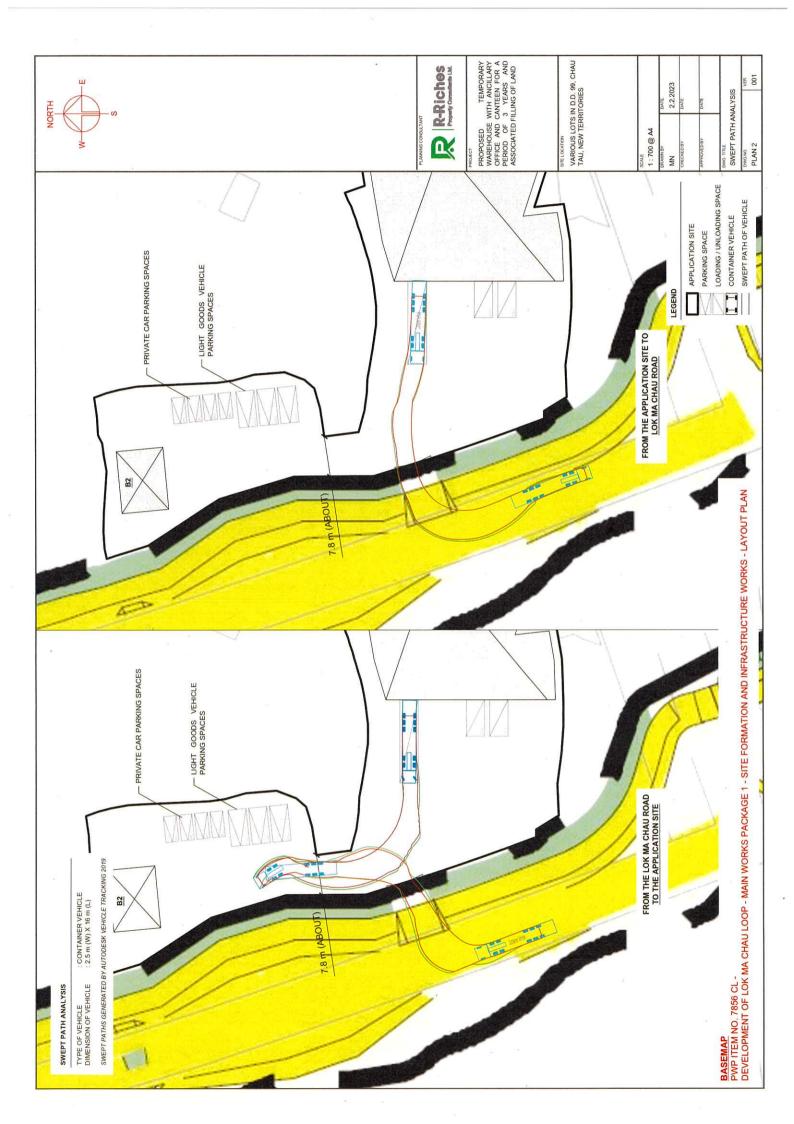



# **Tree Survey Report**

(Rev.01)

Date of Survey: 21st April, 13th June 2023

# Location:

Private Area, Chau Tau West Road, Lok Ma Chau

Prepared by:

Mak Ka Hei

Date: 14th June 2023



## **Table of contents**

1. Introduction 3

2. Summary of Existing Trees 4

## Appendix:

- I. Tree Survey Plan
- II. Tree Survey Schedule
- III. Photo Records

#### Disclaimer:

The tree survey conducted indicates the condition of the surveyed trees at the time of inspection only. The assessments of amenity value, form, health and structural condition of the trees surveyed are based on visual inspection from the ground only. No aerial inspection, root digging or mapping, or diagnostic testing has been conducted as part of this survey. Wing Ho Yuen Landscaping Company Limited cannot accept responsibility for future failure or defects detected after the time of inspection of the trees surveyed in this report.



## 1. Introduction

The survey conducted is to record all the existing trees in the tree survey boundary. The survey include tree species identification, tree tagging with durable labels, the measurements of overall tree height, Diameter at Breast Height (DBH), average crown spread, the evaluation on amenity value, form, health and structural conditions.

The tree survey was conducted on 21st April and 13th June 2023. Plants with DBH less than 95mm were not recorded in the survey.



## 2. Summary of Existing Trees


The surveyed site is located at Private Area, Chau Tau West Road, Lok Ma Chau.

At the time of inspection on 21<sup>st</sup> April and 13<sup>th</sup> June 2023, **12 nos.** tree were found within the Site. **No** dead tree was recorded in the surveyed area. Location of individual tree refers to Appendix I.

Details of tree conditions and photo records for individual tree are recorded in the Appendix II and Appendix III respectively.



# Appendix I – Tree Survey Plan

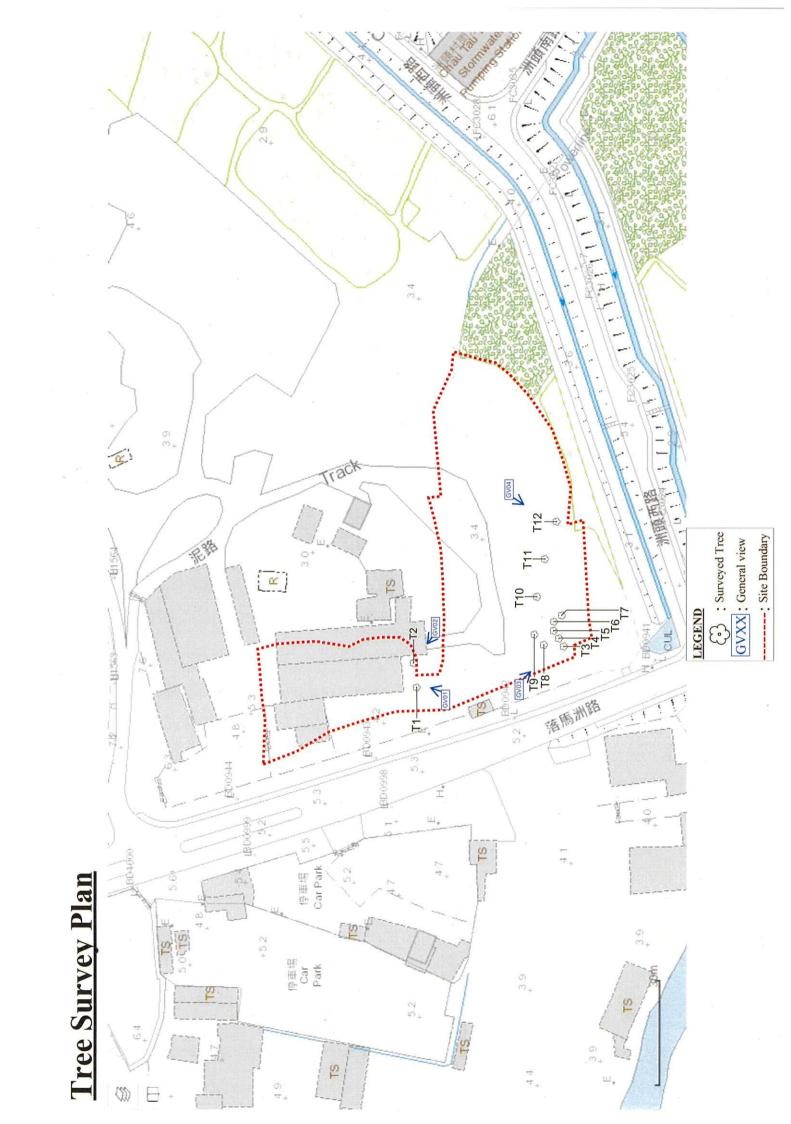



# Appendix II - Tree Survey Schedule

Private Area, Chau Tau West Road, Lok Ma Chau Mak Ka Hei

Tree Survey Schedule

Location:

21 April, 13 June 2023 Tree surveyor(s): Field Survey was conducted on:

水家園綠化工程有限公司

							_			_			
	Remarks	broken branch, broken trunk, climbers, abnormal bark cracks, dead branch with fungal fruiting bodies, decay at trunk base, heavy lateral limb, sparse foliage, abnormal leaf size				ī	í	leaning	co-dominant trunks	co-dominant trunks	-	vine on tree	vine on tree
Suitability for Transplanting	High /Med /Low	Low	Low	Low	Low	Low	Low	Low	Low	Low	Low	Low	Low
Structural Condition	Good /Fair /Poor	Poor	Poor	Poor	Poor	Poor	Poor	Poor	Poor	Poor	Poor	Poor	Poor
Health Condition	Good /Fair /Poor /Dead	Poor	Poor	Poor	Poor	Poor	Poor	Poor	Poor	Poor	Poor	Poor	Poor
Form	Good /Fair /Poor	Poor	Poor	Poor	Poor	Poor	Poor	Poor	Poor	Poor	Poor	Poor	Poor
Amenity Value	High /Med /Low	Low	Low	Low	Low	Low	Low	Low	Low	Low	Low	Low	Low
e nits	Average Crown Spread (m)	0.6	5.5	0.9	7.0	4.0	4.0	8.0	0.9	7.0	0.9	0.9	5.0
Tree Size Measurements	DBH (mm)	360	340	260	240	140	150	170	190	240	220	210	220
W	Overall Height (m)	7.5	9.0	10.0	10.0	0.9	7.0	0.6	8.0	10.0	0.6	9.0	7.0
	Chinese Name	血	假柿木薑子 (假柿樹)	銀合歡	銀合歡	銀合歡	銀合歡	銀合歡	血桐	銀合歡	血桐	銀合歡	伽桐
Tree Species	Botanical Name	Macaranga tanarius	Litsea monopetala	Leucaena leucocephala	Macaranga tanarius	Leucaena leucocephala	Macaranga tanarius	Leucaena leucocephala	Macaranga tanarius				
	Tree No.	T01	T02	T03	T04	T05	T06	T07	T08	T09	T10	TII	T12

Notes: Amenity Value, Form, Health Condition and Structural Condition of trees were obtained by Visual Assessment Only.



## Appendix III – Photo Records

## General View




General view 01



## General View



General view 03

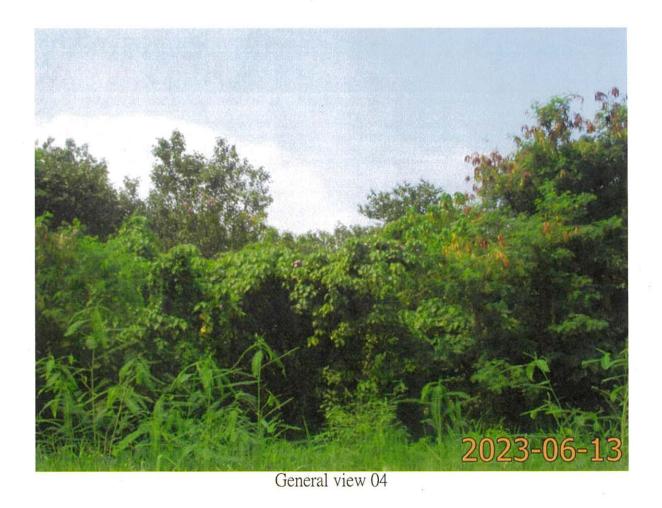



T1 (Overview)



T1 Broken branch\_1






T1 Broken brranch\_3



T1 Broken trunk

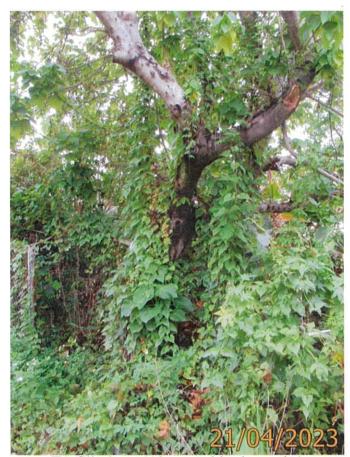

T1 Climbers (Abnormal bark cracks)




T1 Dead branch with fungal fruiting bodies



T1 Decay at trunk base



T1 Heavy lateral limb

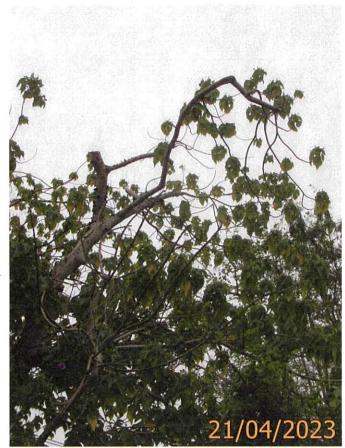

T1 Sparse foliage (Abnormal leaf size)



T2 (Overview)



T2 Topped with epicormics







T04 (Overview)



T05 (Overview)





T07 (Overview)



T08 (Overview)



T09 (Overview)





T11 (Overview)



T12 (Overview)



#### Appendix Ic of RNTPC Paper No. A/YL-ST/646

顧問有限公司 **盈卓物業** 

Our Ref.

: DD99 Lot 247 & VL

Your Ref.

: TPB/A/YL-ST/646

The Secretary
Town Planning Board
15/F, North Point Government office
333 Java Road
North Point, Hong Kong

By Email

25 July 2023

Dear Sir,

#### 3<sup>rd</sup> Further Information

Proposed Temporary Warehouse (Excluding Dangerous Goods Godown) with Ancillary Office and Canteen for a Period of 3 Years and Associated Filling of Land in "Green Belt" Zone, Various Lots in D.D. 99, Chau Tau, Yuen Long

(S.16 Planning Application No. A/YL-ST/646)

We are writing to submit Further Information to address departmental comments of the subject application (Appendix I).

Should you require more information regarding the application, please contact our Mr.

Orpheus LEE at or the undersigned at your convenience. Thank you for your kind attention.

Yours faithfully,

For and on behalf of

R-riches Property Consultants Limited

Louis TSE

Town Planner

cc DPO/FSYLE, PlanD

(Attn.: Ms. Alice CHEUNG

(Attn.: Mr. Davy LAM

email: ayycheung@pland.gov.hk )

email: dlylam@pland.gov.hk



# Responses-to-Comments

Proposed Temporary Warehouse (Excluding Dangerous Goods Godown) with Ancillary Office and Canteen for a Period of 3 Years and Associated Filling of Land in "Green Belt" Zone, Various Lots in D.D. 99, Chau Tau, Yuen Long

# (Application No. A/YL-ST/646)

- (i) Clarifications for the Proposed Development
- Despite the fact that the Site area (i.e. 4,242 m²) is larger than the original 2-storey premises in Kwu Tung (3,172m²), a major portion of the drainage facilities and vehicle maneuvering space. Therefore, the proposed similar scheme is to facilitate the fully relocation of the applicant's relocation site has to be reserved to satisfy the requirements of Government Department, i.e. the provision of fire service installations (FSIs), original business premises due to the implementation of Kwu Tung North New Development Area.
- (ii) A RtoC Table:

	Departmental Comments	Applicant's Responses
1:	1. Comments of Project Manager (North) and Project Manager (West), Civil Engineering and Development Department	st), Civil Engineering and Development Department
	(Contact Person: Mr. WONG Ka Lun, Alan; Tel: 2417 6356)	
(a)	The subject site is within the boundary of San Tin Technopole.	(a) The subject site is within the boundary of San Tin Technopole. Noted. The application is only on a temporary basis and the applicant agreed to be
	According to the latest tentative development programme of	According to the latest tentative development programme of moved out during the land resumption stage of the development of San Tin
	San Tin Technopole, the construction work and land	work and land Technopole. The proposed use would be terminated if the Government resume the
	resumption will commence after the FC funding approval	Site for clearance and construction and relevant works.
	tentatively by 2024. Thus, the subject site, within the	
	boundary of San Tin Technopole, will probably be required for	
	timely clearance and construction.	
,,,,,		



(q)	The proposed temporary warehouse has encroached into the	Noted. The appli	cation site (the Site) is	Noted. The application site (the Site) is accessible from Lok Ma Chau Road via a	Ma Chau Road via a
	works area of Contract No. YL/2020/02 which commenced in	local access. A p	roper run-in/out will b	local access. A proper run-in/out will be implemented by respective B/Ds under	spective B/Ds under
1	September 2021 and will take about 50 months to complete.	PWP Item No. 78	356CL (i.e. Developme	PWP Item No. 7856CL (i.e. Development of Lok Ma Chau Loop - Main Works	oop – Main Works
	Contract No. YL/2020/02 mainly includes the construction of	Package 1 – Site F	ormation and Instructu	Package 1 – Site Formation and Instructure Works), which connects the local access	ects the local access
	Western Connection Road Phase2 through widening of a	to Lok Ma Chau F	toad (Plan 1). The ap	to Lok Ma Chau Road (Plan 1). The applicant will liaise with CEDD regarding the	CEDD regarding the
	section of existing Lok Ma Chau Road and the construction of	right of way and t	he project interface is:	right of way and the project interface issues with the proposed development after	development after
	associated works including footpaths, cycle tracks, slopes,	planning approva	has been granted fror	planning approval has been granted from the Town Planning Board (the Board).	oard (the Board).
	retaining walls, water supply and drainage system. There is a				
	potential interface at the concerned location for the proposed				
	temporary warehouse under the current application.			585	
.:	Comments of Commissioner for Transport, Transport Department	ı			
	(Contact Person: Mr. LEUNG Chi Kong; Tel: 2399 2778)				
(a)	As CEDD is undertaking the construction works for the	During the constru	iction and operation st	During the construction and operation stages, staff will be deployed at the ingress /	oyed at the ingress /
	Development of Lok Ma Chau Loop at Lok Ma Chau Road,	egress to direct be	oth incoming and outg	egress to direct both incoming and outgoing vehicles to enhance road safety. The	ce road safety. The
	please check with the relevant project office of CEDD on the	applicant will liais	e with CEDD regarding	applicant will liaise with CEDD regarding the project interface and sightline issues	and sightline issues
	project interfacing issues with the proposed development,	with the proposed	development after pla	with the proposed development after planning approval has been granted from the	en granted from the
	especially on the sight line issue for vehicles leaving the	Town Planning Board (the Board).	ard (the Board).		
	development site.				
(p)	During the construction stage:	Concrete mixer tru	ınk will be deployed for	Concrete mixer trunk will be deployed for transportation of concrete to facilitate the	crete to facilitate the
		land filling works	during the constructio	land filling works during the construction stage. In view of the small scale of land	small scale of land
	b(i) Lok Ma Chau Road is the only road access leading to Lok	filling works, it is	estimated that not r	filling works, it is estimated that not more than 4 trips will be generated and	be generated and
	Ma Chau Spur line BCP. With the resumption of cross	attracted by the S	attracted by the Site per day, details are as follows:	as follows:	
	boundary travel between Mainland and Hong Kong SAR since		8		
	January 2023, the traffic flow on Lok Ma Chau Road has been	Time Period	Trip Generation	Trip Attraction	Total
	kept increasing. In order to ensure the smooth operation of	(Mon to Fri)			
	the BCP, the applicant is advised to re-assign the traffic trips	07:00 - 10:00	0	0	0



		00:01	•	4	ì
	construction stage from the peak hours [07:00 to 09:00; and	13:00 – 15:00	0	0	0
	13:00 to 15:00] to non-peak hours to minimize the traffic	15:00 – 16:00	Н	1	. 2
	impact to the existing road network.	Time Period	Trip Generation	Trip Attraction	Total
		(Sat to Sun)			
	b(ii) Please provide the trip generation / attraction of	07:00 - 10:00	0	0	0
	construction vehicles during non-peak hours in weekday (Mon	10:00 – 11:00	1	1	2
	to Fri) and weekend (Sat to Sun) respectively.	13:00 – 15:00	0	0	0
		15:00 – 16:00	1	1	2
		As number of vehi	icular trips generated i e traffic impact to nea	As number of vehicular trips generated and attracted by the proposed development is minimal, adverse traffic impact to nearby road network should not be anticipated.	posed developmeni I not be anticipated
(c)	During the operation stage:	During the operat	ion stage, the Site is a	During the operation stage, the Site is accessible from Lok Ma Chau Road via a local	hau Road via a loca
		access. The propo	sed development will	access. The proposed development will operate on Monday to Saturday from 09:00	aturday from 09:00
	c(i) As mentioned above, Lok Ma Chau Road is vital to the	_	ration on Sunday and I	to 19:00. No operation on Sunday and public holiday. 4 private car parking spaces,	car parking spaces
	operation of Lok Ma Chau Spurline Boundary Control Point.		icle parking spaces a	3 light goods vehicle parking spaces and 3 L/UL spaces are provided at the Site,	ovided at the Site
	The peak traffic pattern in Lok Ma Chau Road is different with	details of spaces are as follows:	ire as follows:		
	another public road. In view of this, the applicant should	w.			
	update and provide the trip generation / attraction of vehicles	50			
	during the specified peak hours and non-peak hours in		300		
	weekday (Mon to Fri) and weekend (Sat to Sun) by filling in the	845			
	two tables below.				



			Operatic	on Stage	ation Stage in Weekday - Mon	(Operation Stage in Weekday - Mon to Fri)	on to Fr	_
	Time Period	Private C (Staff)	Private Car (Staff)	Light Veh	Light Goods Vehicle	Container Vehicle	ainer icle	2-Way
		n	Out	드	Out	n	Out	lotal
	Trips at AM peak							
	per hour	0	0	0	0	0	0	0
	(07:00 - 08:00)							
	Trips at AM peak							
	per hour	0	0	0	0	0	0	0
	(00:60 - 00:80)							
	Trips at AM peak							
	per hour	2	0	2	0	Н	0	5
	(09:00 - 10:00)							
	Trips at PM peak				1		W)	
	per hour	0	0	0	0	0	0	0
	(13:00 – 14:00)							
£ ,	Trips at PM peak							
	per hour	П	0	1	Н	0	0	က
	(14:00-15:00)							
	Trips at PM peak							
	per hour	0	1	0	2	0	1	4
	(15:00-16:00)							
	Trips at Non-Peak	,	,	0		2	0	7
	Hours	4	4		<u>.</u>			t
	Traffic trip per		,	,	,	7 0	7 0	ц
	hour (average)	-	4	4	-	2	2	ח




Trip			(Oper	ation St	(Operation Stage on Saturday only)	aturday	( only)	
	Time Period	Private Car	e Car	Light (	Light Goods	Cont	Container	
•		(Staff)	iff)	Veh	Vehicle	Vet	Vehicle	2-Way
		n	Out	드	Out	드	Out	lotal
	Trips at AM peak							
	per hour	2	0	2	0	Н	0	2
	(09:00 - 10:00)							
	Trips at AM peak							
	per hour	2.	0	0	П	0	0	n
	(10:00 – 11:00)							
	Trips at AM peak				G			
	per hour	2	0	0	Н	0	н	4
	(11:00 – 12:00)				,			
	Trips at PM peak							
	per hour	0	0	0	0	0	0	0
	(19:00-20:00)							
	Trips at PM peak							
	per hour	0	0	0	0	0	0	0
	(20:00 – 21:00)							e
6	Trips at PM peak							
	per hour	0	0	0	0	0	0	0
(21	(21:00 – 22:00)							
	Trips at Non-Peak	,	,		C	2		
Hou	Hours	1	-	0.0	0.0	0.0	0.0	1
Tra	Traffic trip per	0.5	0.5	0.5	0.5	0.5	0.5	က
hor	hour (average)							0



As the number of vehicular trips generated and attracted by the proposed development is minimal, adverse traffic impact to the surrounding roads should not

be anticipated.



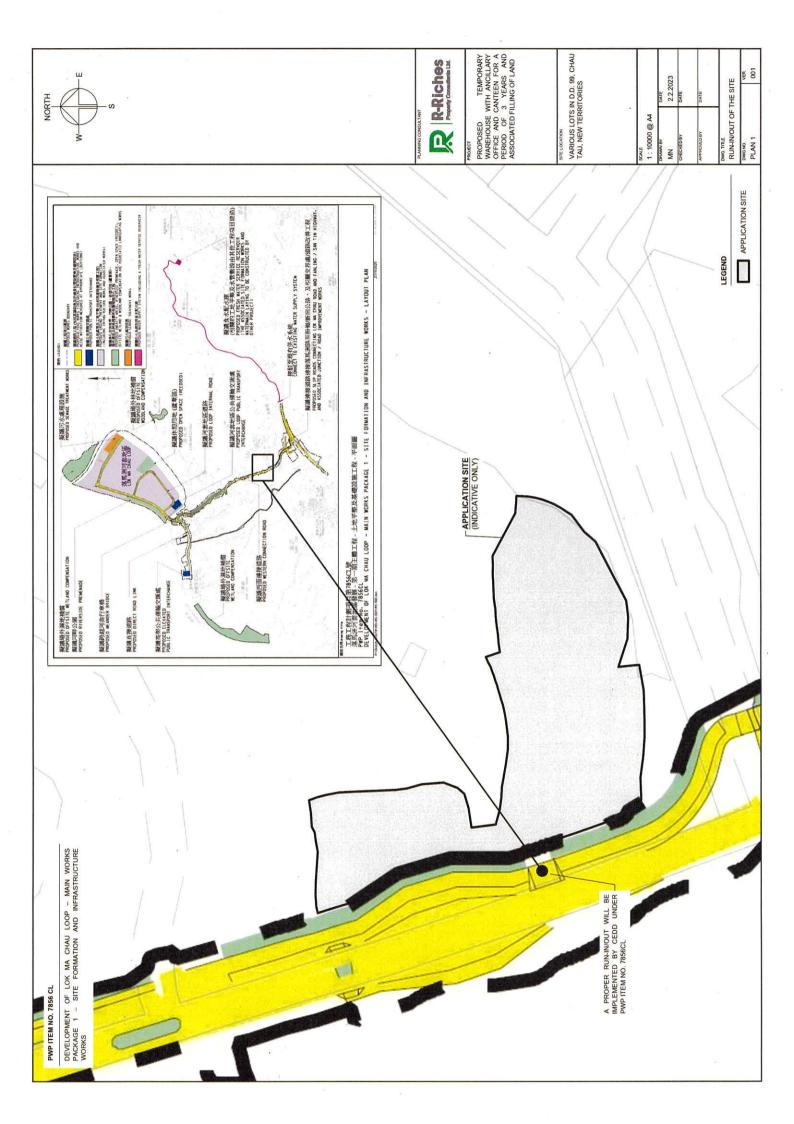

#### Relevant Extracts of Town Planning Board Guidelines for Application for Development within Green Belt Zone under Section 16 of the Town Planning Ordinance (TPB PG-No. 10)

According to TPB PG-No.10, the following assessment criteria are relevant to the application and are summarised as follows:

- (a) there is a general presumption against development (other than redevelopment) in "GB" zone;
- (b) an application for new development in a "GB" zone will only be considered in exceptional circumstances and must be justified with very strong planning grounds;
- (c) the design and layout of any proposed development should be compatible with the surrounding area. The development should not involve extensive clearance of existing natural vegetation, affect the existing natural landscape, or cause any adverse visual impact on the surrounding environment;
- (d) the proposed development should not overstrain the capacity of existing and planned infrastructure such as sewerage, roads and water supply. It should not adversely affect drainage or aggravate flooding in the area; and
- (e) the proposed development should not be susceptible to adverse environmental effects from pollution sources nearby such as traffic noise, unless adequate mitigating measures are provided, and it should not itself be the source of pollution.

#### Relevant Extracts of Town Planning Board Guidelines for Application for Development within Deep Bay Area under Section 16 of the Town Planning Ordinance (TPB PG-No. 12C)

According to TPB PG-No. 12C, the Site falls within the Wetland Buffer Area (WBA) of Deep Bay Area. The relevant assessment criteria are summarised as follows:

#### **WBA**

- (a) the intention of the WBA is to protect the ecological integrity of the fish ponds and wetland within the Wetland Conservation Area (WCA) and prevent development that would have a negative off-site disturbance impact on the ecological value of fish ponds; and
- (b) within the WBA, for development or redevelopment which requires planning permission, an ecological impact assessment (EcoIA) would need to be submitted. Some local and minor uses (including temporary uses) are however exempted from the requirement of EcoIA.

#### Previous s.16 Applications covering the Application Site

#### Rejected s.16 Applications

No.	Application No.	Use(s) / Development(s)	Date of Consideration (RNTPC/TPB)	Rejection Reason(s)
1.	A/YL-ST/150	Temporary Vehicle Park for Container Trailer/Tractor, Lorry and Private Car for a Period of 3 Years	10.11.2000 (RNTPC)	(1), (2), (3)
2.	A/YL-ST/301	Temporary Public Vehicle Park (Private Cars and Lorries) for a Period of 3 Years	11.8.2006 (on review) (TPB) 22.5.2007 Appeal dismissed	(1), (3), (4)
3.	A/YL-ST/567	Filling of Land for Permitted Agricultural Use	6.3.2020 (RNTPC)	(1), (4), (5)

#### Rejection Reasons

- (1) Not in line with the planning intention of the "Green Belt" ("GB") zone. No strong justification for a departure from the planning intention of "GB", even on a temporary basis.
- (2) Not compatible with the rural character of the surrounding area, in particular, to the nearby village settlements of Chau Tau and Pun Uk Tsuen as the movement of heavy vehicles would cause nuisance to the environment and the residents.
- (3) Insufficient information to demonstrate that the development would not have adverse drainage, traffic and landscape impacts on the surrounding areas.
- (4) Setting of an undesirable precedent for other similar applications within the "GB" zones. The cumulative effect would result in a general degradation of the environment of the area.
- (5) Not in line with Town Planning Board Guidelines No. 10 in that the filling of land, which has been completed, involves clearance of natural vegetation, thereby adversely affecting the natural landscape.



#### **Government Departments' General Comments**

#### 1. Traffic

Comments of the Commissioner for Transport (C for T):

- the application site (the Site) is connected to Lok Ma Chau Road via a section of a local access which is not managed by Transport Department. The land status of the local access should be clarified with Lands Department by the applicant. Moreover, the management and maintenance responsibilities of the local access should be clarified with the relevant lands and maintenance authorities by the applicant accordingly.
- having considered the applicant's submissions including the further information, he has no further comment on the application by traffic engineering point of view.
- Should the application be approved, a condition should be incorporated that no vehicle is allowed to queue back to or reverse onto/from public road at any time during the planning approval period.

#### 2. Drainage

Comments of the Chief Engineer/Mainland North, Drainage Services Department (CE/MN, DSD):

he has no objection in principle to the application from drainage operation and maintenance point of view, subject to the following:

- the proposed works should not affect/damage DSD's assets in the vicinity. Should such damage occur, the applicant is requested to inform DSD immediately and carry out remedial works so required to DSD's satisfaction;
- since the applicant proposes land filling works on the Site, the applicant shall demonstrate that there will be no adverse drainage impact to the adjoining areas and drainage facilities in the vicinity in the drainage proposal; and
- his advisory comments are at Appendix V.

#### 3. Other Departments

The following government departments have no objection to or no comment on the application and their advisory comments are at **Appendix V** where appropriate:

- (a) Commissioner of Police;
- (b) Chief Highway Engineer/New Territories West, Highways Department;
- (c) Chief Engineer/Railway Development 2-2, Railway Development Office, Highways Department;
- (d) Project Manager (West), West Development Office, Civil Engineering and Development Department (CEDD);
- (e) Head of Geotechnical Engineering Office, CEDD
- (f) Director of Fire Services;

- (g) (h) Director of Food and Environmental Hygiene;
- Chief Building Surveyor/New Territories West, Buildings Department;
- (i) Chief Engineer/Construction, Water Supplies Department; and
- District Officer (Yuen Long). (j)

#### **Recommended Advisory Clauses**

- (a) The application site (the Site) falls within the boundary of San Tin Technopole. The Site may be resumed by the Government and that the proposed operation at the Site may be terminated at any time during the planning approval period for implementation of government projects;
- (b) to note the comments of the District Lands Officer/Yuen Long, Lands Department (DLO/YL, LandsD) as follows:
  - (i) the Site comprises Old Schedule Agricultural Lots (OSALs) held under the Block Government Lease which contains the restriction that no structures are allowed to be erected without the prior approval of the government;
  - (ii) there are unauthorised building works and/or uses on Lot 276 S.B RP and 279 S.B RP in D.D. 99 which are already subject to lease enforcement actions according to case priority. The lot owner(s) should remedy the lease breaches as demanded by LandsD; and
  - (iii) should planning approval be given to the application, the lot owner(s) will need to immediately apply to his Department to permit the structures to be erected or regularise any irregularity on the Site, if any. Besides, given the proposed use is temporary in nature, only application for regularisation or erection of temporary structure(s) will be considered. Application(s) for any of the above will be considered by LandsD acting in the capacity of the landlord or lessor at its sole discretion and there is no guarantee that such application(s) will be approved. If such application is approved, it will be subject to such terms and conditions, including among others the payment of rent or fee, as may be imposed by LandsD;
- (c) to note the comments of Commissioner for Transport (C for T) that the Site is connected to Lok Ma Chau Road via a section of a local access which is not managed by Transport Department. The land status of the local access should be clarified with LandsD by the applicant. Moreover, the management and maintenance responsibilities of the local access should be clarified with the relevant lands and maintenance authorities by the applicant accordingly;
- (d) to note the comments of the Chief Highway Engineer/New Territories West, Highways Department (CHE/NTW, HyD) as follows:
  - (i) HyD is not/shall not be responsible for the maintenance of any access connecting the Site and Lok Ma Chau Road;
  - (ii) if the proposed run-in/out is agreed by TD, the applicant should provide the run-in/out at Lok Ma Chau Road in accordance with the latest version of Highways Standard Drawings No. H1113 and H1114, or H5133, H5134 and H5135, whichever set is appropriate to match with the existing adjacent pavement;
  - (iii) the applicant shall be responsible for any modification of the existing street furniture for the proposed run-in/out. The proposed modification works should be

- submitted to TD/HyD for comments before commencement of the modification works;
- (iv) the proposed run-in/out location may affect the existing slope. The proposed slope modification works should be submitted to HyD for comments and demarcation of the slope to be maintained by the applicant should be indicated before commencement of the modification works; and
- (v) adequate drainage measures should be provided at the site access to prevent surface water flowing from the Site to nearby public roads or exclusive road drains;
- (e) to note the comments of the Chief Engineer/Railway Development 2-2, Railway Development Office, Highways Department (CE/RD 2-2, RDO, HyD) that the Site is in close proximity to the proposed Northern Link (NOL) Spur Line alignment and station under development by MTRCL. The applicant should consult MTRCL with respect to the design and construction of the proposed works, whether it would affect the NOL Spur Line. Deep foundation such as piling is not permitted at the Site unless MTRCL's agreement is sought;
- (f) to note the comments of the Project Manager (North), Civil Engineering and Development Department (PM(N), CEDD) that the Site is within the proposed boundary of San Tin Technopole (covers the area outside the Loop). According to the latest tentative development programme of San Tin Technopole, the construction work and land resumption will commence after the FC funding approval tentatively by 2024. Thus, the Site, within the boundary of San Tin Technopole, will probably be required for timely clearance and construction;
- (g) to note the comments of Project Manager (West), Civil Engineering and Development Department (PM(W), CEDD) that the proposed temporary warehouse has encroached into the works area of Contract No. YL/2020/02 which commenced in September 2021 and will take about 50 months to complete. Contract No. YL/2020/02 mainly includes the construction of Western Connection Road Phase 2 through widening of a section of existing Lok Ma Chau Road and the construction of associated works including footpaths, cycle tracks, slopes, retaining walls, water supply and drainage system. There is a potential interface at the concerned location for the proposed temporary warehouse under the current application;
- (h) to note the comments of the Director of Environmental Protection (DEP) to follow the latest "Code of Practice on Handling the Environmental Aspects of Temporary Uses and Open Storage Sites" to minimise potential environmental impacts on the surrounding areas;
- (i) to note the comments of the Chief Town Planner/Urban Design and Landscape, Planning Department (CTP/UD&L, PlanD) that approval of the application does not imply approval of tree works such as pruning, transplanting and felling under lease. The applicant is reminded to seek approval for any proposed tree works from relevant departments and authorities prior to commencement of the works.
- (j) to note the comments of the Director of Fire Services (D of FS) to submit relevant layout plans incorporated with the proposed fire service installations (FSIs) to his department


for approval. The layout plans should be drawn to scale and depicted with dimensions and nature of occupancy, and the location of the proposed FSI should be clearly marked on the layout plans. If any proposed structure(s) is required to comply with the Buildings Ordinance (BO) (Cap.123), detailed fire service requirements will be formulated upon receipt of formal submission of general building plans;

- (k) to note the comments of the Chief Engineer/Mainland North, Drainage Services Department (CE/MN, DSD) as follows:
  - (i) the applicant shall submit a drainage submission to demonstrate how he will collect, convey and discharge rain water falling onto or flowing to the Site. A clear drainage plan showing full details of the existing drains and the proposed drains (e.g. cover and invert levels of pipes/catchpits/outfalls and ground levels justifying waterflow, etc.) with supporting design calculations and charts should be included. For preparation of the proposal, the Guideline on preparation of the drainage proposal is available in DSD homepage at:

    http://www.dsd.gov.hk/EN/Files/Technical\_Manual/dsd\_guideline/Drainage\_Sub mission.pdf
  - (ii) it is noted the final discharge point of the 1.8m wide existing channel is part of the public drainage system. Should the applicant choose to connect the proposed drainage system to DSD's network, they shall furnish DSD with their connection proposals for agreement. After obtaining DSD's agreement, the applicant shall submit a duly completed Form HBP1 with a cross cheque covering the technical audit fee and a plan showing the details of the proposed drainage connection works to the Mainland North Division of DSD for formal application for the required connections. Upon DSD's acceptance of the connection application, the applicant shall carry out the proposed connection works in accordance with DSD Standard Drawings at the resources of the applicant. The connection pipe located downstream of the terminal manhole, outside the lot boundaries shall be handed over to DSD for maintenance after satisfactory technical audit by DSD.
  - (iii) the applicant is reminded that approval of the drainage proposal must be sought prior to the implementation of drainage works on the Site;
  - (iv) after completion of the required drainage works, the applicant shall provide DSD for reference a set of record photographs showing the completed drainage works with corresponding photograph locations marked clearly on the approved drainage plan. DSD will inspect the completed drainage works jointly with the applicant with reference to the set of photographs;
  - (v) the applicant shall ascertain that all existing flow paths would be properly intercepted and maintained without increasing the flooding risk of the adjacent areas;
  - (vi) the applicant is reminded that the proposed drainage proposal/works as well as the site boundary should not cause encroachment upon areas outside his jurisdiction;

- (vii) the applicant should consult DLO/YL regarding all the proposed drainage works outside the lot boundary in order to ensure the unobstructed discharge from the Site in future;
- (viii) no public sewerage maintained by CE/MN, DSD is currently available for connection. For sewage disposal and treatment, agreement from the Director of Environmental Protection shall be obtained;
- (ix) the Site is close to an existing drainage channel along Chau Tau West Road. All the proposed works should not create any adverse drainage impacts to the public drainage system both during and after construction; and
- (x) all the proposed drainage facilities should be constructed and maintained by the applicant at his own cost. The applicant should ensure and keep all drainage works on site under proper maintenance at all times;
- (l) to note the comments of the Chief Building Surveyor/New Territories West, Buildings Department (CBS/NTW, BD) as follows:
  - (i) there is no record of approval by the Building Authority (BA) for the structures existing at the Site;
  - (ii) if the existing structures (not being a New Territories Exempted House) are erected on leased land without the approval of BA, they are unauthorised building works (UBW) under BO and should not be designated for any proposed use under the application;
  - (iii) for UBW erected on leased land, enforcement action may be taken by BD to effect their removal in accordance with BD's enforcement policy against UBW as and when necessary. The granting of any planning approval should not be construed as an acceptance of any existing building works or UBW on the Site under BO;
  - (iv) before any new building works (including containers/open sheds as temporary buildings, demolition and land filling, etc.) are to be carried out on the Site, prior approval and consent of BA should be obtained, otherwise they are UBW under BO. An Authorised Person should be appointed as the co-ordinator for the proposed building works in accordance with BO;
  - (v) the Site shall be provided with means of obtaining access thereto from a street and emergency vehicular access in accordance with Regulations 5 and 41D of the Building (Planning) Regulations (B(P)R) respectively;
  - (vi) the Site does not abut on a specified street of not less than 4.5m wide and its permitted development intensity shall be determined under Regulation 19(3) of B(P)R at the building plan submission stage;
  - (vii) any temporary shelters or converted containers for office, storage, washroom or other uses are considered as temporary buildings and are subject to the control of Part VII of B(P)R; and

- (viii) detailed checking under BO will be carried out at building plan submission stage; and
- (m) to note the comments of the Director of Food and Environmental Hygiene (DFEH) as follows:
  - (i) no Food and Environmental Hygiene Department's (FEHD) facilities will be affected;
  - proper licence / permit issued by this Department is required if there is any food business / catering service / activities regulated by the Director of Food and Environmental Hygiene (DFEH) under the Public Health and Municipal Services Ordinance (Cap. 132) and other relevant legislation for the public. Under the Food Business Regulation, Cap. 132X, a food business licence is required for the operation of the relevant type of food business listed in the Regulation (e.g. a restaurant, a refreshment kiosk etc). In accordance with Section 4 of Food Business Regulation, Cap. 132X, the expression "food business" means, any trade or business for the purpose of which any person engages in the handling of food or food is sold by means of a vending machine. But it does not include any canteen in work place (other than a factory canteen referred to in section 31) for the use exclusively of the persons employed in the work place. As such, a staff canteen that exclusively use by the staff members of that working place does not require a food business licence from this department. However, if the said canteen provided foods to the outsiders with payment, a food business licence is required. A cold store licence must be obtained from DFEH for the food business which involves the storage of articles of food under refrigeration in any warehouse in the territory before commencement of such business:
  - (iii) there should be no encroachment on the public place and no environmental nuisance, pest infestation and obstruction should be generated to the surroundings. Its state should not be a nuisance or injurious or dangerous to health and surrounding environment. Also, for any waste generated from such activities/operation, the applicant should arrange disposal properly at their own expenses; and
  - (iv) proper licence issued by this Department is required if related place of entertainment is involved. Any person who desires to keep or use any place of public entertainment for example a theatre and cinema or a place, building, erection or structure, whether temporary or permanent, on one occasion or more, capable of accommodating the public presenting or carrying on public entertainment within Places of Public entertainment (PPE) Ordinance (Cap. 172) and its subsidiary legislation, such as a concert, opera, ballet, stage performance or other musical, dramatic or theatrical entertainment, cinematograph or laser projection display or an amusement ride and mechanical device which is designed for amusement, a Place of Public Entertainment Licence (or Temporary Place of Public Entertainment Licence) should be obtained from FEHD whatever the general public is admitted with or without payment.

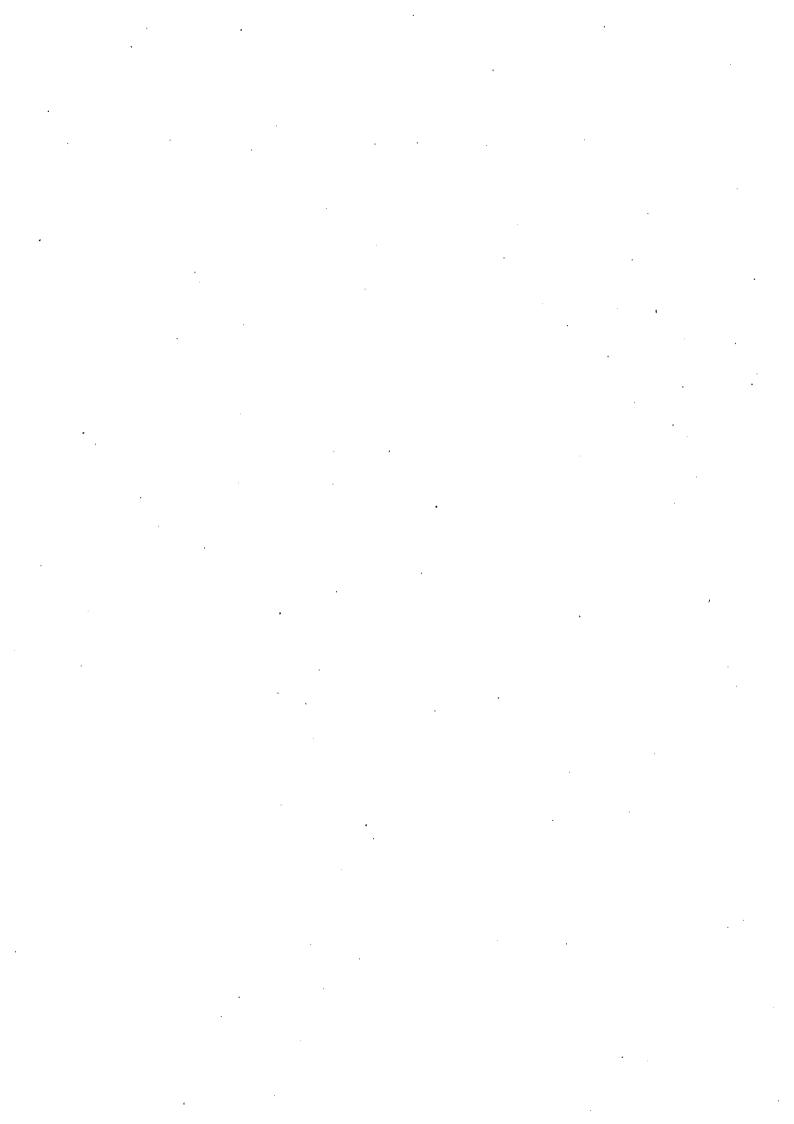

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☐ Urgent ☐ Return Receipt Requested ☐ Sign ☐ Encrypt ☐ Mark Subject Restricted ☐ Expand personal&pub
KFBG's comments on eight planning applications 25/05/2023 13:49
From: EAP KFBG <eap@kfbg.org> To: "tpbpd@pland.gov.hk" <tpbpd@pland.gov.hk> File Ref:</tpbpd@pland.gov.hk></eap@kfbg.org>
7 attachments
PDF PDF
230525 s17 FTA 222.pdf 230525 s16 TKL 726.pdf 230525 s16 MKT 26.pdf 230525 s16 LK 149-150.pdf
230525 s12a KTS 17c.pdf 230525 s16 ST 646.pdf 230525 s16 PH 951.pdf
Dear Sir/ Madam,
Attached please see our comments regarding eight applications. There are SEVEN pdf files

Thank You and Best Regards,

Ecological Advisory Programme Kadoorie Farm and Botanic Garden

#### **Email Disclaimer:**

through email.

The information contained in this e-mail (including any attachments) is confidential and is intended solely for the addressee. If you are not the intended recipient, please notify the sender immediately and delete this e-mail from your system. Any unauthorised use, disclosure, copying, printing, forwarding or dissemination of any part of this information is prohibited. KFBG does not accept responsibility and shall not be liable for the content of any e-mail transmitted by its staff for any reason other than bona fide official purposes. There is no warranty that this e-mail is error or virus free. You should not rely on any information that is not transmitted via secure technology.

attached to this email. If you cannot see/ download/ open these files, please notify us



#### 嘉道理農場暨植物園公司 Kadoorie Farm & Botanic Garden Corporation

The Secretary,
Town Planning Board,
15/F, North Point Government Offices,
333, Java Road, North Point,
Hong Kong.
(Email: tpbpd@pland.gov.hk)

25th May, 2023.

By email only

Dear Sir/ Madam,

## Proposed Temporary Warehouse (Excluding Dangerous Goods Godown) with Ancillary Office and Canteen for a Period of 3 Years and Associated Filling of Land (A/YL-ST/646)

- 1. We refer to the captioned.
- 2. According to the Statutory Planning Portal 2 website, there is a recently rejected (in 2020; for 'Filling of Land for Permitted Agricultural Use'; A/YL-ST/567) application covering the current application site, and the reasons for rejection are shown below:
  - (a) the applied use is not in line with the planning intention of the "Green Belt" ("GB") zone and the Town Planning Board Guidelines No. 10 for Development within Green Belt Zone under Section 16 of the Town Planning Ordinance in that the filling of land, which has been completed, involves clearance of natural vegetation, thereby adversely affecting the natural landscape; and
  - (b) the approval of the application will set an undesirable precedent for similar applications within the "GB" zone. The cumulative effect of approving such similar applications would result in general degradation of the environment of the area.
- 3. We urge the Board to reject this application as the proposed use is not in line with the planning intention of Green Belt zone.
- 4. Thank you for your attention.

Ecological Advisory Programme, Kadoorie Farm and Botanic Garden

香港新界大埔林錦公路 Lam Kam Road, Tai Po, New Territories, Hong Kong Email: eap@kfbg.org

☐ Urgent	☐ Return Receipt Requested ☐ Sign ☐ Encrypt ☐ Mark Subject Restricted ☐ Expand personal&pub
	A/YL-ST/646 DD 99 Pun Uk Tsuen, San Tin GB 26/05/2023 03:42
From: To: File Ref:	tpbpd <tpbpd@pland.gov.hk></tpbpd@pland.gov.hk>
A/YL-ST/6	46
	.B RP, 277 S.B RP, 279 S.B RP (Part), 282 S.B RP, 283 S.B RP, 284, 321 RP (Part), 322, 323 and 324 in D.D. 99 Pun Uk Tsuen, San Tin

Site area: About 4,24200sq.m

Zoning: "Green Belt"

Applied use: Warehouse / Filling of Land / 10 Vehicle Parking

Dear TPB Members,

Application 611 withdrawn. Applicant resorts to the usual trick of splitting the site.

Objections relevant and upheld.

Application should be rejected.

Mary Mulvihill

From:

To: tpbpd <tpbpd@pland.gov.hk>

Date: Tuesday, 25 January 2022 2:41 AM CST

Subject: A/YL-ST/611 DD 99 Pun Uk Tsuen, San Tin GB

A/YL-ST/611

Lots 247 (Part), 248, 276 S.B RP, 277 S.B RP, 279 S.B RP (Part), 282 S.B RP, 283 S.B RP, 284, 285, 289, 293, 321 RP, 322, 323, 324, 325 RP and 329 RP in D.D. 99 and Adjoining Government Land, Pun Uk Tsuen, San Tin

Site area: About 6,100sq.m Includes Government Land of about 45sq.m

Zoning: "Green Belt"

Applied use: Warehouse / Filling of Land / 8 Vehicle Parking

Dear TPB Members.

Strong objections. Some of the lots were included in

A/YL-ST/567 rejected

The applied use was not in line with the planning intention of the "Green Belt" ("GB") zone and did not meet the Town Planning Board Guidelines (TPG) No. 10 in that the proposed development, involving clearance of existing natural vegetation, would result in deterioration of landscape quality as well as adversely affect drainage or aggravate flooding and slope stability in the subject "GB" zone. Whilst the Director of Agriculture, Fisheries and Conservation considered that the application site possessed potential for agricultural rehabilitation and rendered his support for the two agricultural structures, the application site involved unauthorized land filling which had resulted in loss of wetland within the wetland buffer area. In that connection, the applied use was not in line with the "no net loss" in wetland principle as stipulated in the TPB Guidelines No. 12C. The Chief Town Planner/Urban Design and Landscape of PlanD also objected to the application as a large portion of the application site had already been filled prior to the application.

This is the typical 'death by a thousand cuts' whereby a large brownfield operation is rejected and the site is then carved up into smaller bites in the hope that it can slip through.

Google Maps shows the extent of the damage to the GB.

Members must reject this application.

Mary Mulvihill

Urge	nt Return Receipt Requested	☐ Sign	☐ Encrypt	Mark Subject Restricted	Expand personal&put
	A/YL-ST/646 objection 26/05/2023 18:52			· .	·
From: To: File Ref:	tpbpd@pland.gov.hk			·	

A Man Email -

Secretary of the Board Town Planning Board 15th Floor, North Point Government Offices, 333 Java Road, North Point Email - tpbpd@pland.gov.hk

Dear Sir and Madame,

I refer to the Application No. A/YL-ST/646 in Lots 276 S.B RP, 277 S.B RP, 279 S.B RP (Part), 282 S.B RP, 283 S.B RP, 284, 285, 289, 321 RP (Part), 322, 323 and 324 in D.D. 99, Pun Uk Tsuen, San Tin, Yuen Long for the Proposed Temporary Warehouse (Excluding Dangerous Goods Godown) with Ancillary Office and Canteen for a Period of 3 Years and Associated Filling of Land.

The residents and indigenous villagers of Chau Tau Village and Pun Uk Tsuen at the application site object to the development due to the reasons as follows:

- 1. The application site was previously "Green Belt" agricultural land but it has recently been land filled and surfaced with tarmac without planning permission. This development has lead to contamination of the water course and flooding during heavy rainstorm to neighbouring agricultural lands.
- 2. The access via a local path from Lok Ma Chau Road do not have a dedicated pedestrian walkway, therefore, it would be hazardous for both pedestrians and vehicles to share a single path. Also, it would be extremely dangerous for vehicles from the busy heavy traffic Lok Ma Chau Road to access the site.
- 3. The site is being continuously trying to apply for planning permission for various usages, but the response from The Town Planning Board was always refusal.
- 4. The site is only now applying for planning permission after enforcement action from the Planning Department on the illegal parking of lorries and container vehicles at the site and also the illegal associated land filling.
- 5. The application would create unacceptable vehicle access, noise, smell, rubbish, sewage and vehicle headlight beam at night to very close residential properties in an area that is used for residential and agricultural purposes for generations.
- 6. The Proposed Temporary Warehouse (Excluding Dangerous Goods Godown) with

Ancillary Office and Canteen Application is an excuse for parking of lorries. Evidence can be found from the Filling of Land in application A/YL-ST/567 which was refused by the Town Planning Board on 06/03/2020, but the site is being continually and illegally used for lorry parking.

Kind regards, A Man

### 就規劃申請/覆核提出意見 Making Comment on Planning Application / Review

參考編號

Reference Number:

230710-072240-66791

提交限期

Deadline for submission:

11/07/2023

提交日期及時間

Date and time of submission:

10/07/2023 07:22:40

有關的規劃申讀編號

The application no. to which the comment relates:

A/YL-ST/646

「提意見人」姓名/名稱

Name of person making this comment:

先生 Mr. A Man

意見詳憺

Details of the Comment:

A Man

Chau Tau Village, San Tin, Yuen Long

Secretary of the Board Town Planning Board 15th Floor, North Point Government Offices, 333 Java Road, North Point Email - tpbpd@pland.gov.hk

Dear Sir and Madame,

I refer to the Application No. A/YL-ST/646 in Lots 276 S.B RP, 277 S.B RP, 279 S.B RP (Part), 282 S.B RP, 283 S.B RP, 284, 285, 289, 321 RP (Part), 322, 323 and 324 in D.D. 99, Pun Uk Ts uen, San Tin, Yuen Long for the Proposed Temporary Warehouse (Excluding Dangerous Goods Godown) with Ancillary Office and Canteen for a Period of 3 Years and Associated Filling of L and.

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Kind regards,

A Man

致城市規劃委員會秘書

導人送遞或郵遞:香港北角遊報道 333 號北角政府合署 15 櫻

傳資: 2877 0245 或 2522 8426

TES: tpbpd@pland.gov.hk

To: Secretary, Town Planning Board

By hand or post: 15/F4 North Point Government Offices, 333 Java Road, North Point, Hong Kong

By Fax: 2877 0245 or 2522 8426 By e-mail: tpbpd@pland.gov.hk

有限的規劃申讀編號 The application no. to which the comment relates

A/YL-ST/646Received on 07/06/2023

意見詳情 (如有需要, 請另頁說明)

Details of the Commont (use separate sheet if necessary)

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#### 嘉道理農場暨植物園公司 Kadoorie Farm & Botanic Garden Corporation

The Secretary,
Town Planning Board,
15/F, North Point Government Offices,
333, Java Road, North Point,
Hong Kong.
(Email: tpbpd@pland.gov.hk)

RECEIVED

1 1 JUL 2023

Town Planning
Board

By email only

11th July, 2023.

Dear Sir/ Madam,

## Proposed Temporary Warehouse (Excluding Dangerous Goods Godown) with Ancillary Office and Canteen for a Period of 3 Years and Associated Filling of Land (A/YL-ST/646)

- 1. We refer to the captioned.
- 2. According to the Statutory Planning Portal 2 website, there is a recently rejected (in 2020; for 'Filling of Land for Permitted Agricultural Use'; A/YL-ST/567) application covering the current application site, and the reasons for rejection are shown below:
  - (a) the applied use is not in line with the planning intention of the "Green Belt" ("GB") zone and the Town Planning Board Guidelines No. 10 for Development within Green Belt Zone under Section 16 of the Town Planning Ordinance in that the filling of land, which has been completed, involves clearance of natural vegetation, thereby adversely affecting the natural landscape; and
  - (b) the approval of the application will set an undesirable precedent for similar applications within the "GB" zone. The cumulative effect of approving such similar applications would result in general degradation of the environment of the area.
  - 3. We urge the Board to reject this application as the proposed use is not in line with the planning intention of Green Belt zone.
- 4. Thank you for your attention.

Ecological Advisory Programme, Kadoorie Farm and Botanic Garden

香港新界大埔林錦公路 Lam Kam Road, Tai Po, New Territories, Hong Kong

#### 致城市規劃委員會秘書:

專人送遞或郵遞:香港北內渣華道 333 號北角政府合署 15 極

傳頁: 2877 0245 或 2522 8426

電弧: tpbpd@pland.gov.hk

To: Secretary, Town Planning Board

By hand or post: 15/F, North Point Government Offices, 333 Java Road, North Point, Hong Kong

By Fax: 2877 0245 or 2522.8426
By e-mail: tpbpd@pland.gov.hk

有關的規劃申請編號 The application no. to which the comment relates <u>A/YL-ST/646</u>

意見詳情 (如有需要: 游另頁說明)

Details of the Comment (use separate sheet if necessary)

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