

Proposed Temporary Warehouse for Storage of Furniture, Electronic Goods & Construction Materials for a Period of 3 Years at Lots 1449 (Part), 1450 (Part), 1453, 1454 (Part), 1458 (Part) & 1459 (Part) in D.D.119, Tong Yan San Tsuen,

Project 項目名稱:

Yuen Long, N.T.

Drawing Title 圖目:
Proposed Layout Plan

Remarks 備註:

Drawing No. 圖號:


Figure 3

Scale 比例:

<del>1:1000</del>

參考編號 REFERENCE No. A/YL-TYST/1210

繪圖 DRAWING

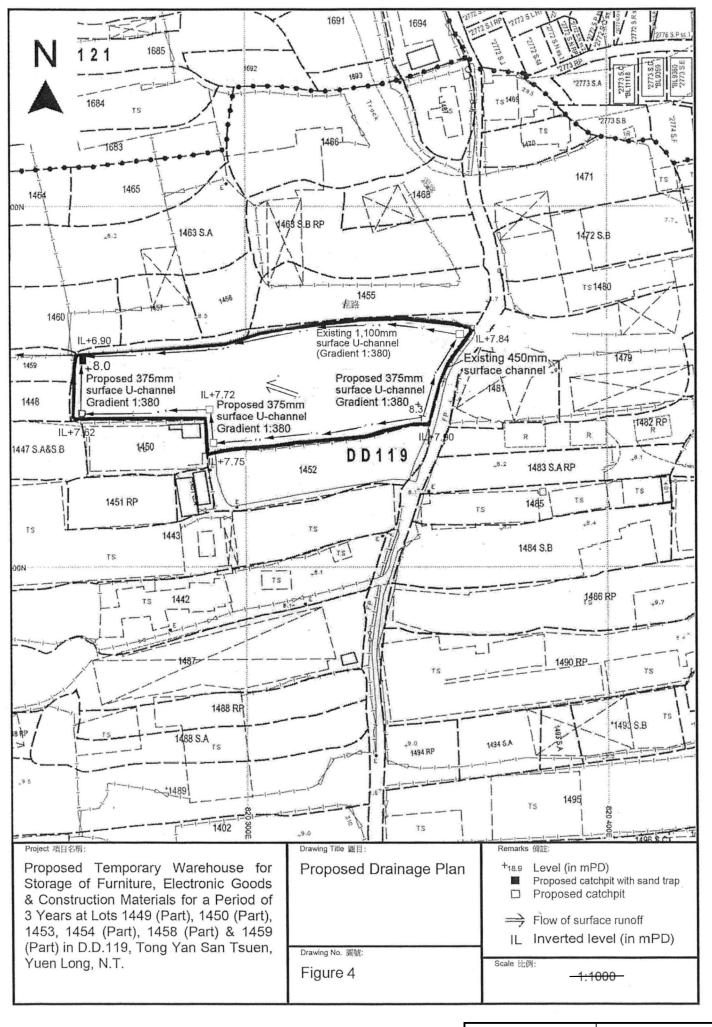

### F.S. NOTES:

### 1. GENERAL

- 1.1 FIRE SERVICE INSTALLATIONS SHALL BE PROVIDED IN ACCORDANCE WITH THE CODES OF PRACTICE FOR MINIMUM FIRE SERVICE INSTALLATIONS AND EQUIPMENT AND INSPECTION, TESTING AND MANIFORMEC OF INSTALLATIONS AND EQUIPMENT 2022 (COP 2022), FSD ORCULAR LETTERS AND THE HOW GOVE MURTERWISE STANDARD REQUIREMENTS.
- 1.2 ALL TUBES AND FITTINGS SHALL BE G.M.S. TO BS1387 MEDIUM GRADE WHERE PIPEWORK UP TO #150mm.
- 1.3 ALL TUBES AND FITTINGS SHALL BE DUCTILE IRON TO BS EN545 K12 WHERE PIPEWORK ABOVE #150mm.
- 1.4 ALL DRAIN PIPES SHALL BE DISCHARGED TO A CONSPICUOUS POSITION WITHOUT THE POSSIBILITY OF BEING SUBMERGED.
- 1.5 ALL PUDDLE FLANGES SHALL BE MADE OF DUCTILE IRON
- 1.6 THE AGGREGATE AREA OF OPENABLE WINDOWS NOT LESS THAN 6.25% OF THE FLOOR AREA OF THE STRUCTURE
- 1.7 VENTILATION/AIR CONDITIONING SYSTEM NOT TO BE PROVIDED.

### 2. HOSE REEL SYSTEM

- 2.1 NEW FIRE HOSE REEL SHALL BE PROVIDED AS INDICATED ON PLAN TO ENSURE THAT EVERY PART OF THE BUILDING CAN BE REACHED BY A
- 2.2 THE WATER SUPPLY FOR HOSE REEL SYSTEM WILL BE FED FROM A NEW 2m<sup>3</sup> F.S. FIBREGLASS WATER TANK VIA TWO HOSE REEL PUMPS (DUTY)
- 2.3 HOSE REEL PUMPS SHALL BE STARTED BY ACTUATION OF ANY BREAKGLASS UNIT FITTED ASIDE EACH HOSE REEL SETS
- 2.4 ALL FIRE HOSE REEL OUTLETS SHOULD BE HOUSED IN GLASS FRONTED CABINET SECURED UNDER LOCK & KEY.
- 2.5 ALL FIRE HOSE REEL SHOULD BE PROVIDED WITH FSD APPROVED TYPE INSTRUCTION PLATE & WSD WARNING PLATE
- 2.6 SECONDARY ELECTRICITY SUPPLY DIRECTLY TEE OFF BEFORE CLP'S INCOMING MAIN SWITCH SHALL BE PROVIDED FOR THE FH/HR PUMPS.

- 3.1 NEW AUTOMATIC SPRINKLER SYSTEM SHALL BE PROVIDED AND INSTALLED IN ACCORDANCE WITH LPC RULES FOR AUTOMATIC SPRINKLER INSTALLATIONS INCORPORATING BS SIN 12845: 2015 (INCLUDING TECHNOLL BULLETING, NOTES, COMMENTARY AND RECOMMENDATIONS) AND FSD CIRCULAR LETTER NO. 5/200. THE CLASSIFICATION OF THE COULYMAGES WILL BE COMMENT HAZARD GROUP III.
- 3.2 ONE NEW 135m3 SPRINKLER WATER TANK WILL BE PROVIDED AS INDICATED ON PLAN. THE TOWN MAIN WATER SUPPLY WILL BE FED FROM SINGLE END.
- 3.3 TWO NEW SPRINKLER PUMPS (DUTY/STANDBY) AND ONE JOCKEY PUMP SHALL BE PROVIDED IN FS PUMP ROOM LOCATED AT EXTERNAL AREA
- 3.4 NEW SPRINKLER CONTROL VALVE SET AND SPRINKLER INLET SHALL BE PROVIDED AS INDICATED ON PLAN.
- 3.5 A TEST VALVE SHALL BE PROVIDED FOR EACH ZONE OF SPRINKLER PIPE. THIS VALVE SHALL BE AT A CONSPICUOUS POSITION THAT WATER CAN BE DRAINED AWAY FASILY
- 3.6 ALL SUBSIDIARY STOP VALVES TO BE ELECTRIC MONITORING TYPE.
- 3.7 ALL ELECTRIC TYPE VALVES SHOULD GIVE VISUAL SIGNALS TO FIRE SERVICE MAIN SUPERVISORY CONTROL PANEL TO INDICATE THE STATUS (OPEN/CLOSE) OF THE VALVES.
- 3.8 SECONDARY ELECTRICITY SUPPLY DIRECTLY TEE OFF BEFORE CLP'S INCOMING MAIN SWITCH SHALL BE PROVIDED FOR THE SPRINKLER PUMPS.
- 3.9 THE SPRINKLER SYSTEM DESIGN IS BASED ON THE FOLLOWINGS:

HAZARD CLASS: ORDINARY HAZARD GROUP III
TYPE OF STORAGE: POST-PALLET (ST2)
STORAGE CATEGORY: CATEGORY I
MAXIMUM STORAGE HEGHT: 3.5m
SPRINKLER PROTECTION: CEILING PROTECTION ONLY
MAXIMUM STORAGE AREA: 50m<sup>2</sup>

## 4. FIRE ALARM SYSTEM

- 4.1 NEW FIRE ALARM SYSTEM SHALL BE PROVIDED IN ACCORDANCE WITH BS 5839 PART 1: 2017 AND FSD CIRCULAR LETTERS 6/2021
- 4.2 NEW BREAKGLASS UNITS AND FIRE ALARM BELLS SHALL BE PROVIDED AT ALL NEW FIRE HOSE REEL POINTS. THE FIRE ALARM INTALLATION WILL BE

## 5. EMERGENCY LIGHTING

5.1 EMERGENCY LIGHTING SHALL BE PROVIDED IN ACCORDANCE WITH '85 5266-PART 1 :2016 AND BS EN 1838 :2013", FSD CIRCULAR LETTER 4/2021, COVERING ALL AREA. EMERGENCY LIGHTINGS SHALL BE BACKED UP BY BUILT-IN BATTERY AND CAPABLE OF MAINTAINING FUNCTION OF NOT LESS THAN 2 HOURS IN CASE OF POWER FAILURE

6.1 ALL DIT SIONS/DIRECTIONAL DIT SIONS SHALL BE PROVDED IN ACCORDANCE WITH '8S 5266-PART 1 2016 AND FSO CRICULAR LETTER NO. 5/2006, FOR THE BULLDING. EXIT SIGNS/DIRECTIONAL DIT SIGNS SHALL BE BIOXED UP BY BUILT-IN BUTTERY AND CAPABLE OF MANTANING FUNCTION OF NOT LISS THAN 2 HOURS IN OUS OF POWER PALIBLE.

## 7. PORTABLE APPLIANCES

7.1 PORTABLE HAND OPERATED APPLIANCES SHALL BE PROVIDED AS INDICATED ON PLAN.

# **LEGEND**

FIRE ALARM BELL

1458 (Part) & 1459 (Part), in D.D.119 Tong Yan San Tsuen, Yuen



EMERGENCY LIGHT EXIT SIGN

5KG CO2 FIRE EXTINGUISHER 

SUBSIDIARY VALVE / FLOW SWITCH

PUMP SET Y-TYPE STRAINER SPRINKLER INLET

12000

12000

12000

CONSULTANT FIRE SERVICE CONTRACTOR

NAME DATE FS-01 0 C.K.NG 25 APR 202 RAWN BY SCALE : B.O.O. Ref. F.S.D. Ref. PPROVED BY

HR HOSE REEL BREAK GLASS UNIT

Proposed Temporary Warehouse for Storage of

NON-RETURN VALVE

DRAWING TITLE F.S. Notes, Legend, Furniture, Electronic Goods and Construction Materials for a Period Fire Service Installation of 3 Years at Lots 1449 (Part) & 1450 (Park), 1453, 1454 (Part),

Layout Plan

ARCHITECT : REV DESCRIPTION DATE

Structure 1 Openable Windows Calculation

Section drawing of window opening for the structure (1)

12000

12000

12000

12000

Structure 2 Site office

No. of storey: 2

GFA: Not exceeding 80m<sup>2</sup>

Height: Not exceeding 8m

Structure 3

No. of storey: 1

GFA: Not exceeding 16m2 Height: Not exceeding 3.5m

18m diameter

manoeuvring

circle

2 loading/unloading

bays of 11m x 3.5m

for medium goods vehicle

12000

Structure 4

No. of storey: 1

GFA: Not exceeding 2m2

Height: Not exceeding 3.5m

6m wide

Ingress/Egress

Guard room

Area of Structure 1= 2100 sq.m. 2000 LIT. FIBREGLASS SPRINKLER PUMP F.S. WATER TANK

12000



Structure 1 Warehouse for storage of furniture, electronic goods and construction materials GFA: Not exceeding 2,100m<sup>2</sup>

Height: Not exceeding 10m No. of storey: 1

5KG DRY POWDER

Century Fire Service Engineering Co., Ltd.

CHECKED BY


參考編號 REFERENCE No.


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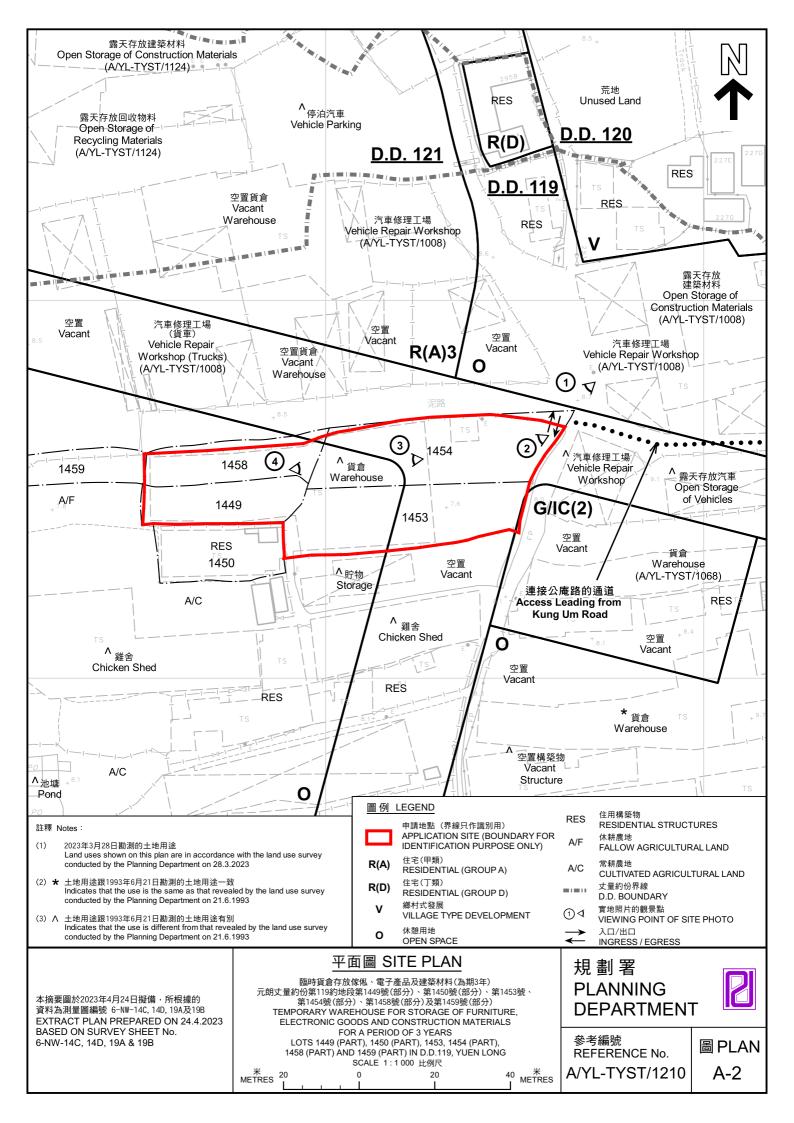
繪圖 DRAWING A-4

(摘錄自申請人於 26.4.2023 呈交的進一步資料)

(Extract from Applicant's Further Information Submitted on 26.4.2023)



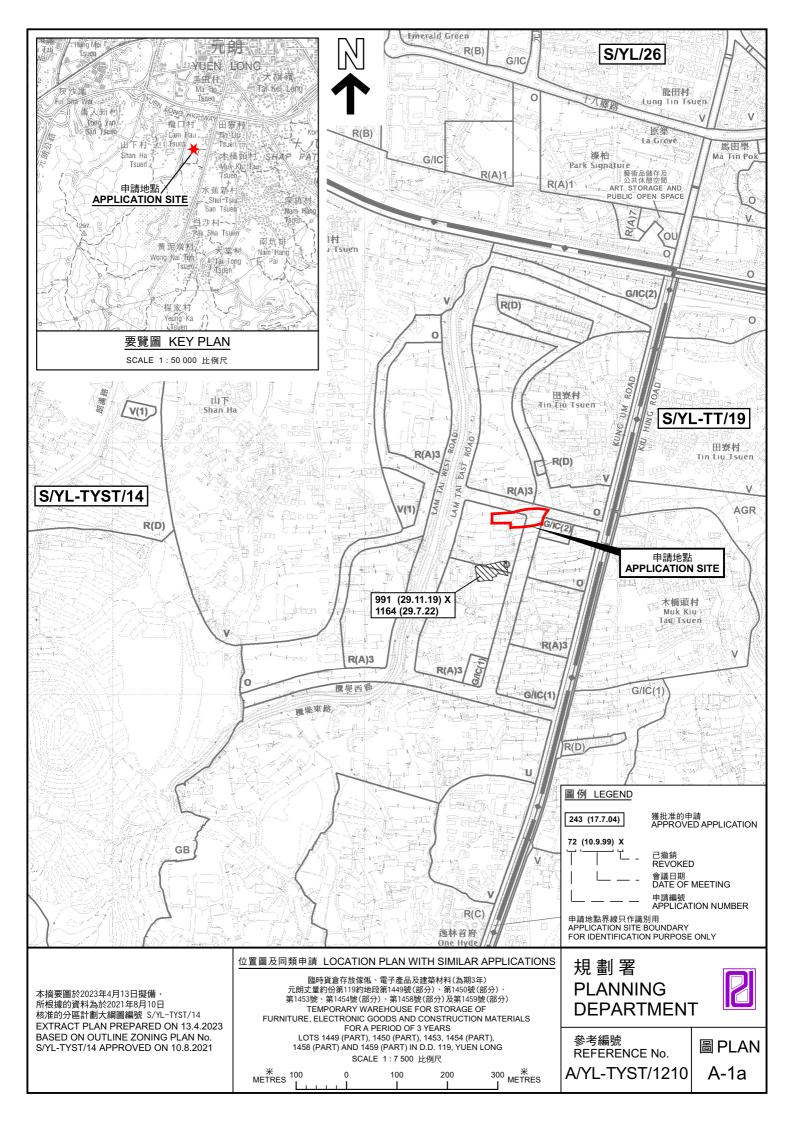

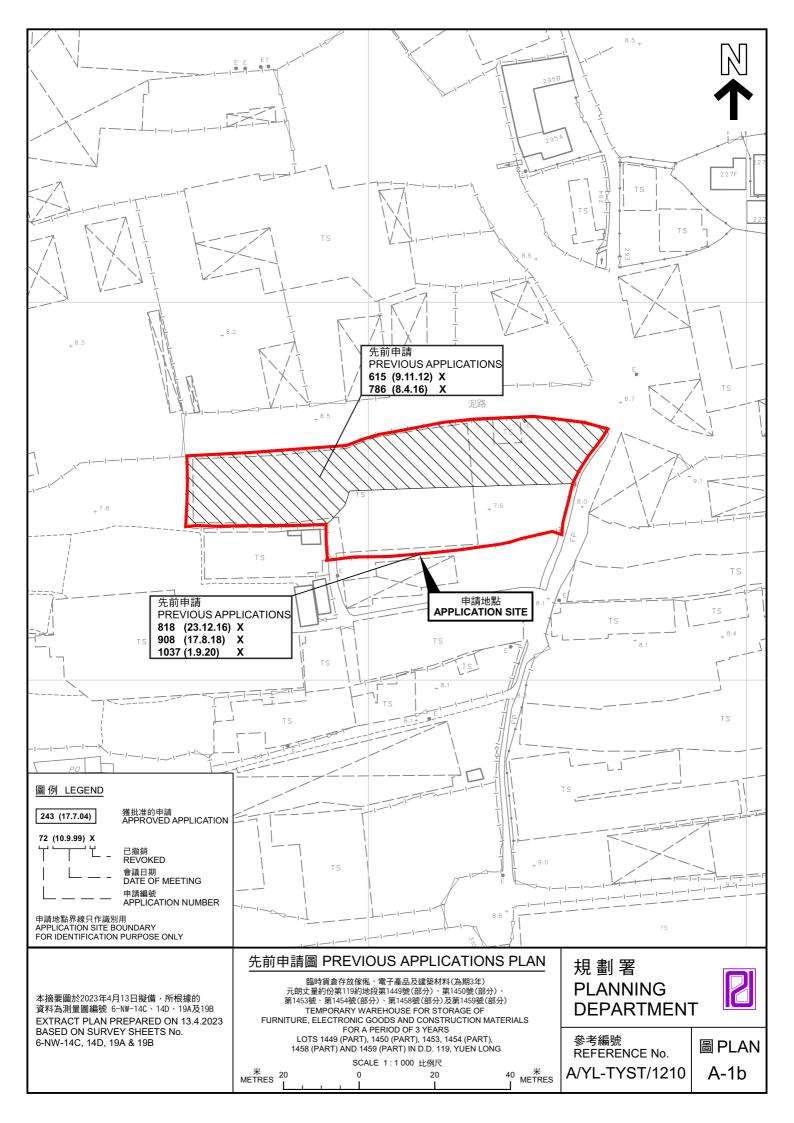



本摘要圖於2023年4月14日擬備,所根據 的資料為地政總署於2022年4月7日拍得 的航攝照片編號 E159004C

EXTRACT PLAN PREPARED ON 14.4.2023 BASED ON AERIAL PHOTO No. E159004C TAKEN ON 7.4.2022 BY LANDS DEPARTMENT

# 航攝照片 AERIAL PHOTO

臨時貨倉存放傢俬、電子產品及建築材料(為期3年) 元朗丈量約份第119約地段第1449號(部分)、第1450號(部分)、 第1453號、第1454號(部分)、第1458號(部分)及第1459號(部分) TEMPORARY WAREHOUSE FOR STORAGE OF FURNITURE, ELECTRONIC GOODS AND CONSTRUCTION MATERIALS

FOR A PERIOD OF 3 YEARS
LOTS 1449 (PART), 1450 (PART), 1453, 1454 (PART),
1458 (PART) AND 1459 (PART) IN D.D. 119, YUEN LONG

## 規劃署 **PLANNING DEPARTMENT**



參考編號 REFERENCE No. A/YL-TYST/1210

圖 PLAN A-3





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本圖於2023年4月13日擬備·所根據的 資料為攝於2023年3月29日的實地照片 PLAN PREPARED ON 13.4.2023 BASED ON SITE PHOTOS TAKEN ON 29.3.2023

## 實地照片 SITE PHOTOS

臨時貨倉存放傢俬、電子產品及建築材料(為期3年) 元朗丈量約份第119約地段第1449號(部分)、第1450號(部分)、 第1453號、第1454號(部分)、第1458號(部分)及第1459號(部分) TEMPORARY WAREHOUSE FOR STORAGE OF FURNITURE, ELECTRONIC GOODS AND CONSTRUCTION MATERIALS FOR A PERIOD OF 3 YEARS LOTS 1449 (PART), 1450 (PART), 1453, 1454 (PART), 1458 (PART) AND 1459 (PART) IN D.D. 119, YUEN LONG

# 規 劃 署 PLANNING DEPARTMENT



參考編號 REFERENCE No. A/YL-TYST/1210

圖 PLAN A-4a









本圖於2023年4月13日擬備·所根據的 資料為攝於2023年3月29日的實地照片 PLAN PREPARED ON 13.4.2023 BASED ON SITE PHOTOS TAKEN ON 29.3.2023

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# 規 劃 署 PLANNING DEPARTMENT



參考編號 REFERENCE No. A/YL-TYST/1210

圖 PLAN A-4b